

STATE OF CALIFORNIA
DEPARTMENT OF TRANSPORTATION
PROJECT PLANS FOR CONSTRUCTION ON
STATE HIGHWAY
IN LOS ANGELES COUNTY
IN LOS ANGELES, GLENDALE, AND BURBANK
FROM ROUTE 5/134 SEPARATION
TO MAGNOLIA BOULEVARD OVERCROSSING

TO BE SUPPLEMENTED BY STANDARD PLANS DATED JULY 2004




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STRUCTURE PLANS

574-637	LOS ANGELES RIVER BRIDGE AND SEPARATION (WIDEN) Br No. 53-1075
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650-708	SONORA AVENUE UC (WIDEN) Br No. 53-1077
709-736	WESTERN AVENUE UC (WIDEN) Br No. 53-1079
737-756	ALLEN AVENUE UC (WIDEN) Br No. 53-1081
757-789	ALAMEDA AVENUE UC (WIDEN) Br No. 53-1082
790-941	PROVIDENCIA AVENUE OH (WIDEN) Br No. 53-1085
942-980	VERDUGO AVENUE UC (WIDEN AND RETROFIT) Br No. 53-1086
981-987	RETAINING WALL No. 440
988-999	RETAINING WALL No. 437
1000-1030	SOUTH APPROACH RAMP AND RETAINING WALLS Br No. 53E0127
1031-1071	NORTH APPROACH RAMP AND RETAINING WALLS Br No. 53E0128
1072-1073	RETAINING WALL No. 466 Br No. 53E0138

THE STANDARD PLANS LIST APPLICABLE TO THIS CONTRACT IS INCLUDED IN THE NOTICE TO BIDDERS AND SPECIAL PROVISIONS BOOK.



BEGIN CONSTRUCTION
STA 428+83 KP 42.8
PM 26.7

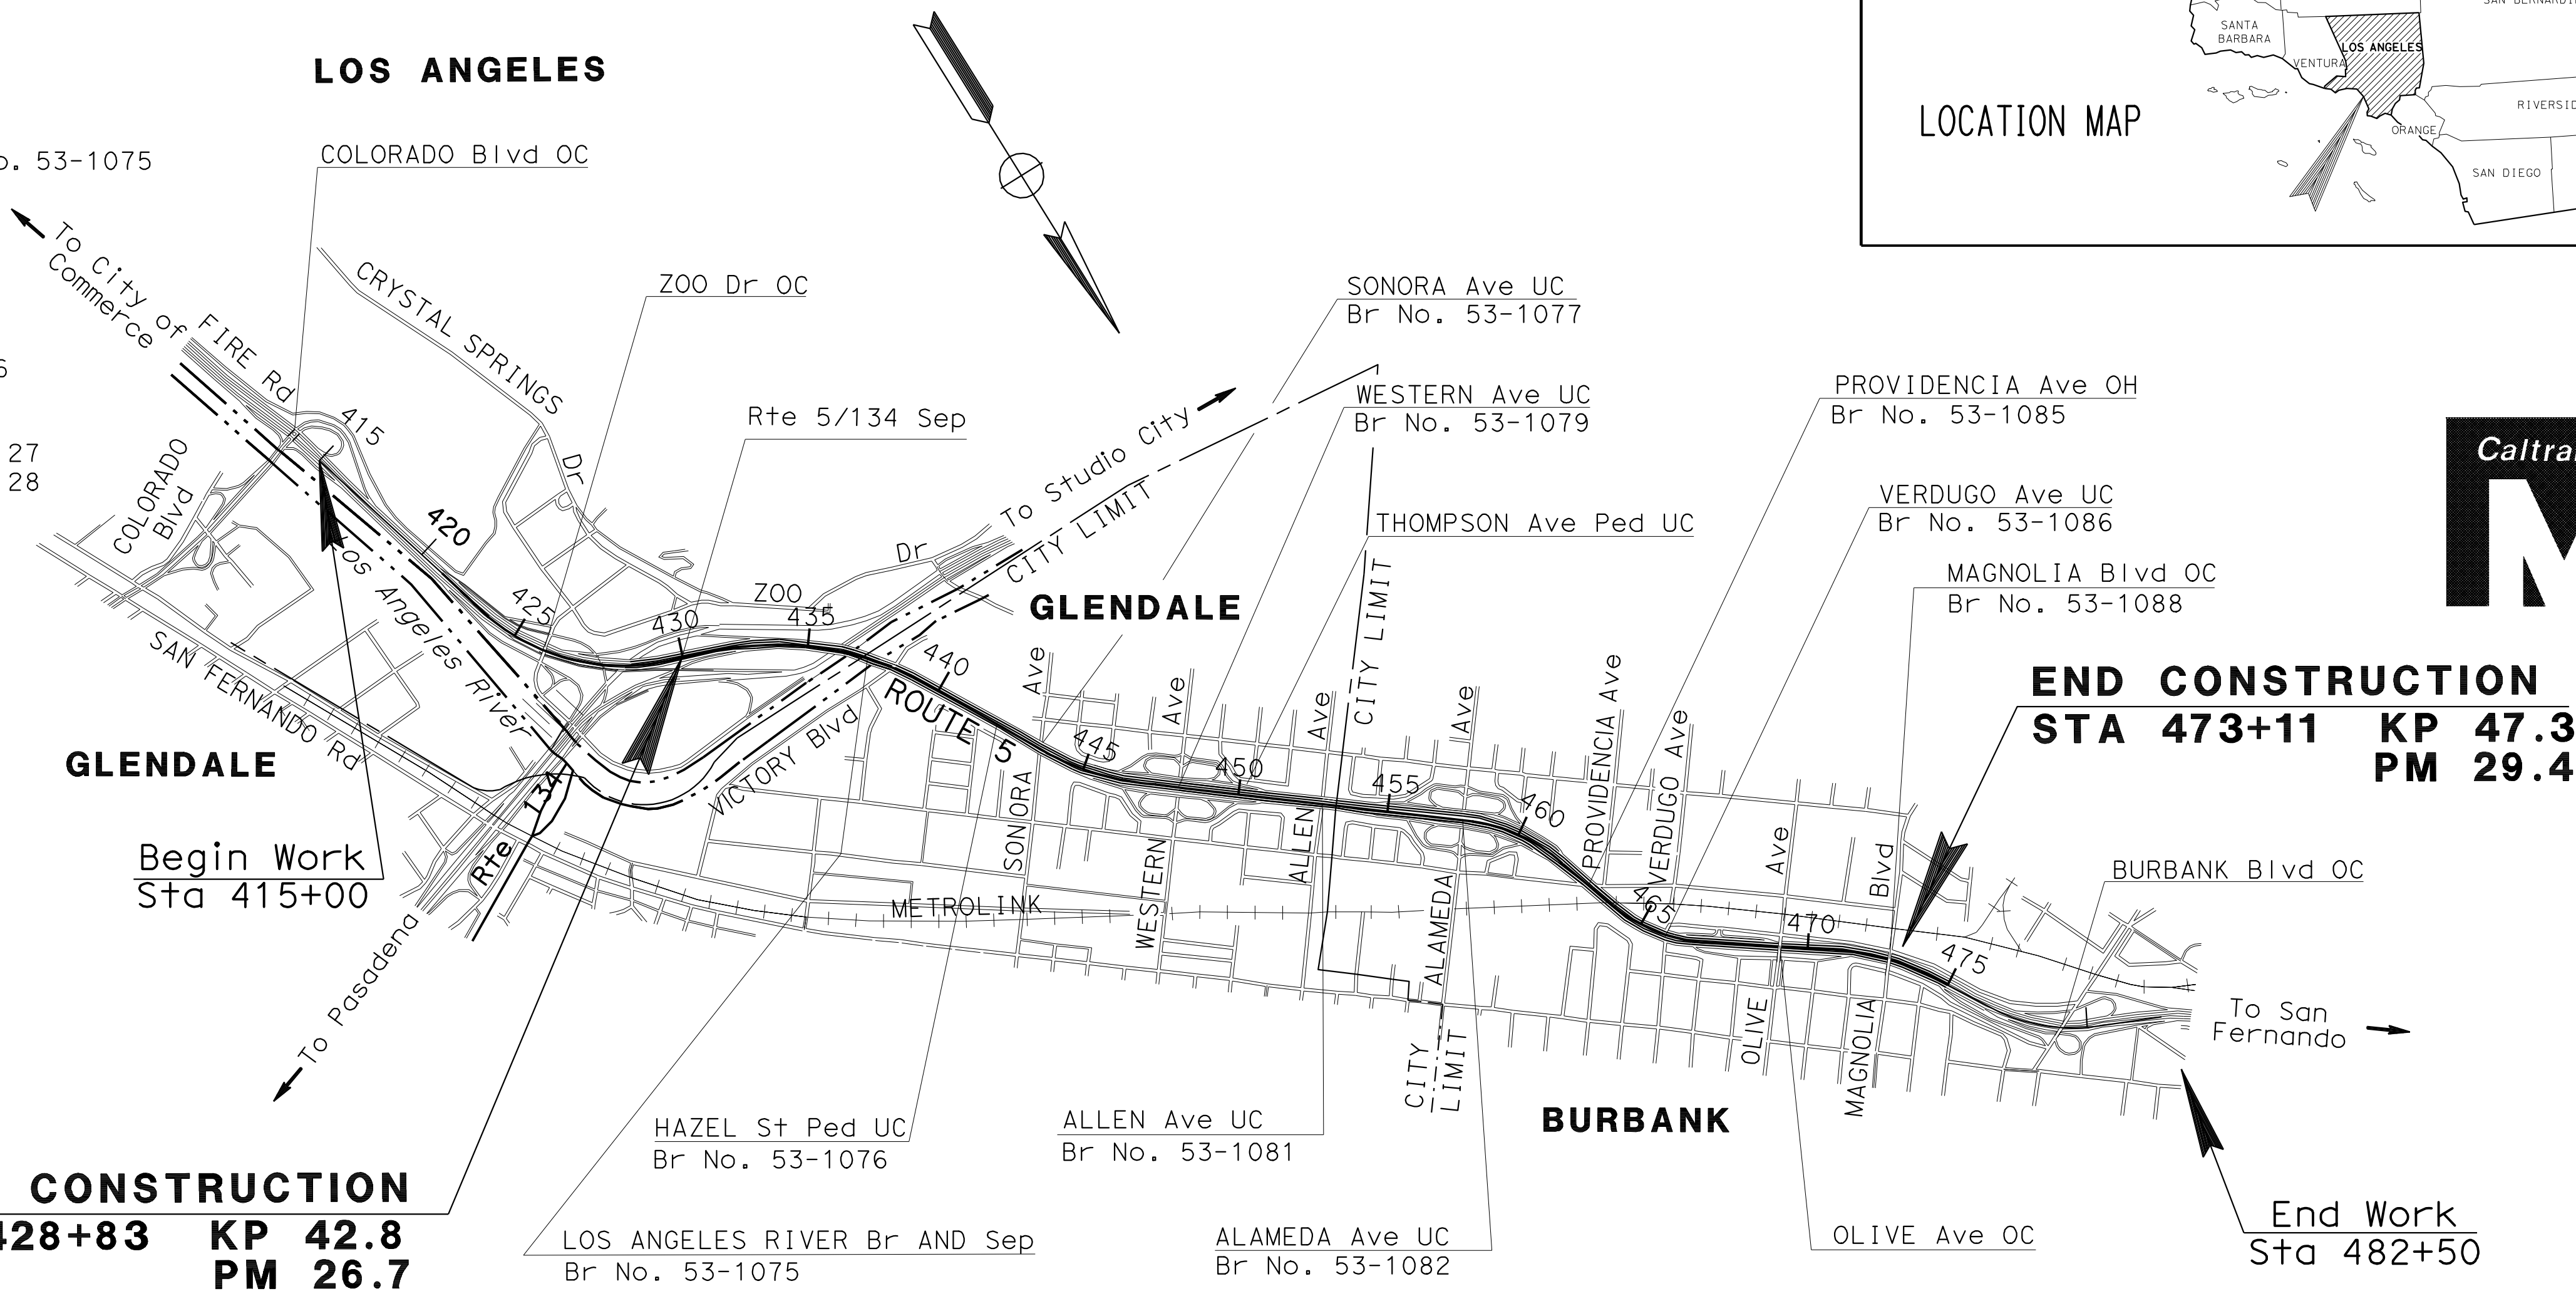END CONSTRUCTION
STA 473+11 KP 47.3
PM 29.4

End Work
Sta 482+50

NO SCALE

LOCATIONS OF HUB AND LARTMC FOR SYSTEM TESTING			
ROUTE	KP	LOCATION	DESCRIPTION
5	27.2	NORTHBOUND ROUTE 5 NEAR GARNETT STREET	ELA - EAST LOS ANGELES HUB BUILDING
2	30.1	ROUTE 134 AND ROUTE 2 INTERCHANGE (2901 WEST BROADWAY, LOS ANGELES, CA 90041)	LARTMC (TMC) - LOS ANGELES REGIONAL TRANSPORTATION MANAGEMENT CENTER

THE CONTRACTOR SHALL POSSESS THE CLASS (OR CLASSES) OF LICENSE AS SPECIFIED IN THE "NOTICE TO BIDDERS"

PROJECT ENGINEER REGISTERED CIVIL ENGINEER
 DATE 2-09-09
June 8, 2009
 PLANS APPROVAL DATE

CONTRACT No. 07-121844

EXISTING STRUCTURAL SECTIONS

A	60 mm AC (TYPE A) 40 mm RUBBERIZED AC 204 mm PCC 101 mm CTB 101 mm AB 204 mm AS
B	60 mm AC (TYPE A) 40 mm RUBBERIZED AC 229 mm PCC 101 mm CTB 76 mm AB 204 mm AS
C	76 mm AC 150 mm AB VARIABLE THICKNESS AS
D	101 mm AC 204 mm CTB 101 mm AB 204 mm AS
E	204 mm PCC 101 mm CTB 101 mm AB 204 mm AS
F	229 mm PCC 101 mm CTB 76 mm AB 204 mm AS


NOTES:

- DIMENSIONS OF THE STRUCTURAL SECTIONS ARE SUBJECT TO TOLERANCES SPECIFIED IN THE STANDARD SPECIFICATIONS.
- SUPERELEVATION AS SHOWN OR AS DIRECTED BY THE ENGINEER.
- PLACE TIE BAR AT JOIN EXISTING FROM STA 464+07.068 TO 473+03.000.
- BARRIER ALIGNMENT IS 1.5 m RIGHT OF C FROM STA 463+16.52 TO 466+88.690.

DESIGN DESIGNATION (ROUTE 5)

2002 ADT = 188,000 D = 55%
 2027 ADT = 410,000 D = 55%
 DHV = 32,800 D = 110 Km/h

ABBREVIATION:
 RS RAPID SETTING
 RSC RAPID STRENGTH CONCRETE

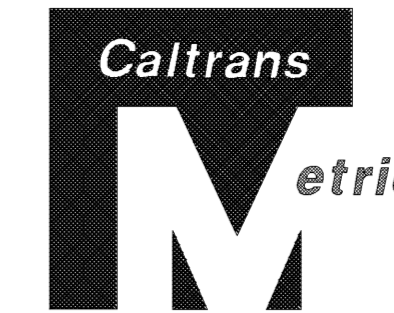

Dist	COUNTY	ROUTE	KILOMETER POST TOTAL PROJECT	SHEET No.	TOTAL SHEETS
07	LA	5	42.8/47.3	2	1073

REGISTERED CIVIL ENGINEER: MUNSHI MOHSIN
 No. 61916
 Exp. 9/30/09
 DATE: 2-17-09
 PLANS APPROVAL DATE: 6-8-09



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TYPICAL STRUCTURAL SECTIONS

TYPE 1	345 mm JPCP 150 mm LCB 215 mm CLASS 3 AB
TYPE 2	195 mm HMA (TYPE B) 180mm LCB (RS) 345 mm CLASS 3 AB
TYPE 3	165 mm HMA (TYPE B) 315 mm CLASS 3 AB
TYPE 4	105 mm HMA (TYPE B) GEOSYNTHETIC Pvm+ INTERLAYER 90 mm HMA (TYPE B) ** 180 mm LCB (RS) 345 mm CLASS 3 AB
TYPE 5	345 mm Conc Pvm+ (RSC) BOND BREAKER 150 mm LCB (RS) 215 mm CLASS 3 AB
TYPE 6	195 mm HMA (TYPE B) 180mm LCB 345 mm CLASS 3 AB

** THE TRAFFIC LOOP SHALL BE CUT AND EPOXY FILLED IN THIS LAYER OF HMA PRIOR TO PLACING GEOSYNTHETIC PAVEMENT INTERLAYER AND FINAL LAYER.

* SEE LAYOUT SHEET

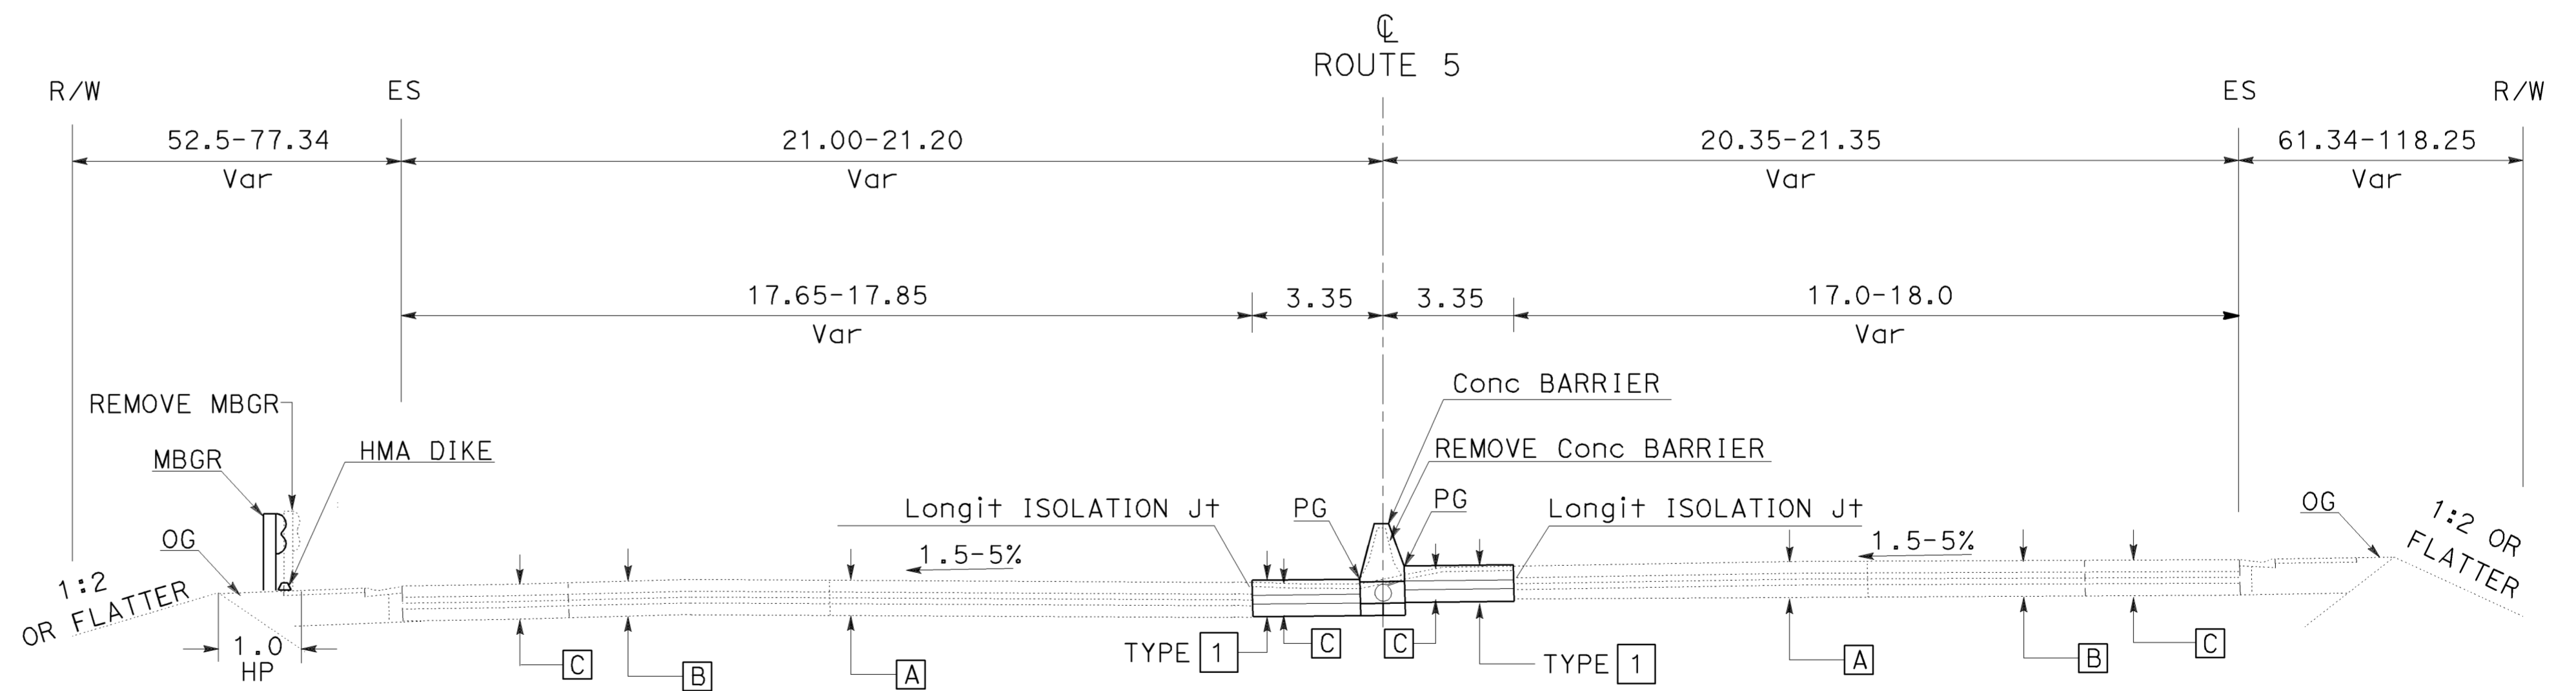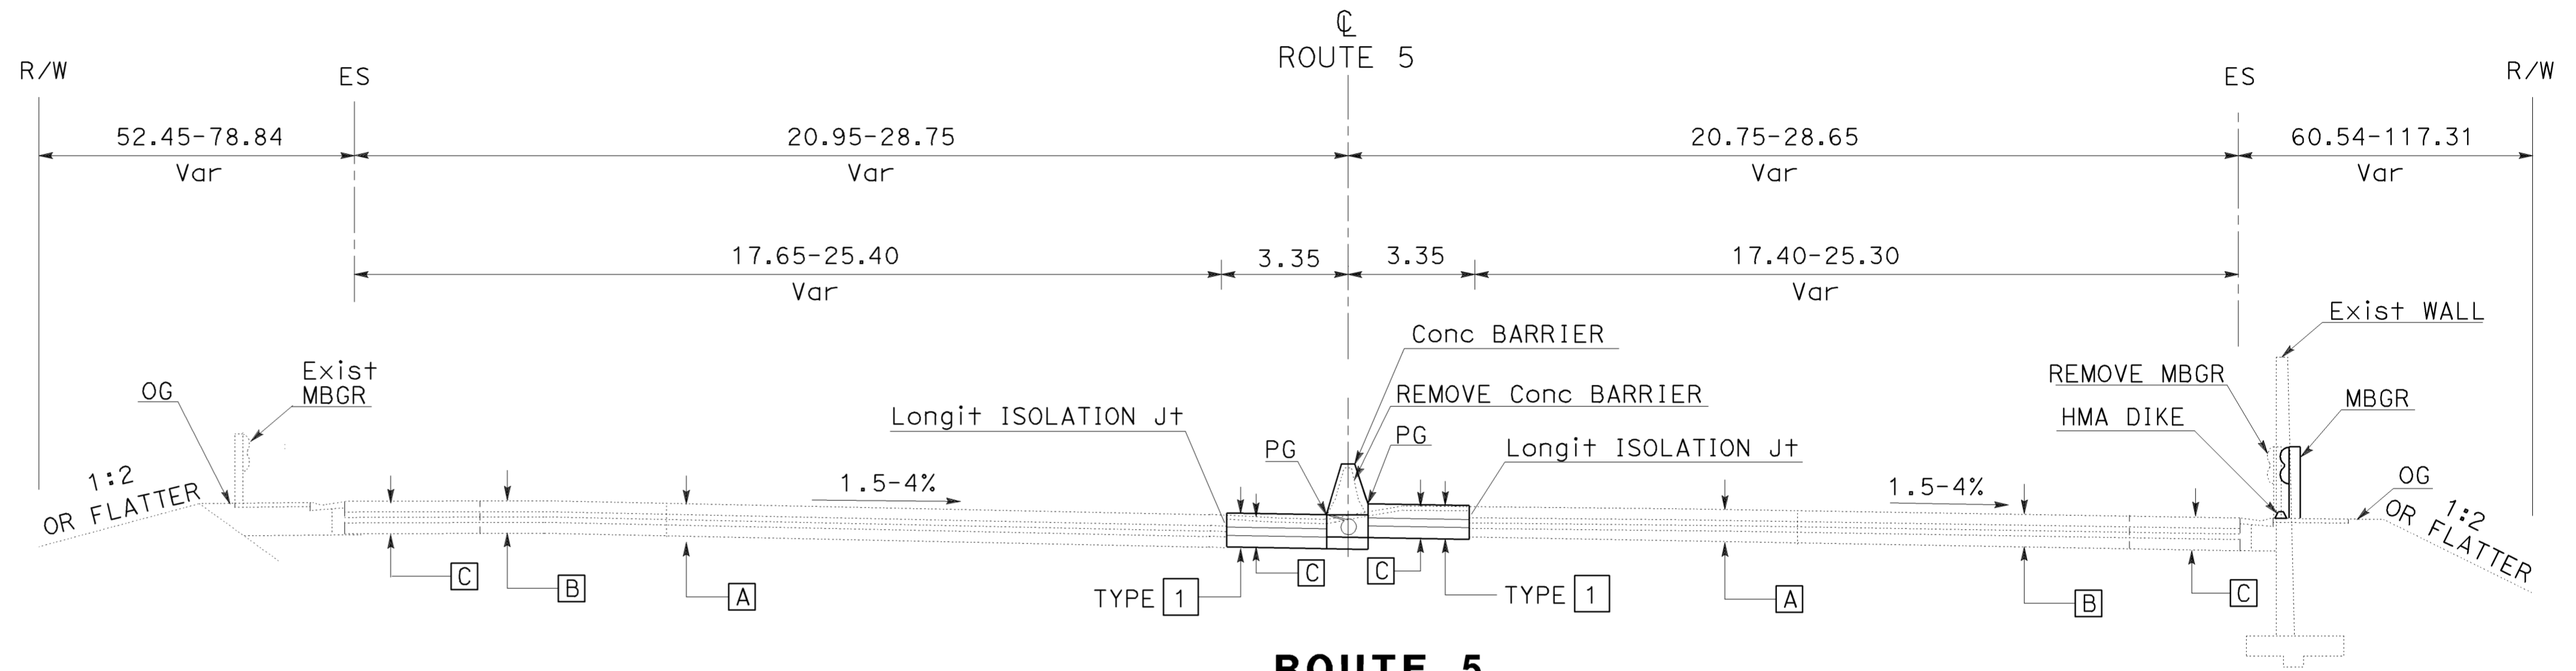

ALL DIMENSIONS ARE IN METERS UNLESS OTHERWISE SHOWN

TYPICAL CROSS SECTIONS
 NO SCALE

X-1




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07	LA	5	42.8/47.3	3	1073

<i>Munshi</i>	2-17-09
REGISTERED CIVIL ENGINEER	DATE
6-8-09	
PLANS APPROVAL DATE	


REGISTERED PROFESSIONAL ENGINEER
MUNSHI MOHSIN
No. 61916
Exp. 9/30/09
CIVIL
STATE OF CALIFORNIA

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Caltrans OFFICE OF DESIGN D
 FUNCTIONAL SUPERVISOR: CELINA AVILES
 CHECKED BY: DAWIT WORKU
 DESIGNED BY: MUNSHI MOHSIN
 REVISIONS: 01/08 SA, 02/09 CTT

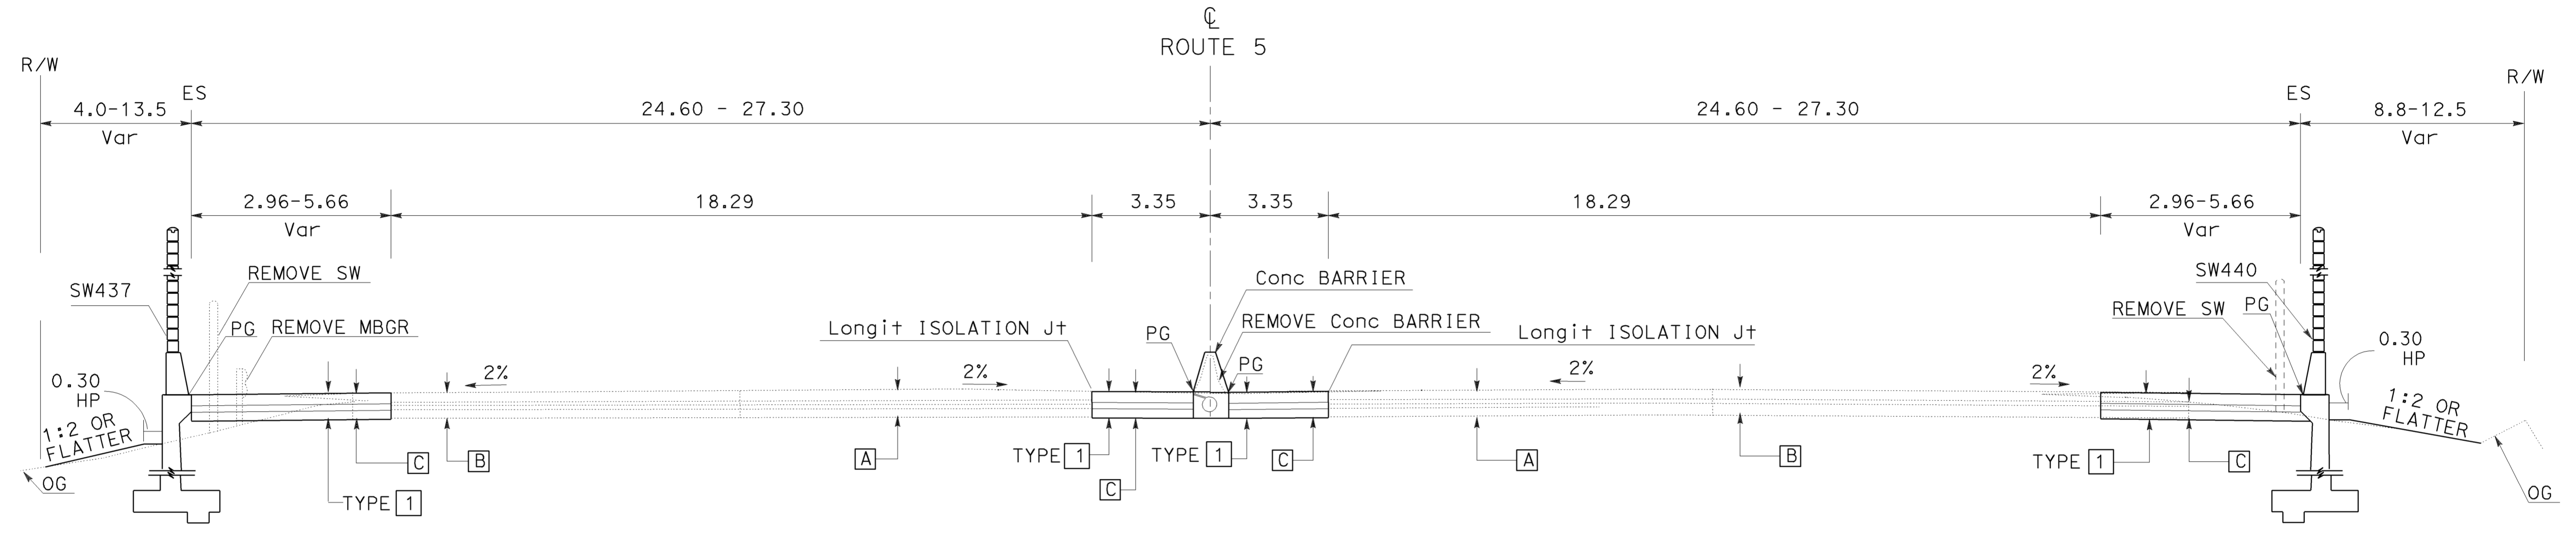

ROUTE 5
 STA 438+86.740 TO 442+92.025

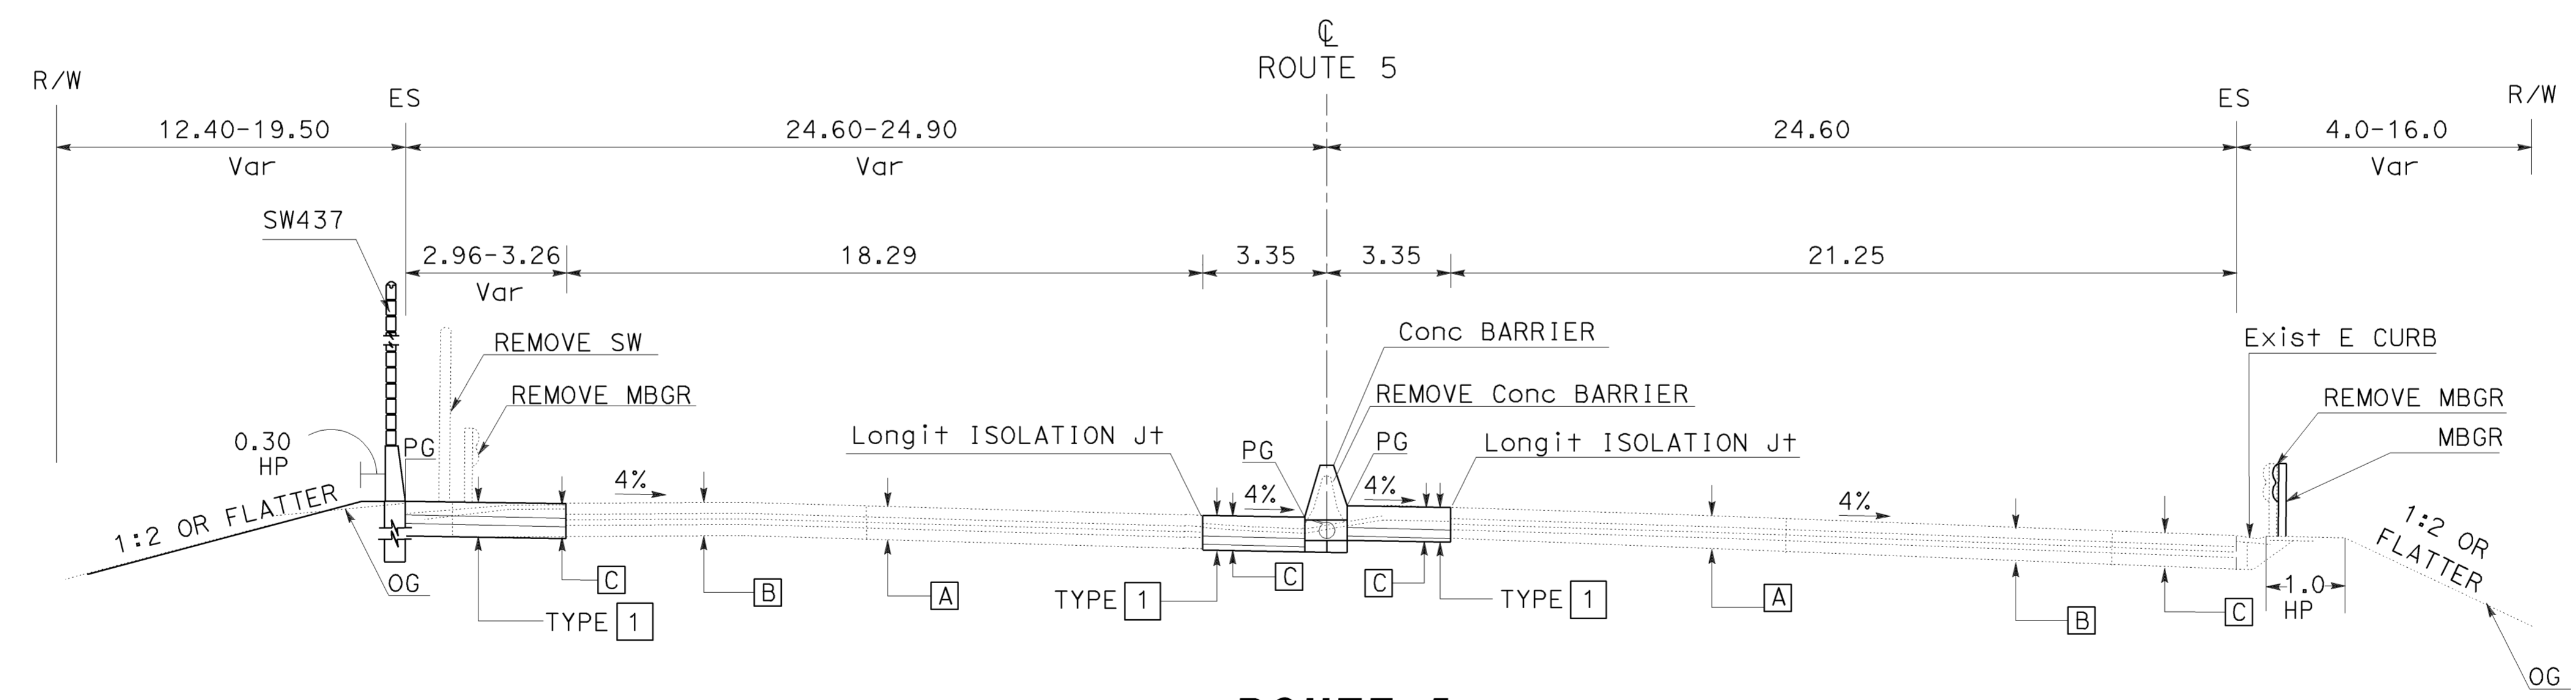

ROUTE 5
 STA 437+55.146 TO 438+86.740

* SEE LAYOUT SHEET

ALL DIMENSIONS ARE IN METERS
 UNLESS OTHERWISE SHOWN
TYPICAL CROSS SECTIONS
 NO SCALE
X-2




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07	LA	5	42.8/47.3	4	1073

<i>Munshi</i>	2-17-09
REGISTERED CIVIL ENGINEER	DATE
6-8-09	
PLANS APPROVAL DATE	

REGISTERED PROFESSIONAL ENGINEER
MUNSHI MOHSIN
No. 61916
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CIVIL
STATE OF CALIFORNIA


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 FUNCTIONAL SUPERVISOR: CELINA AVILES
 CALCULATED-DRAWN BY: MOHSIN MUNSHI
 CHECKED BY:
 DAWIT WORKU
 MOHSIN MUNSHI
 REVISIONS: SA 01/08, CTT 02/09

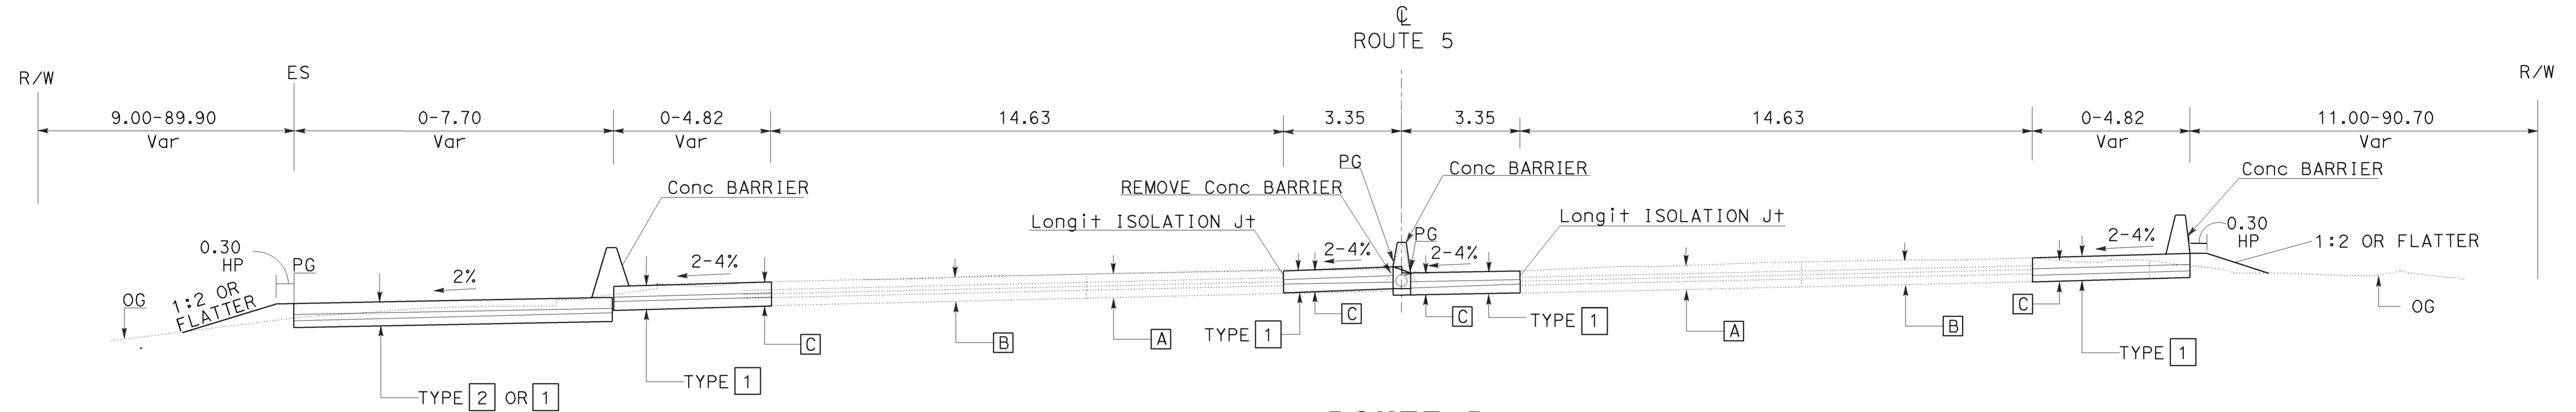

ROUTE 5

STA 444+73.880 TO 447+78.692
 STA 448+28.696 TO 450+00.000

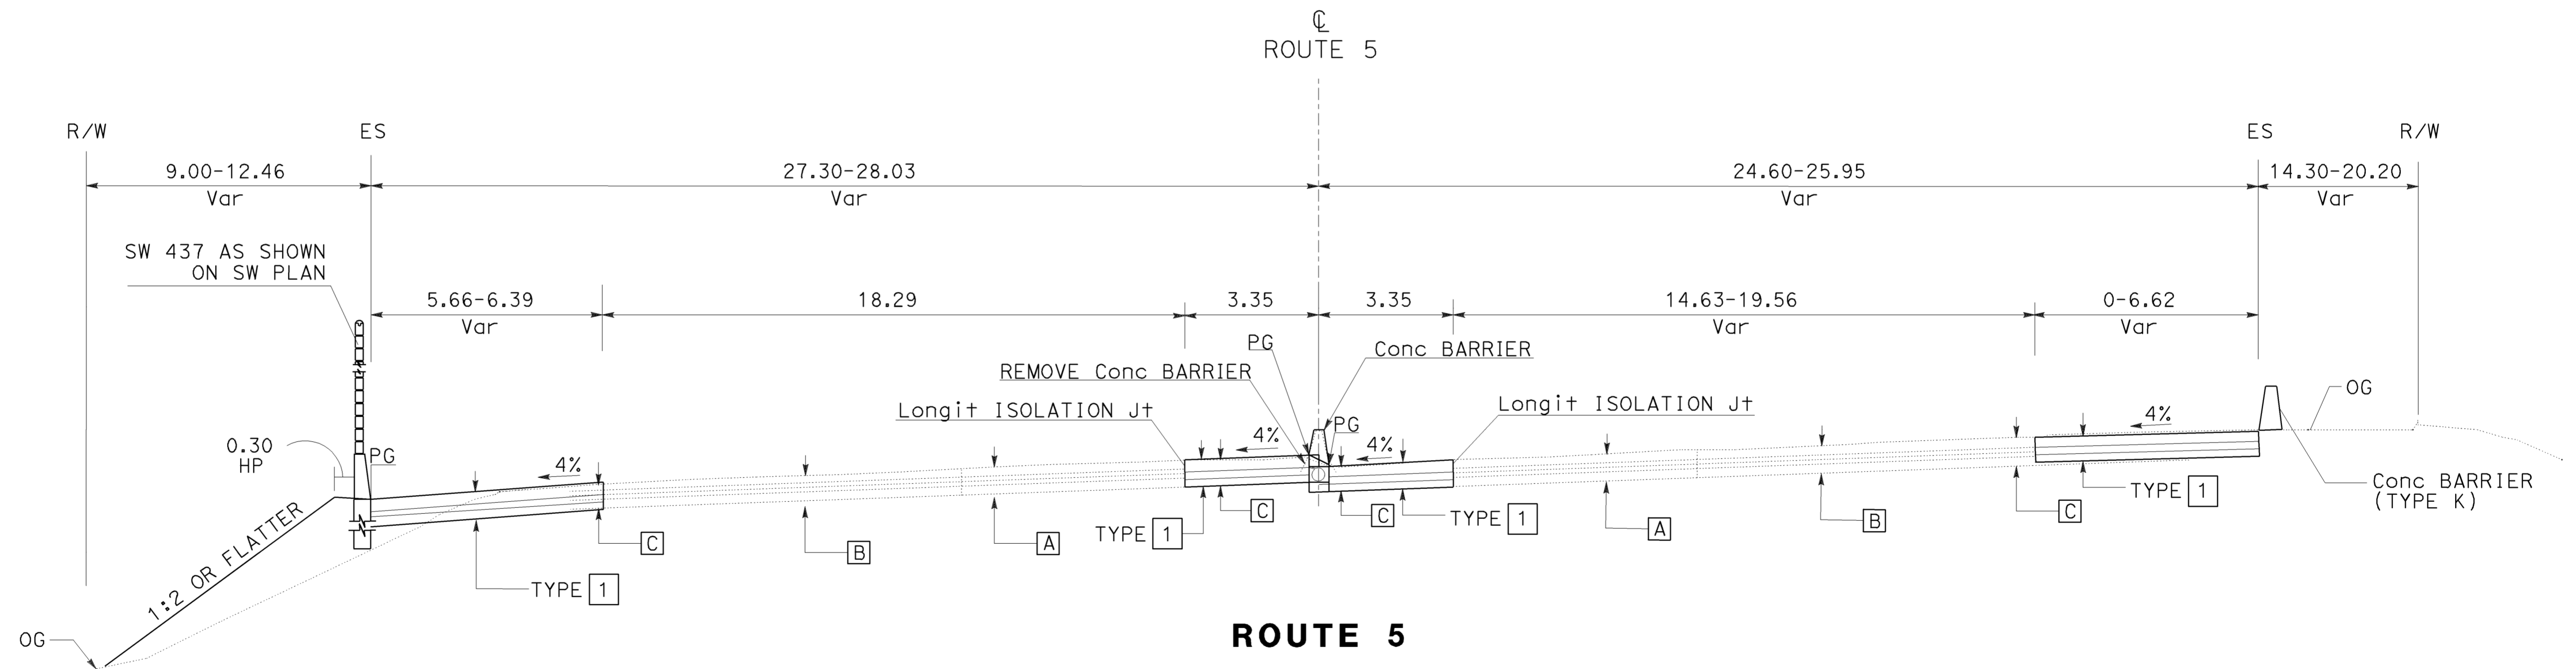

ROUTE 5

STA 443+44.225 TO 444+73.880

ALL DIMENSIONS ARE IN METERS
 UNLESS OTHERWISE SHOWN

TYPICAL CROSS SECTIONS

NO SCALE

X-3

* SEE LAYOUT SHEET


STATE OF CALIFORNIA - DEPARTMENT OF TRANSPORTATION
Caltrans OFFICE OF DESIGN D
 FUNCTIONAL SUPERVISOR
 CELINA AVILES
 CALCULATED-DESIGNED BY
 CHECKED BY
 DAWIT WORKU
 MUNSHI MOHSIN
 REVISOR BY
 DATE REVISED
 SA
 01/08
 CTT
 02/09



Dist	COUNTY	ROUTE	KILOMETER POST TOTAL PROJECT	SHEET No.	TOTAL SHEETS
07	LA	5	42.8/47.3	5	1073


REGISTERED CIVIL ENGINEER DATE 2-17-09
 6-8-09
 PLANS APPROVAL DATE
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REGISTERED PROFESSIONAL ENGINEER
 MUNSHI MOHSIN
 No. 61916
 Exp. 9/30/09
 CIVIL
 STATE OF CALIFORNIA

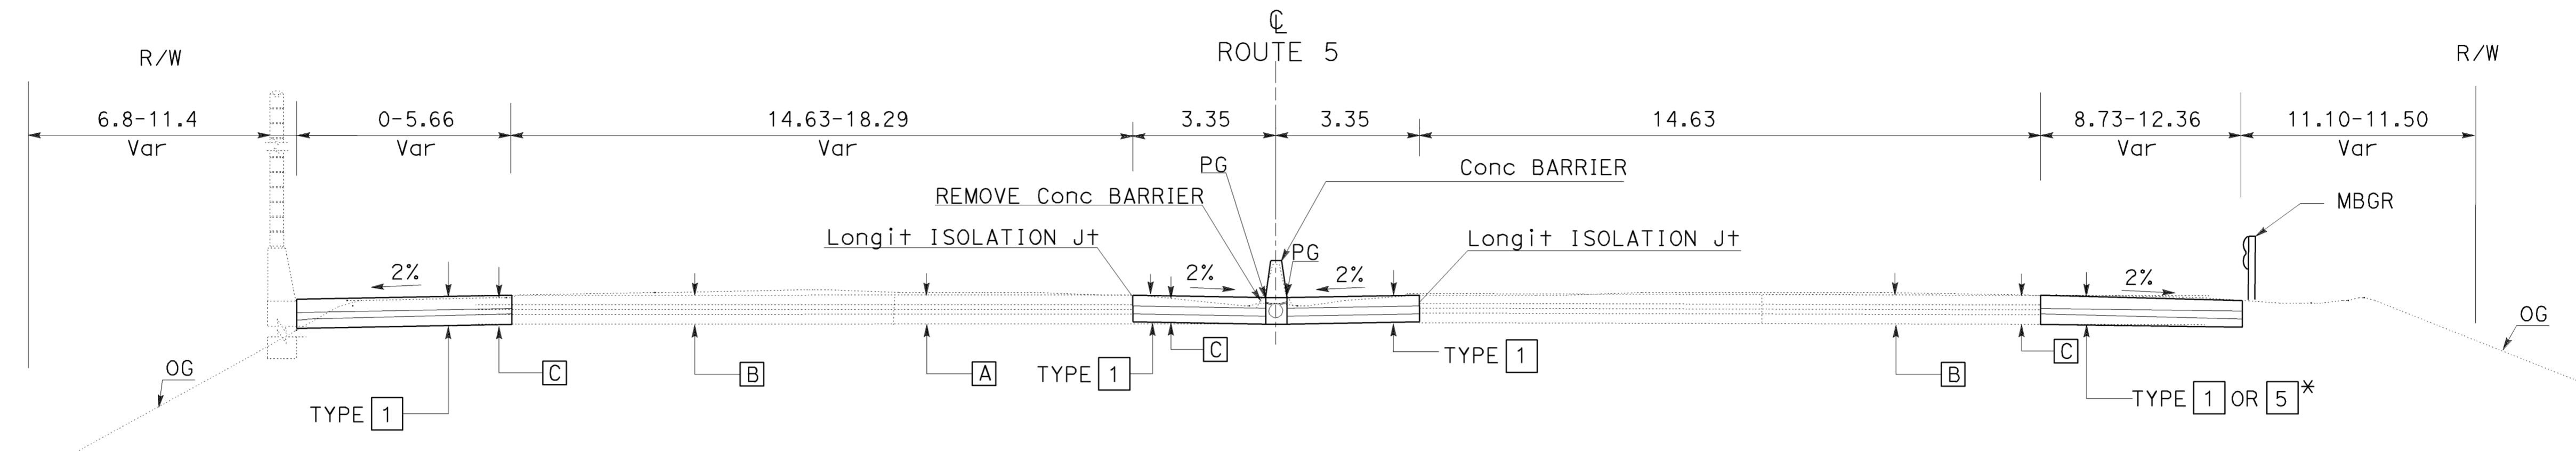

ROUTE 5

STA 451+00.000 TO 452+56.620
 STA 453+00.000 TO 454+28.850

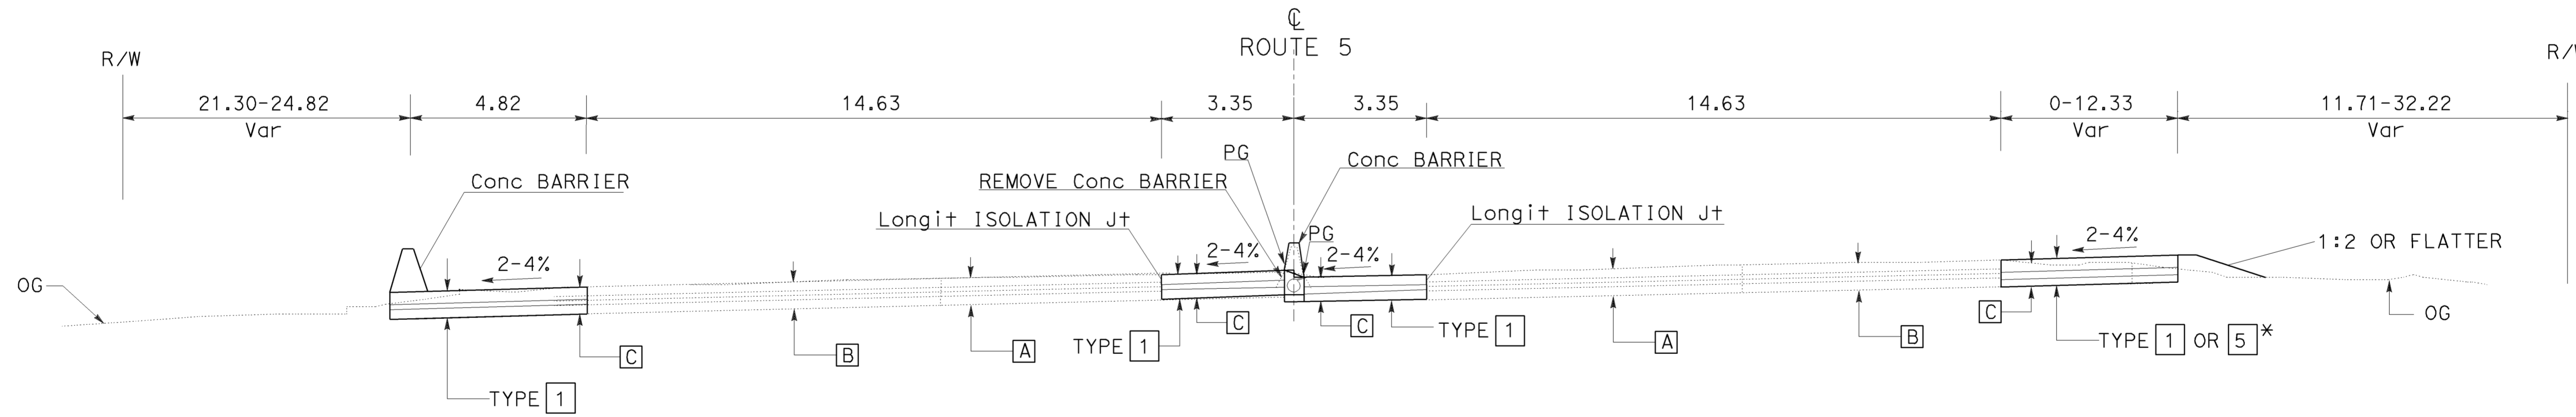

ROUTE 5

STA 450+00.000 TO 451+00.000

* SEE LAYOUT SHEET


ALL DIMENSIONS ARE IN METERS
 UNLESS OTHERWISE SHOWN
TYPICAL CROSS SECTIONS
 NO SCALE

X-4




Dist	COUNTY	ROUTE	KILOMETER POST TOTAL PROJECT	SHEET No.	TOTAL SHEETS
07	LA	5	42.8/47.3	6	1073
			2-17-09	REGISTERED PROFESSIONAL ENGINEER	
			DATE	MUNSHI MOHSIN	
			6-8-09	No. 61916	
			PLANS APPROVAL DATE	Exp. 9/30/09	
<small>THE STATE OF CALIFORNIA OR ITS OFFICERS OR AGENTS SHALL NOT BE RESPONSIBLE FOR THE ACCURACY OR COMPLETENESS OF ELECTRONIC COPIES OF THIS PLAN SHEET.</small>					

CTT	02/09
SA	01/08
REVISOR	DATE
DAWIT WORKU	MUNSHI MOHSIN
CHECKED BY	
FUNCTIONAL SUPERVISOR	CELINA AVILES
DESIGNATION	DESIGN D

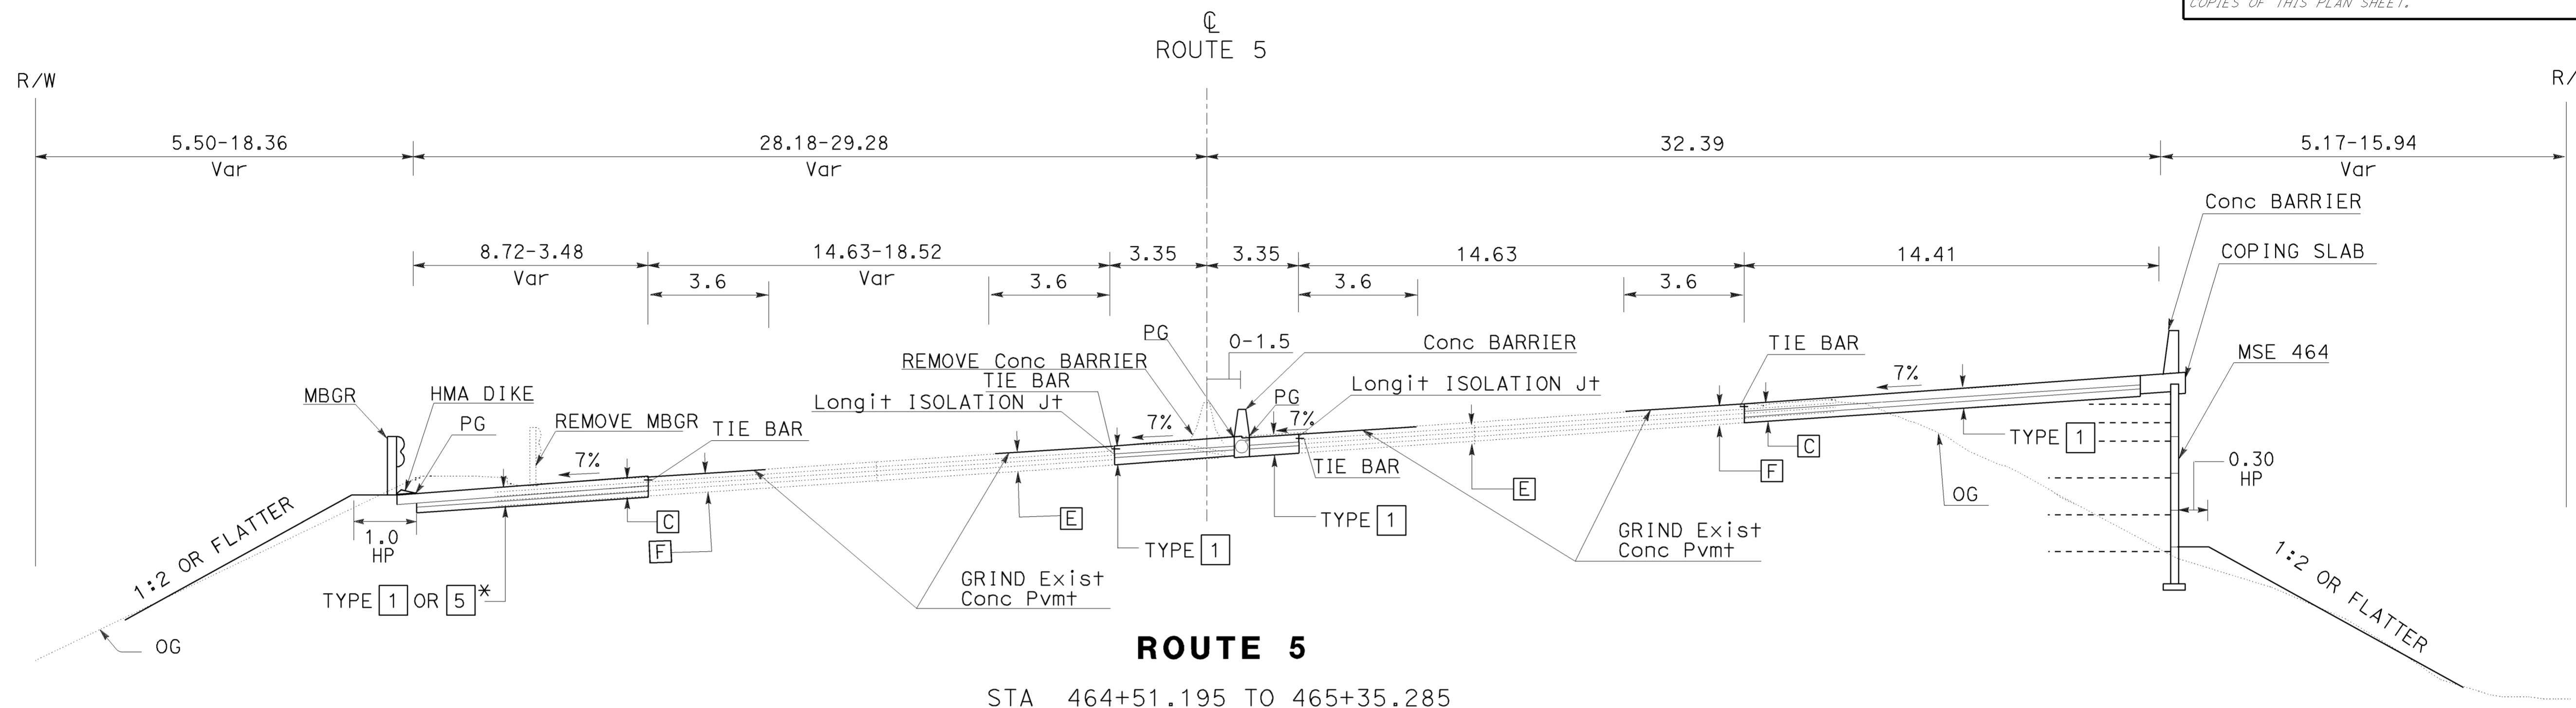

ROUTE 5
STA 464+51.195 TO 465+35.285

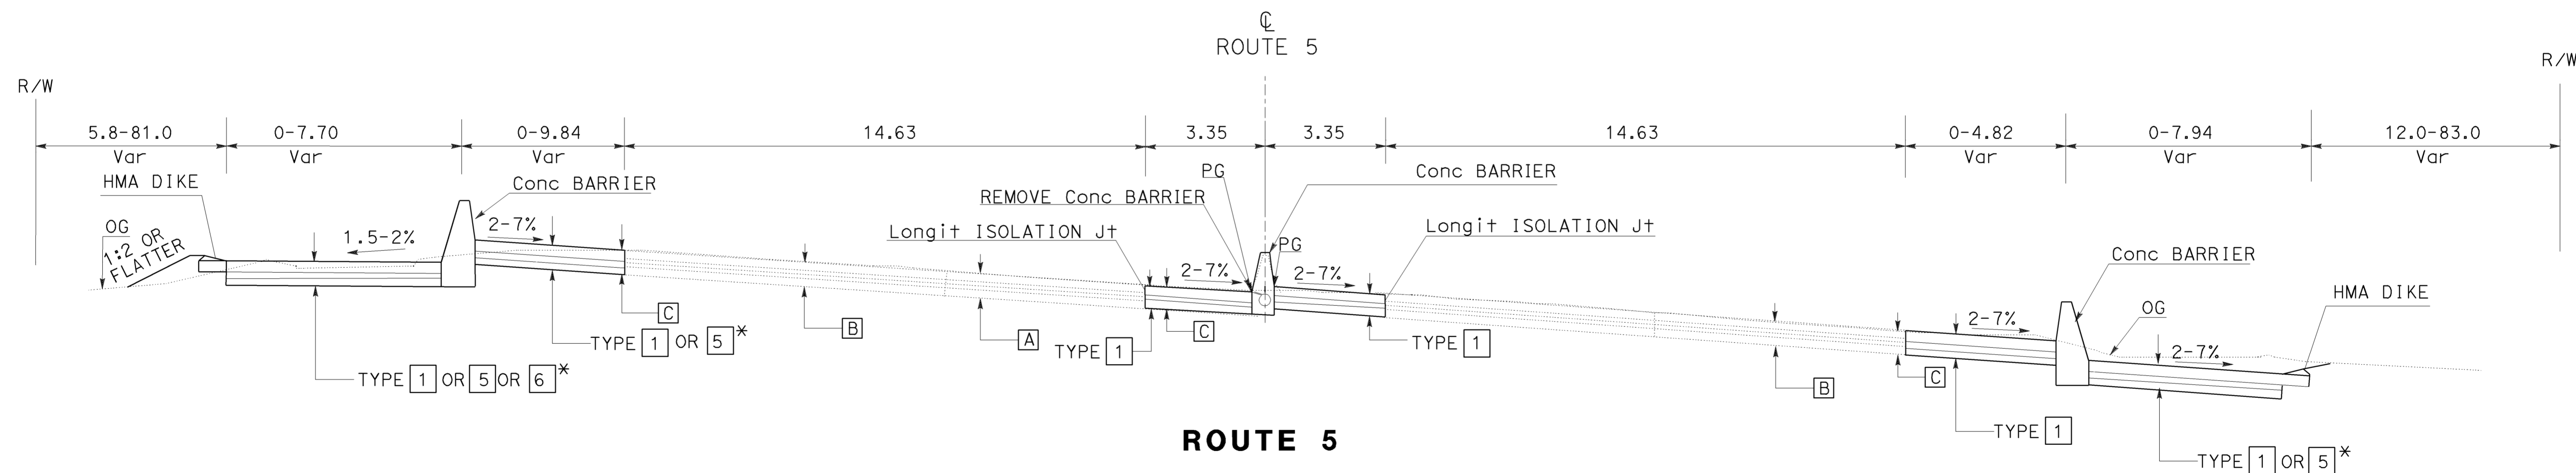

ROUTE 5
STA 454+28.850 TO 457+27.301
STA 457+77.305 TO 461+64.360

ALL DIMENSIONS ARE IN METERS
UNLESS OTHERWISE SHOWN
TYPICAL CROSS SECTIONS
NO SCALE
X-5



* SEE LAYOUT SHEET



Dist	COUNTY	ROUTE	KILOMETER POST TOTAL PROJECT	SHEET No.	TOTAL SHEETS
07	LA	5	42.8/47.3	7	1073

REGISTERED CIVIL ENGINEER DATE 2-17-09
 6-8-09 PLANS APPROVAL DATE
 REGISTERED PROFESSIONAL ENGINEER
 MUNSHI MOHSIN
 No. 61916
 Exp. 9/30/09
 CIVIL
 STATE OF CALIFORNIA

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ALL DIMENSIONS ARE IN METERS
 UNLESS OTHERWISE SHOWN
TYPICAL CROSS SECTIONS
 NO SCALE
X-6










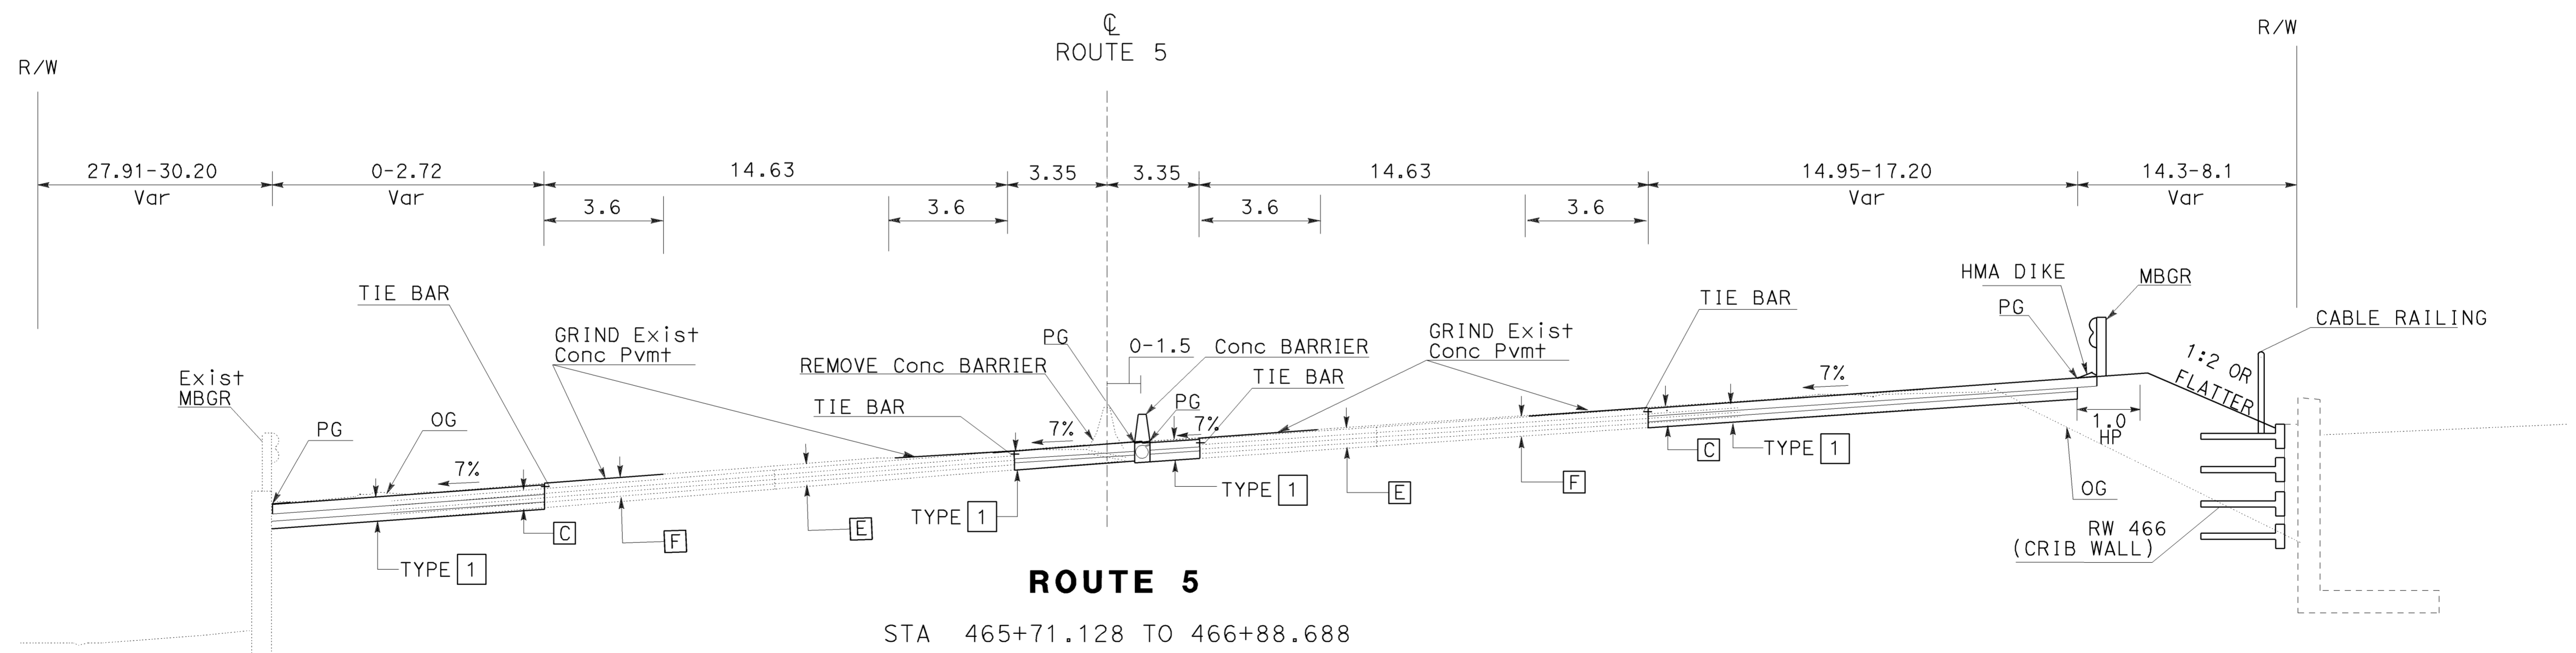
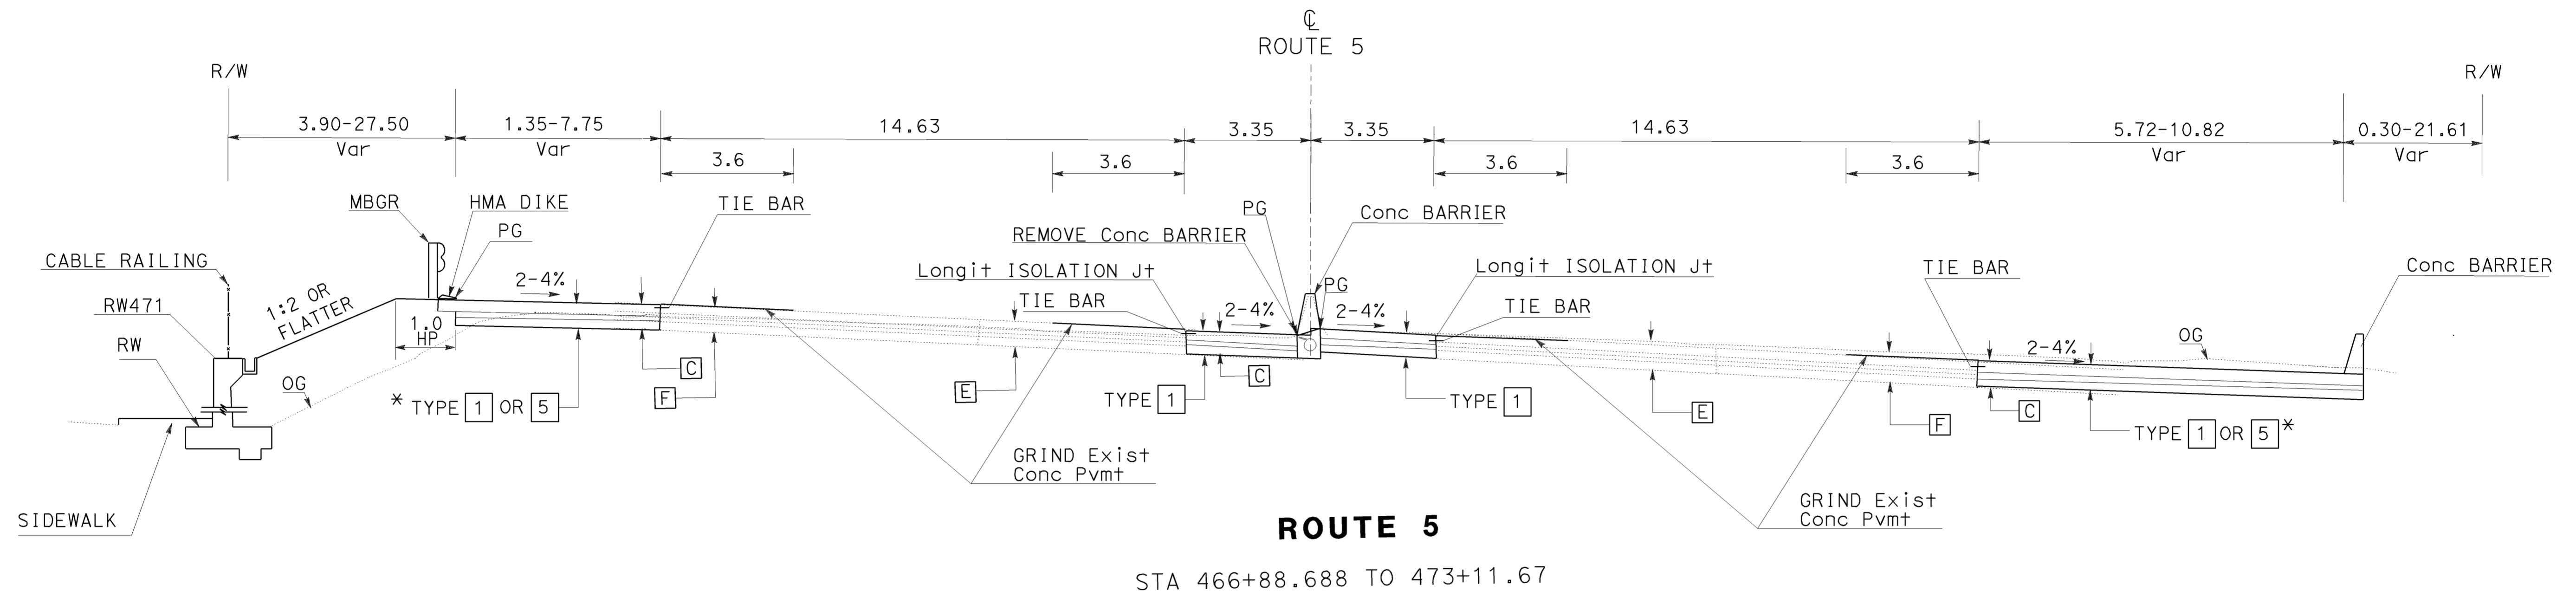
* SEE LAYOUT SHEET



Dist	COUNTY	ROUTE	KILOMETER POST TOTAL PROJECT	SHEET No.	TOTAL SHEETS
07	LA	5	42.8/47.3	8	1073

REGISTERED CIVIL ENGINEER
 DATE 2-17-09
 6-8-09
 PLANS APPROVAL DATE

REGISTERED PROFESSIONAL ENGINEER
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 Exp. 9/30/09
 CIVIL
 STATE OF CALIFORNIA

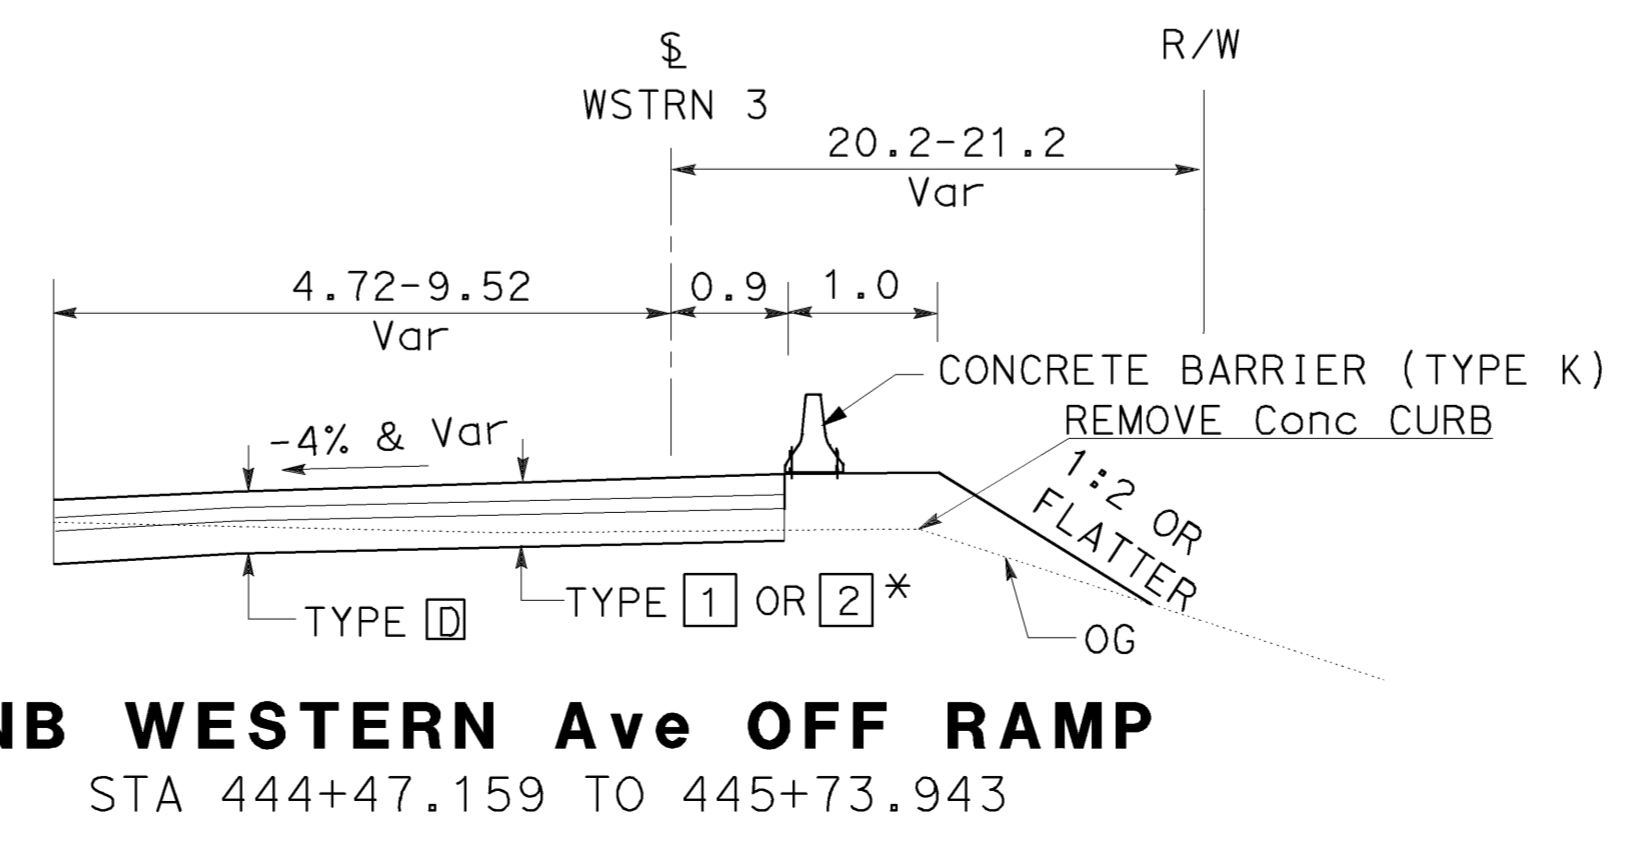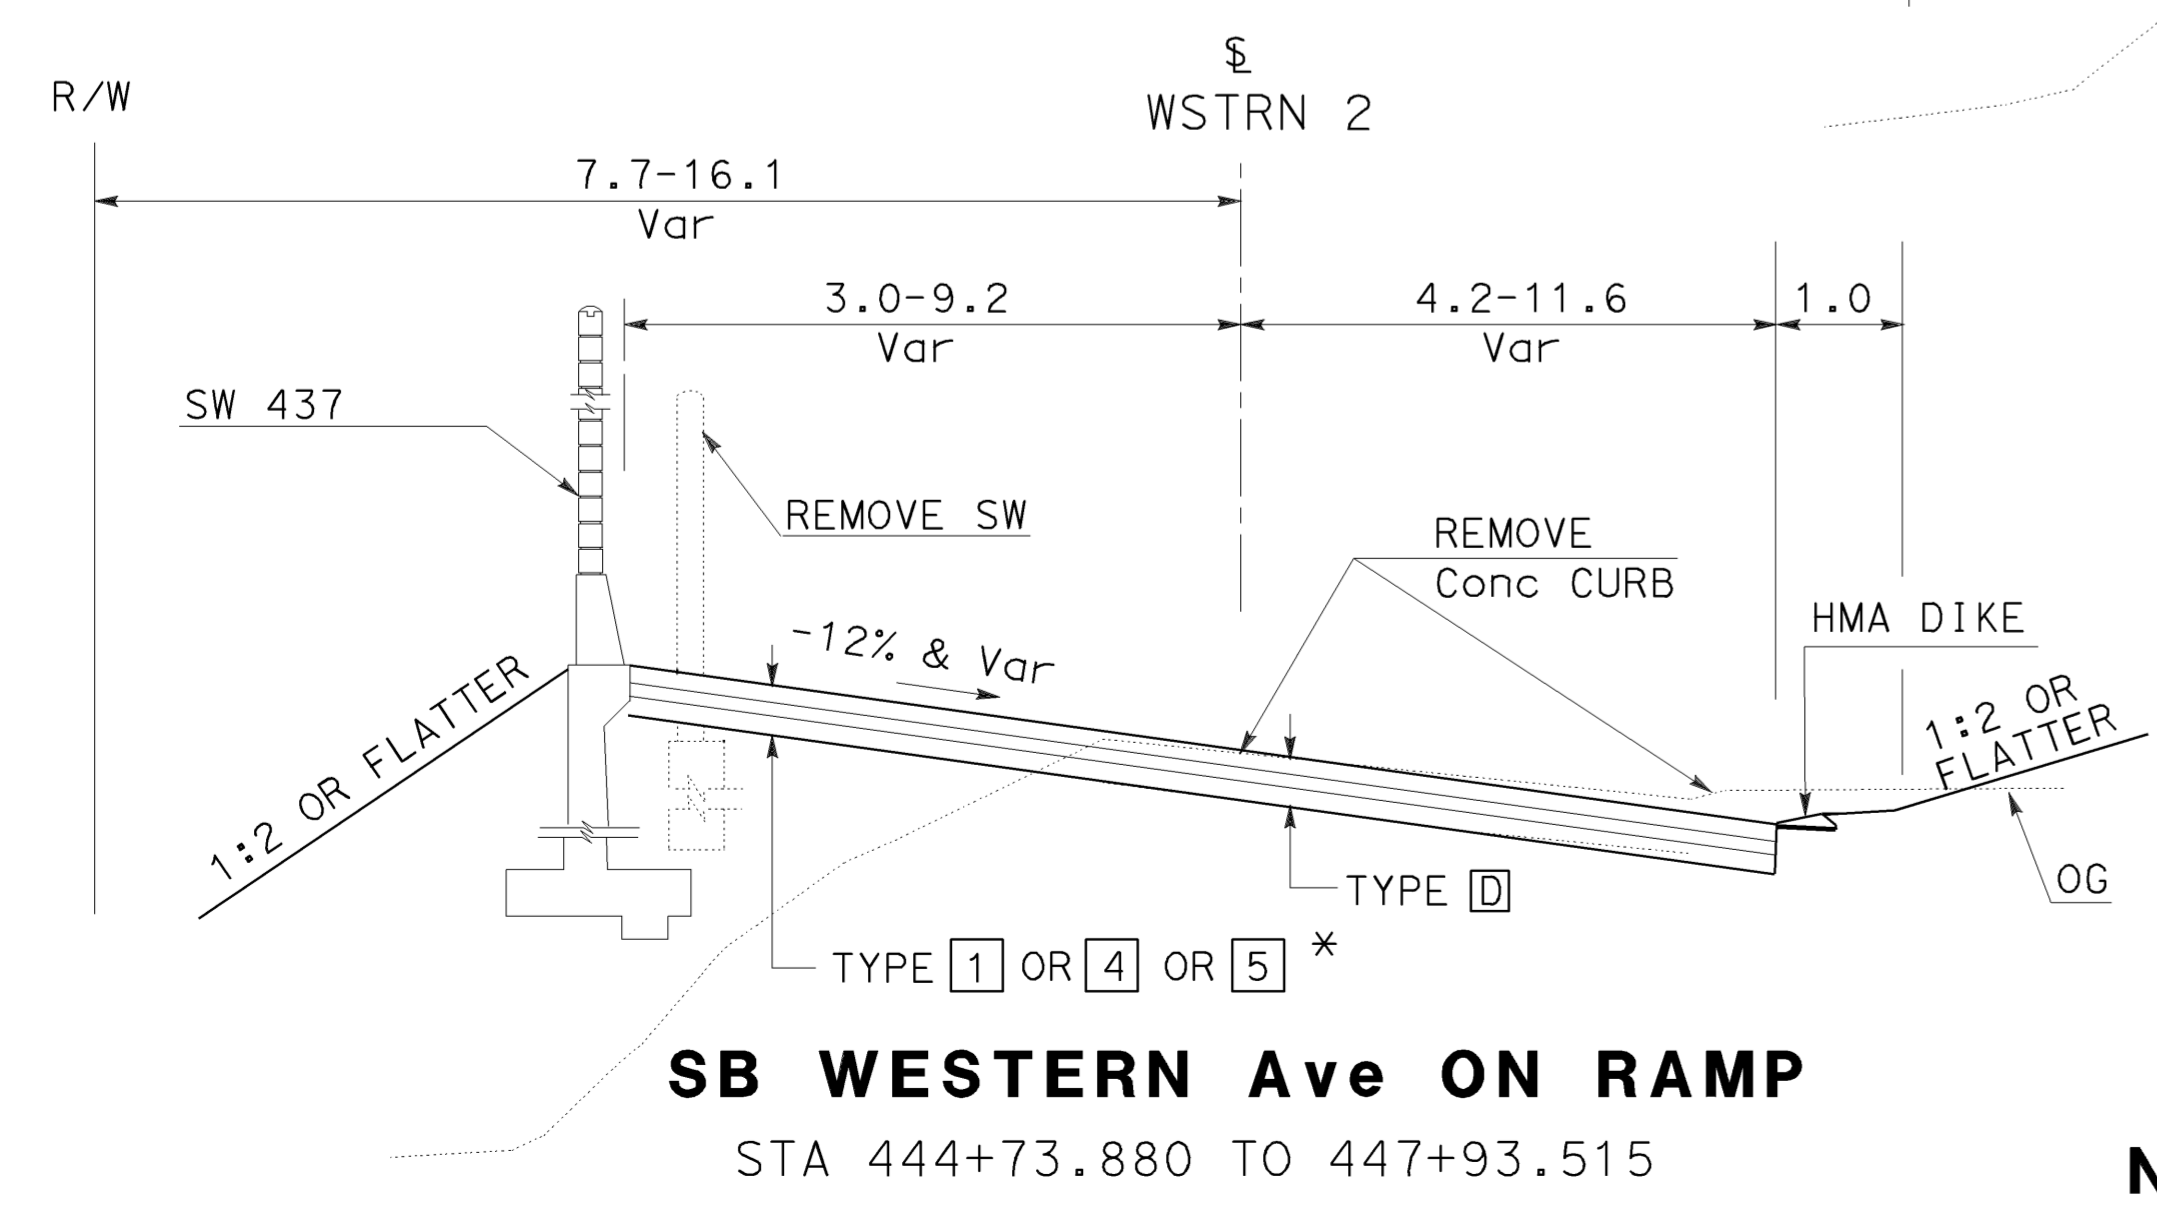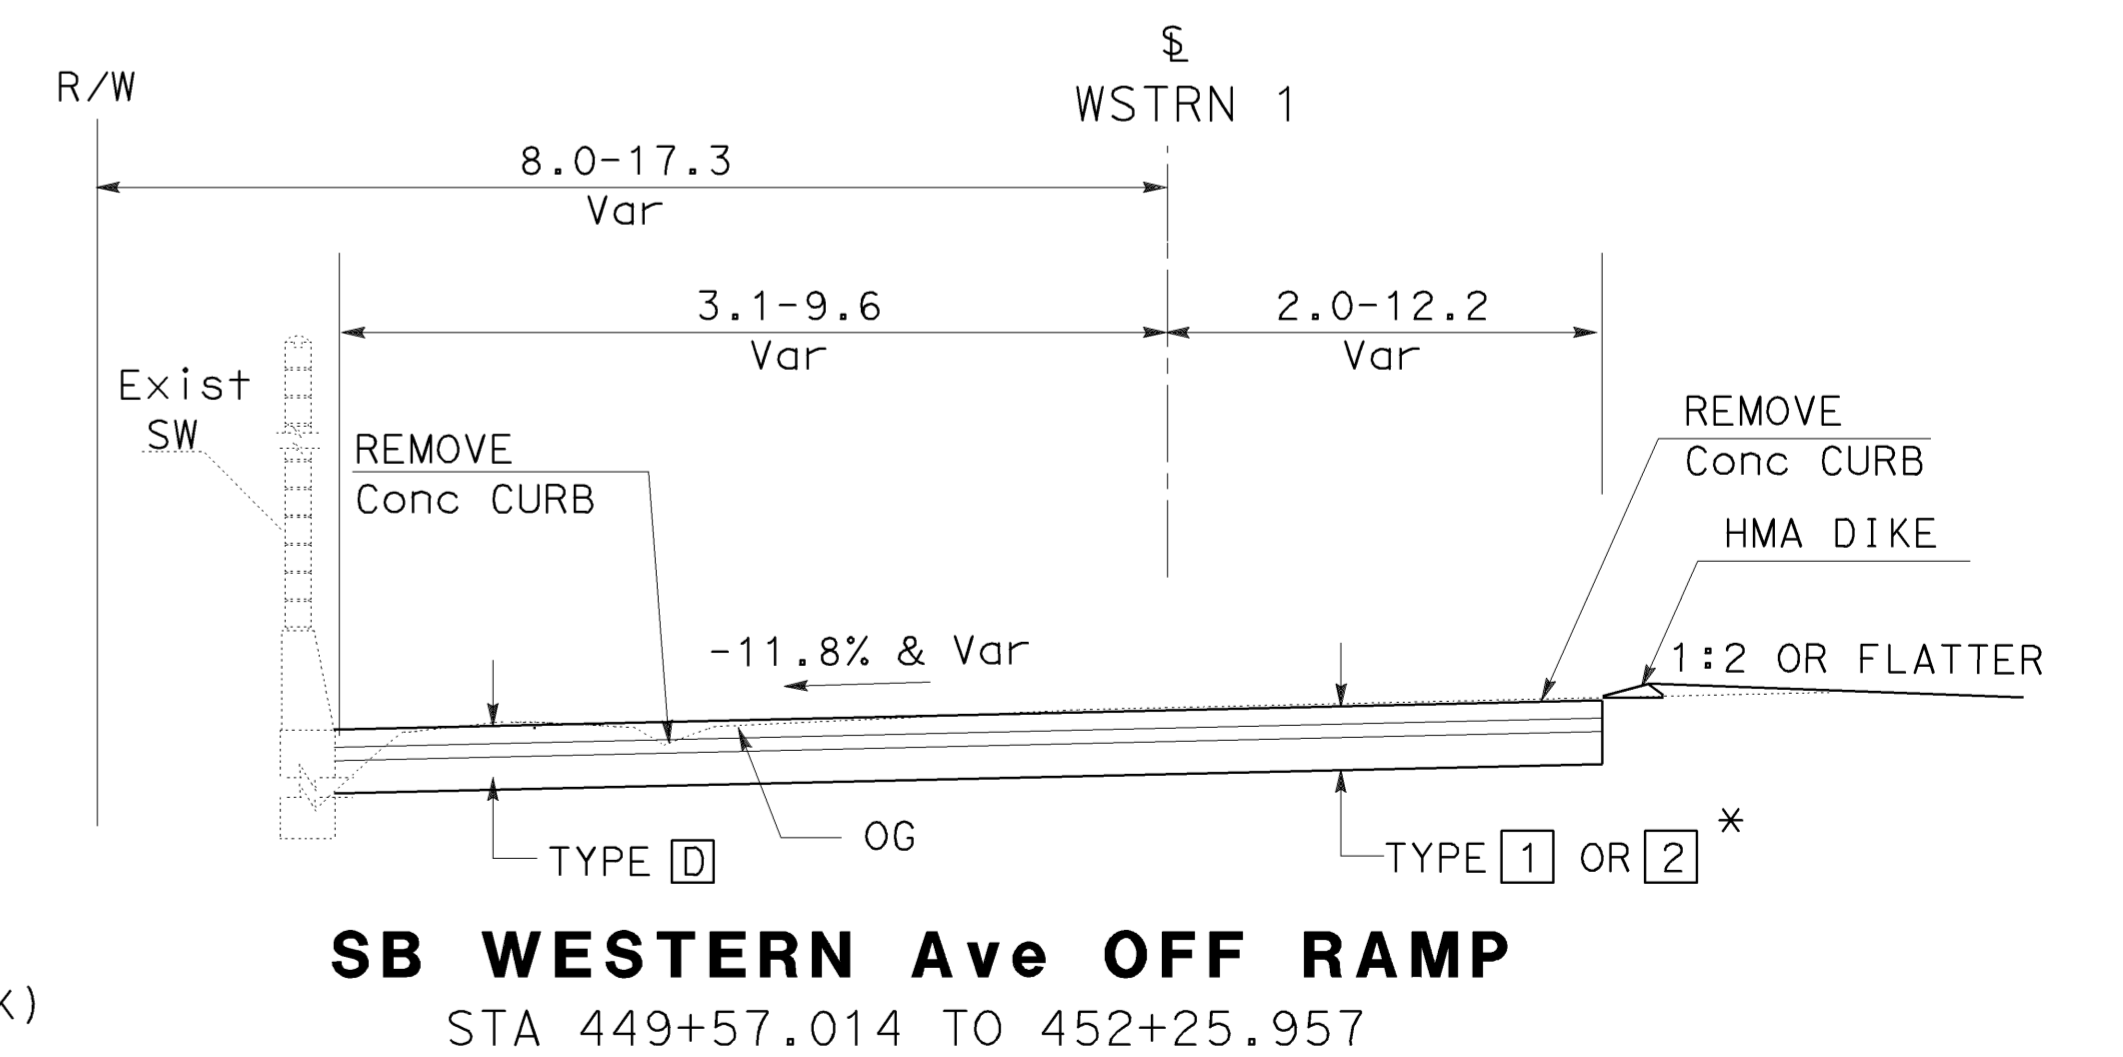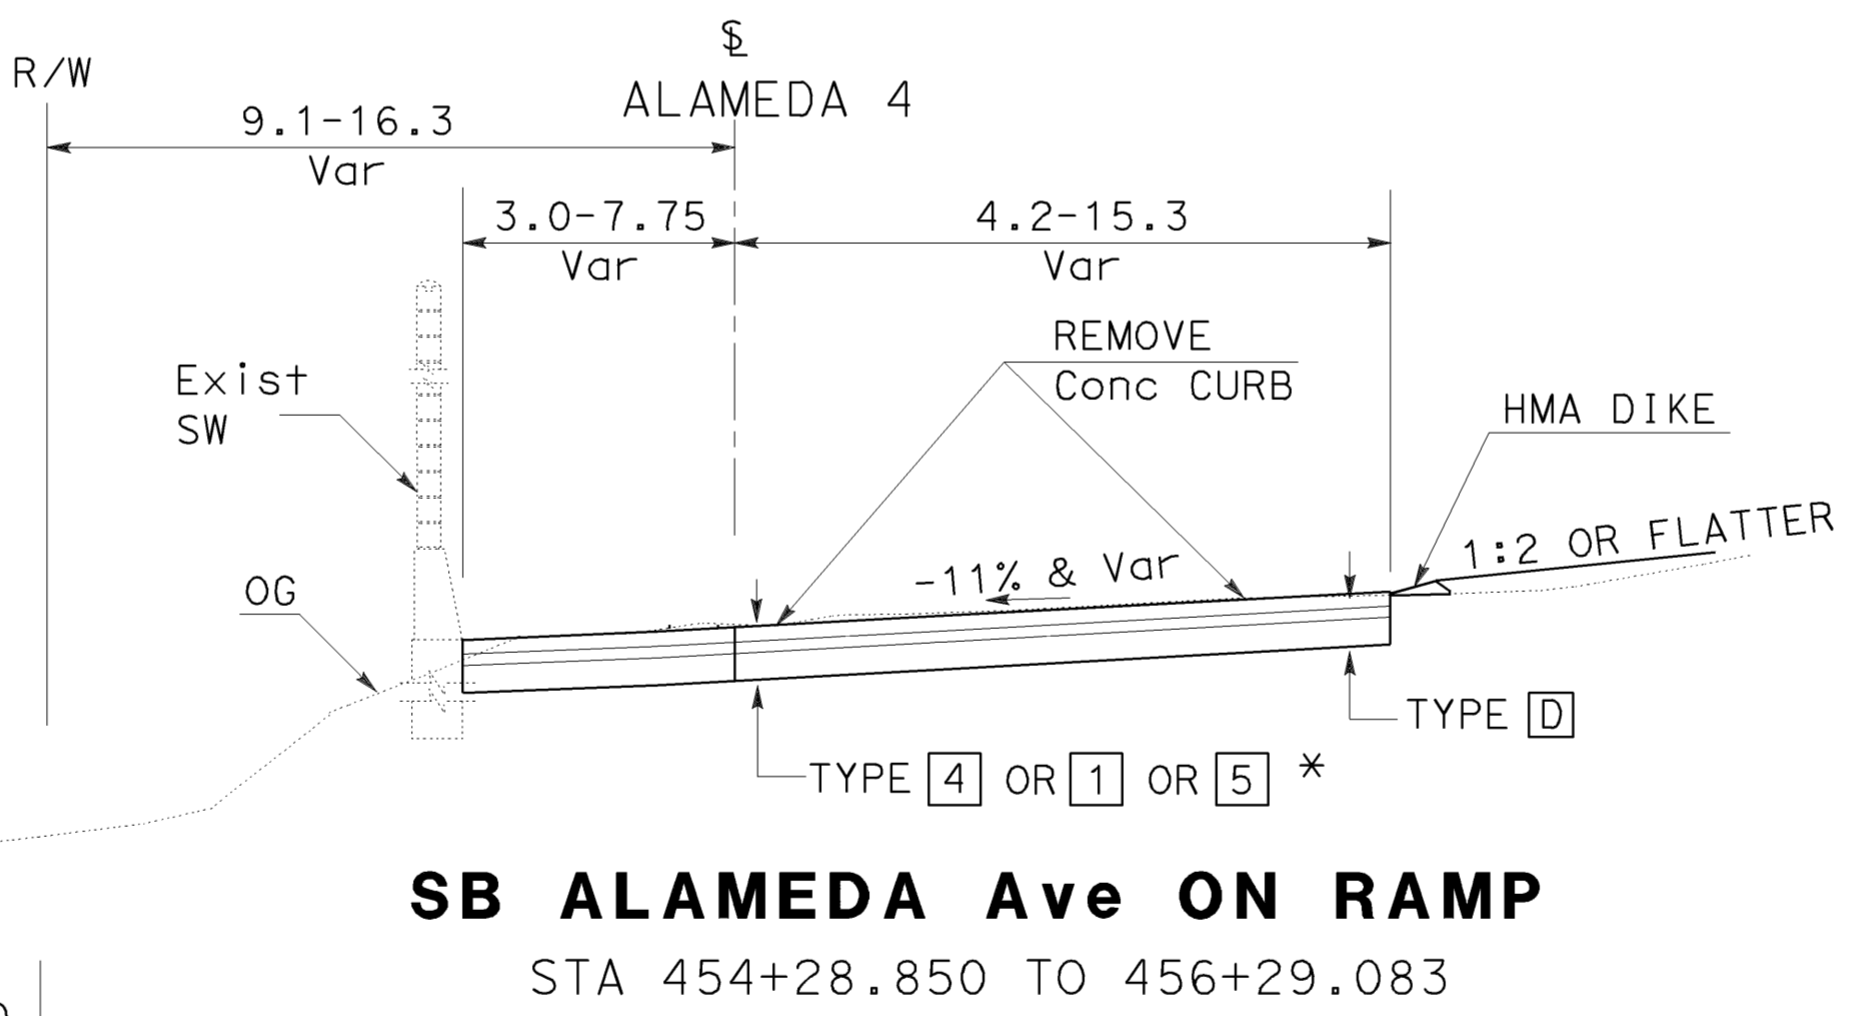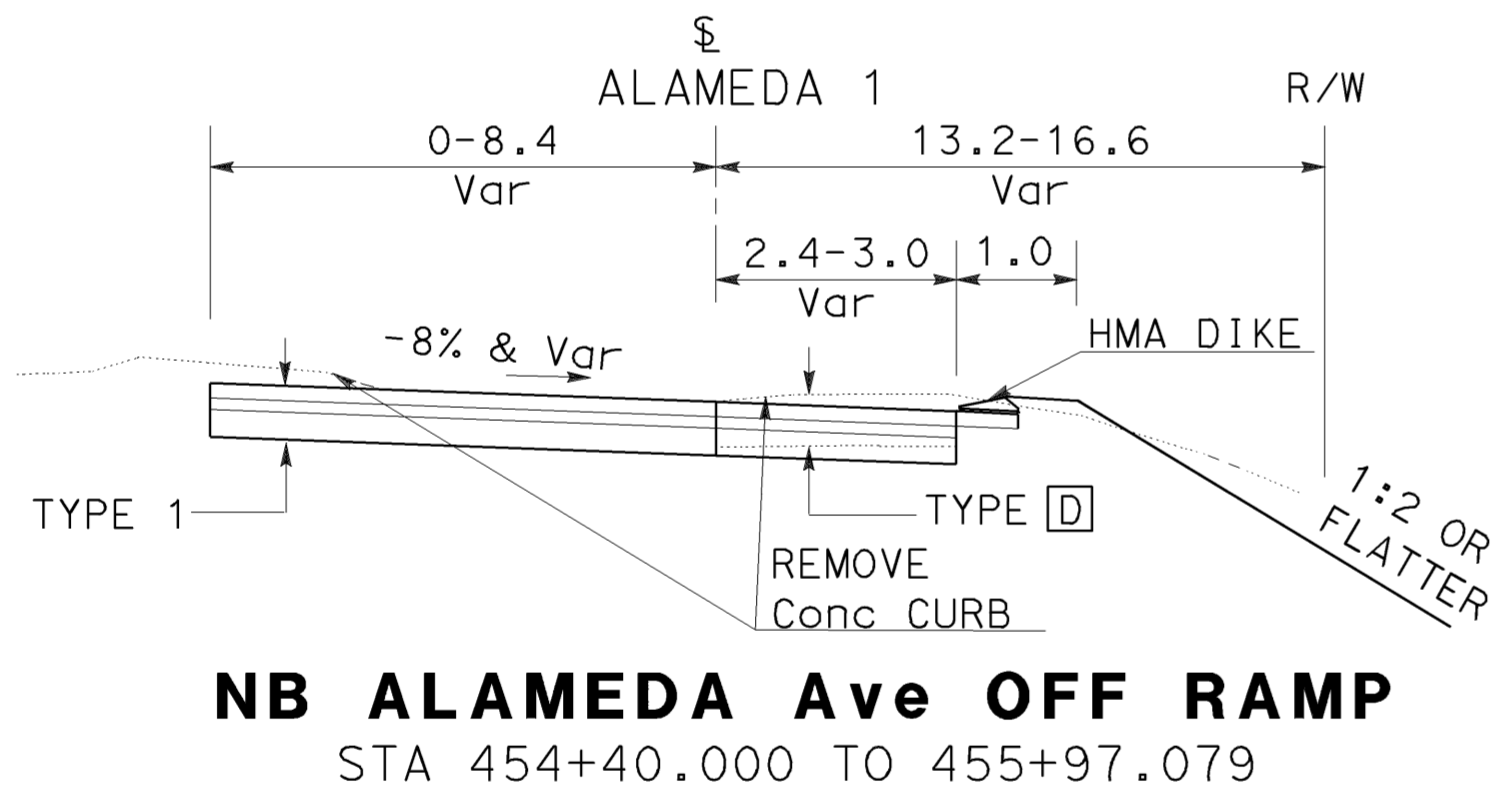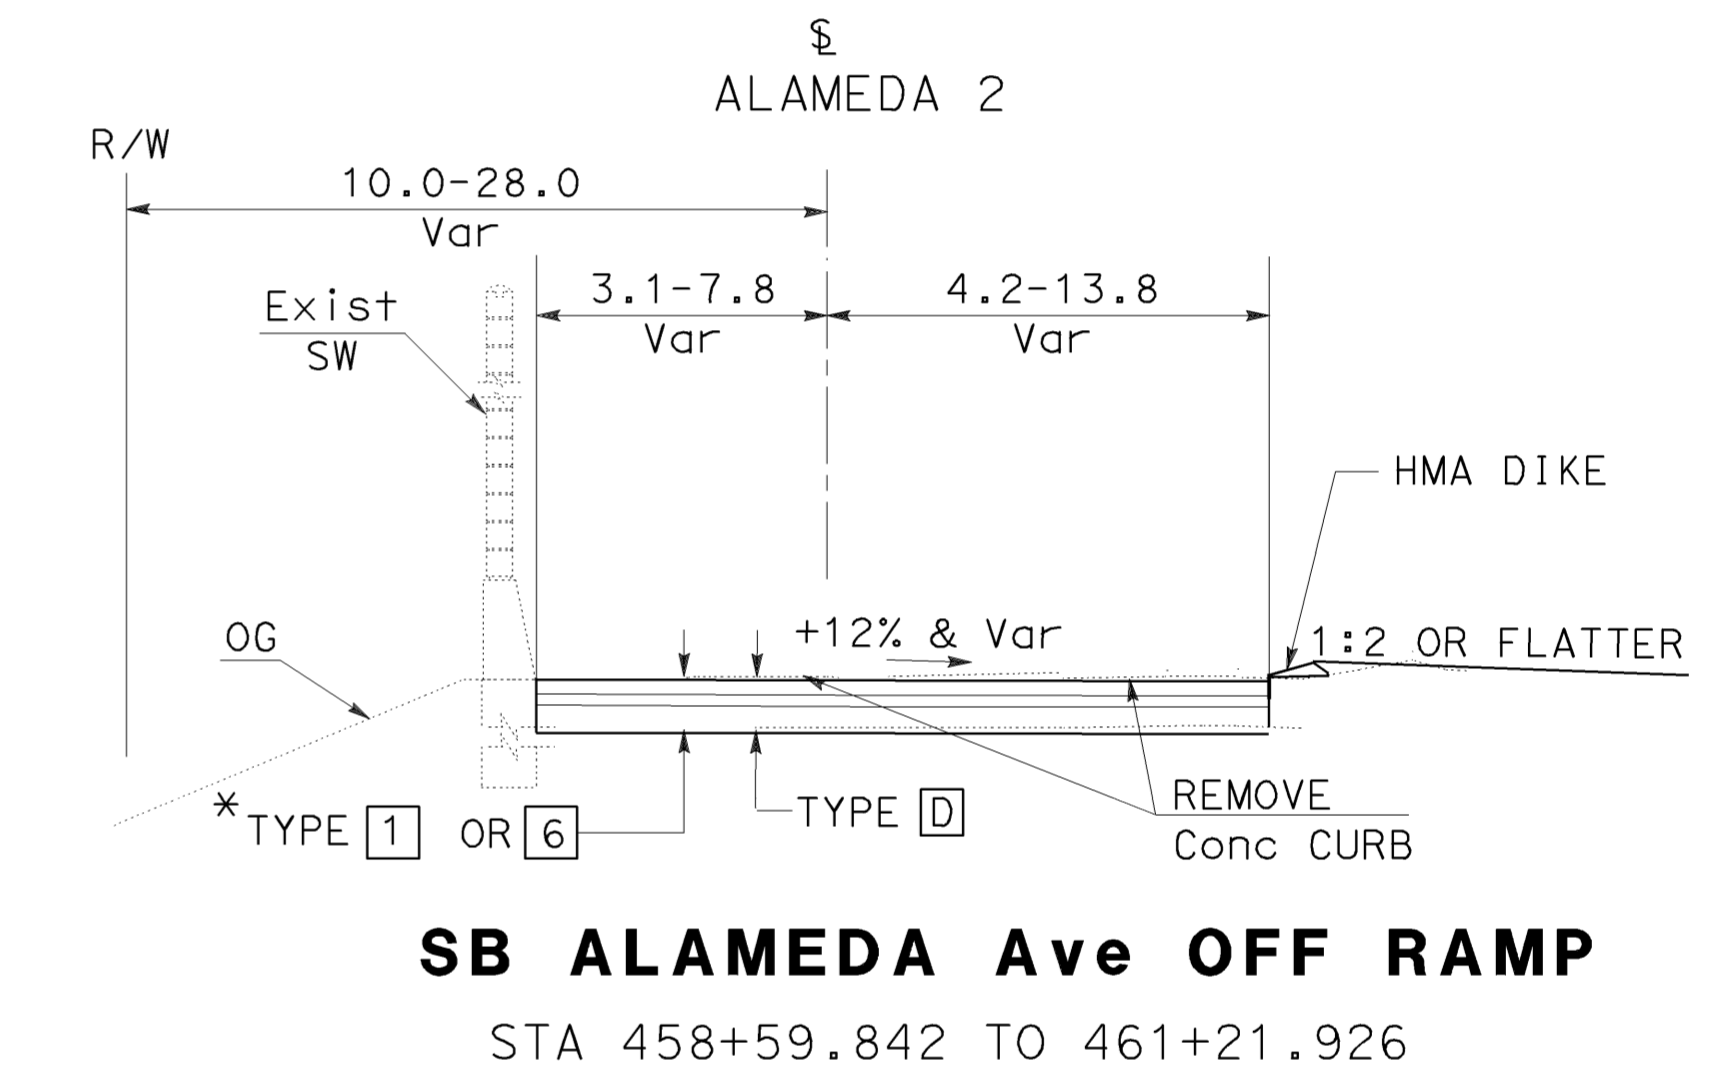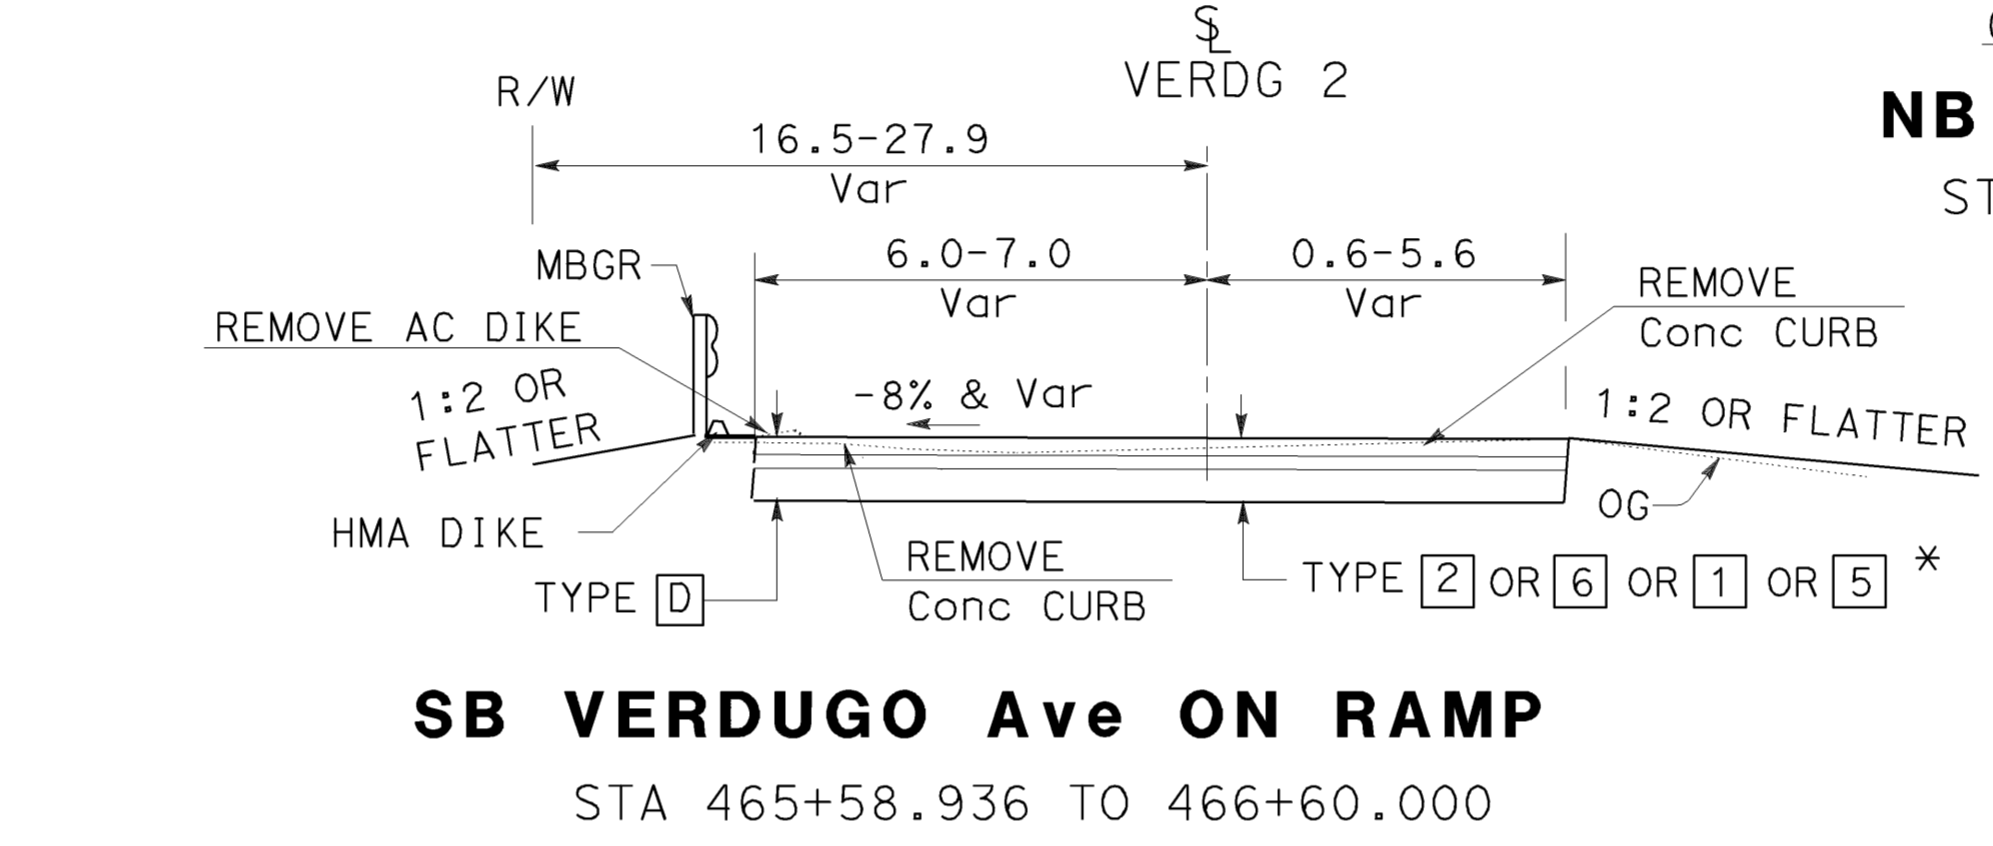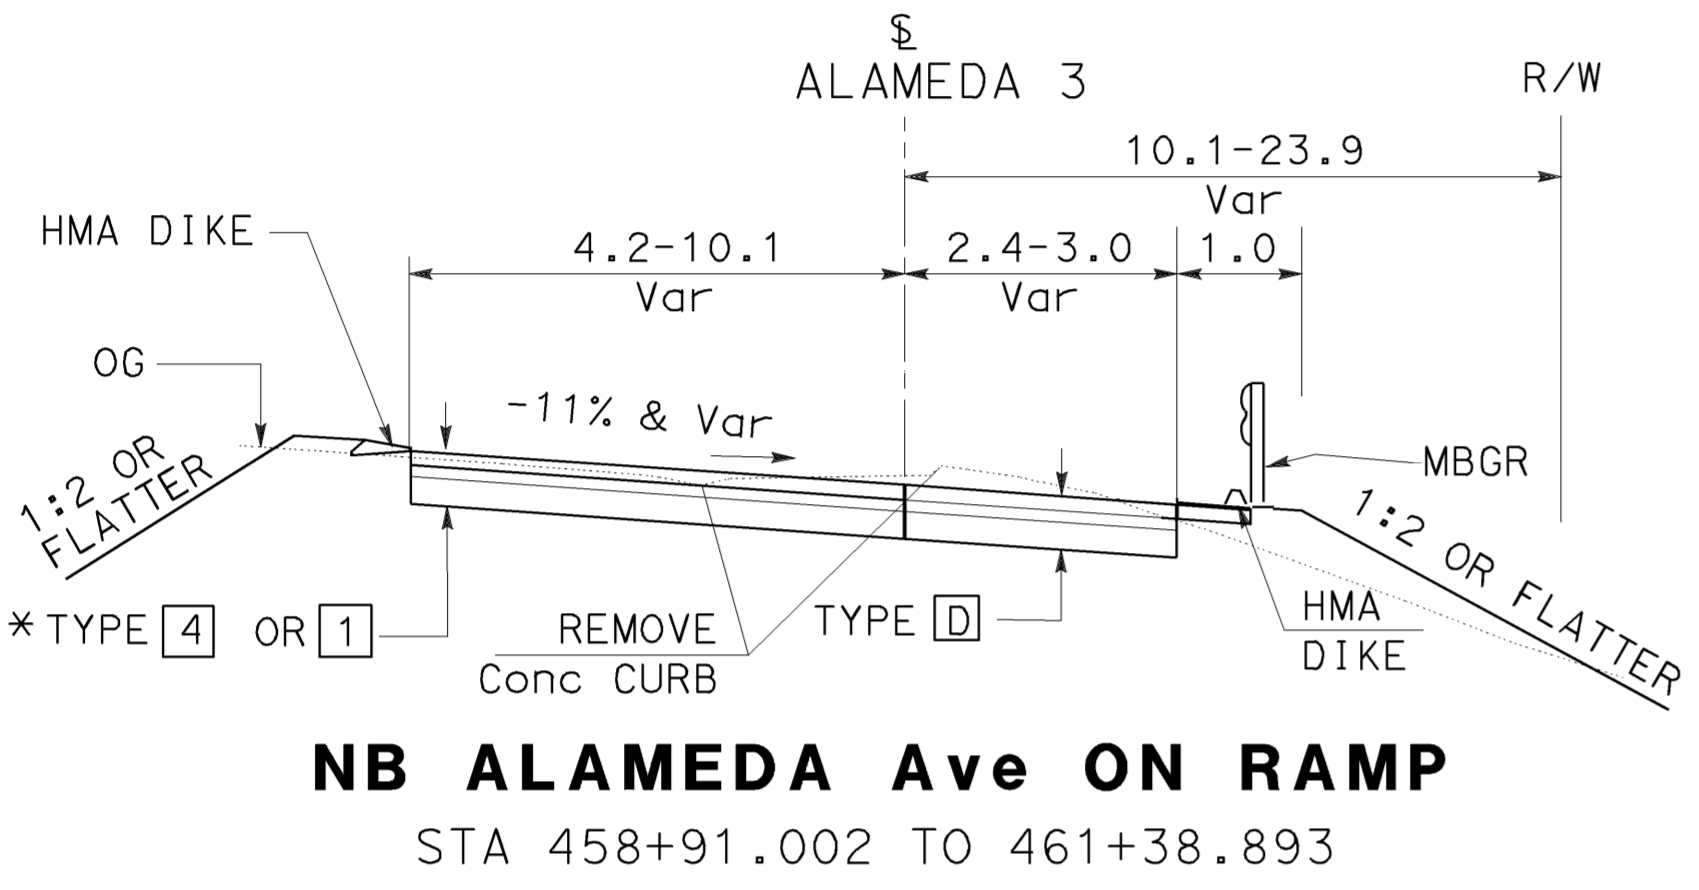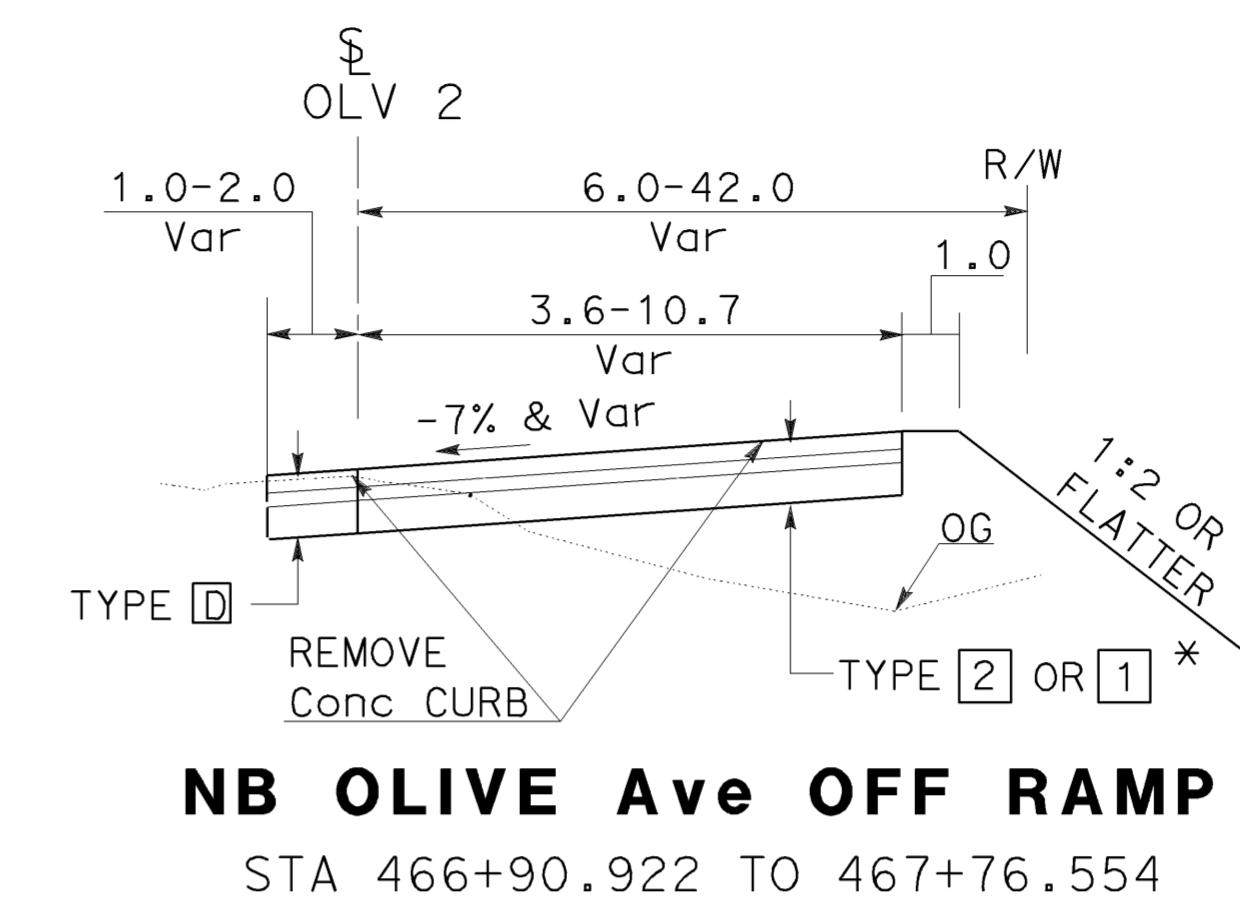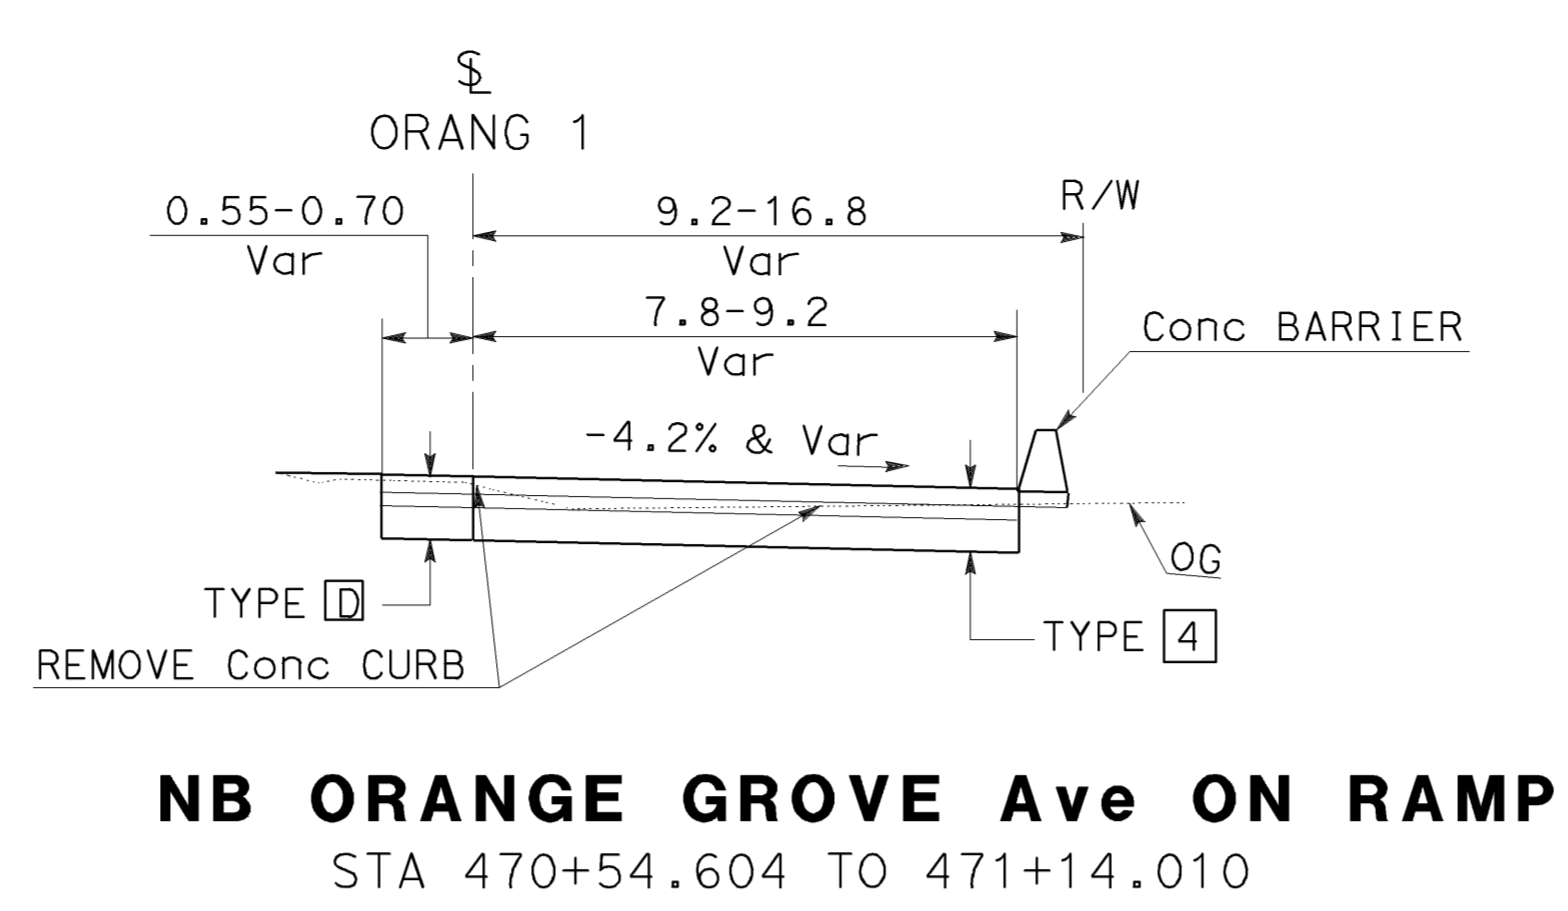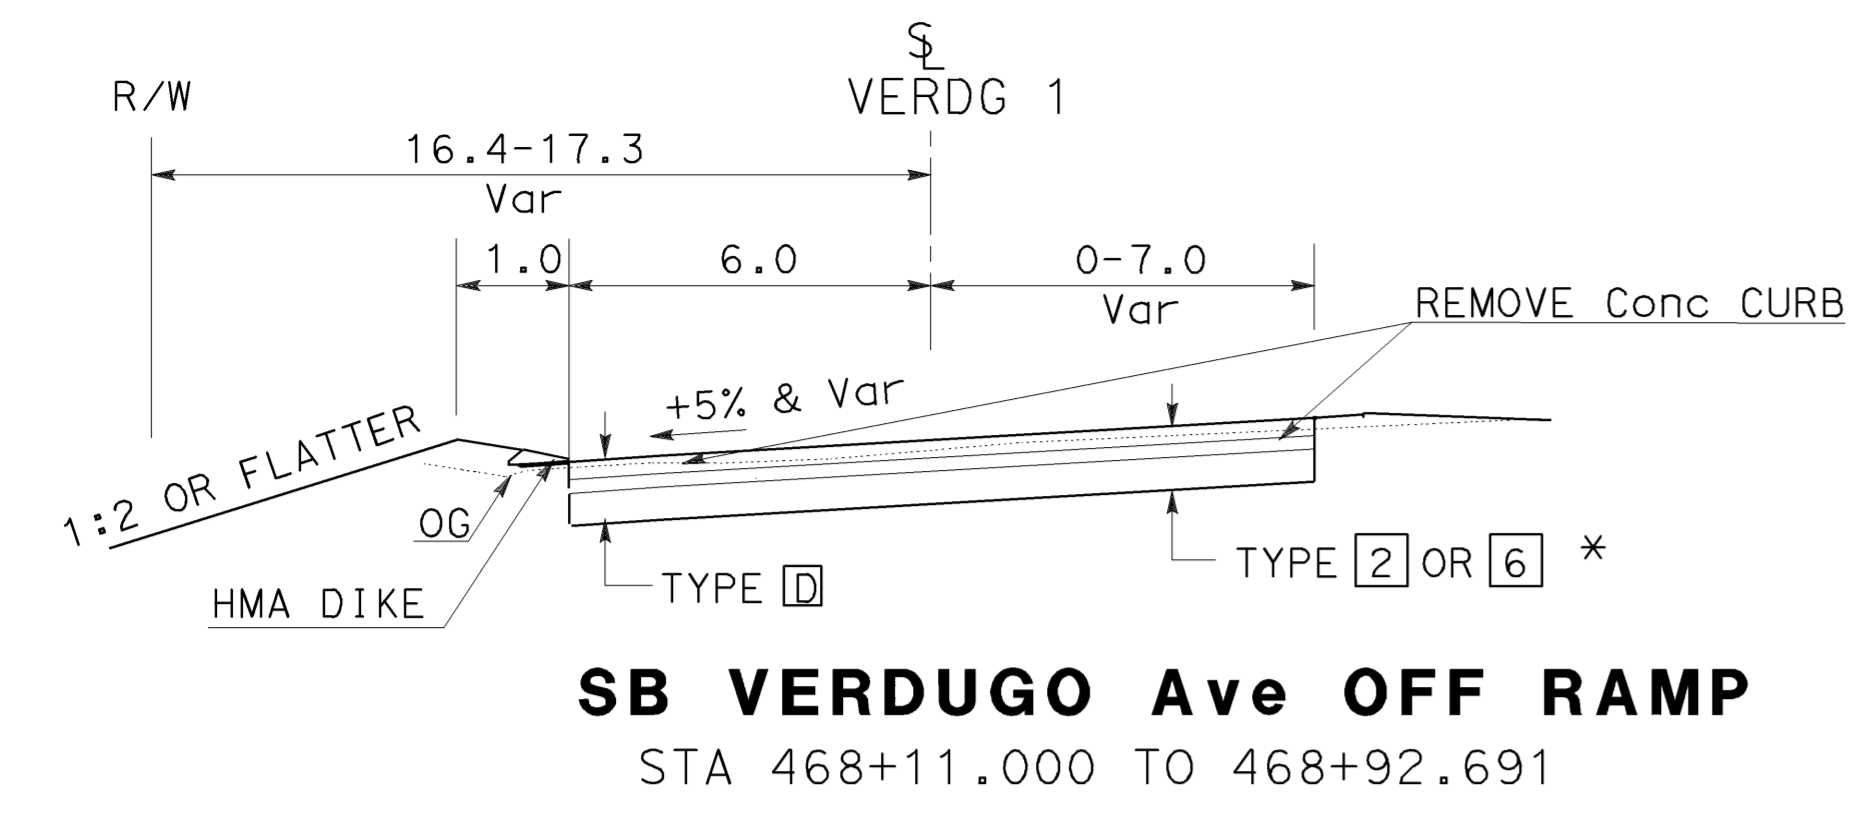

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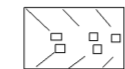

TYPICAL CROSS SECTIONS
 NO SCALE X-7

NOTE: 1. FOR COMPLETE RIGHT OF WAY AND ACCURATE ACCESS DATA, SEE RIGHT OF WAY RECORD MAPS AT DISTRICT OFFICE.

ABBREVIATIONS:

- PFE PERMANENT FOOTING EASEMENT
- HMA HOT MIX ASPHALT
- MVP MAINTENANCE VEHICLE PULLOUT
- TCE TEMPORARY CONSTRUCTION EASEMENT

LEGEND:

-  MINOR CONCRETE (TEXTURED PAVING)
-  35 mm COLD PLANE ASPHALT CONCRETE PAVEMENT
35 mm HMA (Type B)
SEE Const DETAILS





Dist	COUNTY	ROUTE	KILOMETER POST TOTAL PROJECT	SHEET No.	TOTAL SHEETS
07	LA	5	42.8/47.3	9	1073

REGISTERED CIVIL ENGINEER DATE 2-24-09
 6-8-09 PLANS APPROVAL DATE

MUNSHI MOHSIN
 No. 61916
 Exp. 9/30/09
 CIVIL

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CURVE DATA				
NO	R	Δ	T	L
①	701.04	54°57'32"	364.62	672.45
②	510.84	10°7'7"	45.32	90.22
③	731.52	14°10'41"	90.97	181.02

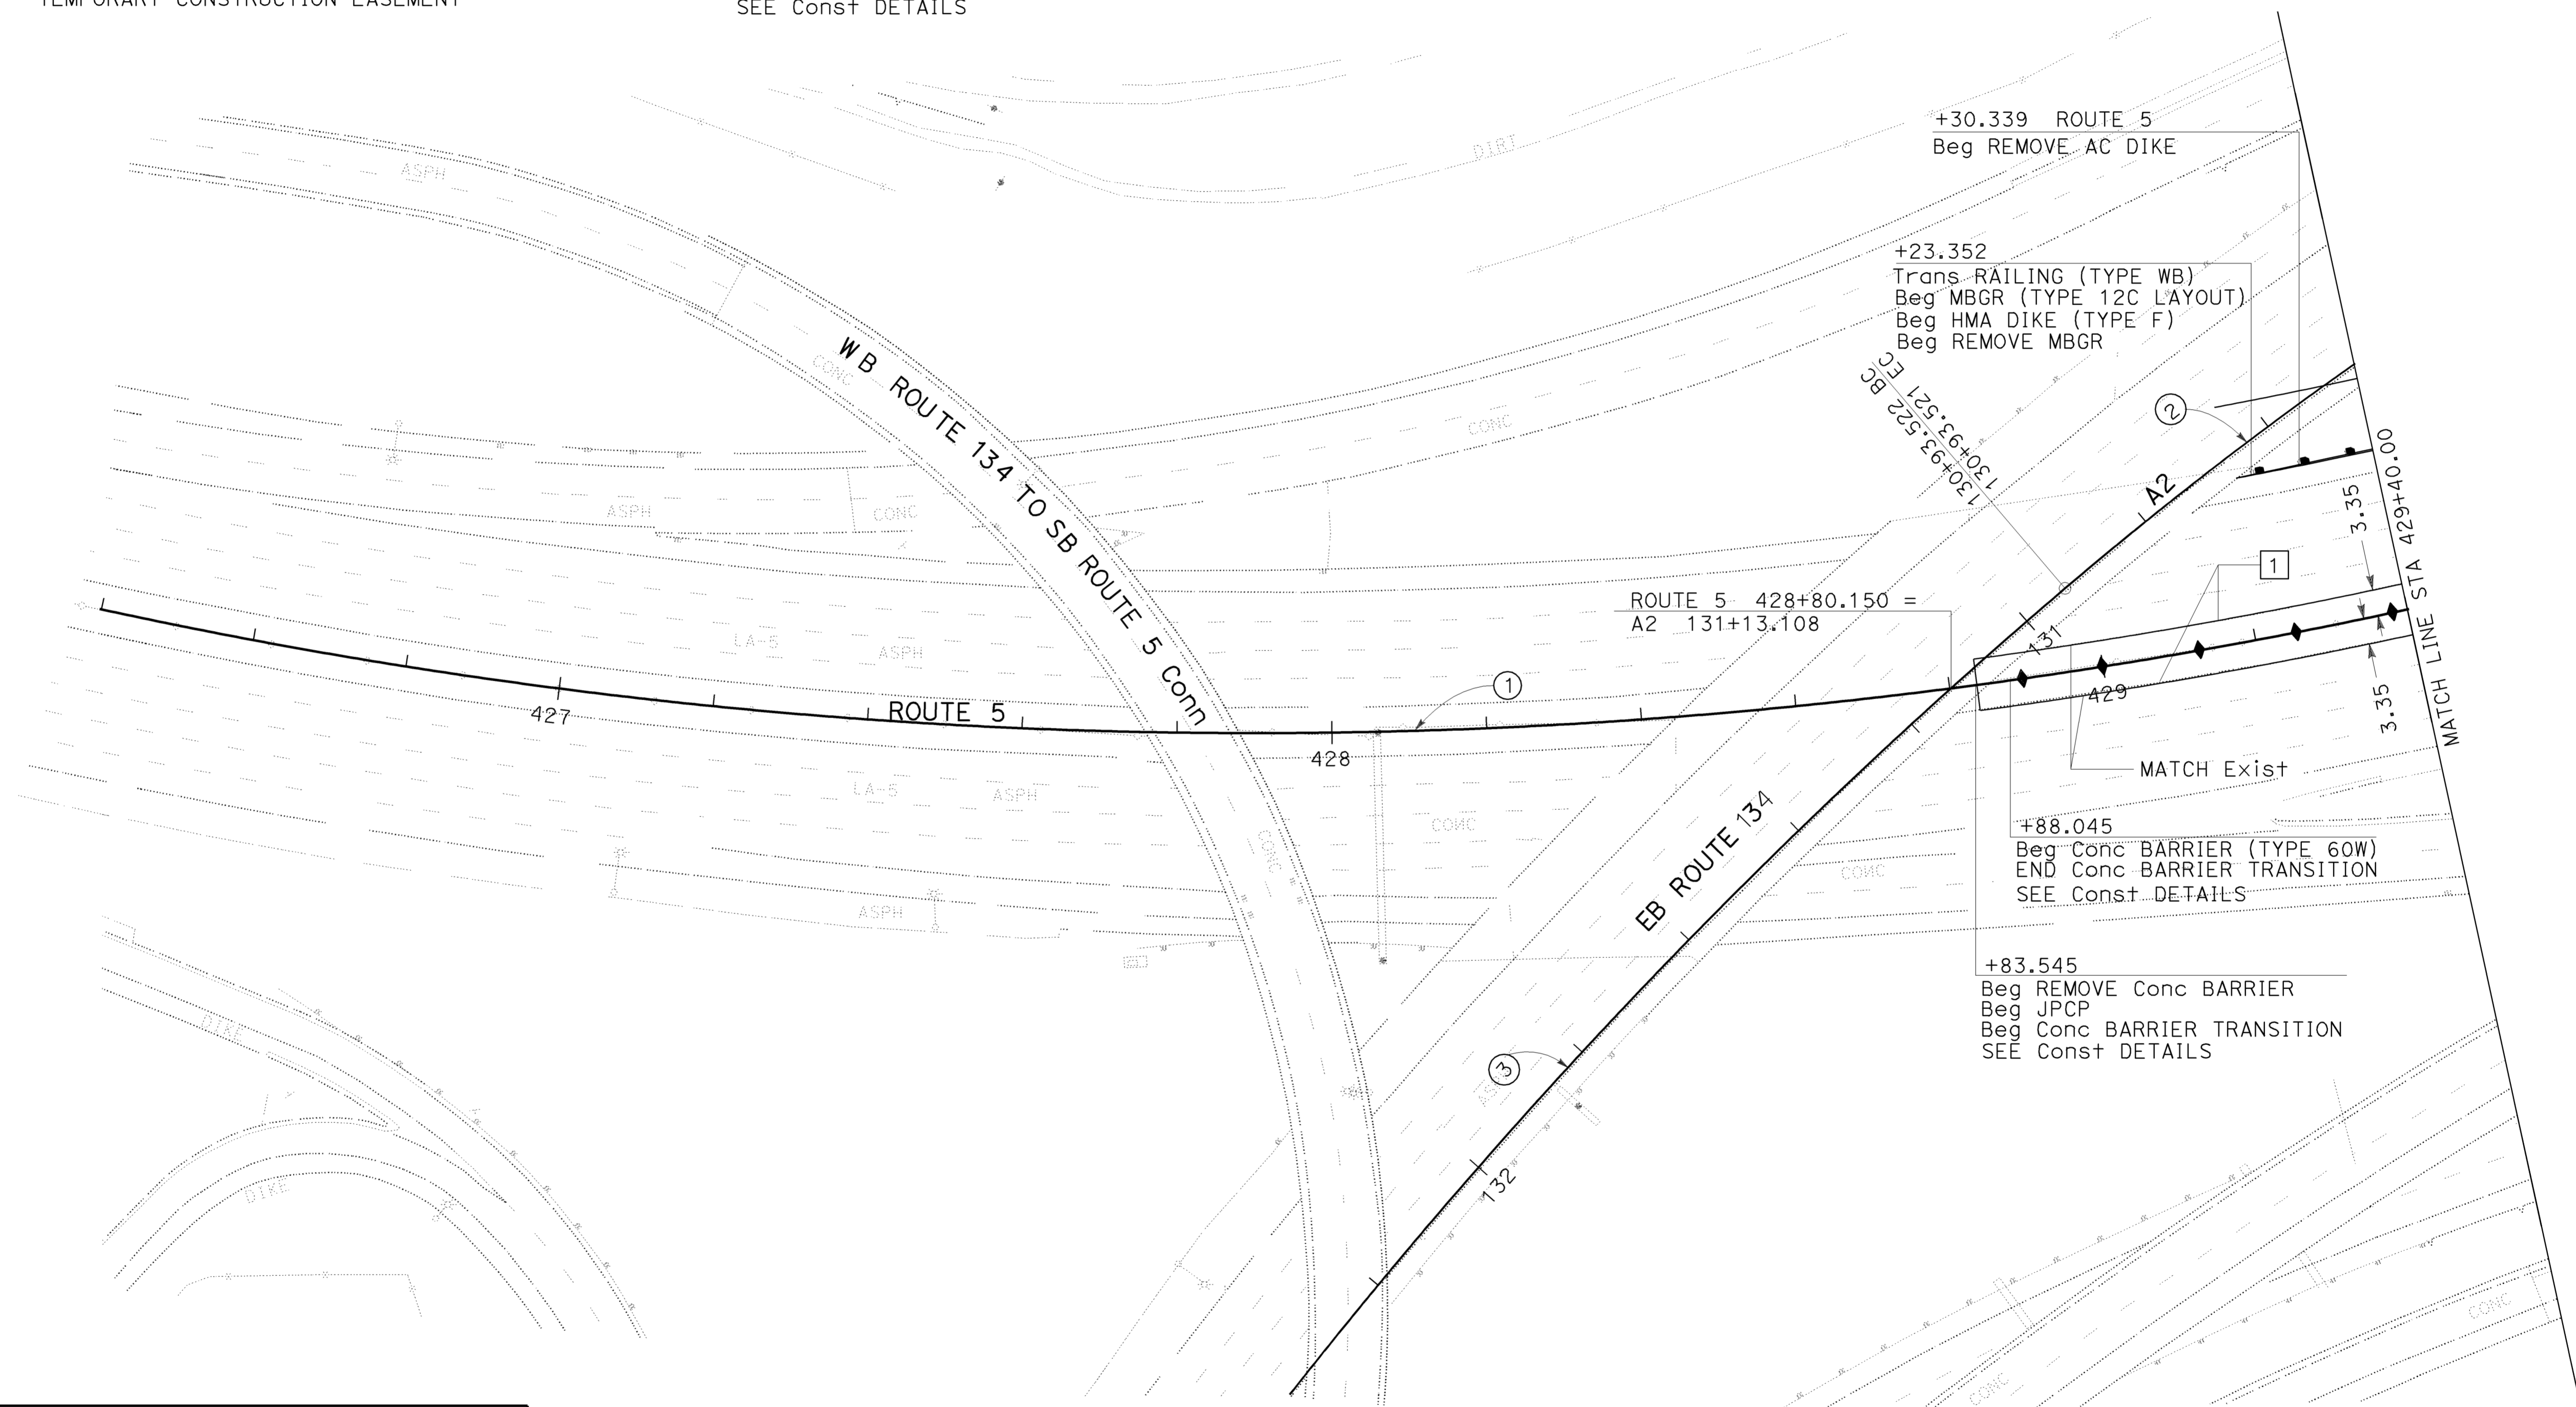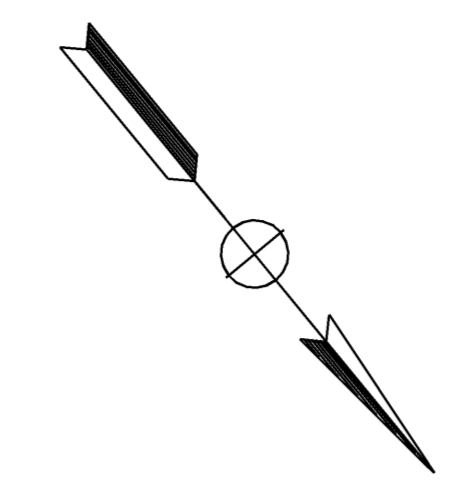ALL DIMENSIONS ARE IN METERS UNLESS OTHERWISE SHOWN

LAYOUT
SCALE 1:500

L-1

FUNCTIONAL SUPERVISOR
 CELINA AVILES

CALCULATED-DESIGNED BY
 CHECKED BY

DAWIT WOKRU
 MUNSHI MOHSIN

REVISED BY
 DATE REVISED

SA
 01/08

MM
 12/08

NOTE: 1. FOR COMPLETE RIGHT OF WAY AND ACCURATE ACCESS DATA, SEE RIGHT OF WAY RECORD MAPS AT DISTRICT OFFICE.




Dist	COUNTY	ROUTE	KILOMETER POST TOTAL PROJECT	SHEET No.	TOTAL SHEETS
07	LA	5	42.8/47.3	10	1073

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 6-8-09
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CURVE DATA				
NO	R	Δ	T	L
①	701.04	54°57'32"	364.62	672.45
②	510.84	10°07'07"	45.23	90.22
④	518.16	25°55'47"	119.29	234.50
⑤	537.67	49°11'52"	246.15	461.68
⑥	1036.32	42°10'00"	399.54	762.68



USERNAME => trmnguye
 DGN FILE => 712184ea002.dgn

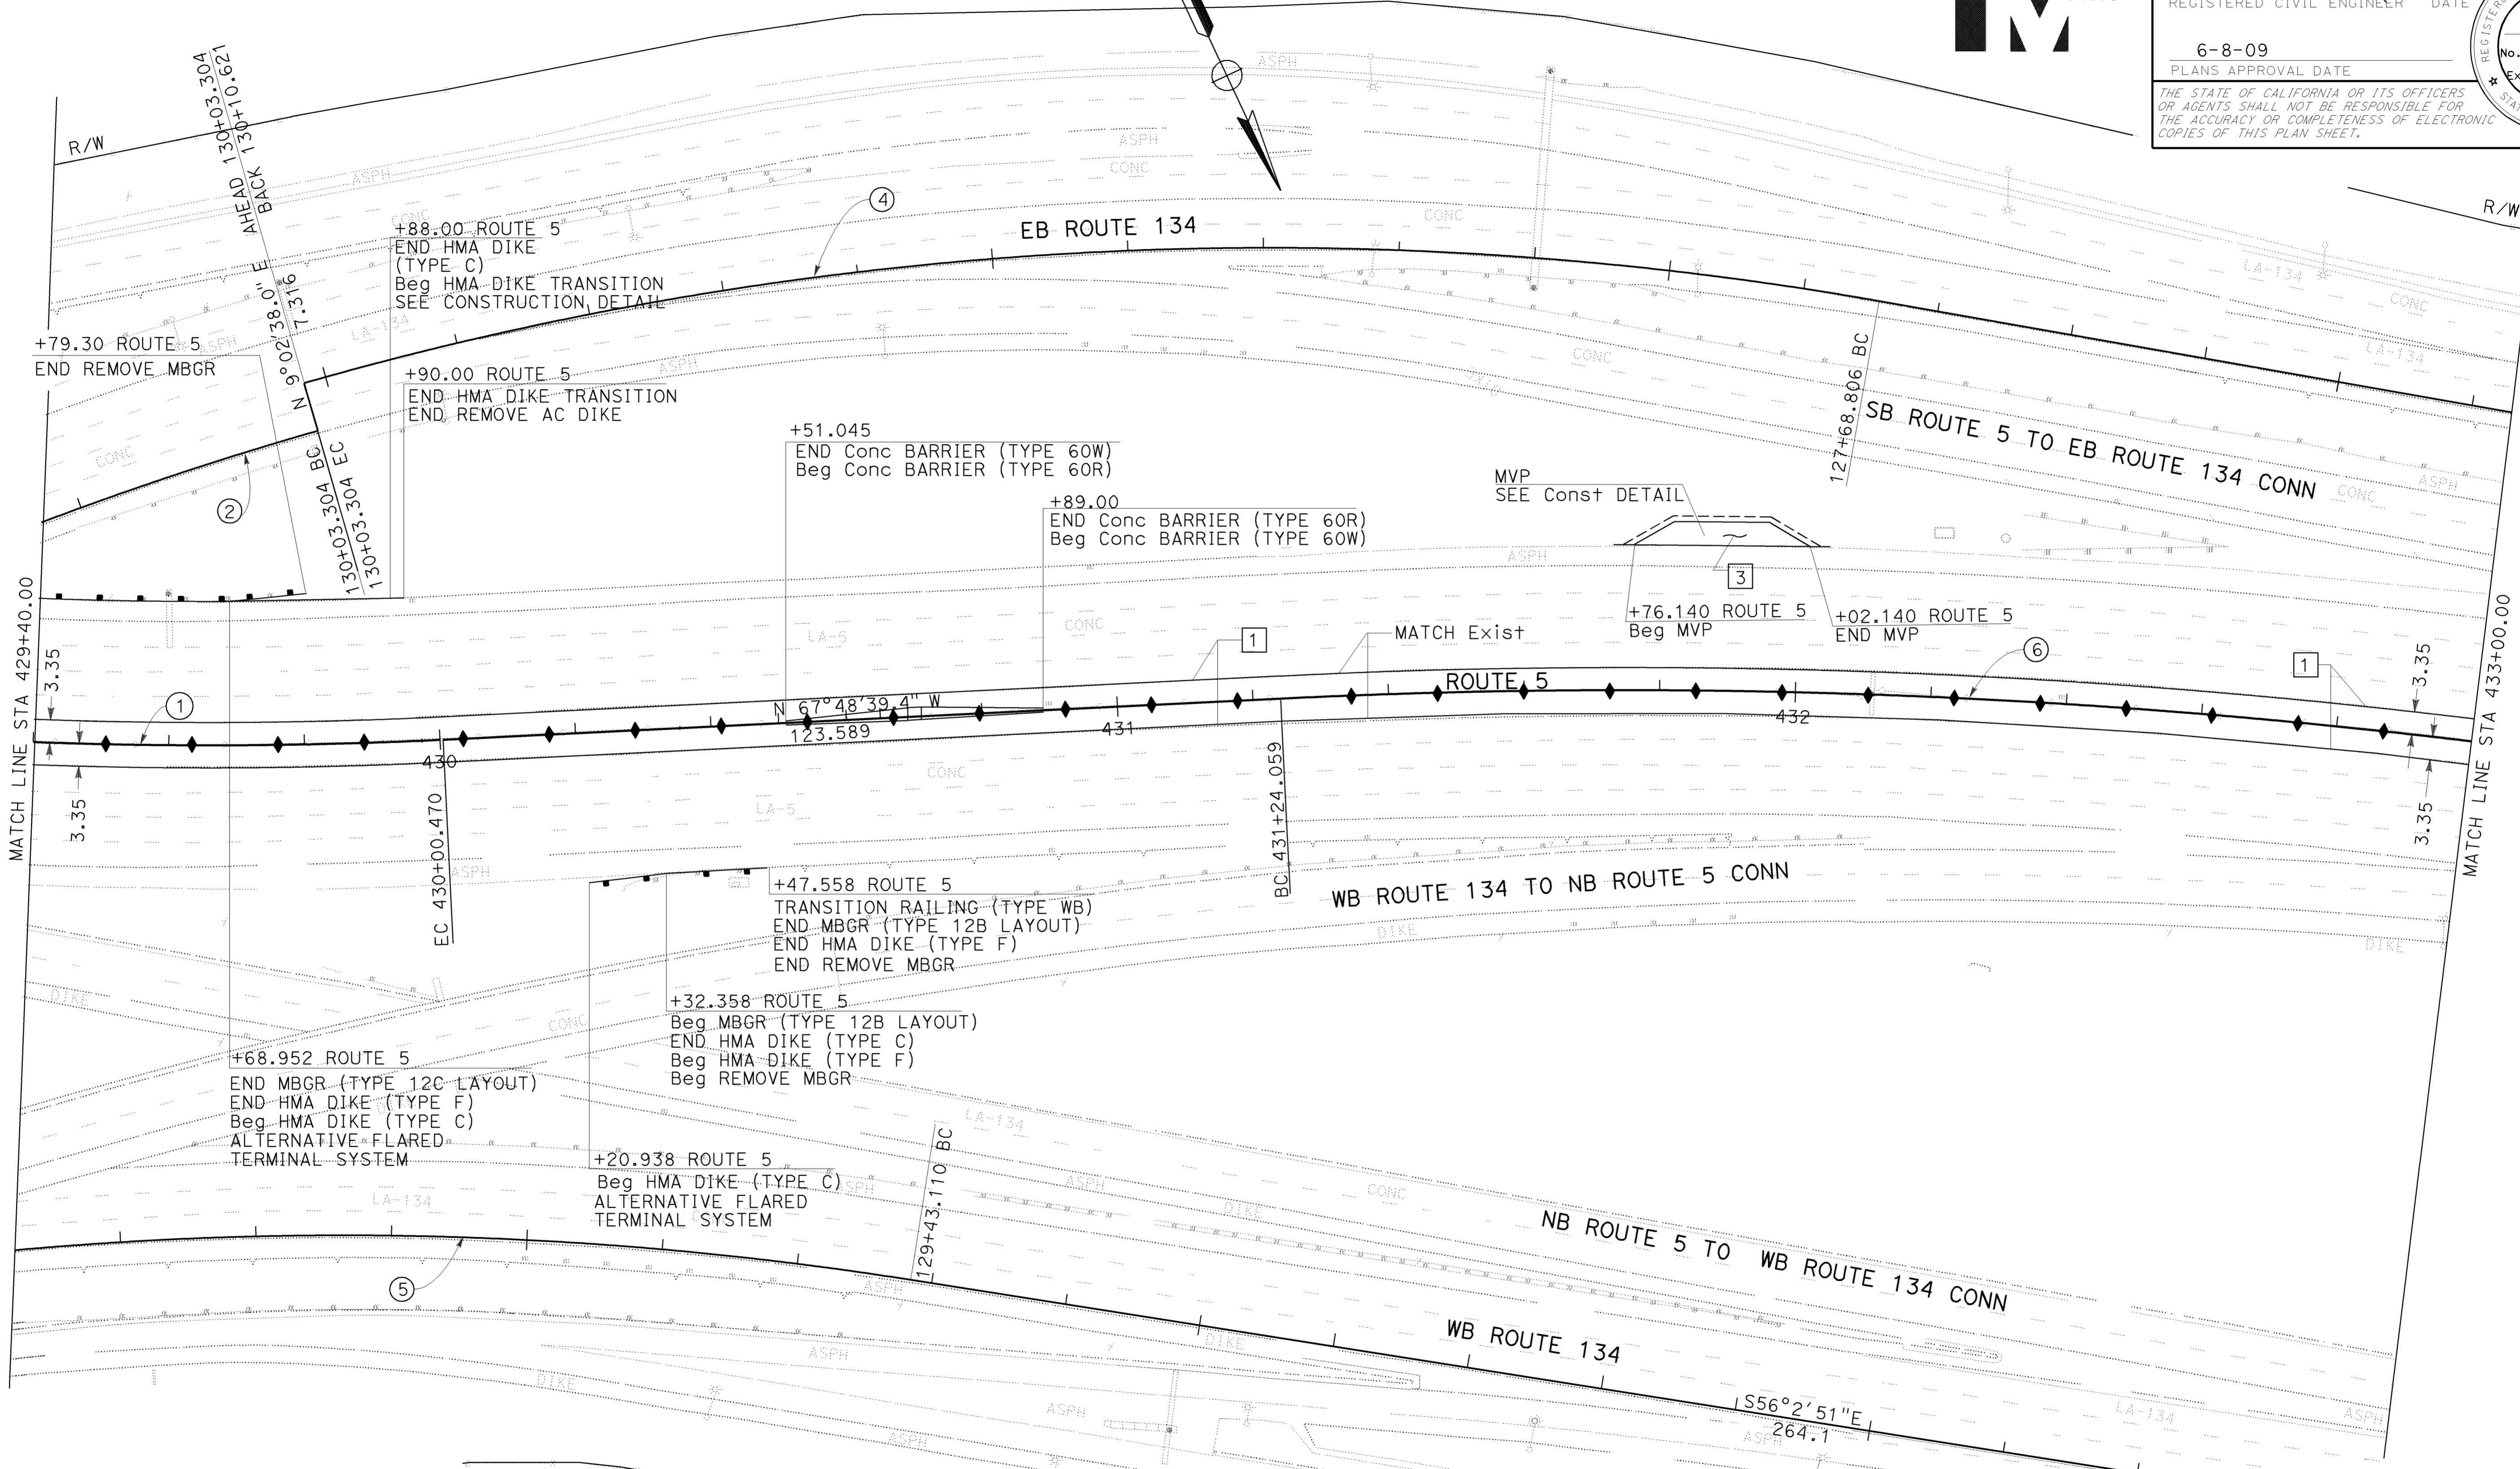CU 07276 EA 121841

ALL DIMENSIONS ARE IN METERS UNLESS OTHERWISE SHOWN

LAYOUT
 SCALE 1:500

LAST REVISION DATE PLOTTED => 12-JUN-2009 01-27-09 TIME PLOTTED => 01:29

FUNCTIONAL SUPERVISOR
 CELINA AVILES


CALCULATED-DESIGNED BY
 CHECKED BY

DAWIT WORKU
 MUNSHI MOHSIN

REVISOR BY
 DATE REVISED

MM
 10/08

NOTE: 1. FOR COMPLETE RIGHT OF WAY AND ACCURATE ACCESS DATA, SEE RIGHT OF WAY RECORD MAPS AT DISTRICT OFFICE.

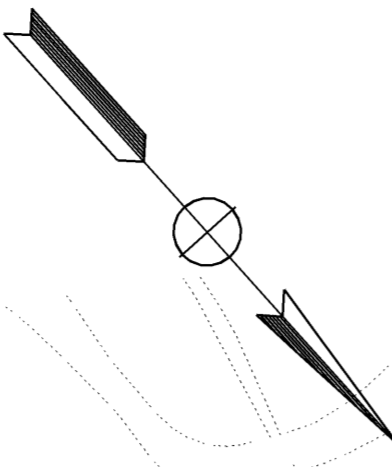


Dist	COUNTY	ROUTE	KILOMETER POST TOTAL PROJECT	SHEET No.	TOTAL SHEETS
07	LA	5	42.8/47.3	11	1073

2-24-09
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6-8-09
 PLANS APPROVAL DATE

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CURVE DATA				
NO	R	Δ	T	L
⑥	1036.32	42°10'00"	399.54	762.68
⑦	365.76	19°00'45"	61.25	121.37
⑧	468.17	14°47'01"	60.74	120.80
⑨	457.20	34°49'29"	143.39	277.89

ROUTE 5 435+80.204 = R/W
 A3 124+31.109
 LOS ANGELES RIVER Br AND Sep
 Br No. 53-1075
 ROUTE 5 STA POT
 = WB ROUTE 134 STA

ALL DIMENSIONS ARE IN METERS
 UNLESS OTHERWISE SHOWN

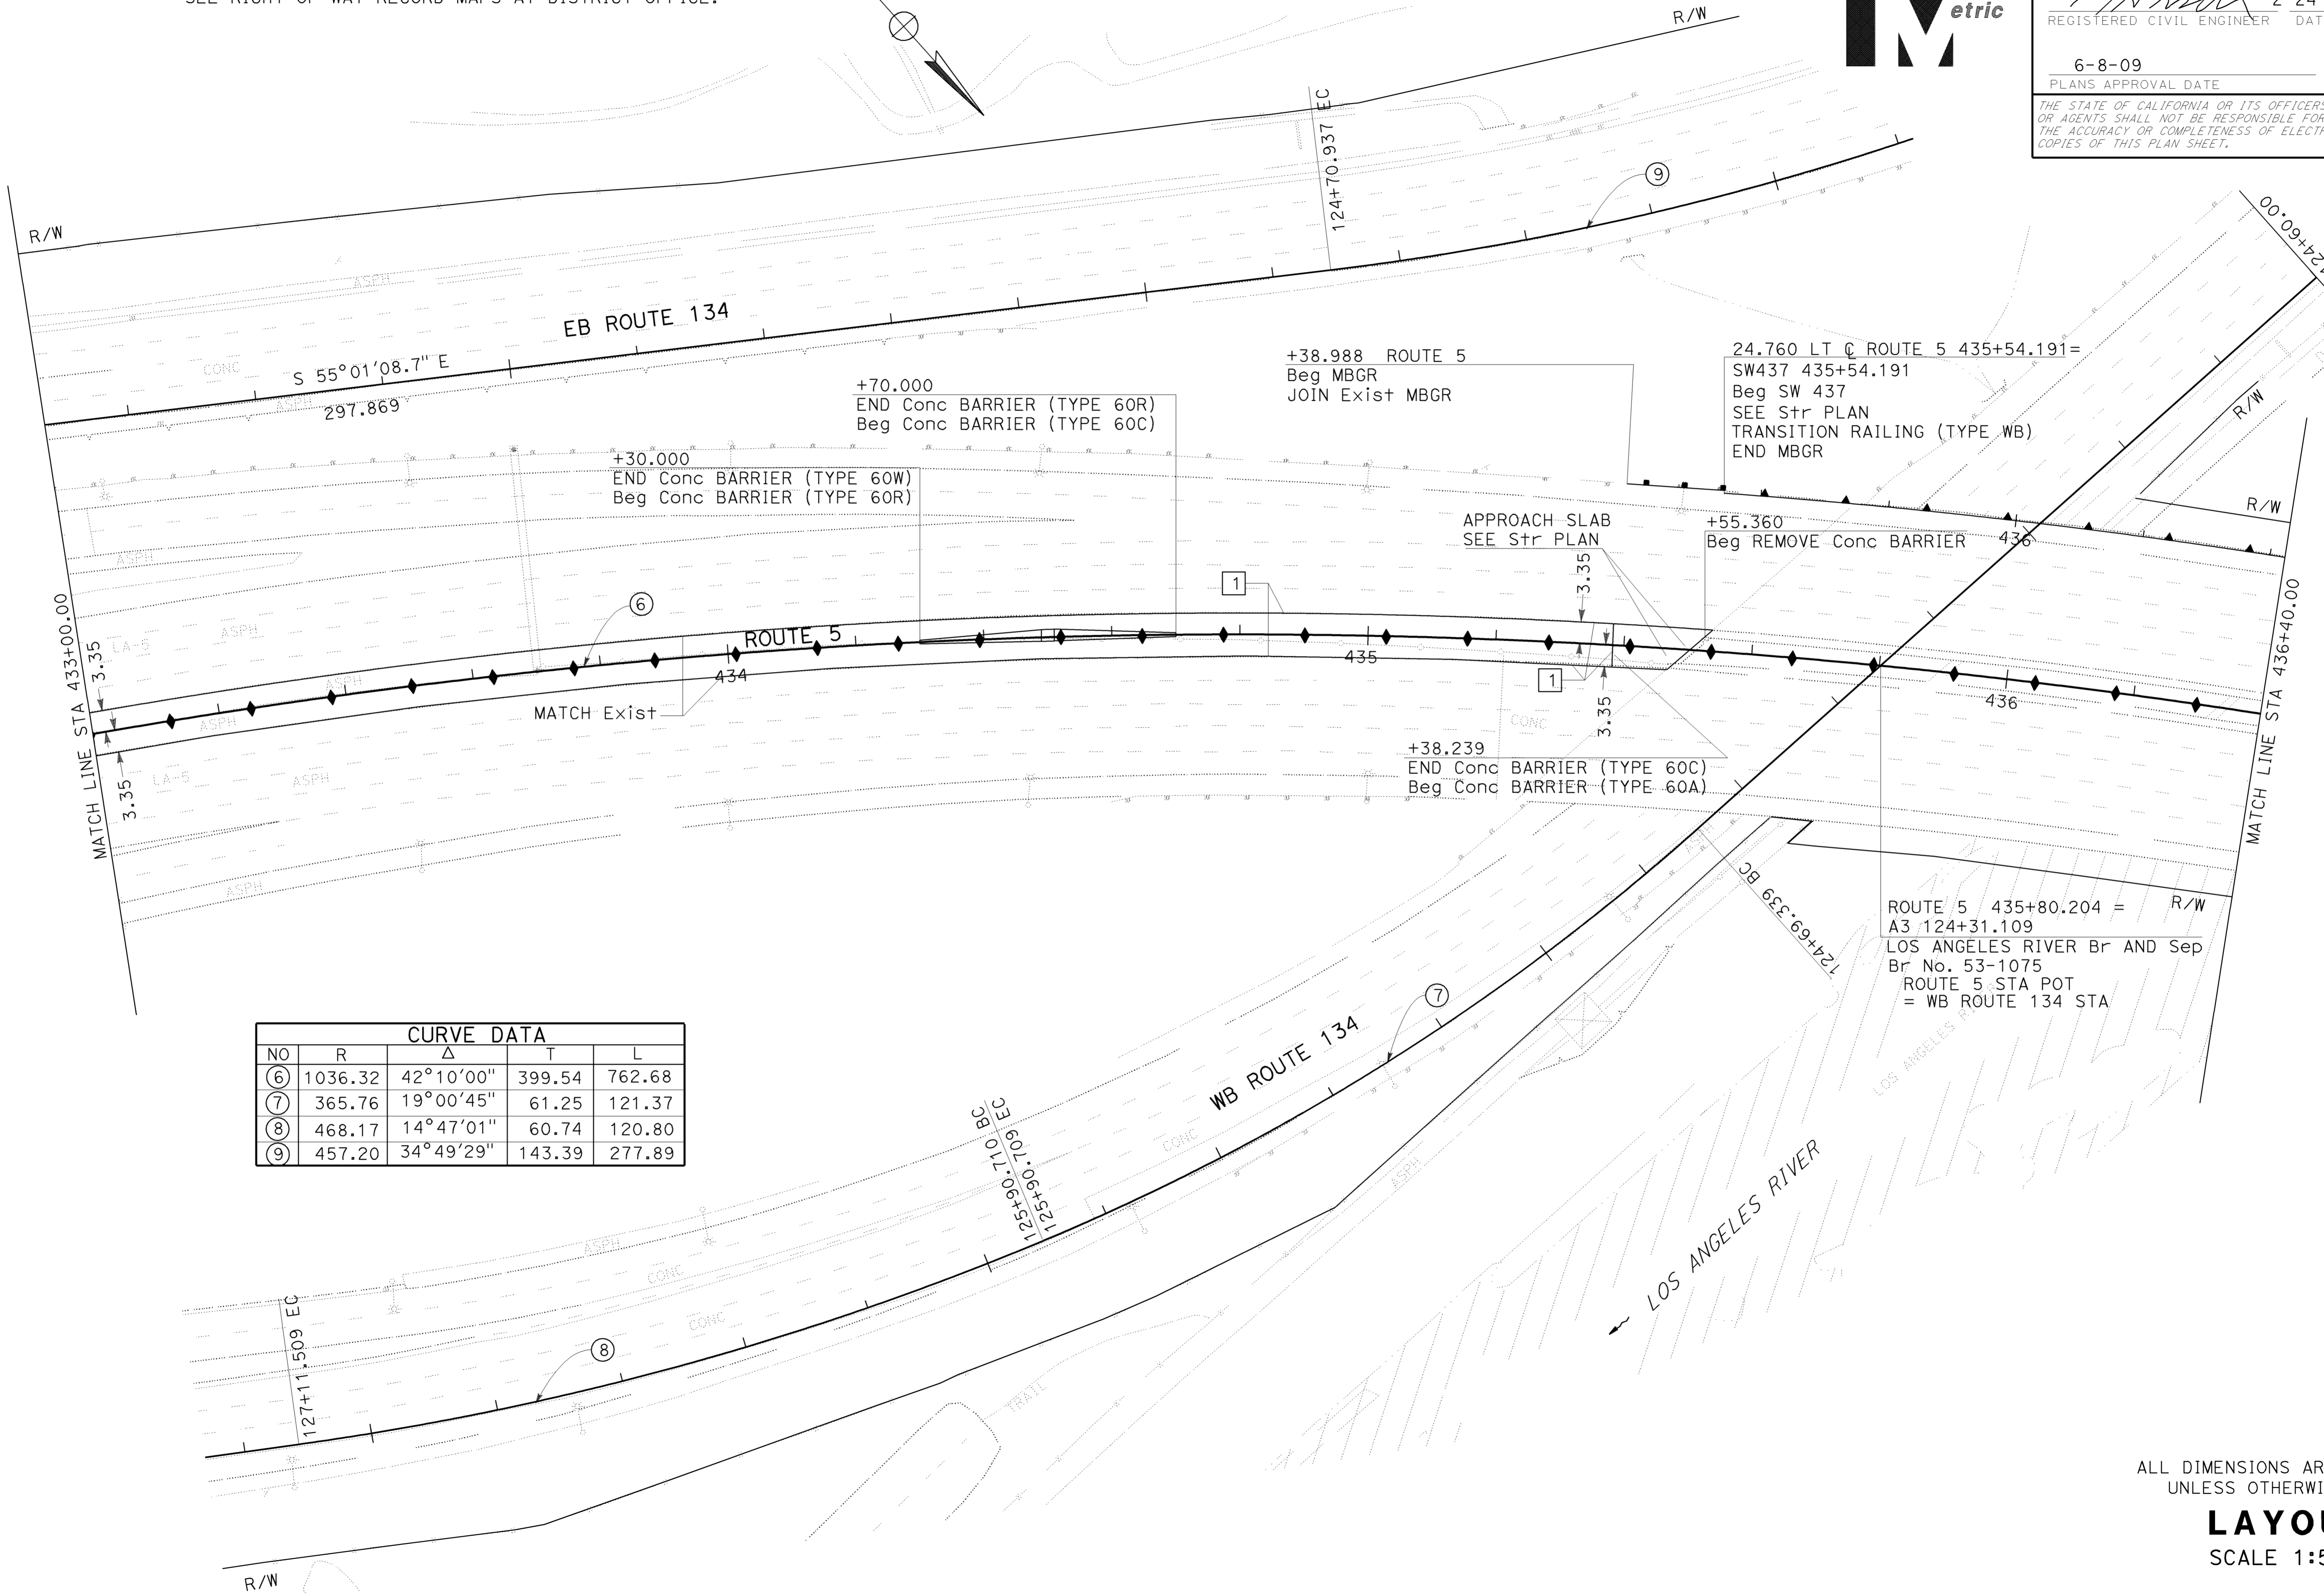LAYOUT
 SCALE 1:500

L-3

NOTE: 1. FOR COMPLETE RIGHT OF WAY AND ACCURATE ACCESS DATA, SEE RIGHT OF WAY RECORD MAPS AT DISTRICT OFFICE.




Dist	COUNTY	ROUTE	KILOMETER TOTAL PROJECT	POST TOTAL PROJECT	SHEET No.	TOTAL SHEETS
07	LA	5	42.8/47.3		12	1073

REGISTERED CIVIL ENGINEER: MUNSHI MOHSIN
 No. 61916
 Exp. 9/30/09
 CIVIL

DATE: 2-24-09
 DATE: 6-8-09
 PLANS APPROVAL DATE

THE STATE OF CALIFORNIA OR ITS OFFICERS OR AGENTS SHALL NOT BE RESPONSIBLE FOR THE ACCURACY OR COMPLETENESS OF ELECTRONIC COPIES OF THIS PLAN SHEET.

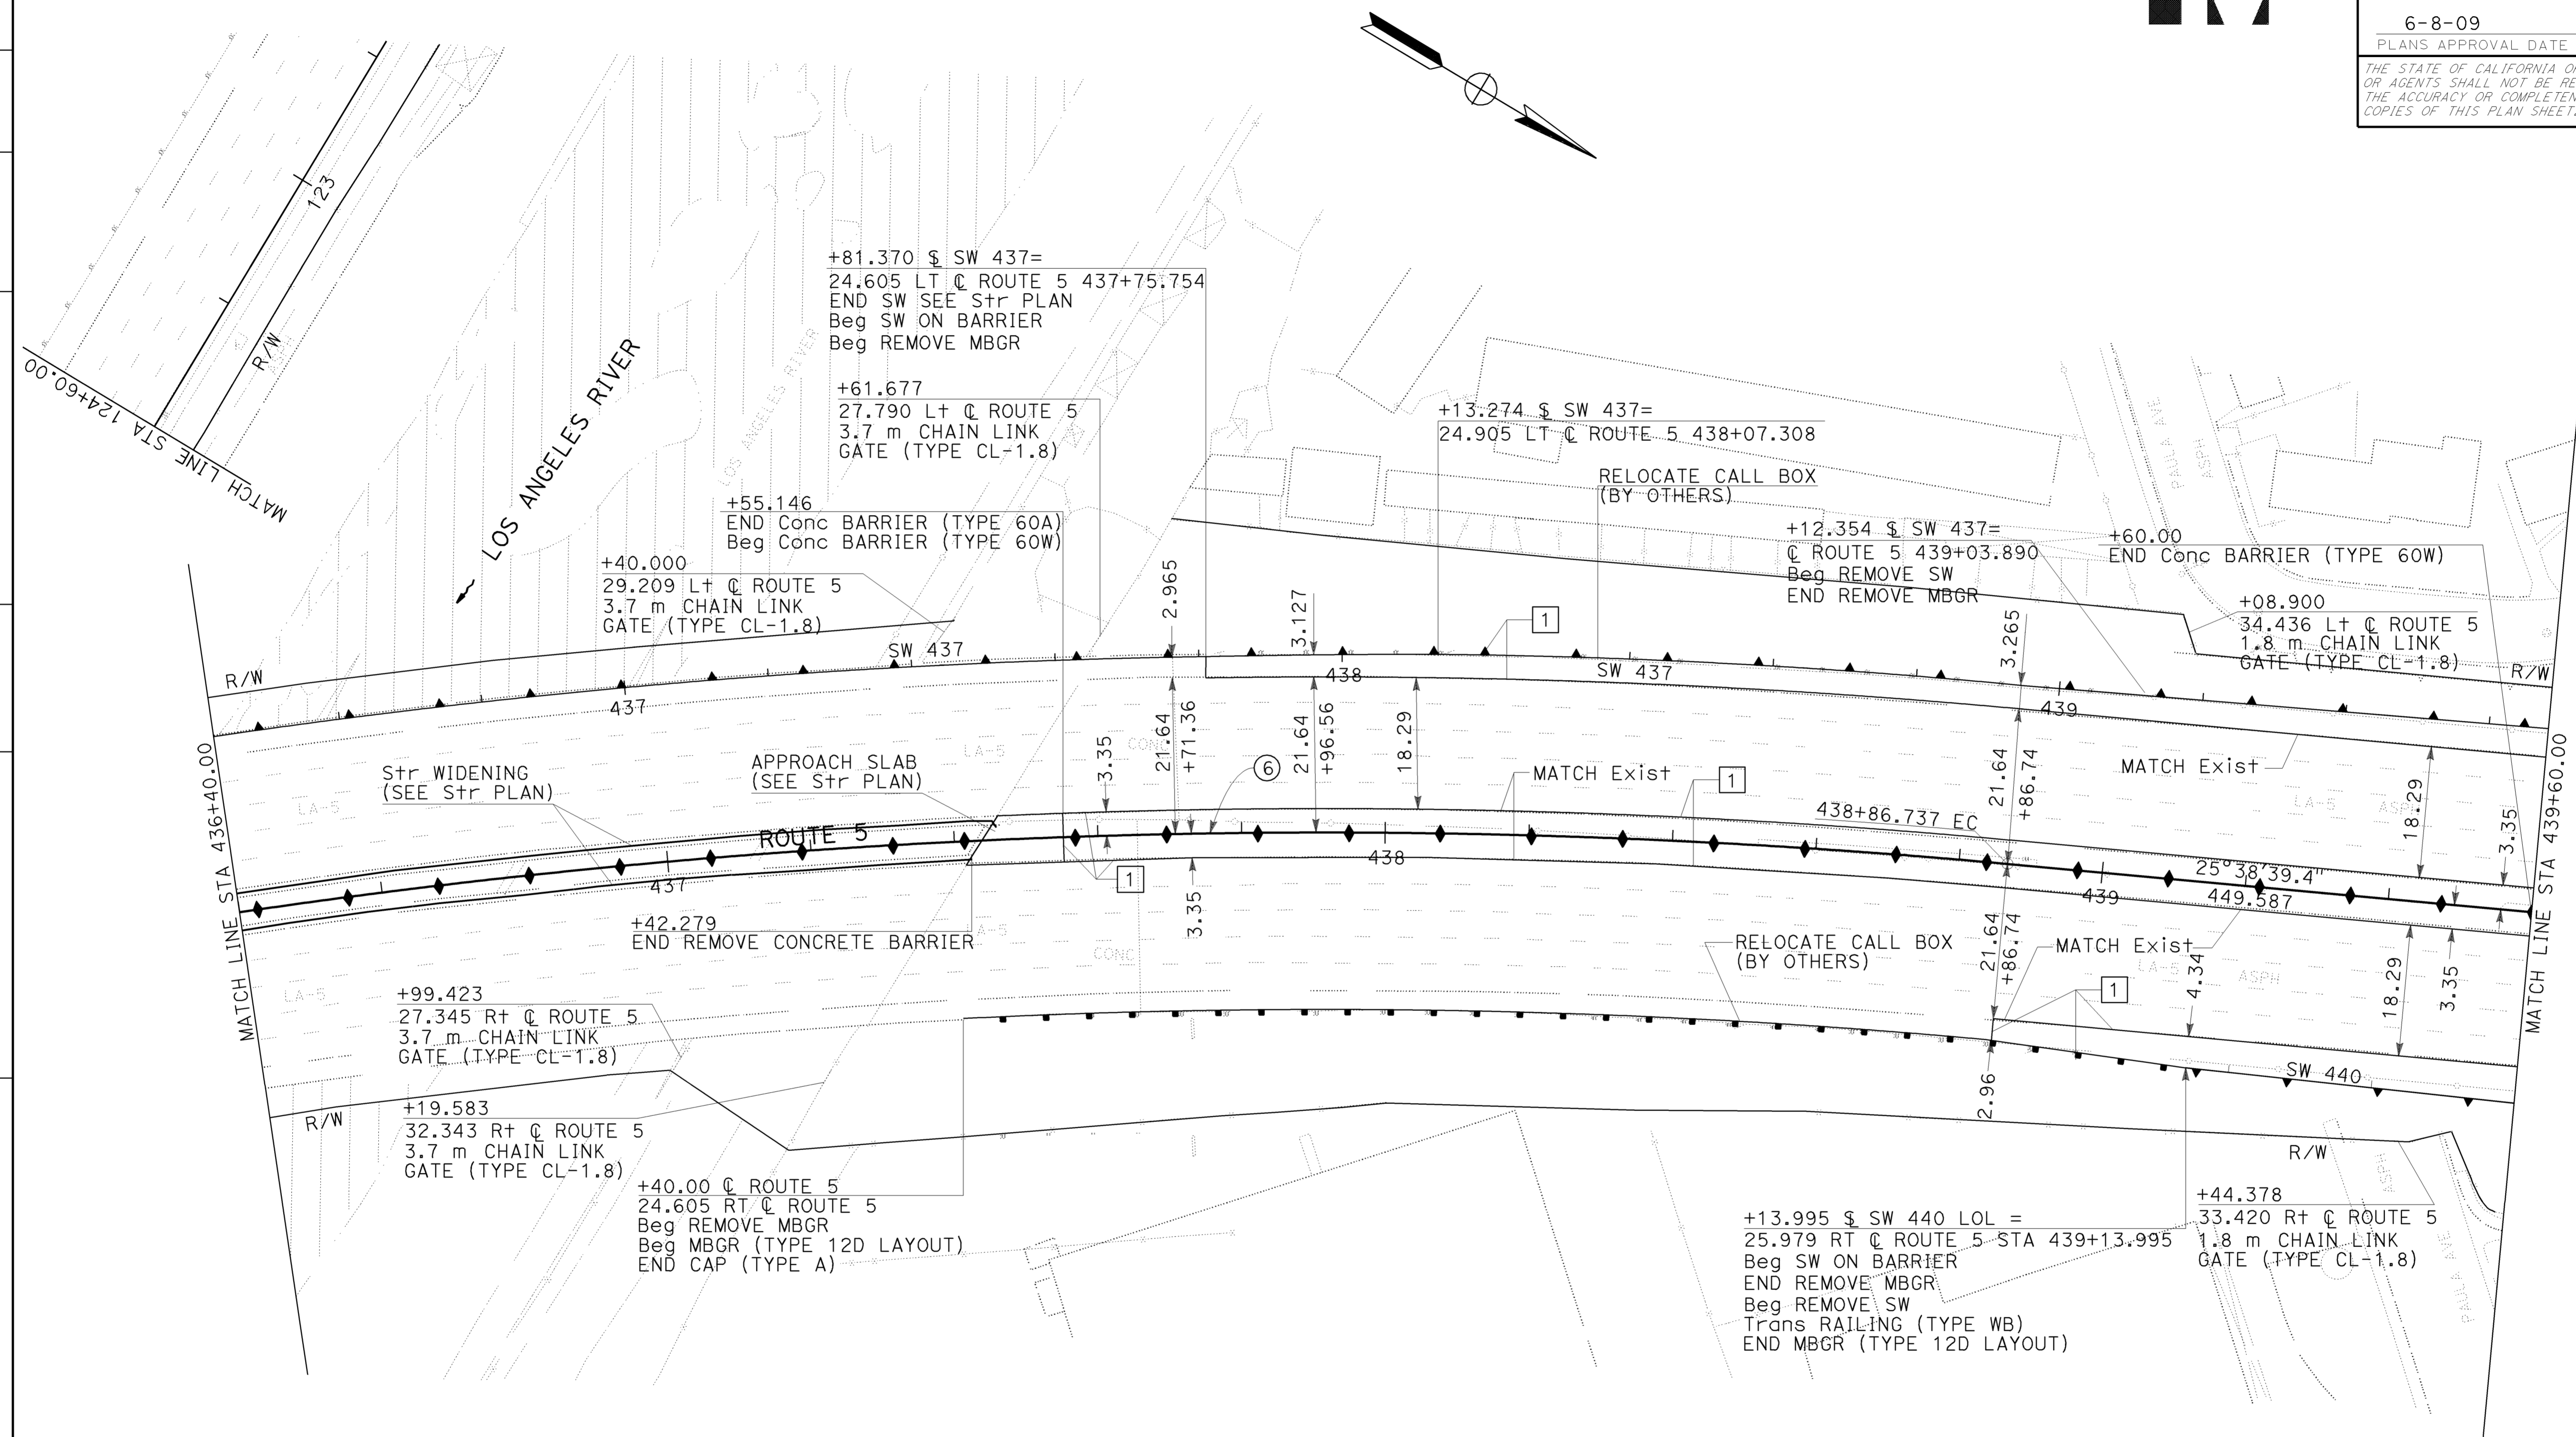


CURVE DATA				
NO	R	Δ	T	L
⑥	1036.32	42°10'0"	399.54	762.68

ALL DIMENSIONS ARE IN METERS UNLESS OTHERWISE SHOWN

LAYOUT
 SCALE 1:500

NOTE: 1. FOR COMPLETE RIGHT OF WAY AND ACCURATE ACCESS DATA, SEE RIGHT OF WAY RECORD MAPS AT DISTRICT OFFICE.


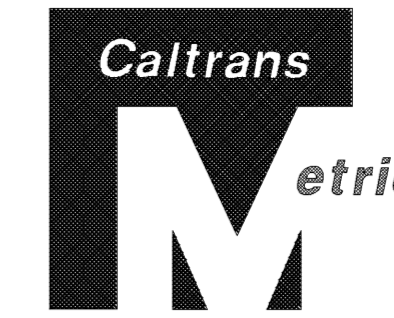


Dist	COUNTY	ROUTE	KILOMETER POST TOTAL PROJECT	SHEET No.	TOTAL SHEETS
07	LA	5	42.8/47.3	13	1073

REGISTERED CIVIL ENGINEER	DATE
MUNSHI MOHSIN	2-24-09
No. 61916	
Exp. 9/30/09	
CIVIL	

PLANS APPROVAL DATE: 6-8-09

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STATE OF CALIFORNIA - DEPARTMENT OF TRANSPORTATION
Caltrans OFFICE OF DESIGN
 FUNCTIONAL SUPERVISOR: CELINA AVILES
 CHECKED BY: MUNSHI MOHSIN
 DAWIT WORKU: MUNSHI MOHSIN
 REVISOR: SA
 DATE: 01/08
 MM: 12/08

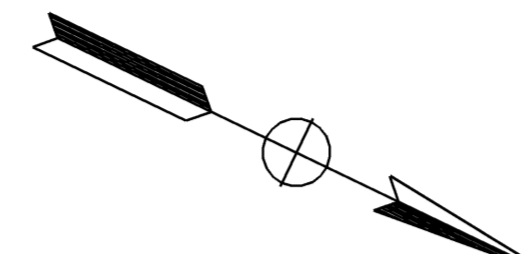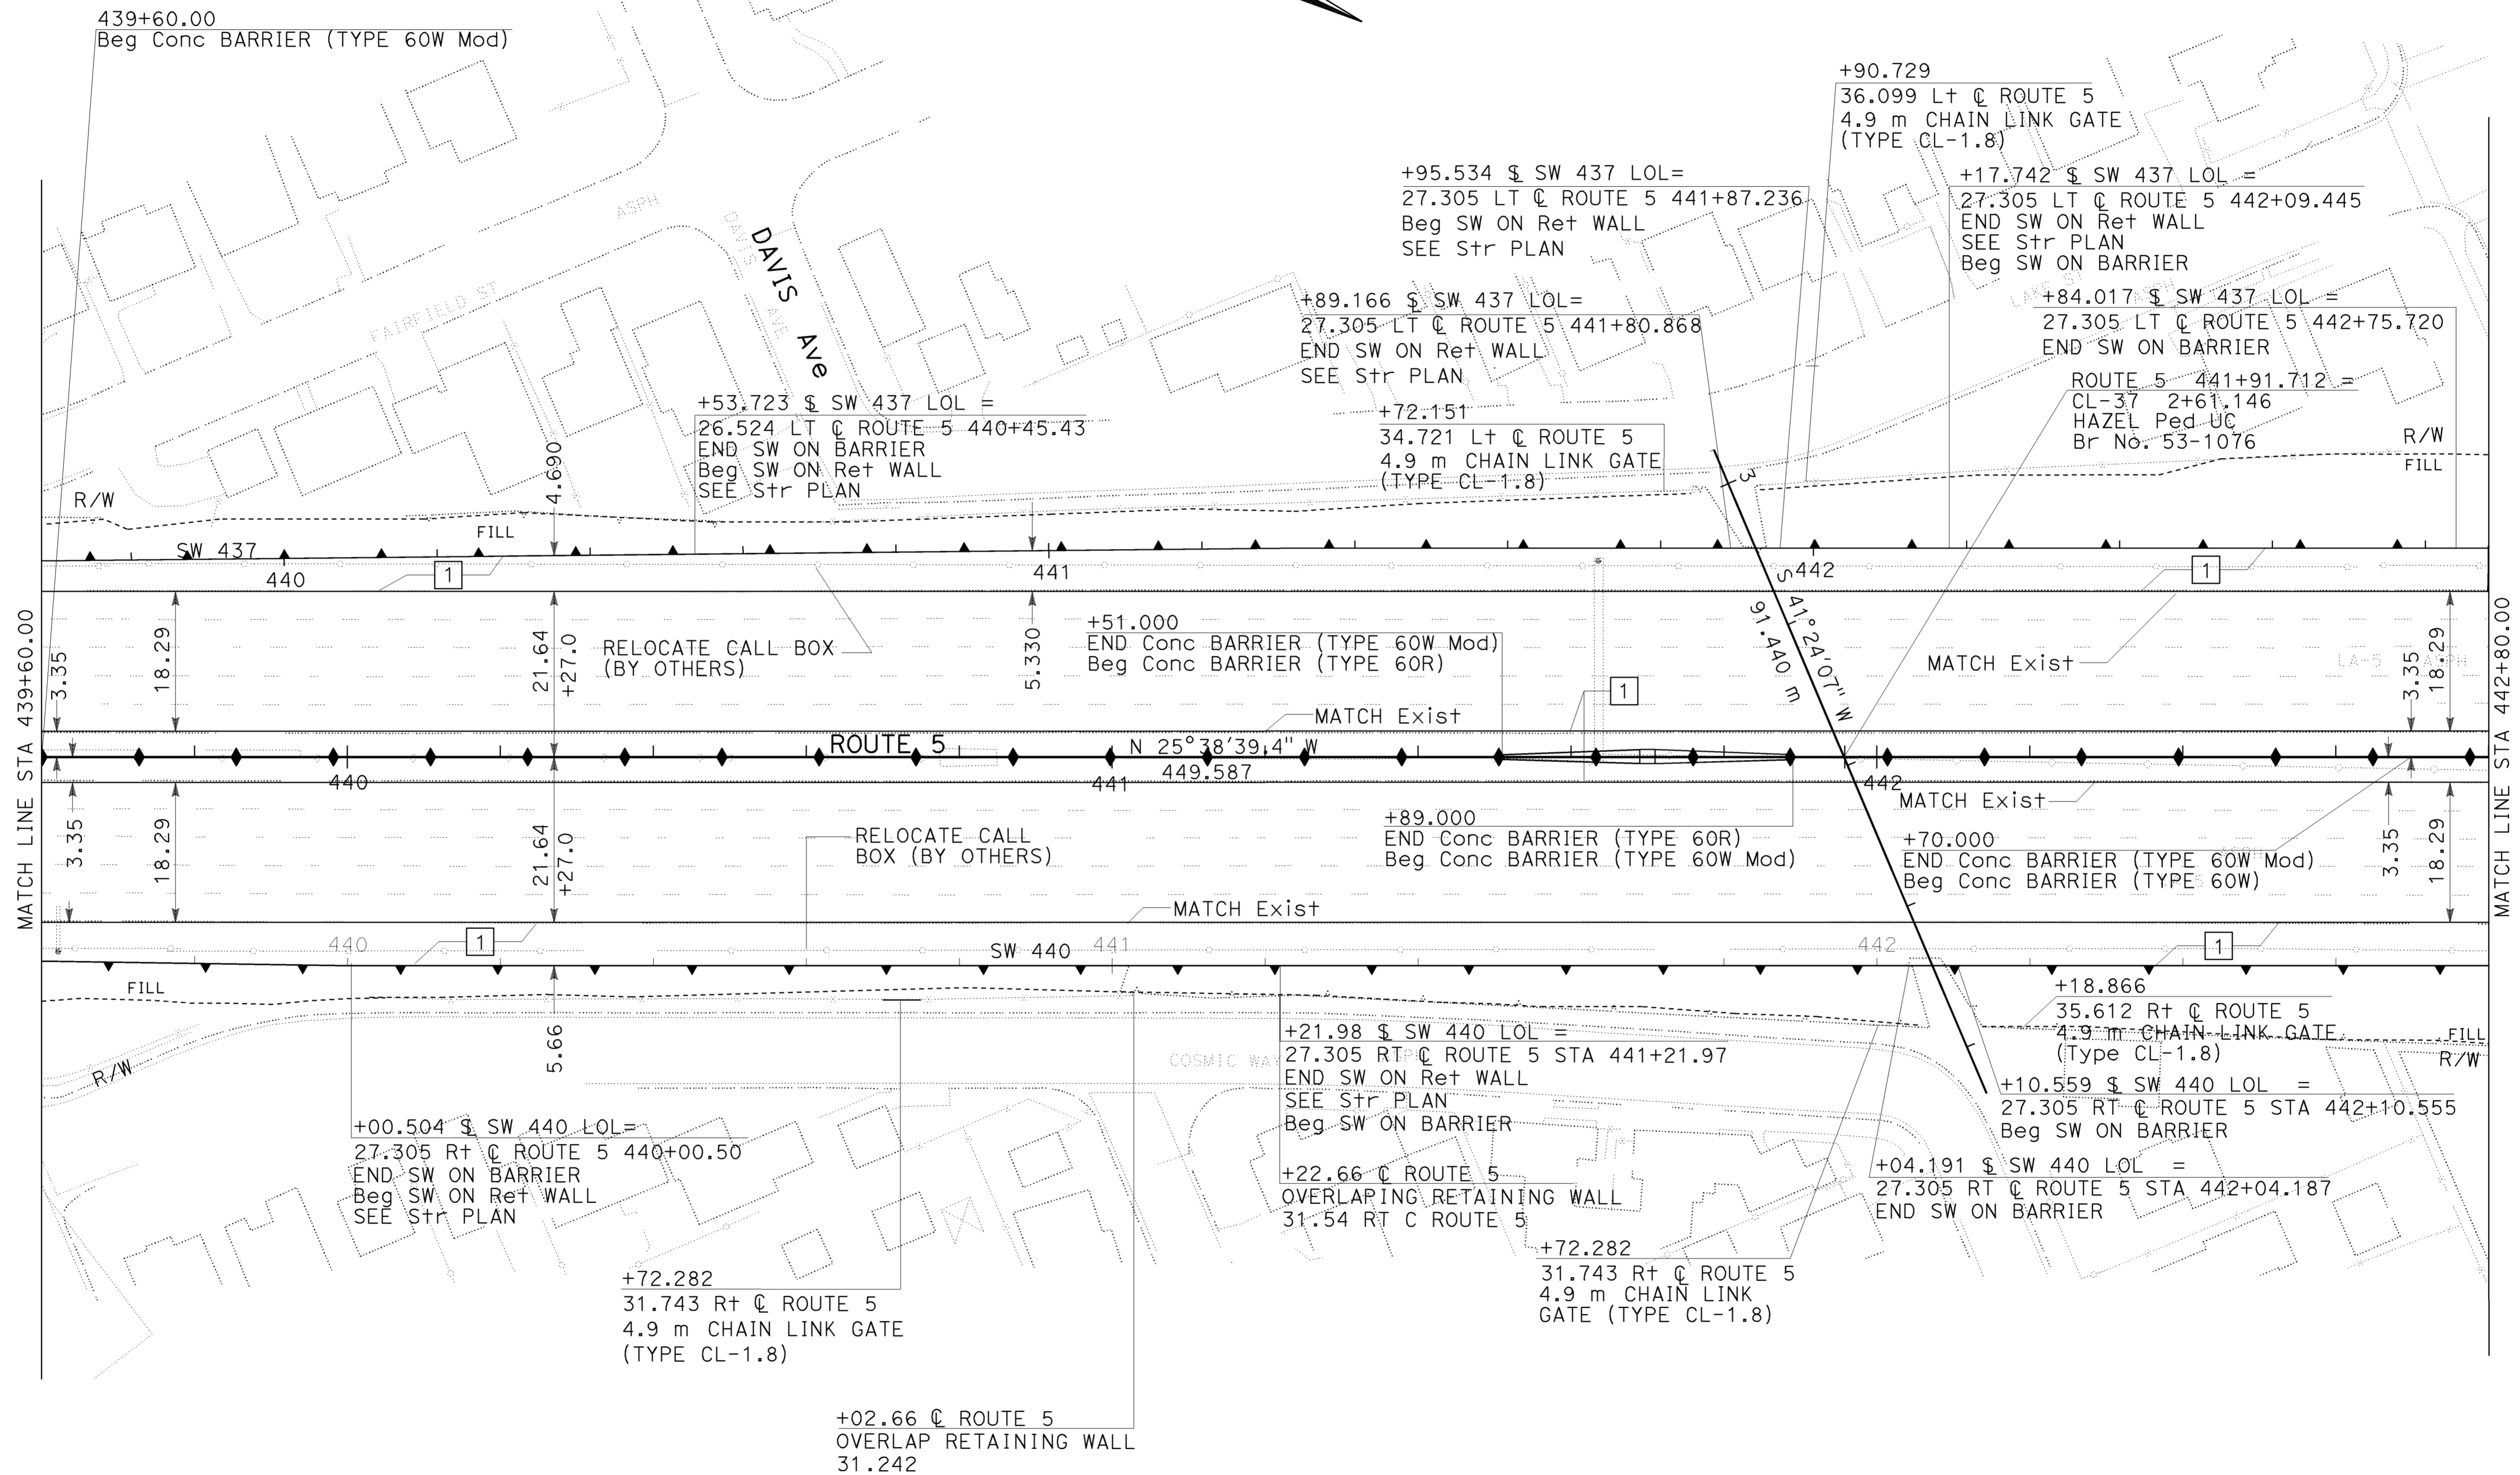ALL DIMENSIONS ARE IN METERS UNLESS OTHERWISE SHOWN

LAYOUT
SCALE 1:500

L-5

LAST REVISION DATE PLOTTED => 12-JUN-2009
 10-24-08 TIME PLOTTED => 07:29

NOTE: 1. FOR COMPLETE RIGHT OF WAY AND ACCURATE ACCESS DATA, SEE RIGHT OF WAY RECORD MAPS AT DISTRICT OFFICE.



Dist	COUNTY	ROUTE	KILOMETER POST TOTAL PROJECT	SHEET No.	TOTAL SHEETS
07	LA	5	42.8/47.3	14	1073


2-24-09
 REGISTERED CIVIL ENGINEER DATE
 6-8-09
 PLANS APPROVAL DATE

MUNSHI MOHSIN
 No. 61916
 Exp. 9/30/09
 CIVIL

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CURVE DATA				
NO	R	Δ	T	L
10	464.84	13°23'42"	54.59	108.68
11	70.00	51°8'32"	33.49	62.48
12	800.01	7°43'53"	54.06	107.95
13	914.40	22°55'4"	185.36	365.75
14	552.53	11°27'52"	55.46	110.56

STATE OF CALIFORNIA - DEPARTMENT OF TRANSPORTATION
Caltrans OFFICE OF DESIGN
 FUNCTIONAL SUPERVISOR: CELINA AVILES
 CHECKED BY: []
 CALCULATED/DESIGNED BY: []
 DAWIT WORKU: MUNSHI MOHSIN
 REVISED BY: []
 DATE REVISED: 01/08
 SA: 01/08
 MM: 12/08

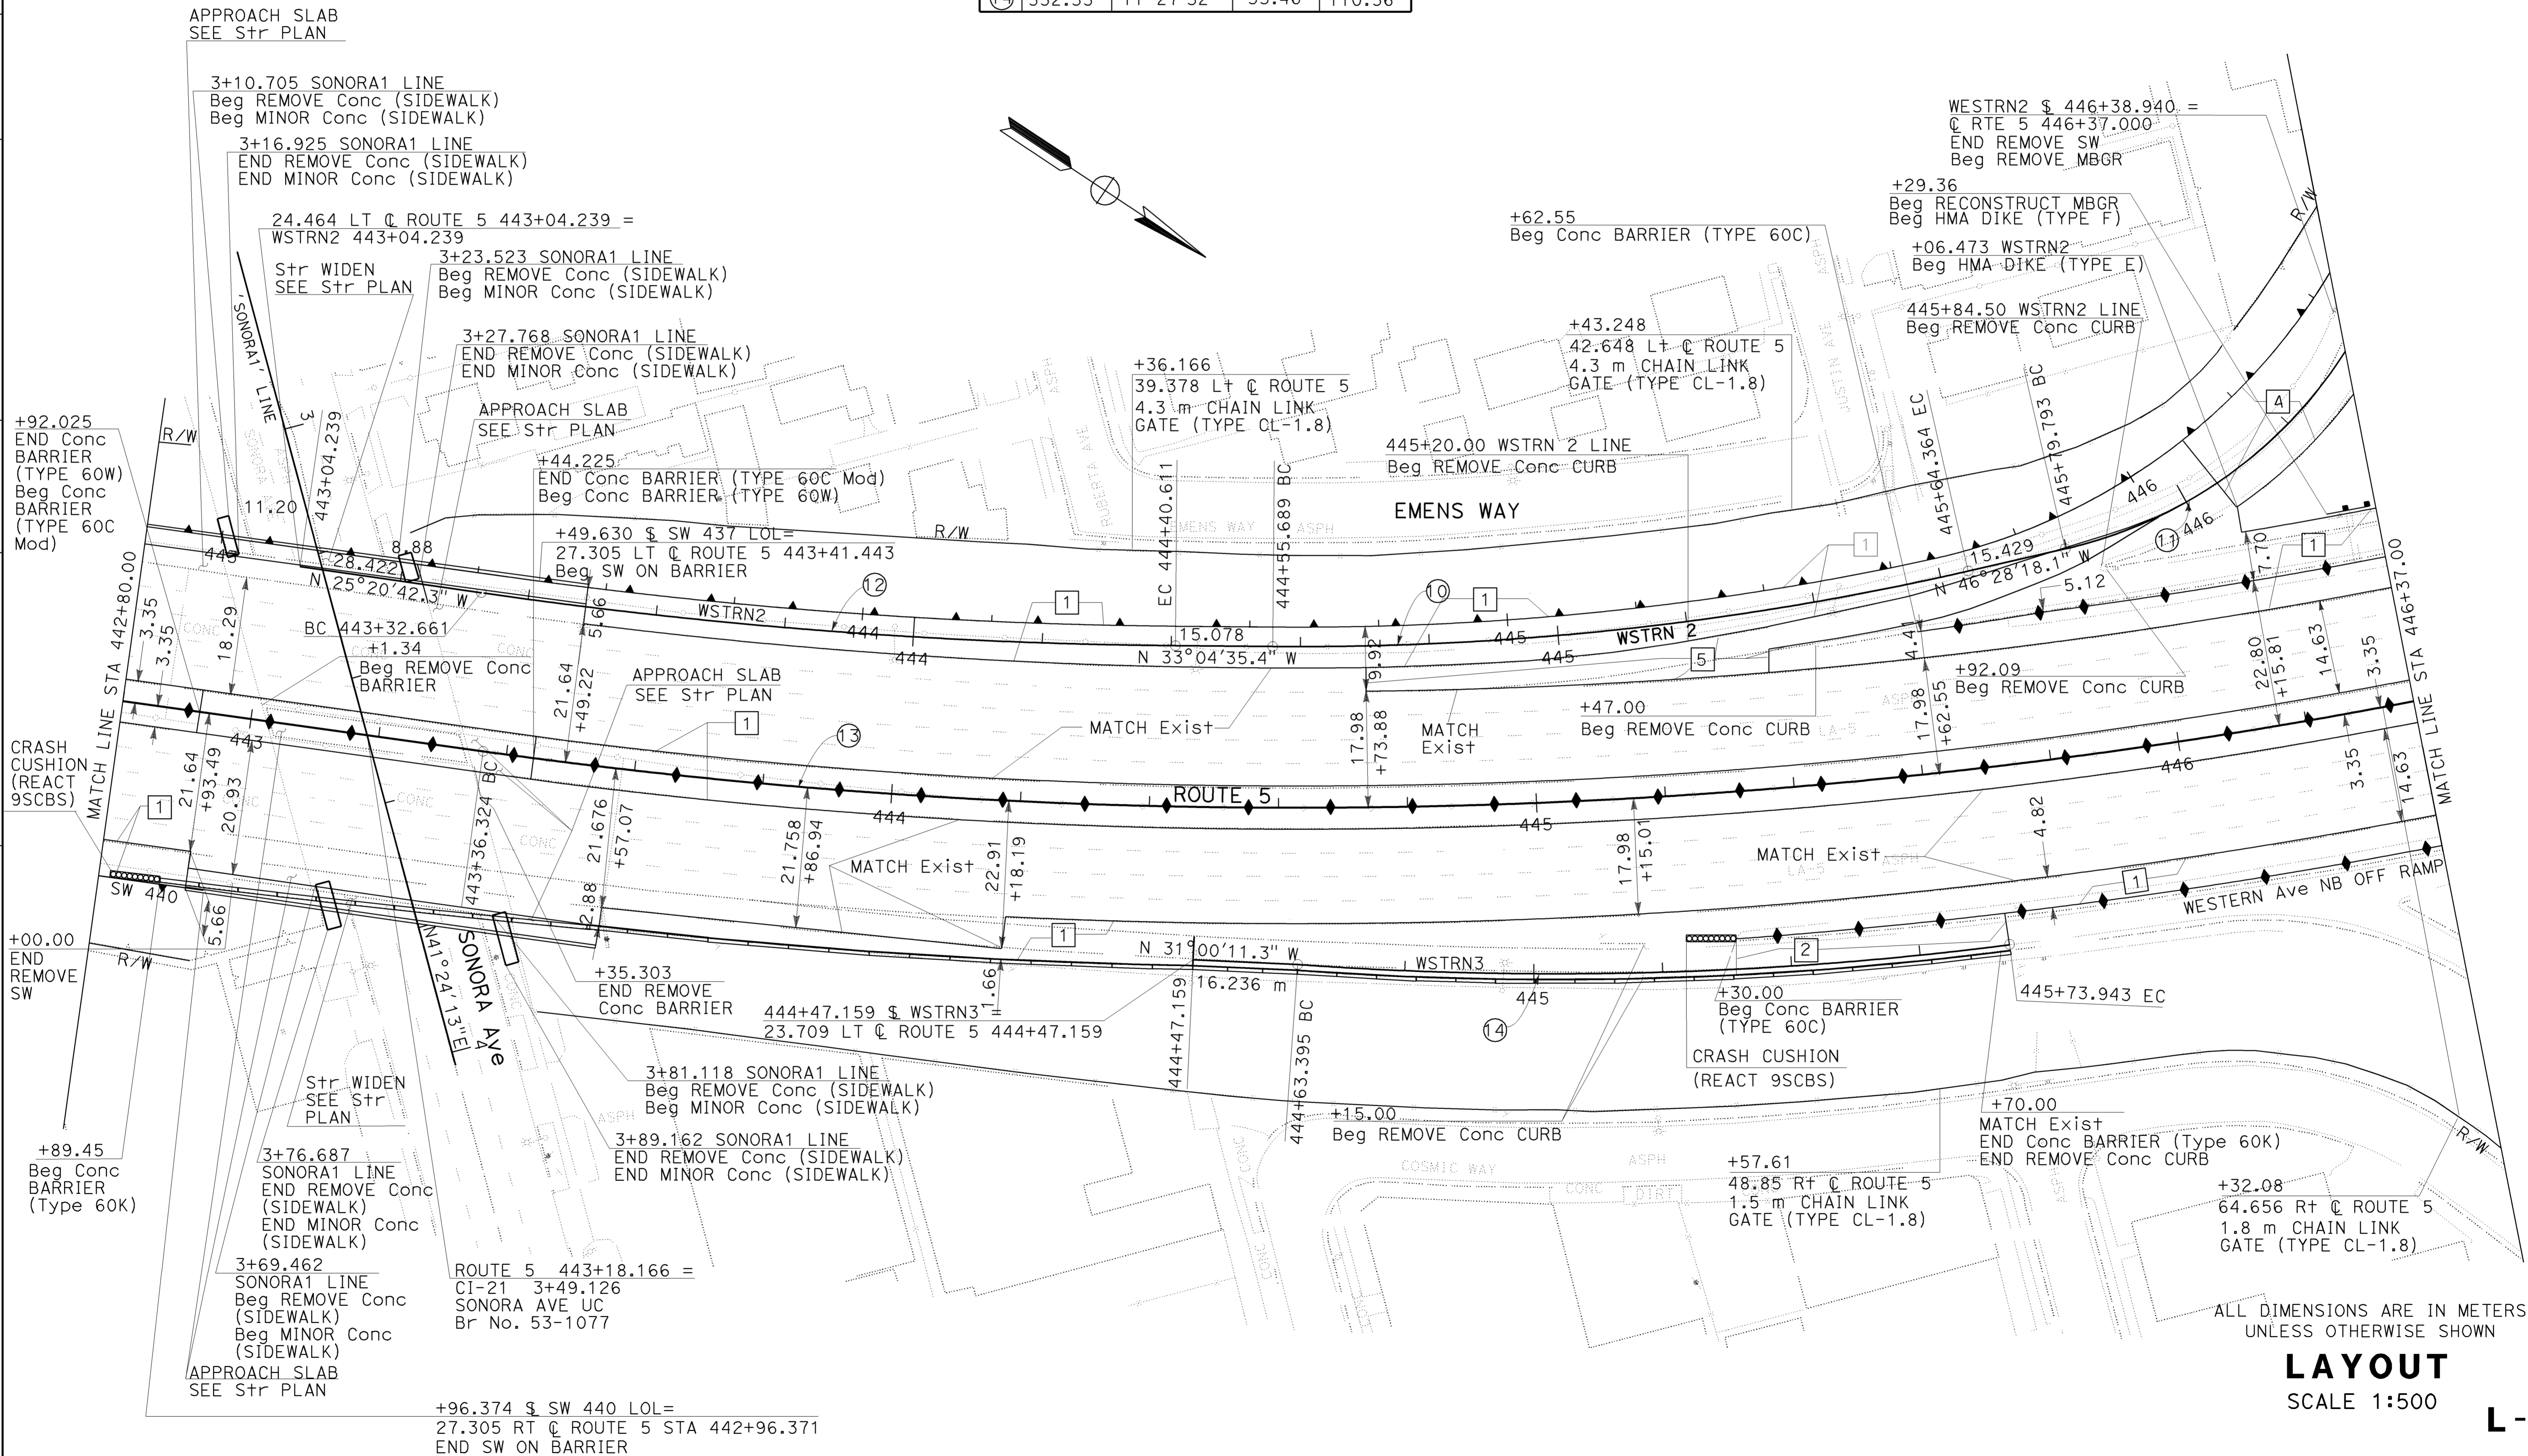

ALL DIMENSIONS ARE IN METERS UNLESS OTHERWISE SHOWN

LAYOUT
 SCALE 1:500

L-6

LAST REVISION DATE PLOTTED => 12-JUN-2009
 12-10-08 TIME PLOTTED => 07:29

STATE OF CALIFORNIA - DEPARTMENT OF TRANSPORTATION
Caltrans OFFICE OF DESIGN
 FUNCTIONAL SUPERVISOR: CELINA AVILES
 CHECKED BY: CELINA AVILES
 CALCULATED/DESIGNED BY: CELINA AVILES
 DAWIT WORKU: MUNSHI MOHSIN
 REVISOR: SA: 01/08
 DATE REVISION: 01/08
 MM: 12/08

Dist	COUNTY	ROUTE	KILOMETER POST TOTAL PROJECT	SHEET No.	TOTAL SHEETS
07	LA	5	42.8/47.3	15	1073


2-24-09
 REGISTERED CIVIL ENGINEER DATE
 6-8-09
 PLANS APPROVAL DATE

Metric

MUNSHI MOHSIN
 No. 61916
 Exp. 9/30/09
 CIVIL

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NOTE: 1. FOR COMPLETE RIGHT OF WAY AND ACCURATE ACCESS DATA, SEE RIGHT OF WAY RECORD MAPS AT DISTRICT OFFICE.

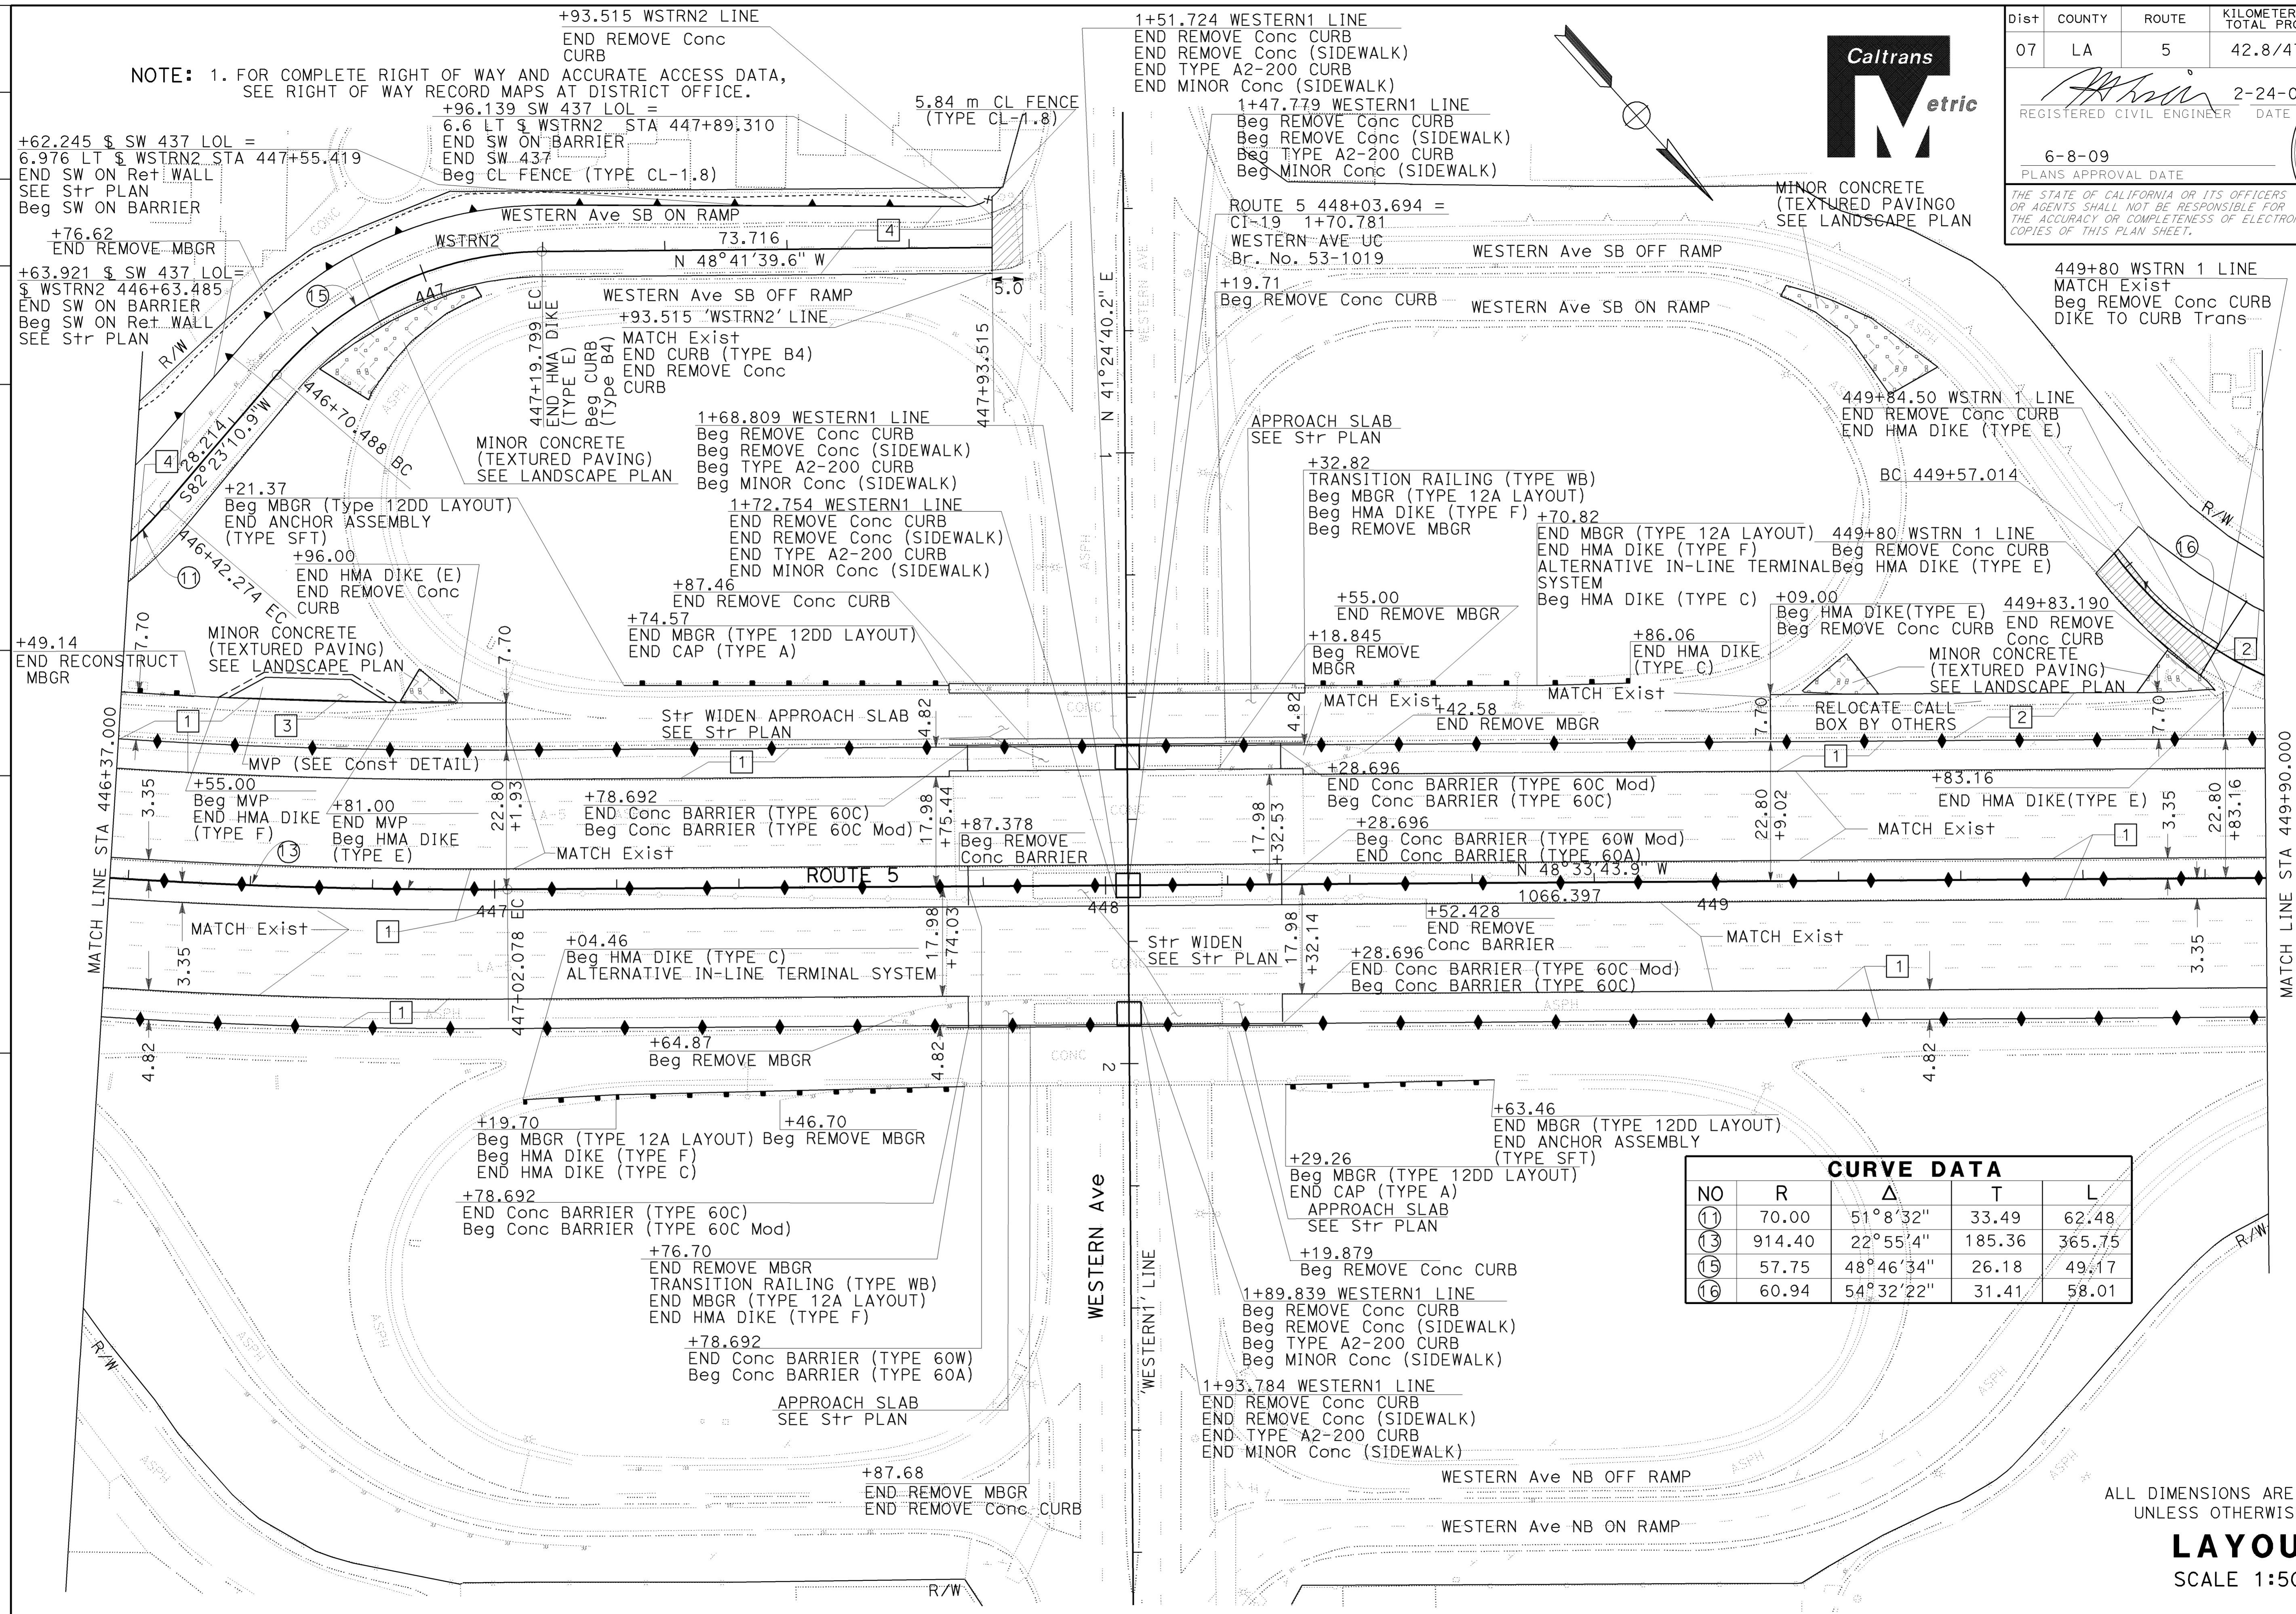


NO	R	Δ	T	L
11	70.00	51° 8' 32"	33.49	62.48
13	914.40	22° 55' 4"	185.36	365.75
15	57.75	48° 46' 34"	26.18	49.17
16	60.94	54° 32' 22"	31.41	58.01

ALL DIMENSIONS ARE IN METERS UNLESS OTHERWISE SHOWN

LAYOUT
 SCALE 1:500

NOTE: 1. FOR COMPLETE RIGHT OF WAY AND ACCURATE ACCESS DATA, SEE RIGHT OF WAY RECORD MAPS AT DISTRICT OFFICE.

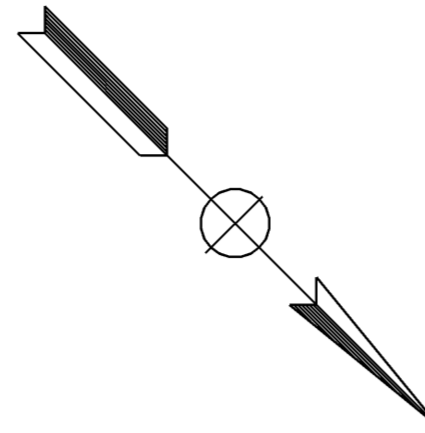


Dist	COUNTY	ROUTE	KILOMETER POST TOTAL PROJECT	SHEET No.	TOTAL SHEETS
07	LA	5	42.8/47.3	16	1073

2-24-09
 REGISTERED CIVIL ENGINEER DATE
 6-8-09
 PLANS APPROVAL DATE

MUNSHI MOHSIN
 No. 61916
 Exp. 9/30/09
 CIVIL
 STATE OF CALIFORNIA

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STATE OF CALIFORNIA - DEPARTMENT OF TRANSPORTATION
Caltrans OFFICE OF DESIGN
 FUNCTIONAL SUPERVISOR: CELINA AVILES
 CALCULATED/DESIGNED BY: MUNSHI MOHSIN
 CHECKED BY:
 DAWIT WORKU
 REVISIONS: SA 01/08, MM 12/08

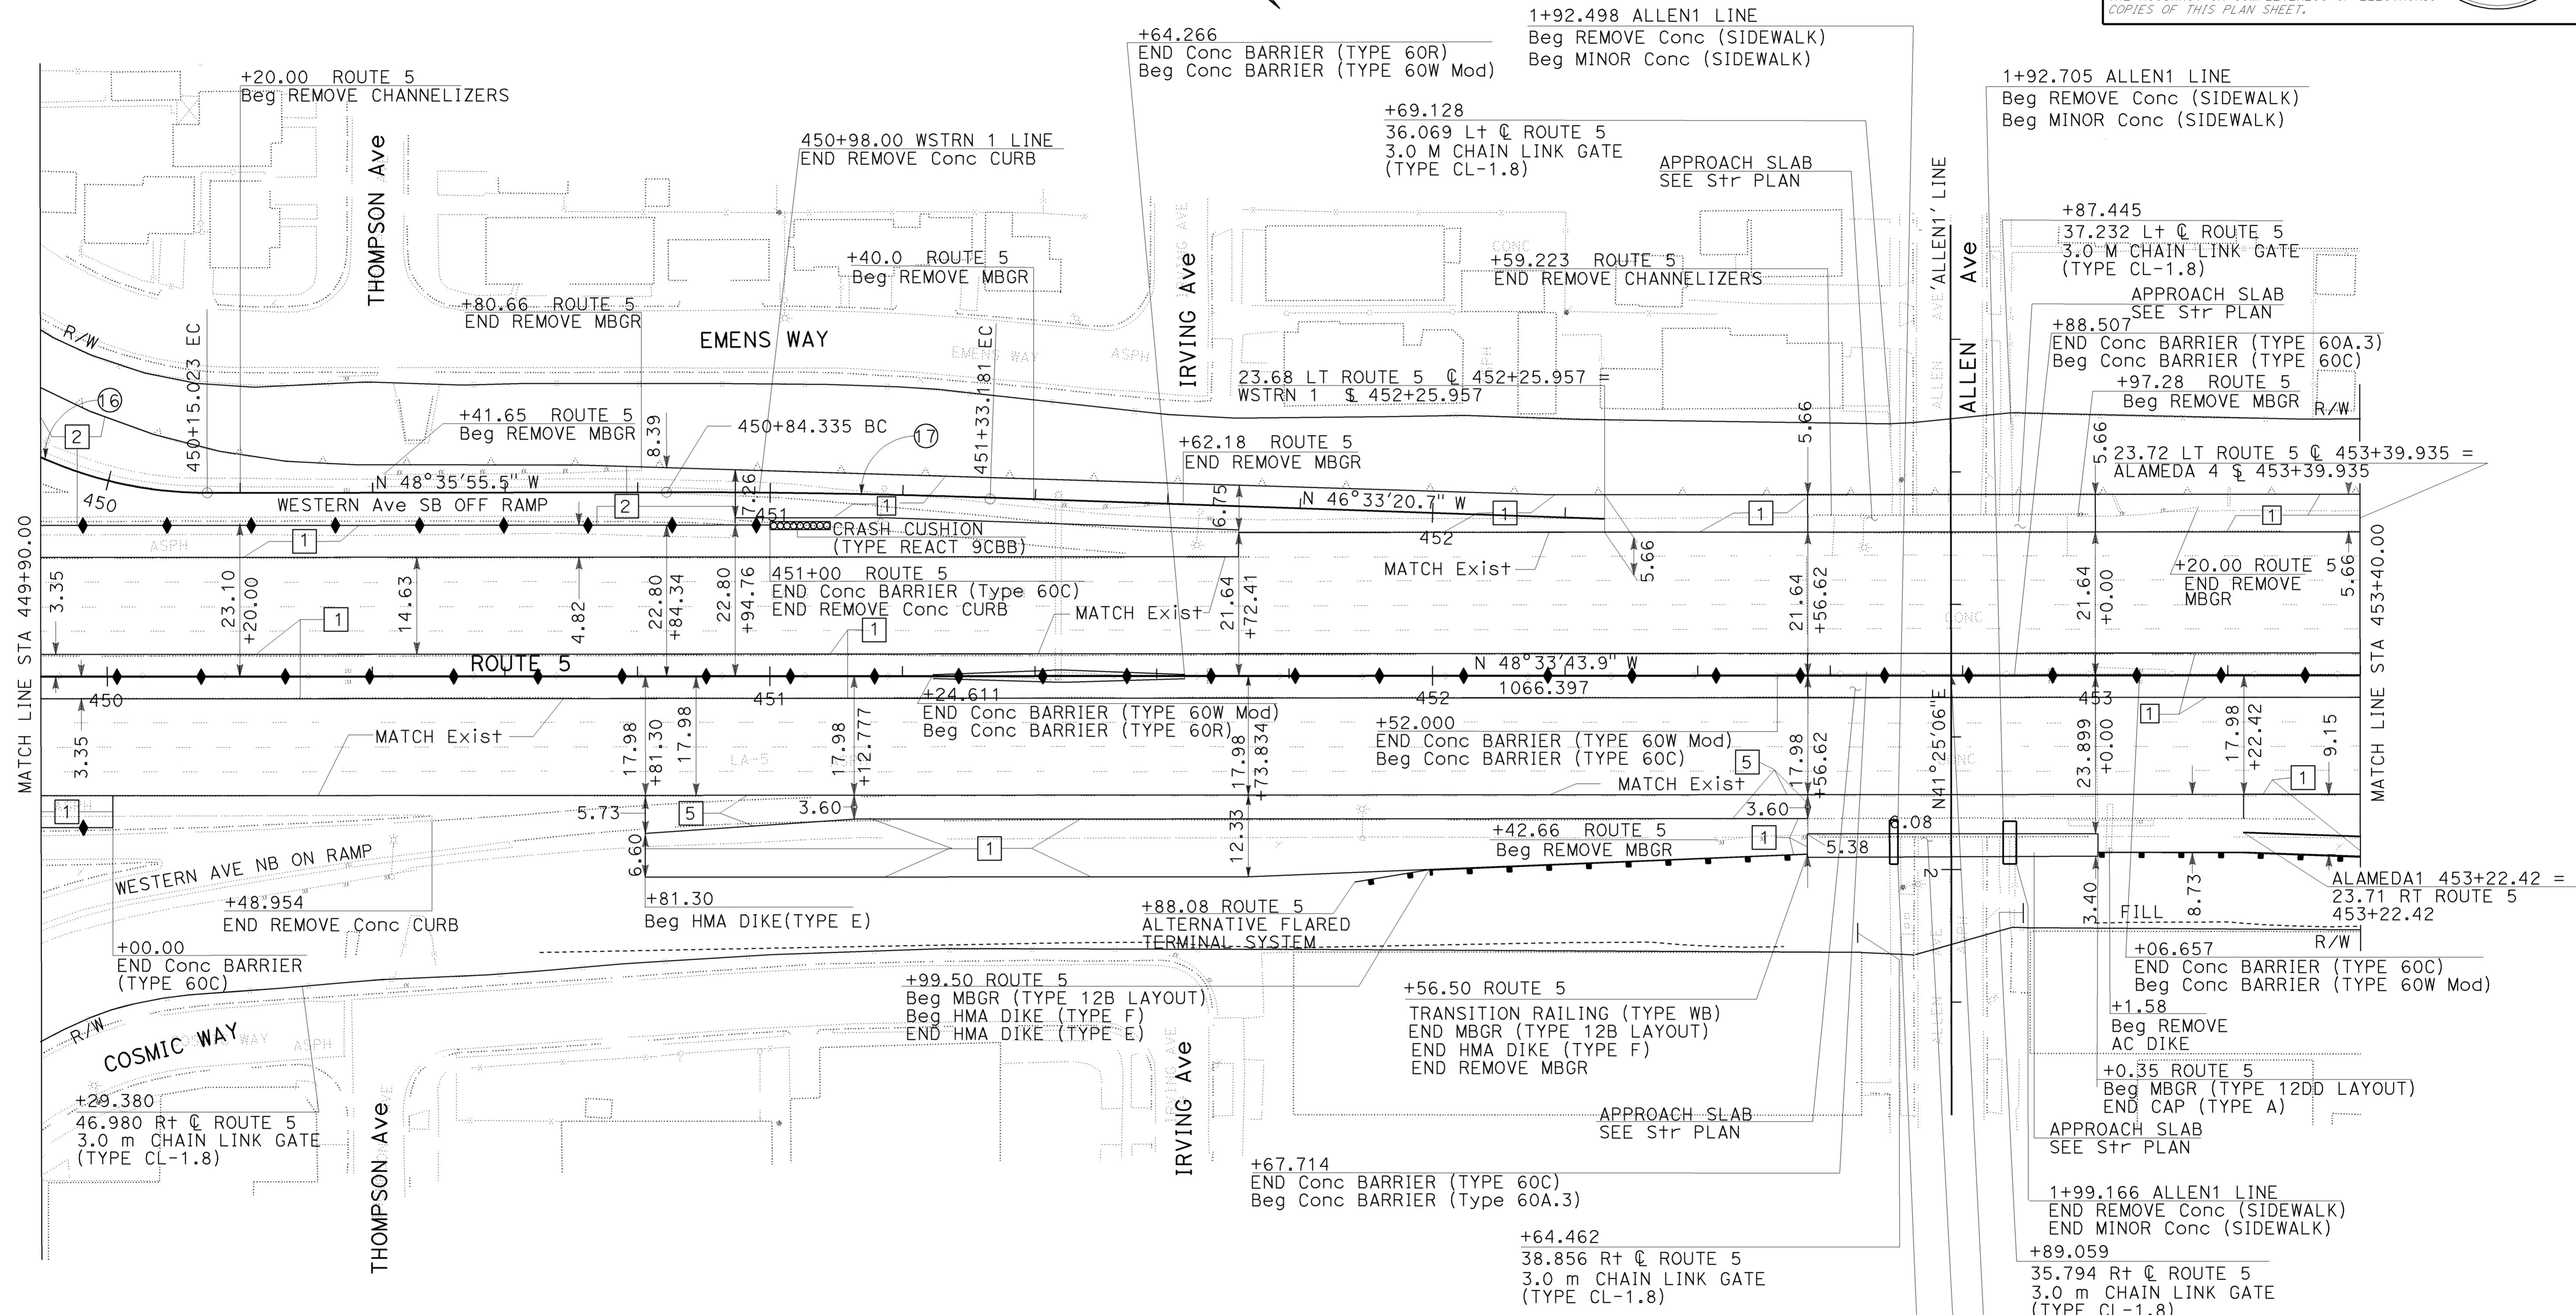

CURVE DATA

No.	R	Δ	T	L
(16)	60.94	54°32'22.480"	31.41	58.01
(17)	1369.96	2°2'34.380"	24.43	48.85

ALL DIMENSIONS ARE IN METERS UNLESS OTHERWISE SHOWN

LAYOUT
 SCALE 1:500

L-8



Str WIDEN
 SEE Str PLAN
 ROUTE 5 452+78.227
 CI-18 1+70.698
 ALLEN Ave UC
 Br No. 53-1081

LAST REVISION DATE PLOTTED => 12-JUN-2009
 12-11-08 TIME PLOTTED => 07:29

NOTE: 1. FOR COMPLETE RIGHT OF WAY AND ACCURATE ACCESS DATA, SEE RIGHT OF WAY RECORD MAPS AT DISTRICT OFFICE.




Dist	COUNTY	ROUTE	KILOMETER POST TOTAL PROJECT	SHEET No.	TOTAL SHEETS
07	LA	5	42.8/47.3	17	1073

2-24-09
 REGISTERED CIVIL ENGINEER DATE
 6-8-09
 PLANS APPROVAL DATE

MUNSHI MOHSIN
 No. 61916
 Exp. 9/30/09
 CIVIL
 STATE OF CALIFORNIA

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STATE OF CALIFORNIA - DEPARTMENT OF TRANSPORTATION
Caltrans OFFICE OF DESIGN
 FUNCTIONAL SUPERVISOR: CELINA AVILES
 CALCULATED/DESIGNED BY: MUNSHI MOHSIN
 CHECKED BY: MUNSHI MOHSIN
 REVISIONS: SA 01/08, MM 12/08

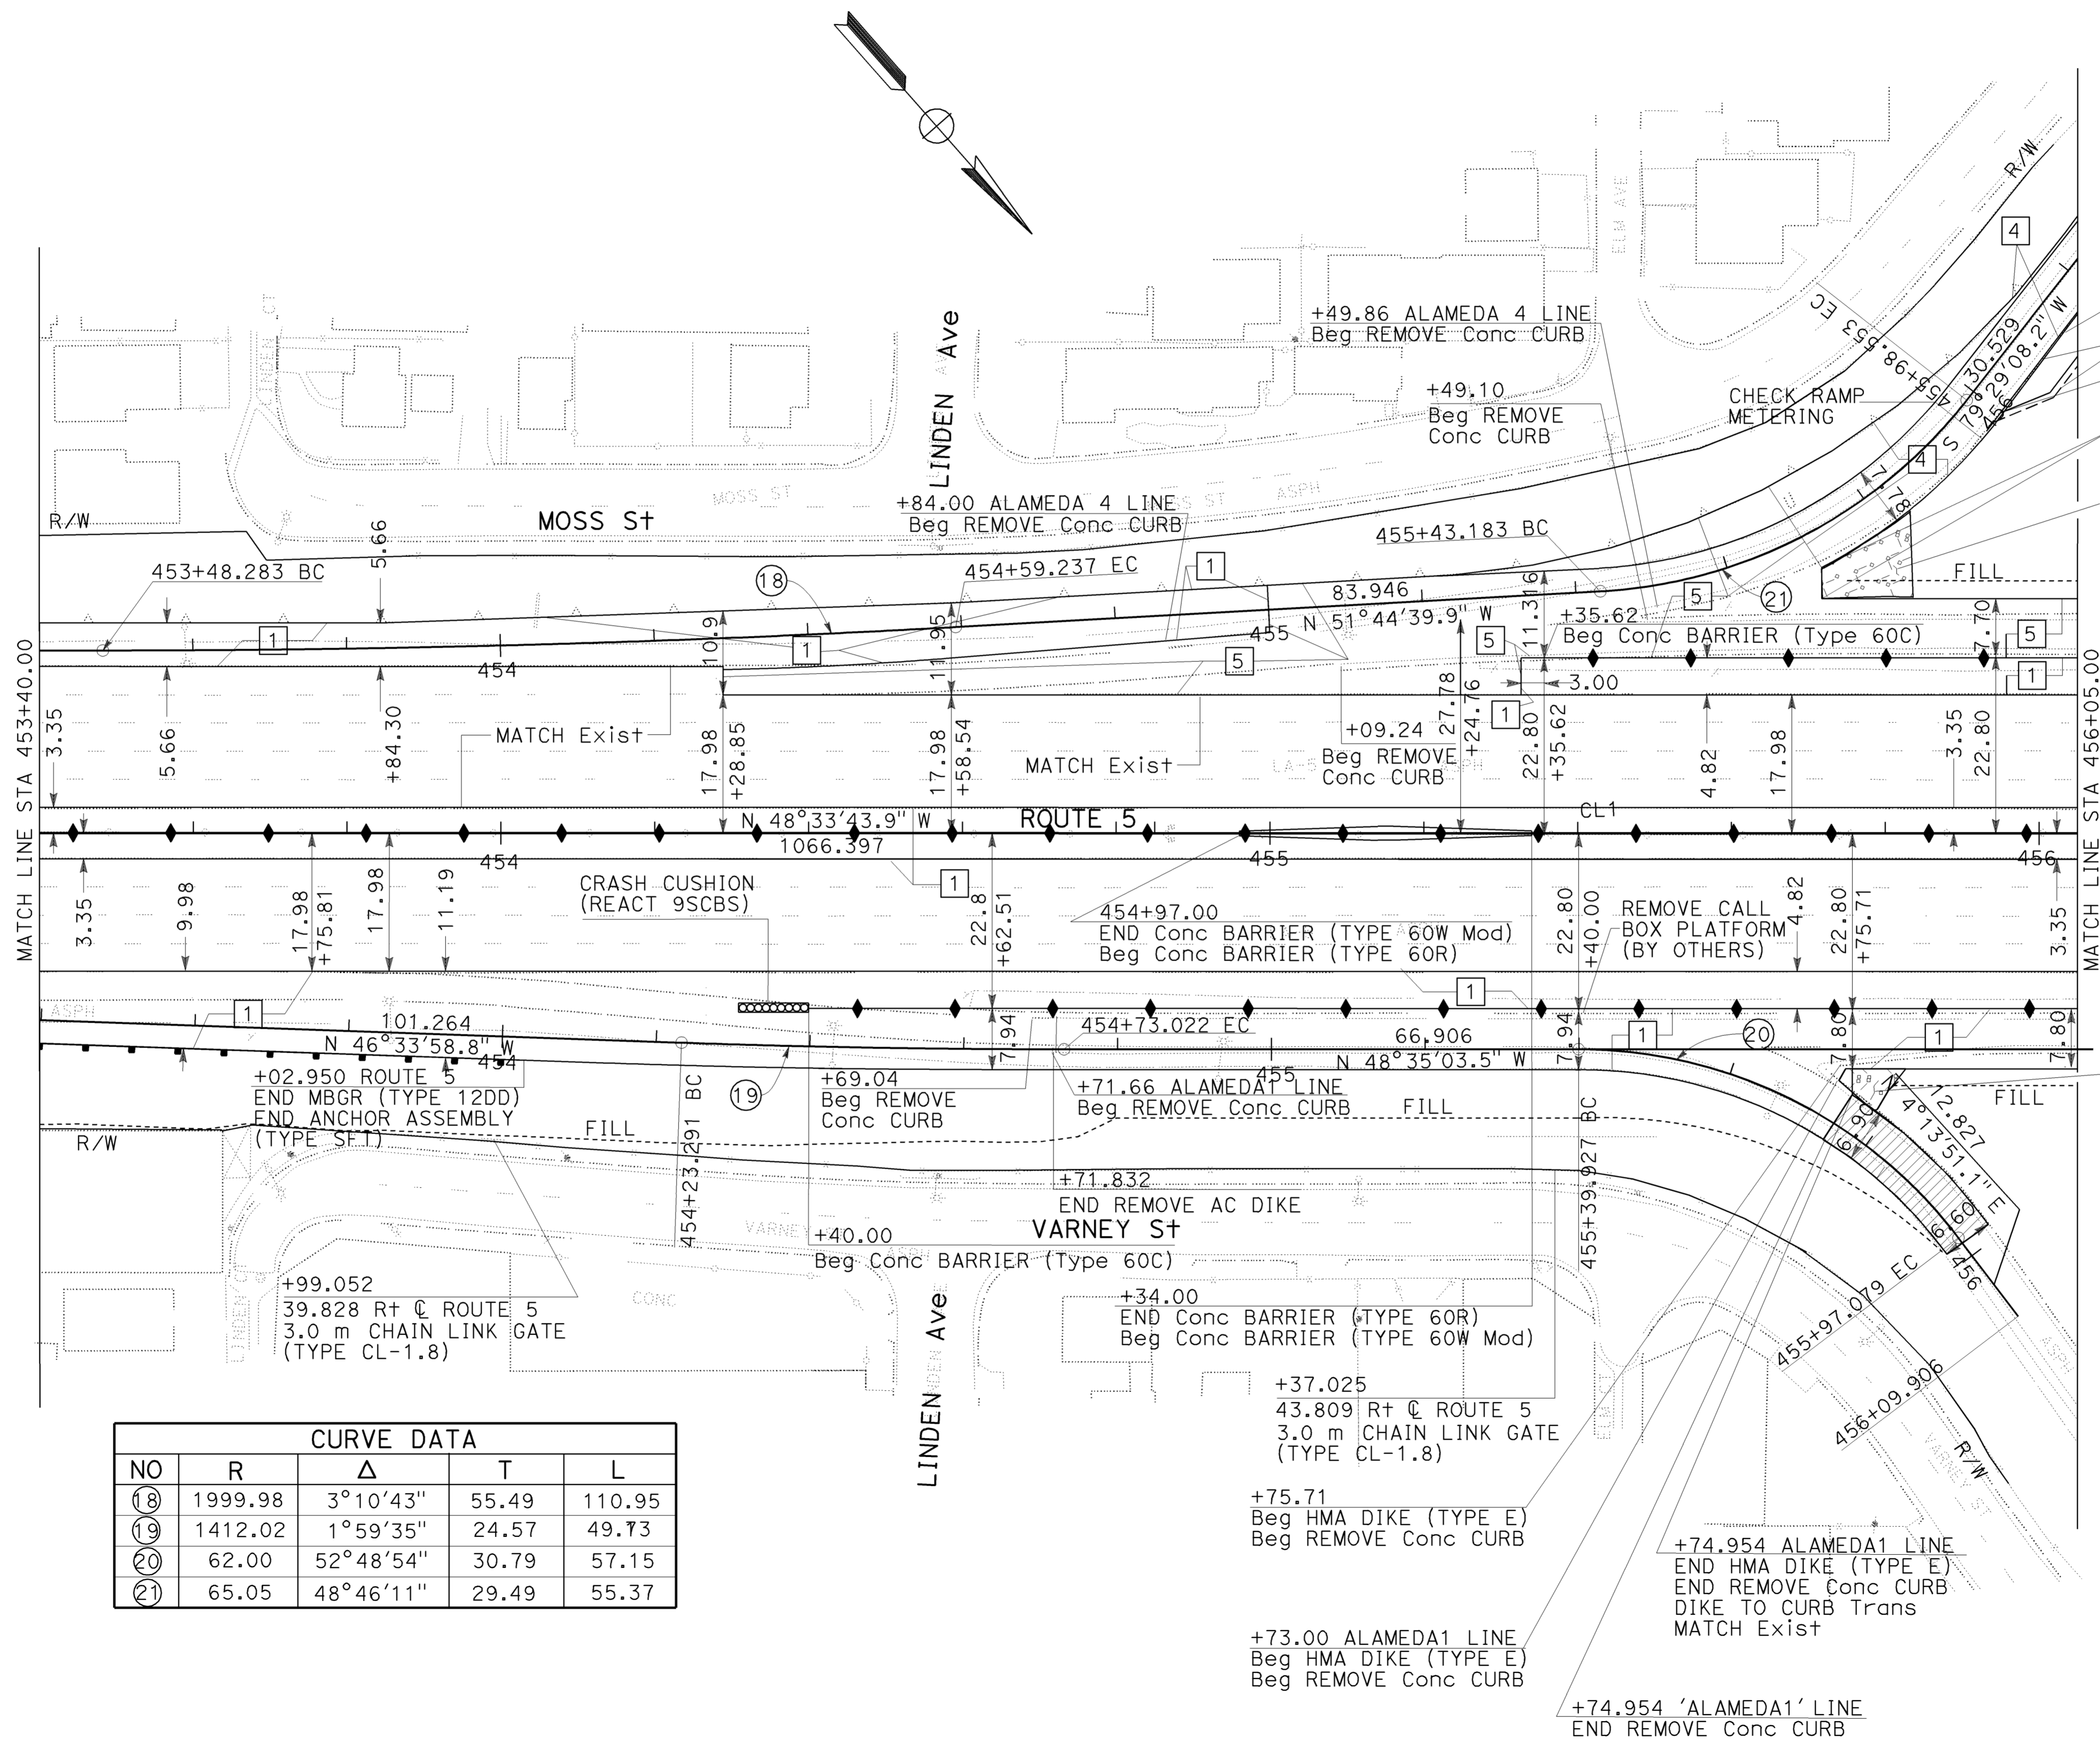

CURVE DATA				
NO	R	Δ	T	L
18	1999.98	3°10'43"	55.49	110.95
19	1412.02	1°59'35"	24.57	49.73
20	62.00	52°48'54"	30.79	57.15
21	65.05	48°46'11"	29.49	55.37

MVP
 +00.00 § ALAMEDA4
 END HMA DIKE (TYPE E)
 Beg MVP
 +70.495 § ALAMEDA4 = 71.692 C ROUTE 5
 Beg HMA DIKE (TYPE E)
 MINOR CONCRETE
 (TEXTURED PAVING)
 SEE LANDSCAPE PLAN

MINOR CONCRETE
 (TEXTURED PAVING)
 SEE LANDSCAPE PLAN

ALL DIMENSIONS ARE IN METERS
 UNLESS OTHERWISE SHOWN

LAYOUT
 SCALE 1:500


L-9

Dist	COUNTY	ROUTE	KILOMETER POST TOTAL PROJECT	SHEET No.	TOTAL SHEETS
07	LA	5	42.8/47.3	18	1073


2-24-09
 REGISTERED CIVIL ENGINEER DATE
 6-8-09
 PLANS APPROVAL DATE

REGISTERED PROFESSIONAL ENGINEER
 MUNSHI MOHSIN
 No. 61916
 Exp. 9/30/09
 CIVIL
 STATE OF CALIFORNIA

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NOTE: 1. FOR COMPLETE RIGHT OF WAY AND ACCURATE ACCESS DATA, SEE RIGHT OF WAY RECORD MAPS AT DISTRICT OFFICE.
 2. SEE CONSTRUCTION DETAIL FOR MAINTENANCE VEHICLE PULLOUT

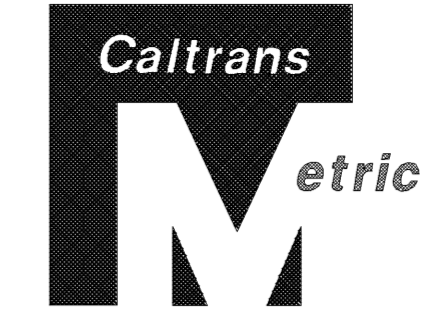

NO	R	Δ	T	L
22	548.64	35°10'0"	173.86	336.74
23	60.96	49°6'32"	27.85	52.25
24	67.45	51°56'24"	32.85	61.14

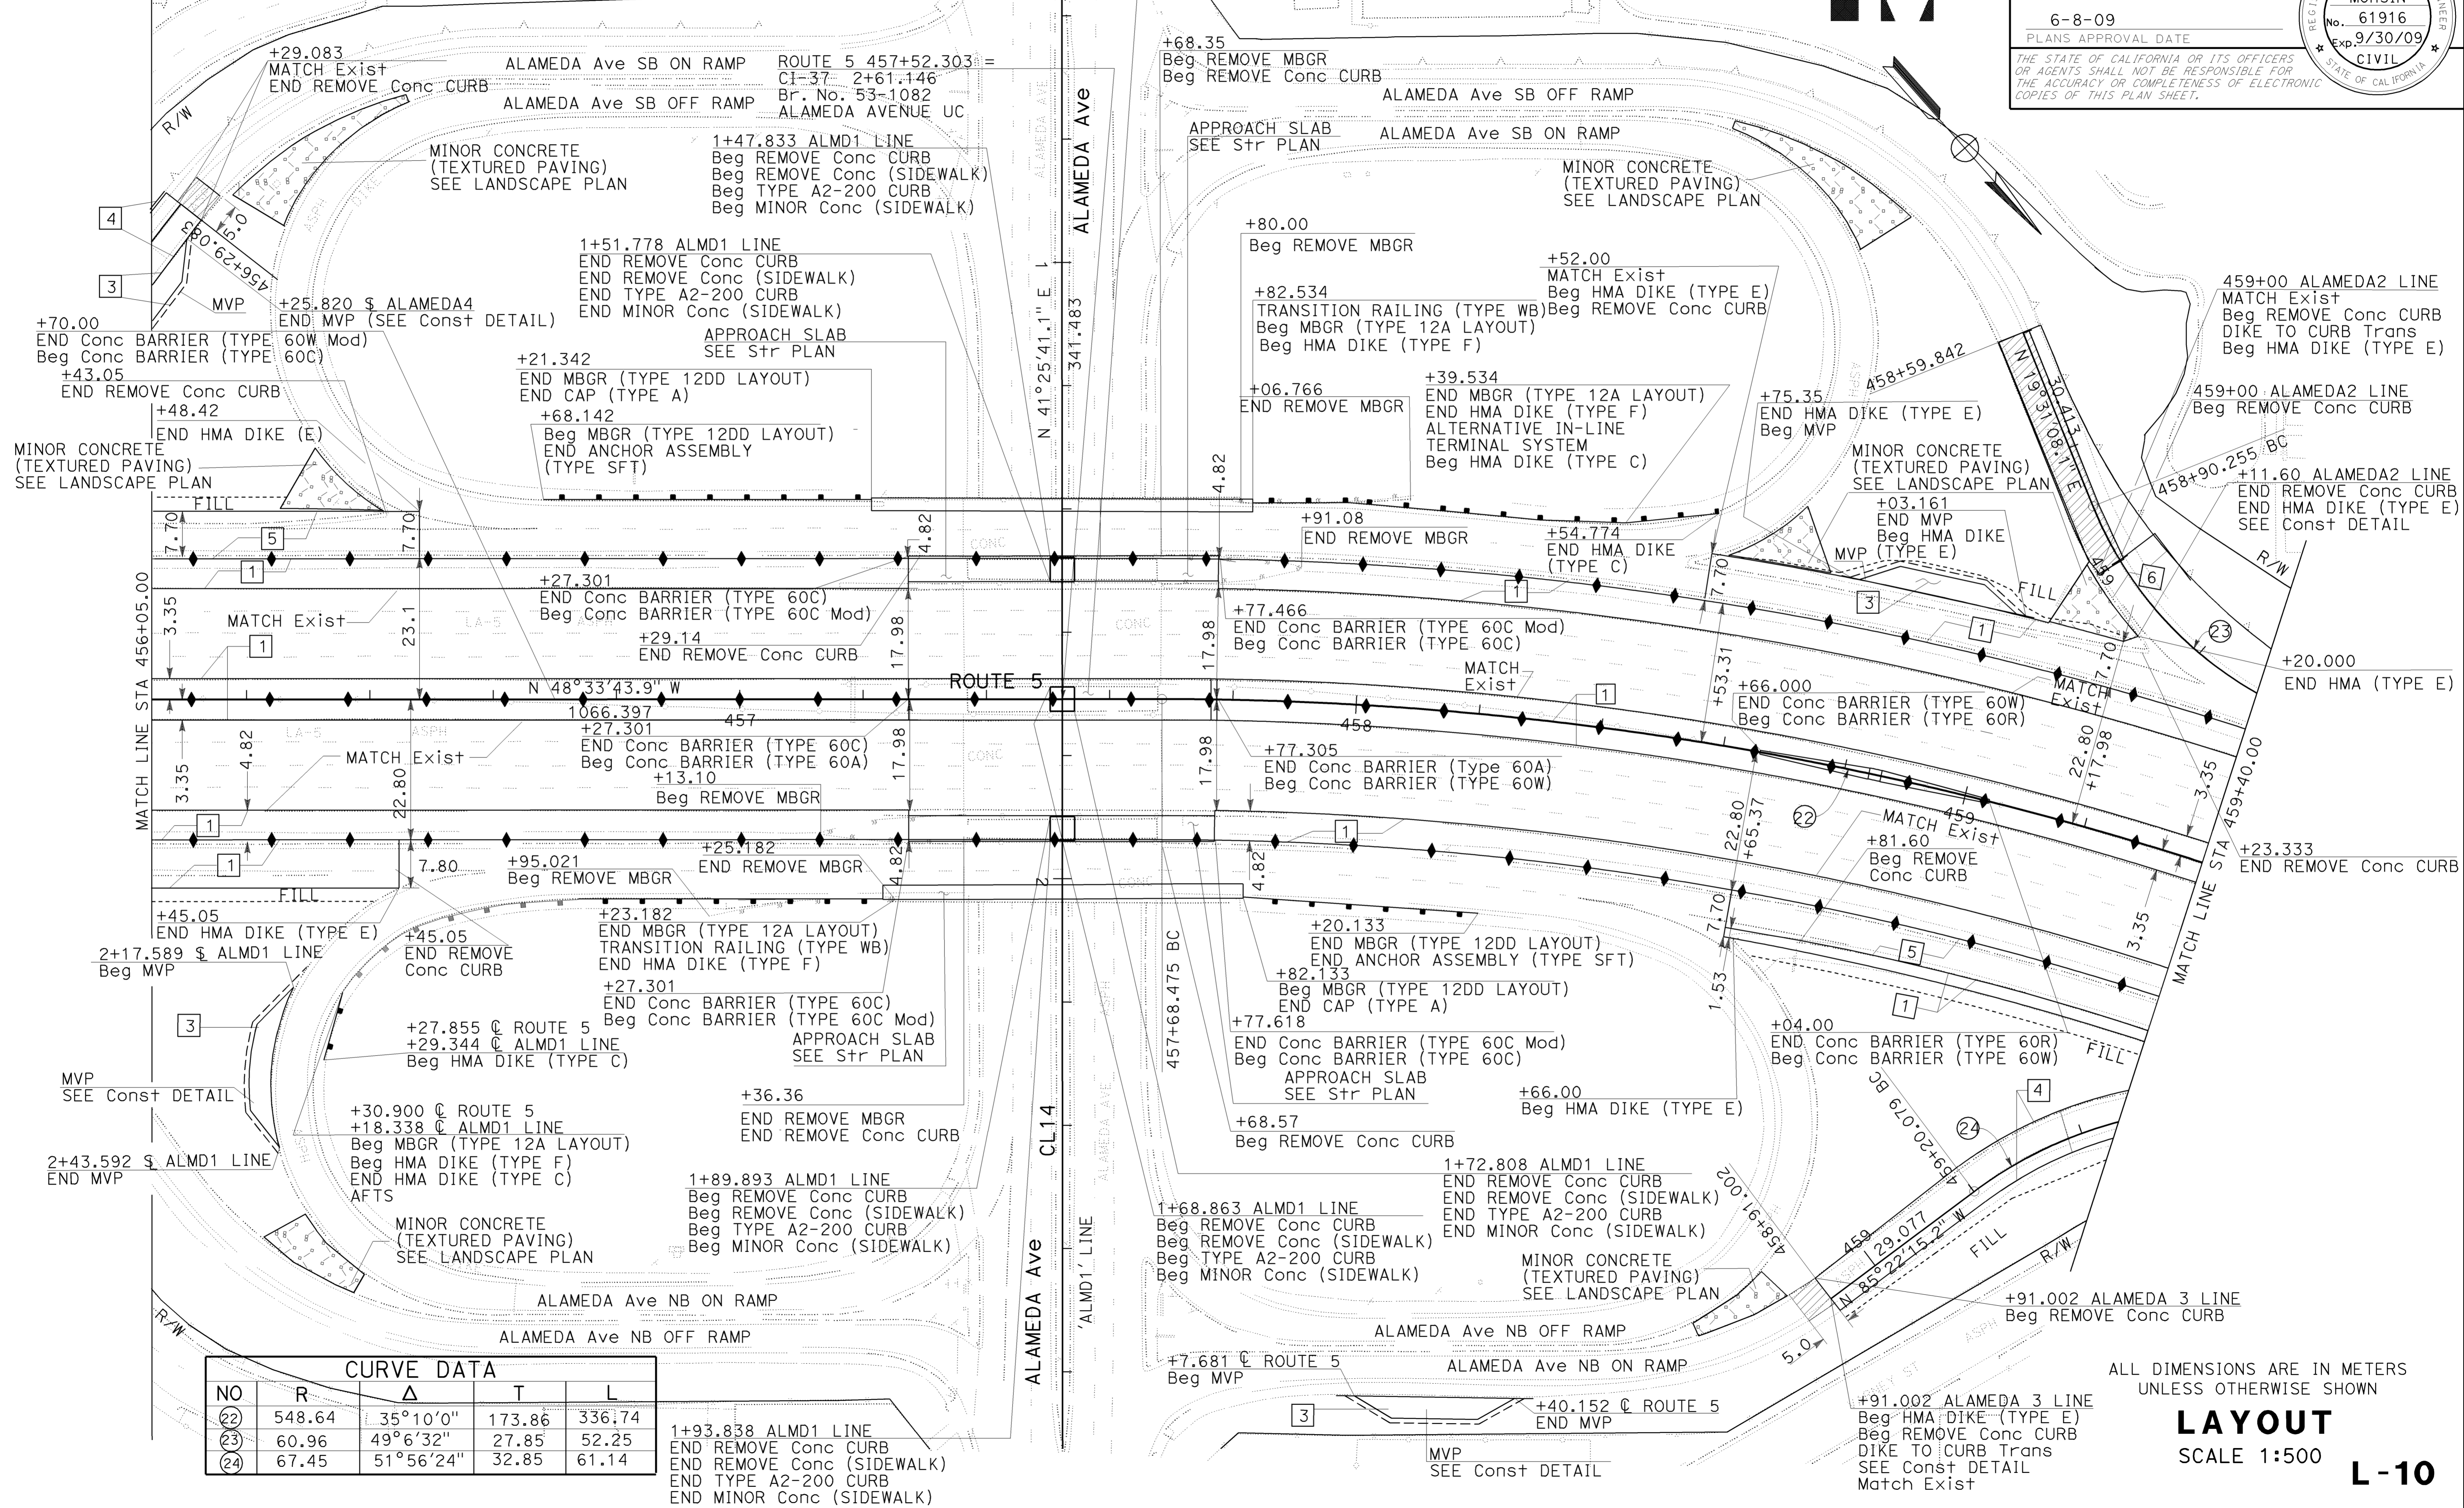ALL DIMENSIONS ARE IN METERS UNLESS OTHERWISE SHOWN

LAYOUT
SCALE 1:500
L-10

STATE OF CALIFORNIA - DEPARTMENT OF TRANSPORTATION

Caltrans OFFICE OF DESIGN

FUNCTIONAL SUPERVISOR: CELINA AVILES

DESIGNED BY: MUNSHI MOHSIN

CHECKED BY: MUNSHI MOHSIN

REVISIONS:

NO	DATE	BY	DESCRIPTION
1	01/08	SA	REVISION
2	12/08	MM	REVISION



USERNAME => trmnguye
DGN FILE => 712184ea010.dgn


LAST REVISION DATE PLOTTED => 12-JUN-2009 12-10-08 TIME PLOTTED => 07:29

NOTE: 1. FOR COMPLETE RIGHT OF WAY AND ACCURATE ACCESS DATA, SEE RIGHT OF WAY RECORD MAPS AT DISTRICT OFFICE
 2. WORK AROUND THE AERIAL EASEMENT AND TEMPORARY CONSTRUCTION EASEMENT PARCEL 78706-1 UNTIL FEBRUARY 2010



Dist	COUNTY	ROUTE	KILOMETER POST TOTAL PROJECT	SHEET No.	TOTAL SHEETS
07	LA	5	42.8/47.3	19	1073

REGISTERED CIVIL ENGINEER DATE: 2-24-09
 6-8-09 PLANS APPROVAL DATE
 REGISTERED PROFESSIONAL ENGINEER: MUNSHI MOHSIN, No. 61916, Exp. 9/30/09, CIVIL
THE STATE OF CALIFORNIA OR ITS OFFICERS OR AGENTS SHALL NOT BE RESPONSIBLE FOR THE ACCURACY OR COMPLETENESS OF ELECTRONIC COPIES OF THIS PLAN SHEET.

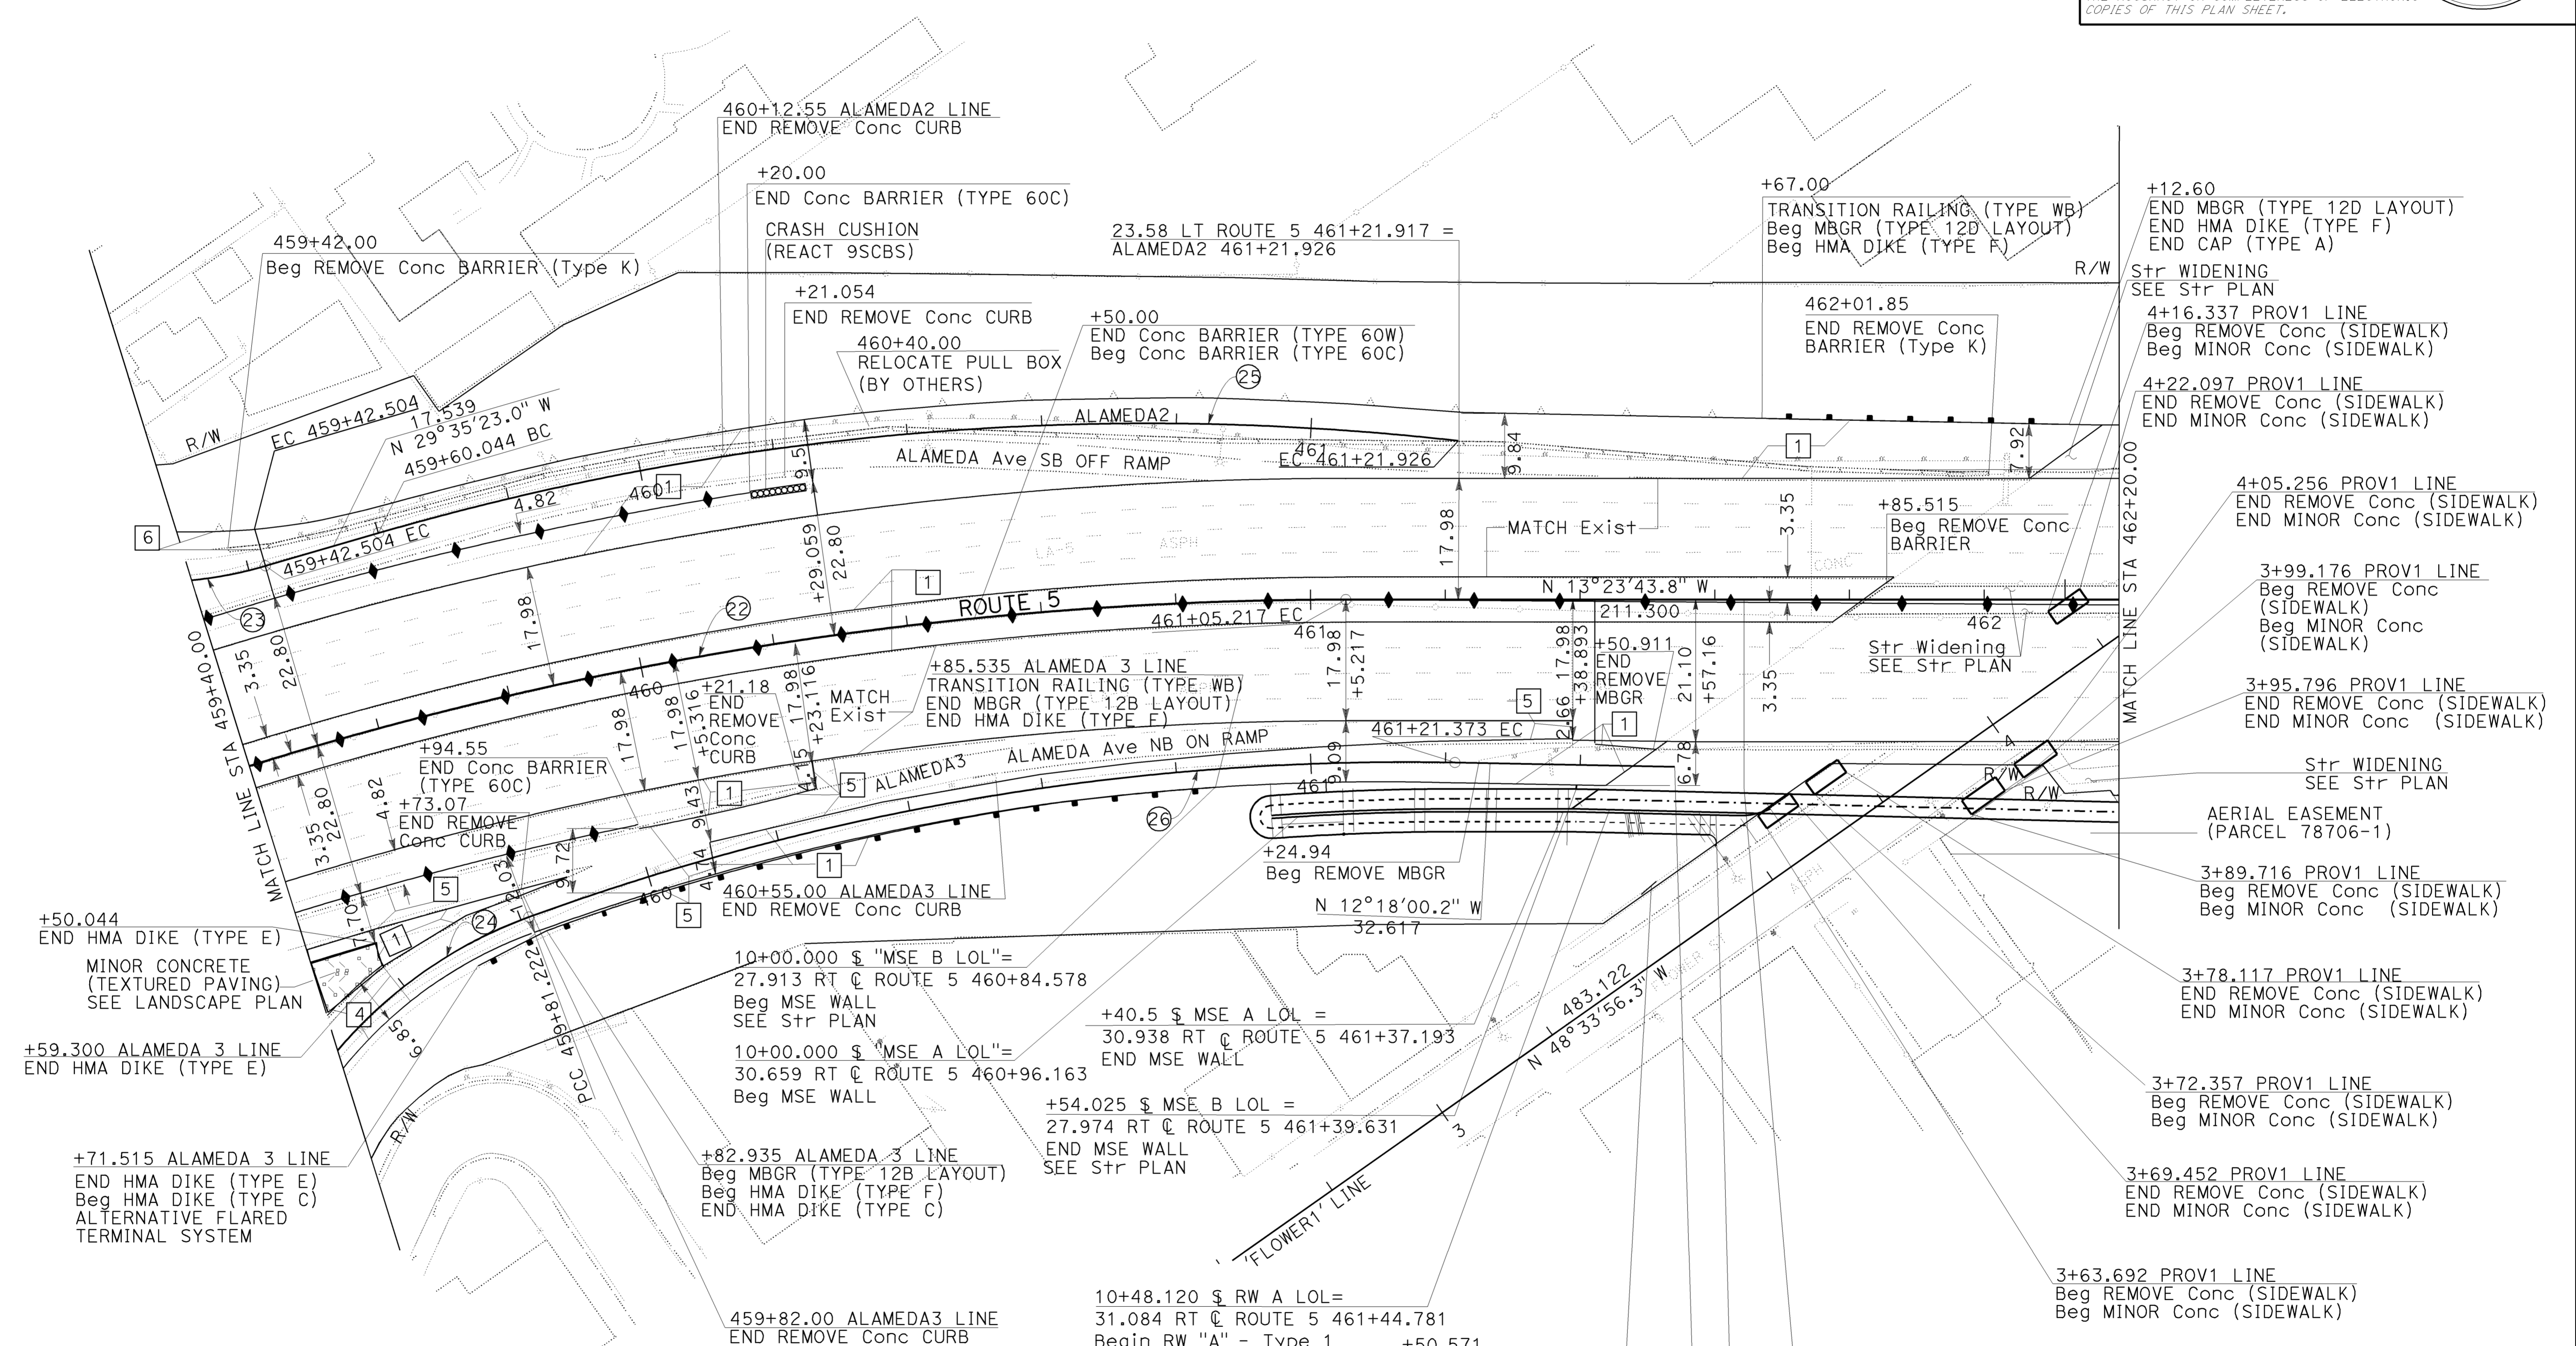

CURVE DATA				
NO	R	Δ	T	L
22	548.64	35°10'0"	173.86	336.74
23	60.96	49°6'32"	27.85	52.25
24	67.45	51°56'24"	32.85	61.14
25	410.00	22°37'20"	82.10	161.88
26	380.04	21°15'21"	71.31	140.15



USERNAME => trmgungye
 DGN FILE => 712184ea011.dgn

LAYOUT
 SCALE 1:500
L-11

LAST REVISION DATE PLOTTED => 12-JUN-2009
 12-17-08 TIME PLOTTED => 07:29

NOTE: 1. FOR COMPLETE RIGHT OF WAY AND ACCURATE ACCESS DATA,
SEE RIGHT OF WAY RECORD MAPS AT DISTRICT OFFICE.
2. WORK AROUND AERIAL EASEMENT PARCELS
78706 AND 78707 UNTIL JUNE 10, 2010.



Dist	COUNTY	ROUTE	KILOMETER POST TOTAL PROJECT	SHEET No.	TOTAL SHEETS
07	LA	5	42.8/47.3	20	1073


2-24-09
REGISTERED CIVIL ENGINEER DATE

6-8-09
PLANS APPROVAL DATE

MUNSHI MOHSIN
No. 61916
Exp. 9/30/09
CIVIL

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STATE OF CALIFORNIA - DEPARTMENT OF TRANSPORTATION
Caltrans OFFICE OF DESIGN
FUNCTIONAL SUPERVISOR
CELINA AVILES
CALCULATED-DESIGNED BY
CHECKED BY
DAWIT WORKU
MUNSHI MOHSIN
REVISOR
DATE REVISOR
SA
01/08
MM
12/08

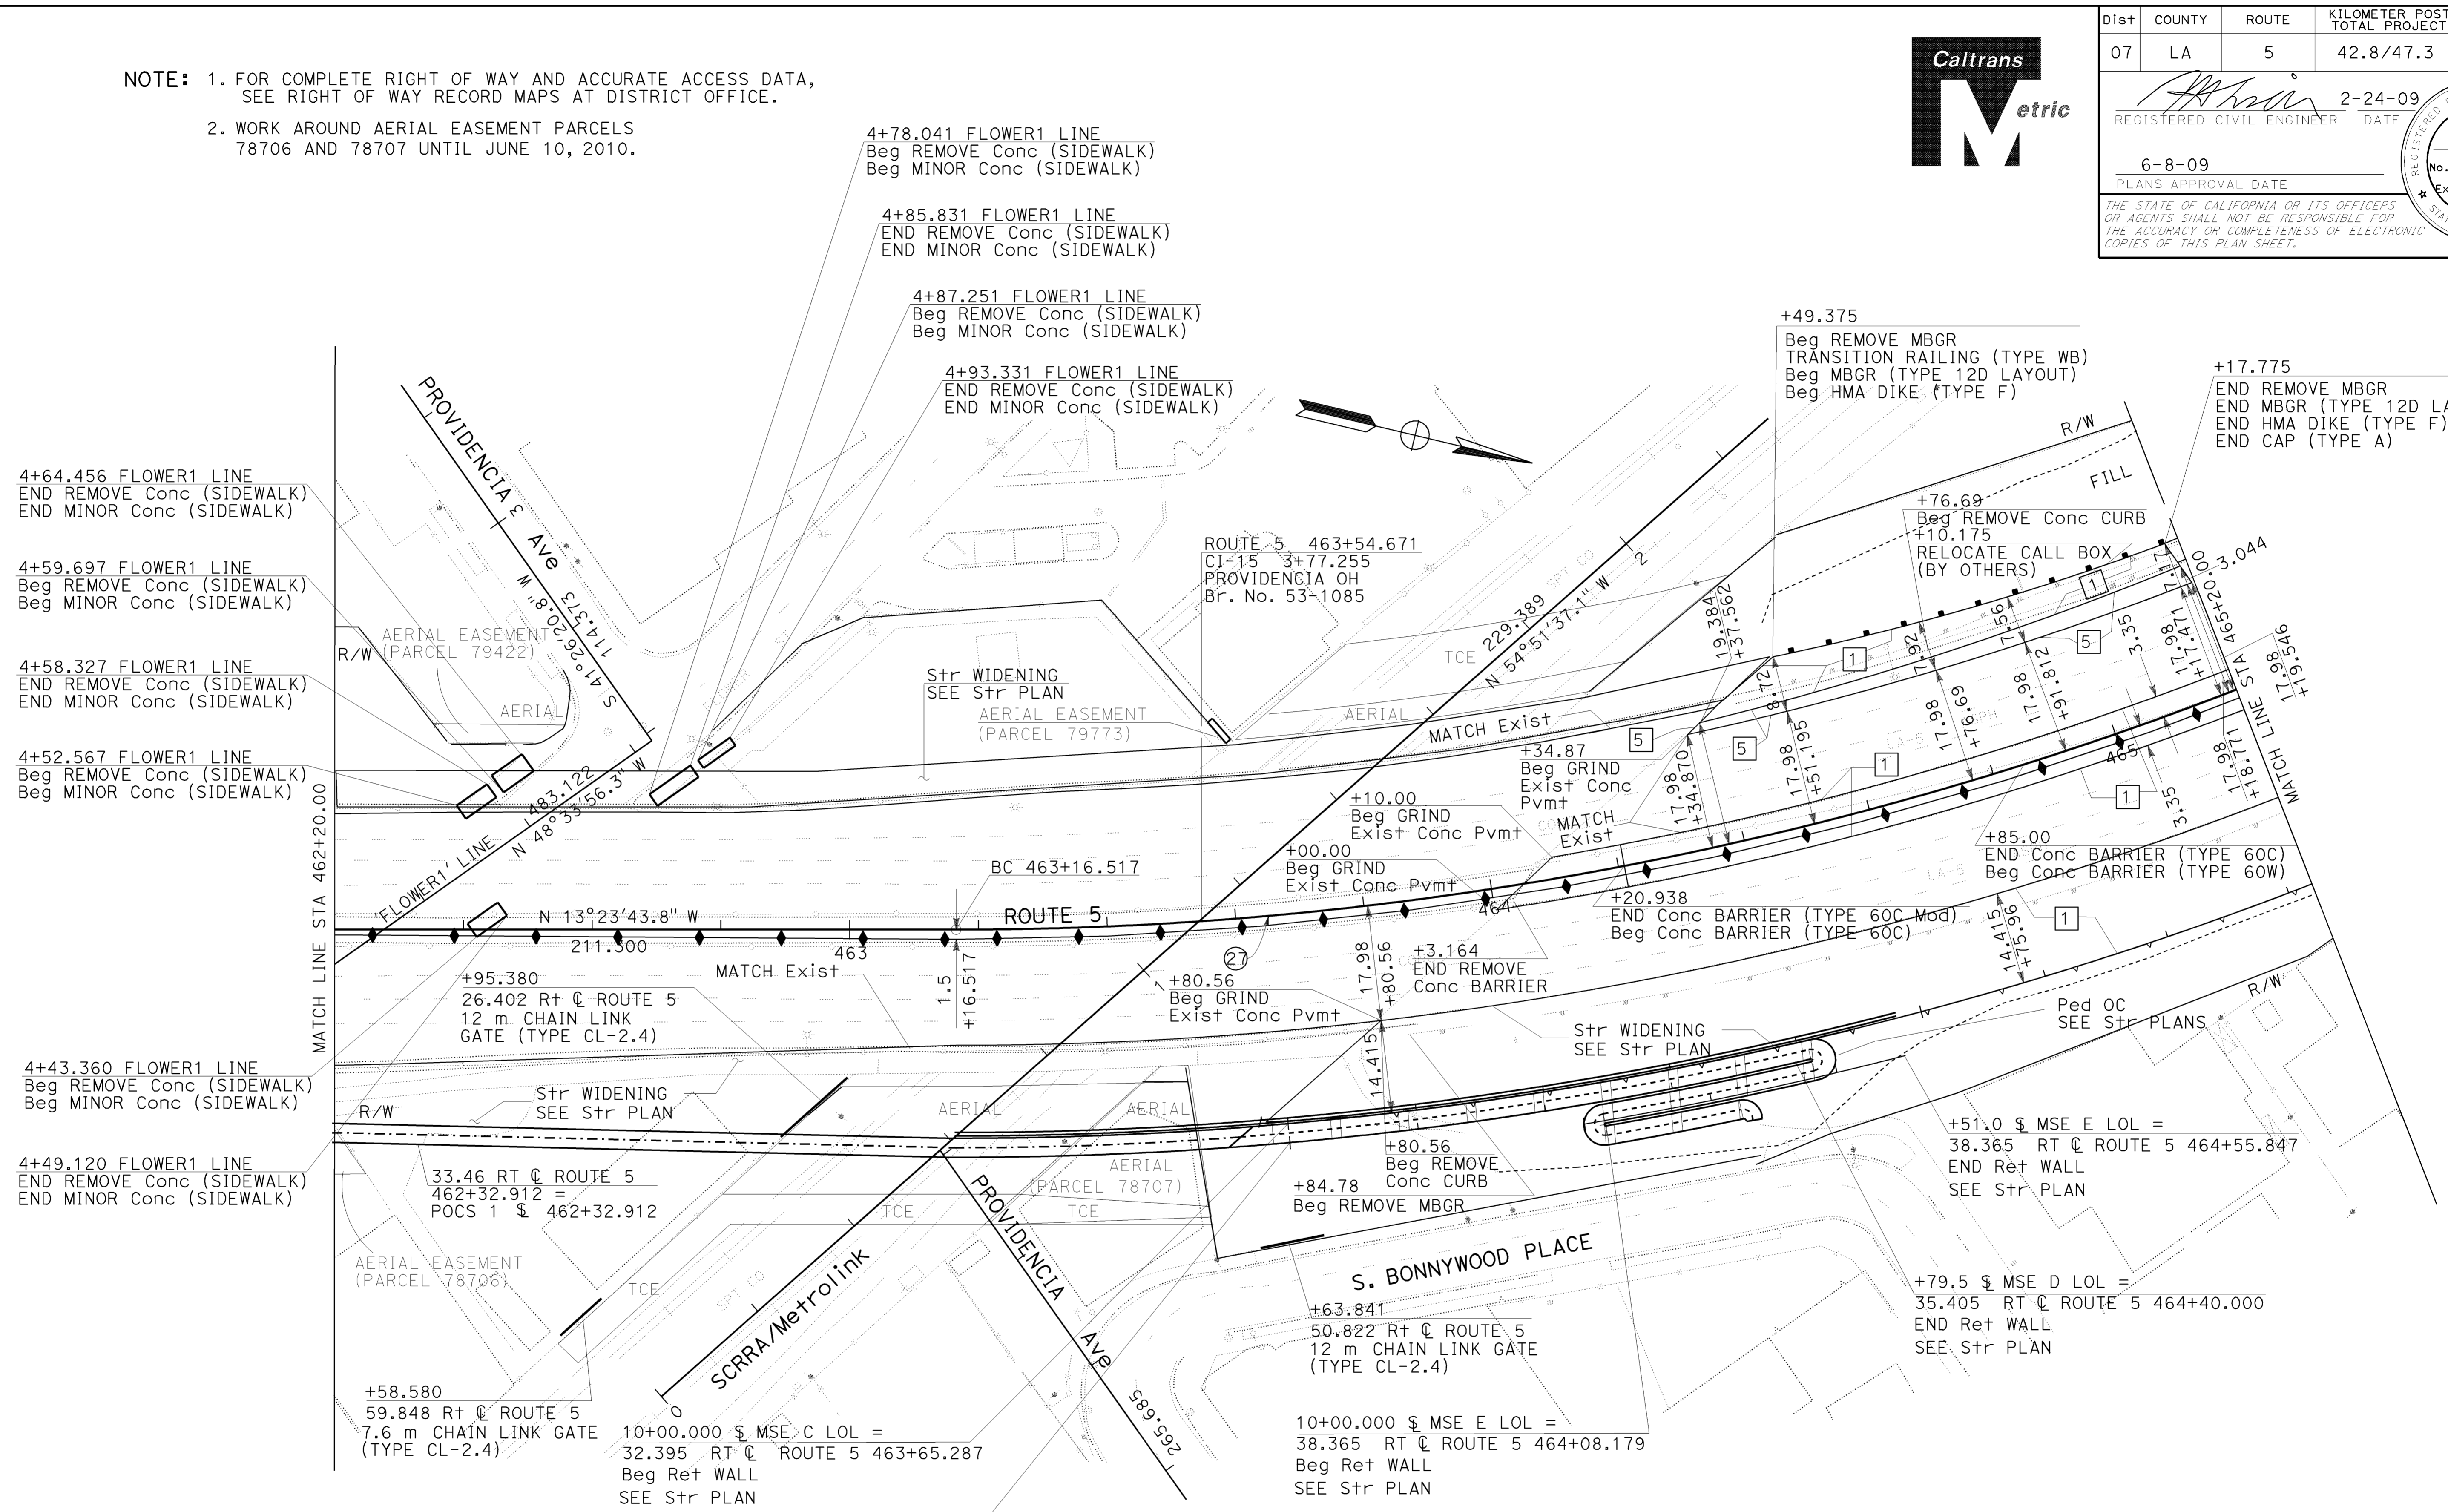

CURVE DATA				
NO	R	Δ	T	L
27	548.64	38°52'0"	193.57	372.17

10+00.000 § MSE C LOL =
32.395 RT @ ROUTE 5 463+65.287
Beg Ret WALL
SEE Str PLAN

10+00.000 § MSE D LOL =
35.405 RT @ ROUTE 5 463+65.341
Beg Ret WALL
SEE Str PLAN

+51.0 § MSE E LOL =
38.365 RT @ ROUTE 5 464+55.847
END Ret WALL
SEE Str PLAN

+79.5 § MSE D LOL =
35.405 RT @ ROUTE 5 464+40.000
END Ret WALL
SEE Str PLAN

ALL DIMENSIONS ARE IN METERS
UNLESS OTHERWISE SHOWN

LAYOUT
SCALE 1:500
L-12

NOTE: 1. FOR COMPLETE RIGHT OF WAY AND ACCURATE ACCESS DATA, SEE RIGHT OF WAY RECORD MAPS AT DISTRICT OFFICE.




Dist	COUNTY	ROUTE	KILOMETER POST TOTAL PROJECT	SHEET No.	TOTAL SHEETS
07	LA	5	42.8/47.3	21	1073

2-24-09
 REGISTERED CIVIL ENGINEER DATE
 6-8-09
 PLANS APPROVAL DATE

MUNSHI MOHSIN
 No. 61916
 Exp. 9/30/09
 CIVIL

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STATE OF CALIFORNIA - DEPARTMENT OF TRANSPORTATION
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 FUNCTIONAL SUPERVISOR
 CELINA AVILES
 DAWIT WORKU
 MUNSHI MOHSIN
 REVISED BY
 MM
 12/08
 DP
 04/09

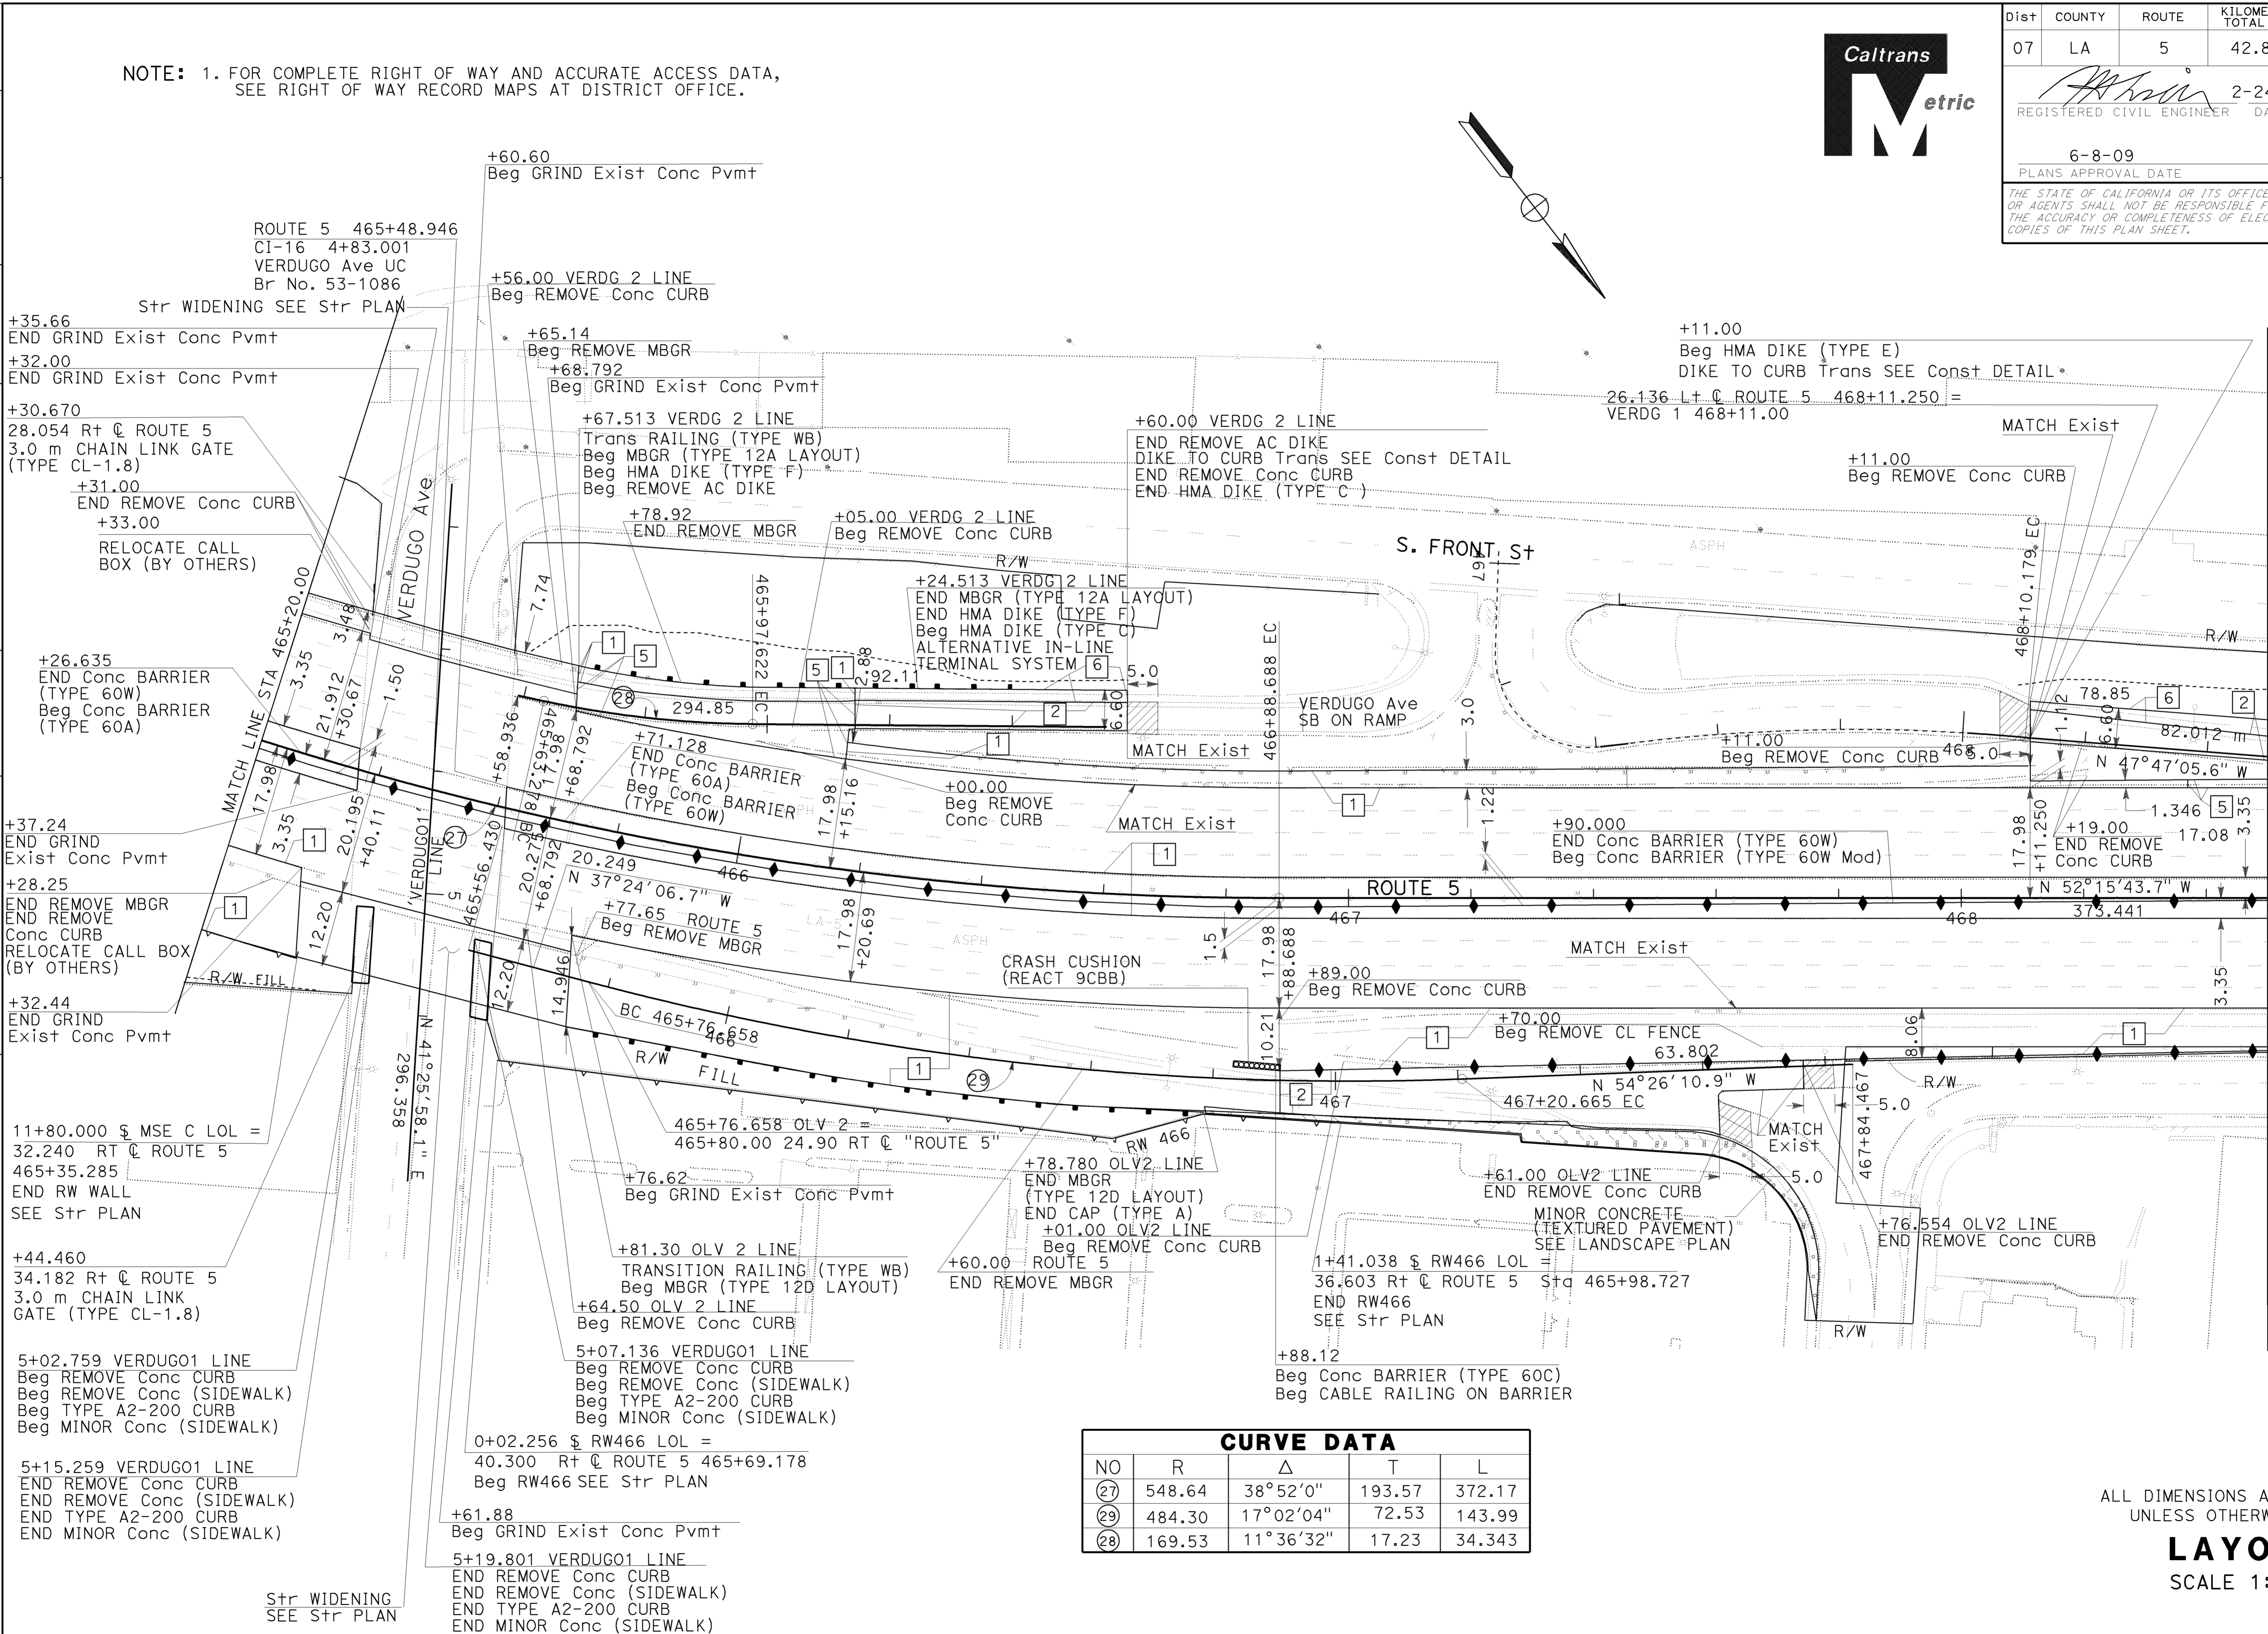

NO	R	Δ	T	L
27	548.64	38°52'0"	193.57	372.17
28	484.30	17°02'04"	72.53	143.99
29	169.53	11°36'32"	17.23	34.343

ALL DIMENSIONS ARE IN METERS UNLESS OTHERWISE SHOWN

LAYOUT
 SCALE 1:500
L-13

NOTE: 1. FOR COMPLETE RIGHT OF WAY AND ACCURATE ACCESS DATA, SEE RIGHT OF WAY RECORD MAPS AT DISTRICT OFFICE.



Dist	COUNTY	ROUTE	KILOMETER POST TOTAL PROJECT	SHEET No.	TOTAL SHEETS
07	LA	5	42.8/47.3	22	1073


2-24-09
REGISTERED CIVIL ENGINEER DATE

6-8-09
PLANS APPROVAL DATE

MUNSHI MOHSIN
No. 61916
Exp. 9/30/09
CIVIL
STATE OF CALIFORNIA

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STATE OF CALIFORNIA - DEPARTMENT OF TRANSPORTATION
Office of Design
CELINA AVILES
DAWIT WORKU
MUNSHI MOHSIN
KDP
12/08
MM
11/08

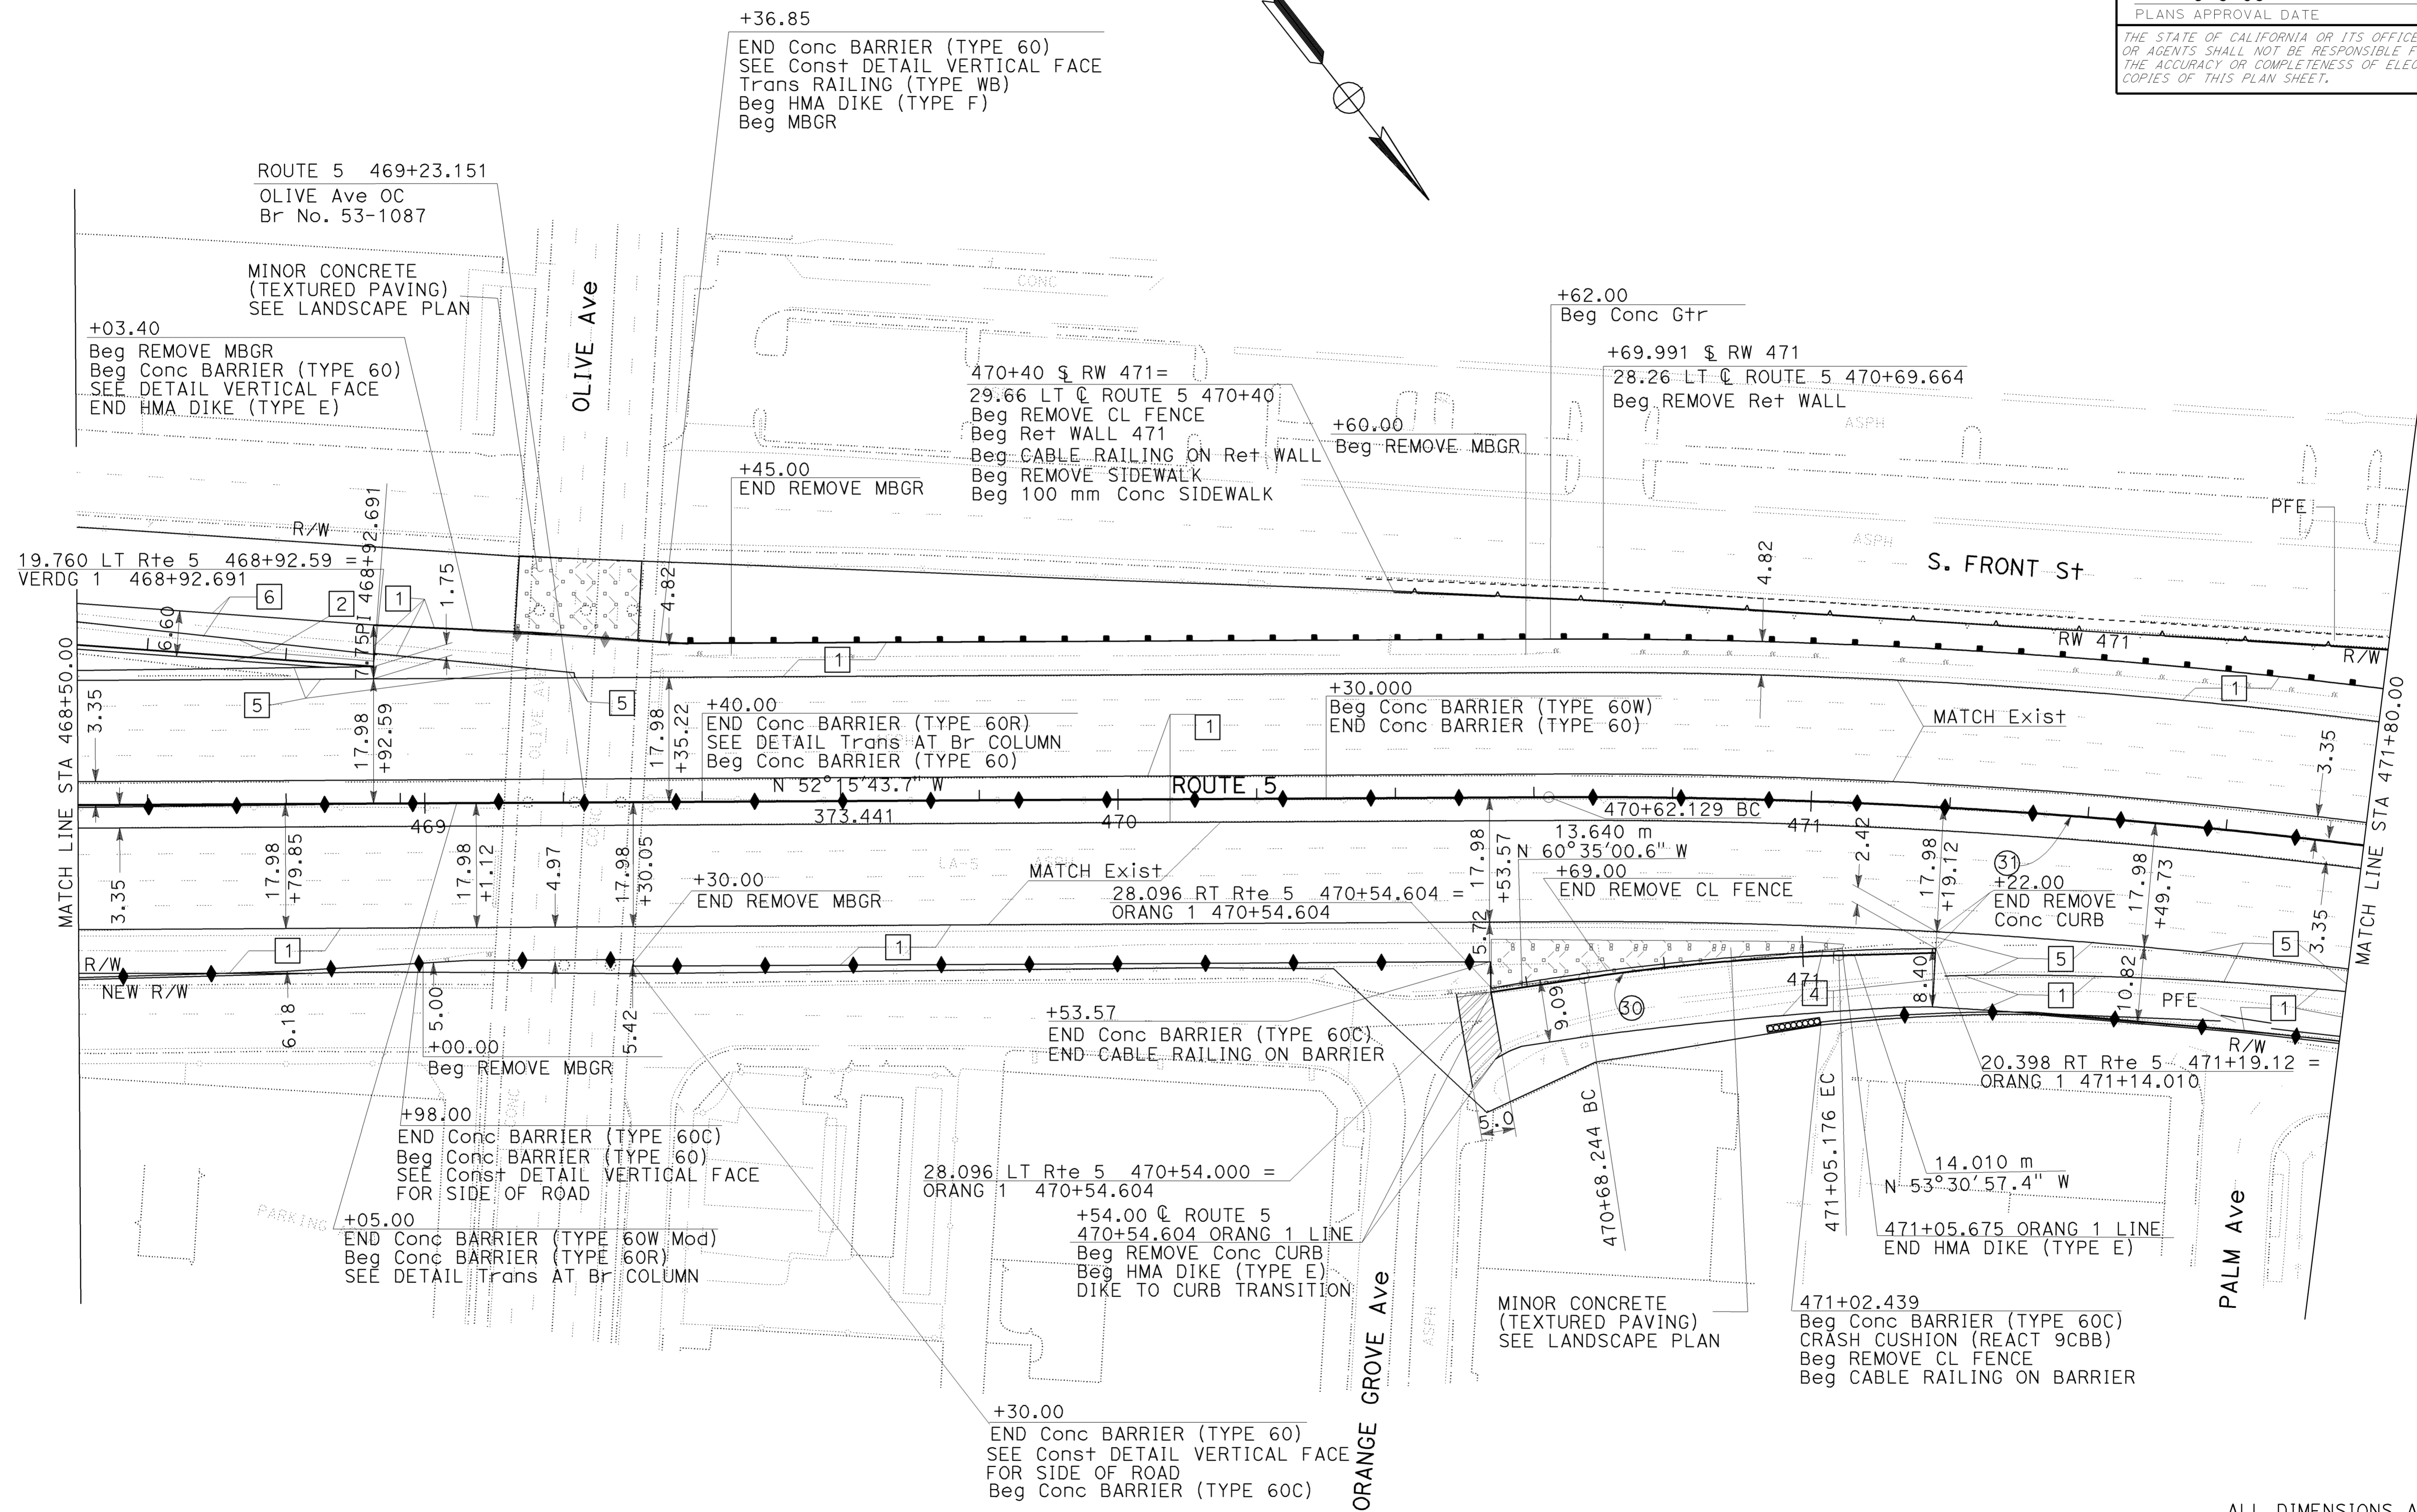


CURVE DATA				
NO	R	Δ	T	L
30	299.39	7°4'04"	18.49	36.93
31	914.40	24°0'47"	194.47	383.23

ALL DIMENSIONS ARE IN METERS
UNLESS OTHERWISE SHOWN

LAYOUT
SCALE 1:500
L-14

NOTE: 1. FOR COMPLETE RIGHT OF WAY AND ACCURATE ACCESS DATA,
SEE RIGHT OF WAY RECORD MAPS AT DISTRICT OFFICE.

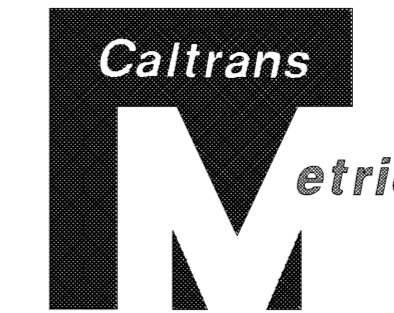


Dist	COUNTY	ROUTE	KILOMETER POST TOTAL PROJECT	SHEET No.	TOTAL SHEETS
07	LA	5	42.8/47.3	23	1073

2-24-09
 REGISTERED CIVIL ENGINEER DATE
 6-8-09
 PLANS APPROVAL DATE

REGISTERED PROFESSIONAL ENGINEER
 MUNSHI MOHSIN
 No. 61916
 Exp. 9/30/09
 CIVIL
 STATE OF CALIFORNIA

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STATE OF CALIFORNIA - DEPARTMENT OF TRANSPORTATION
Caltrans OFFICE OF DESIGN
 FUNCTIONAL SUPERVISOR
 CELINA AVILES
 CALCULATED/DESIGNED BY
 CHECKED BY
 DAWIT WORKU
 MUNSHI MOHSIN
 REVISOR BY
 DATE REVISED
 SA
 01/08
 MM
 12/08

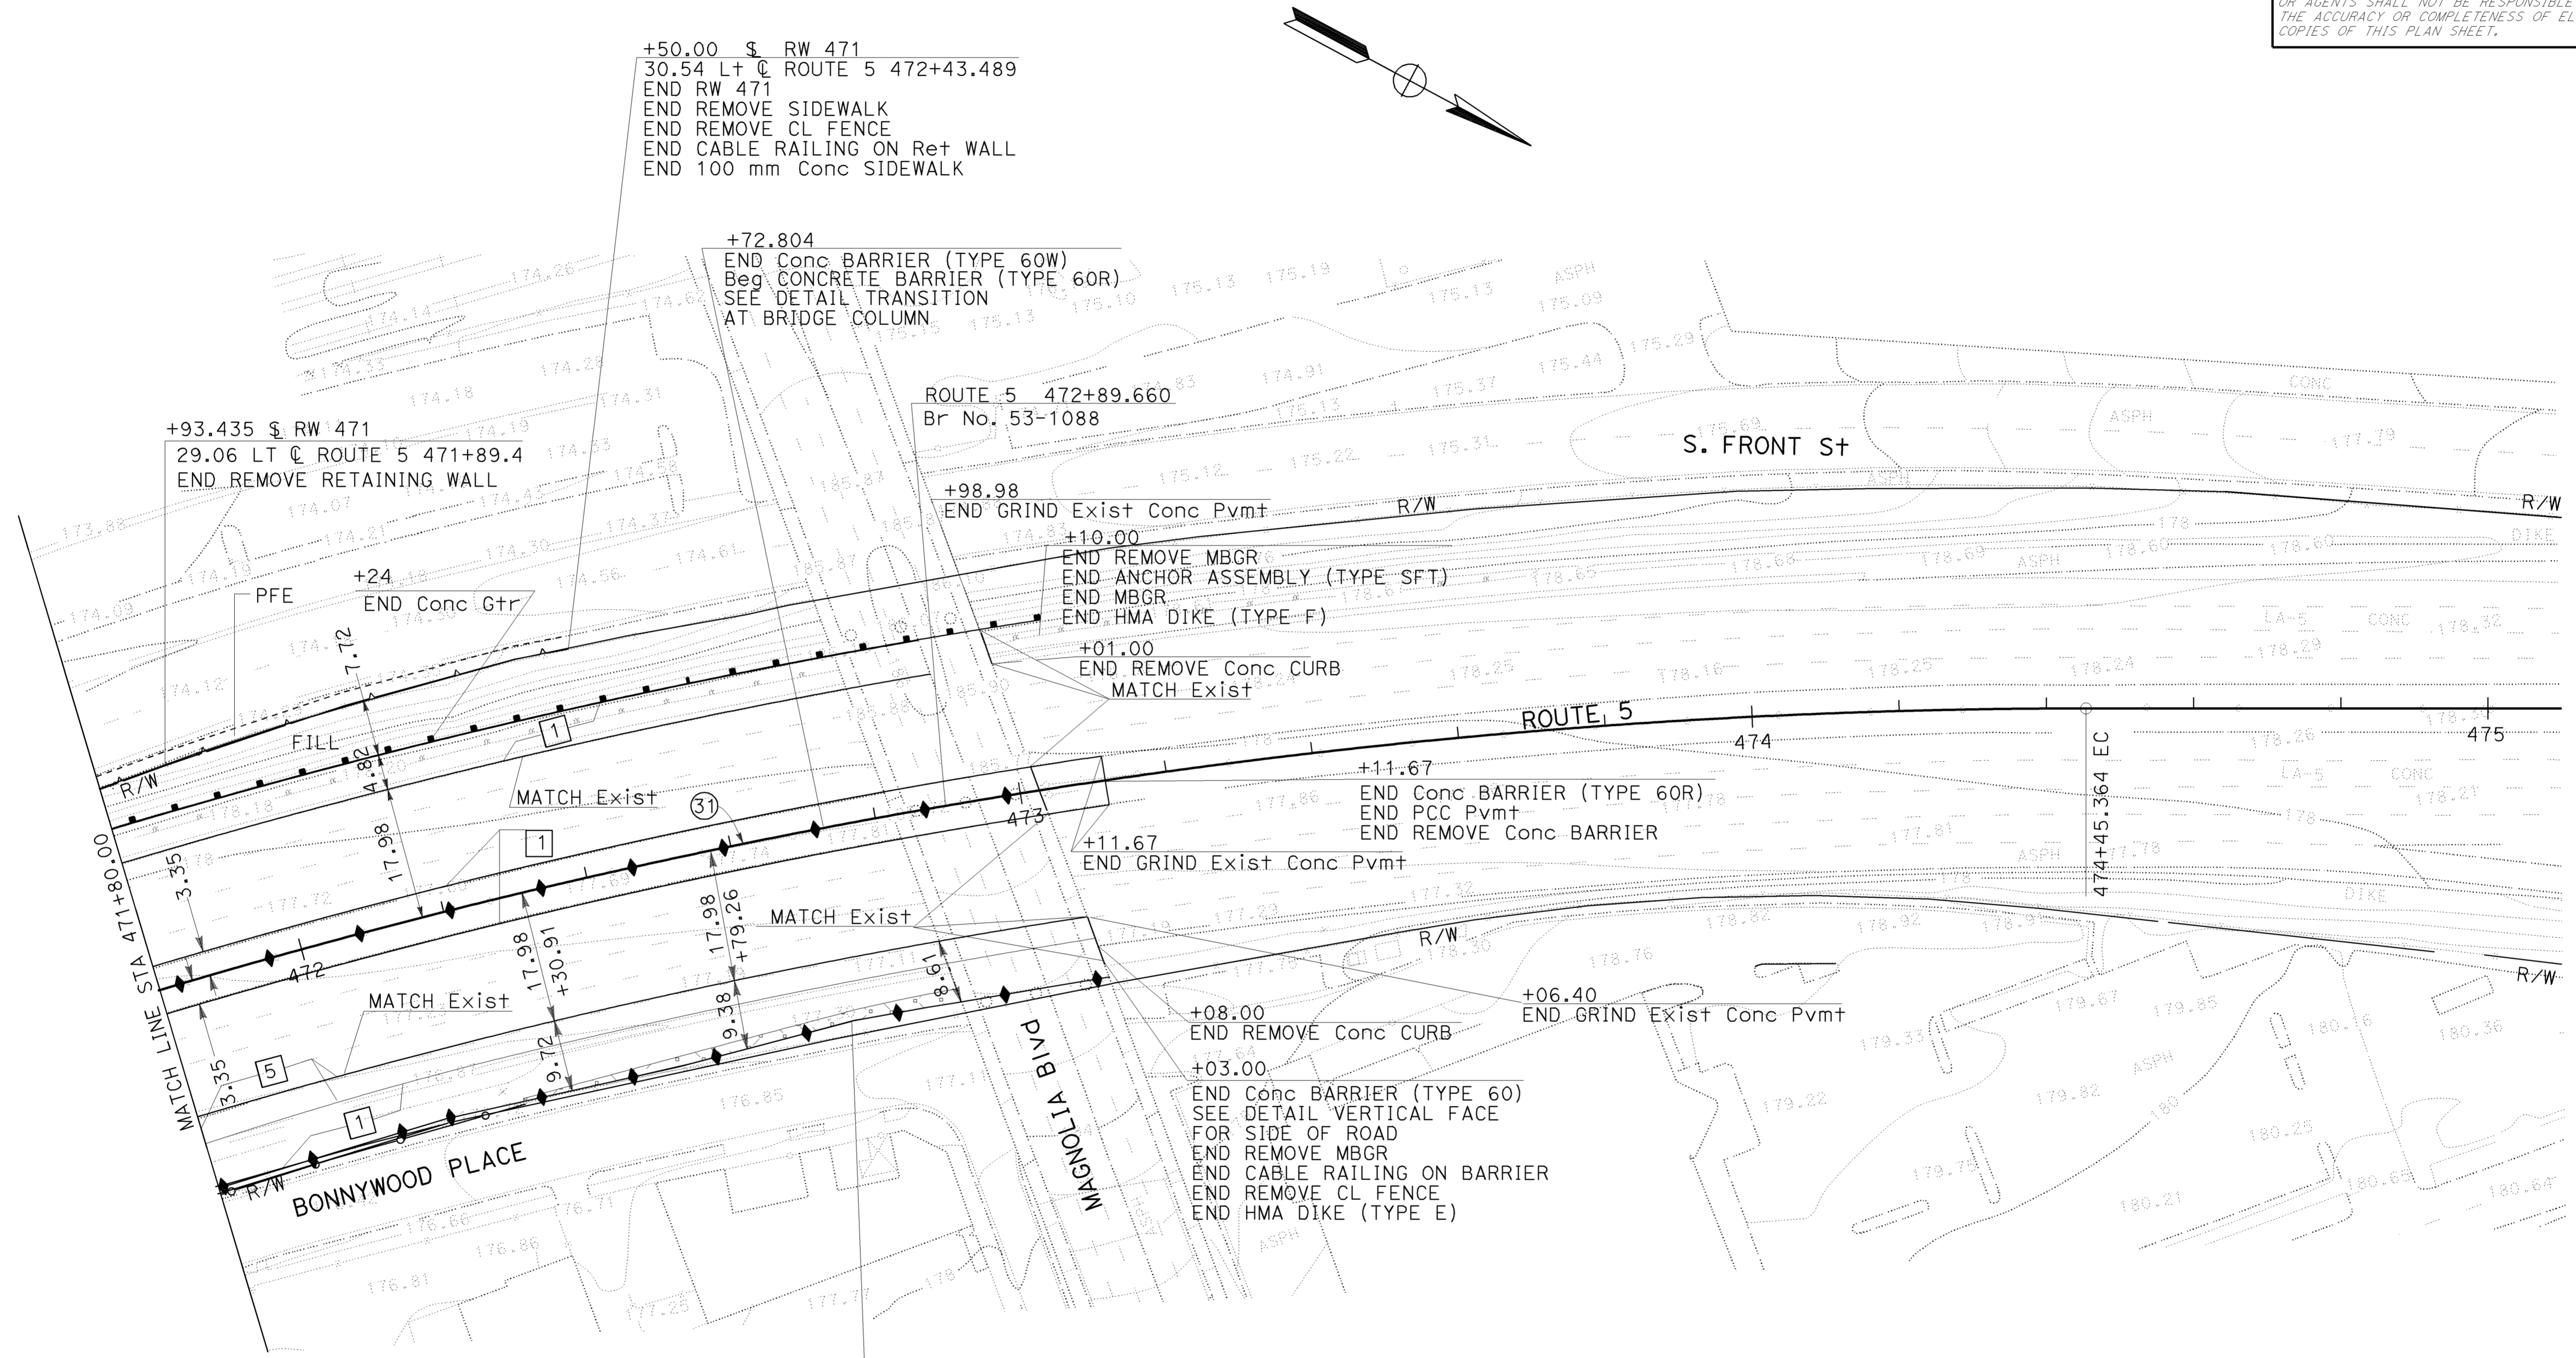


CURVE DATA				
NO	R	Δ	T	L
(31)	914.40	24°0'47"	194.47	383.23

ALL DIMENSIONS ARE IN METERS
UNLESS OTHERWISE SHOWN

LAYOUT
SCALE 1:500

L-15

FUNCTIONAL SUPERVISOR	CELINA AVILES
DESIGNED BY	
CHECKED BY	
DAWIT WORKU	MUNSHI MOSHIN
REVISOR	DW
DATE	12/2008

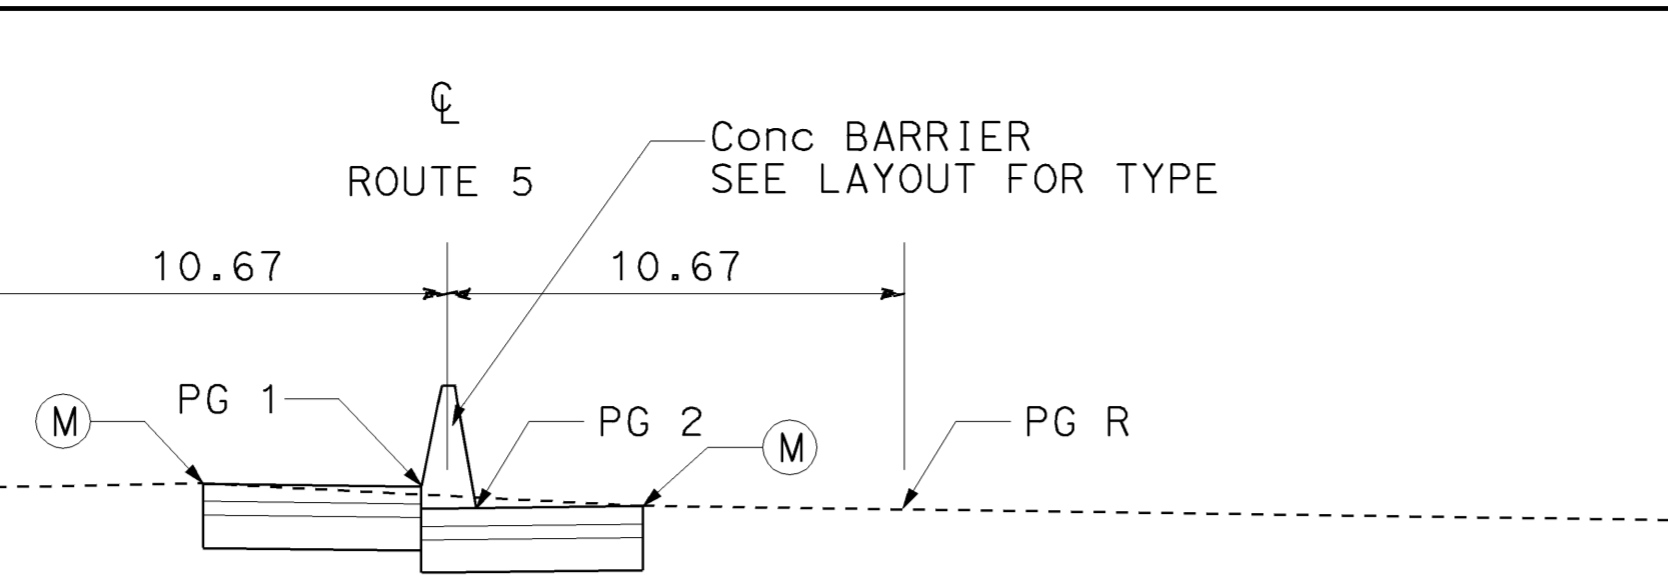

LEGEND:
 PG 1 : LEFT BOTTOM OF BARRIER
 PG 2 : RIGHT BOTTOM OF BARRIER
 PG L : 10.67 m LEFT OF CL ROUTE 5 (AXIS OF ROTATION)
 PG R : 10.67 m RIGHT OF CL ROUTE 5 (AXIS OF ROTATION)
 (M) : MATCH EXISTING PAVEMENT




Dist	COUNTY	ROUTE	KILOMETER POST TOTAL PROJECT	SHEET No.	TOTAL SHEETS
07	LA	5	42.8/47.3	24	1073


REGISTERED CIVIL ENGINEER DATE 2-24-09
 6-8-09 PLANS APPROVAL DATE

MUNSHI MOHSIN No. 61916 Exp. 9/30/09
 REGISTERED PROFESSIONAL ENGINEER STATE OF CALIFORNIA CIVIL

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ALL DIMENSIONS ARE IN METERS UNLESS OTHERWISE SHOWN
PROFILE
 SCALE: Horiz 1:500
 Vert 1:100
P-1

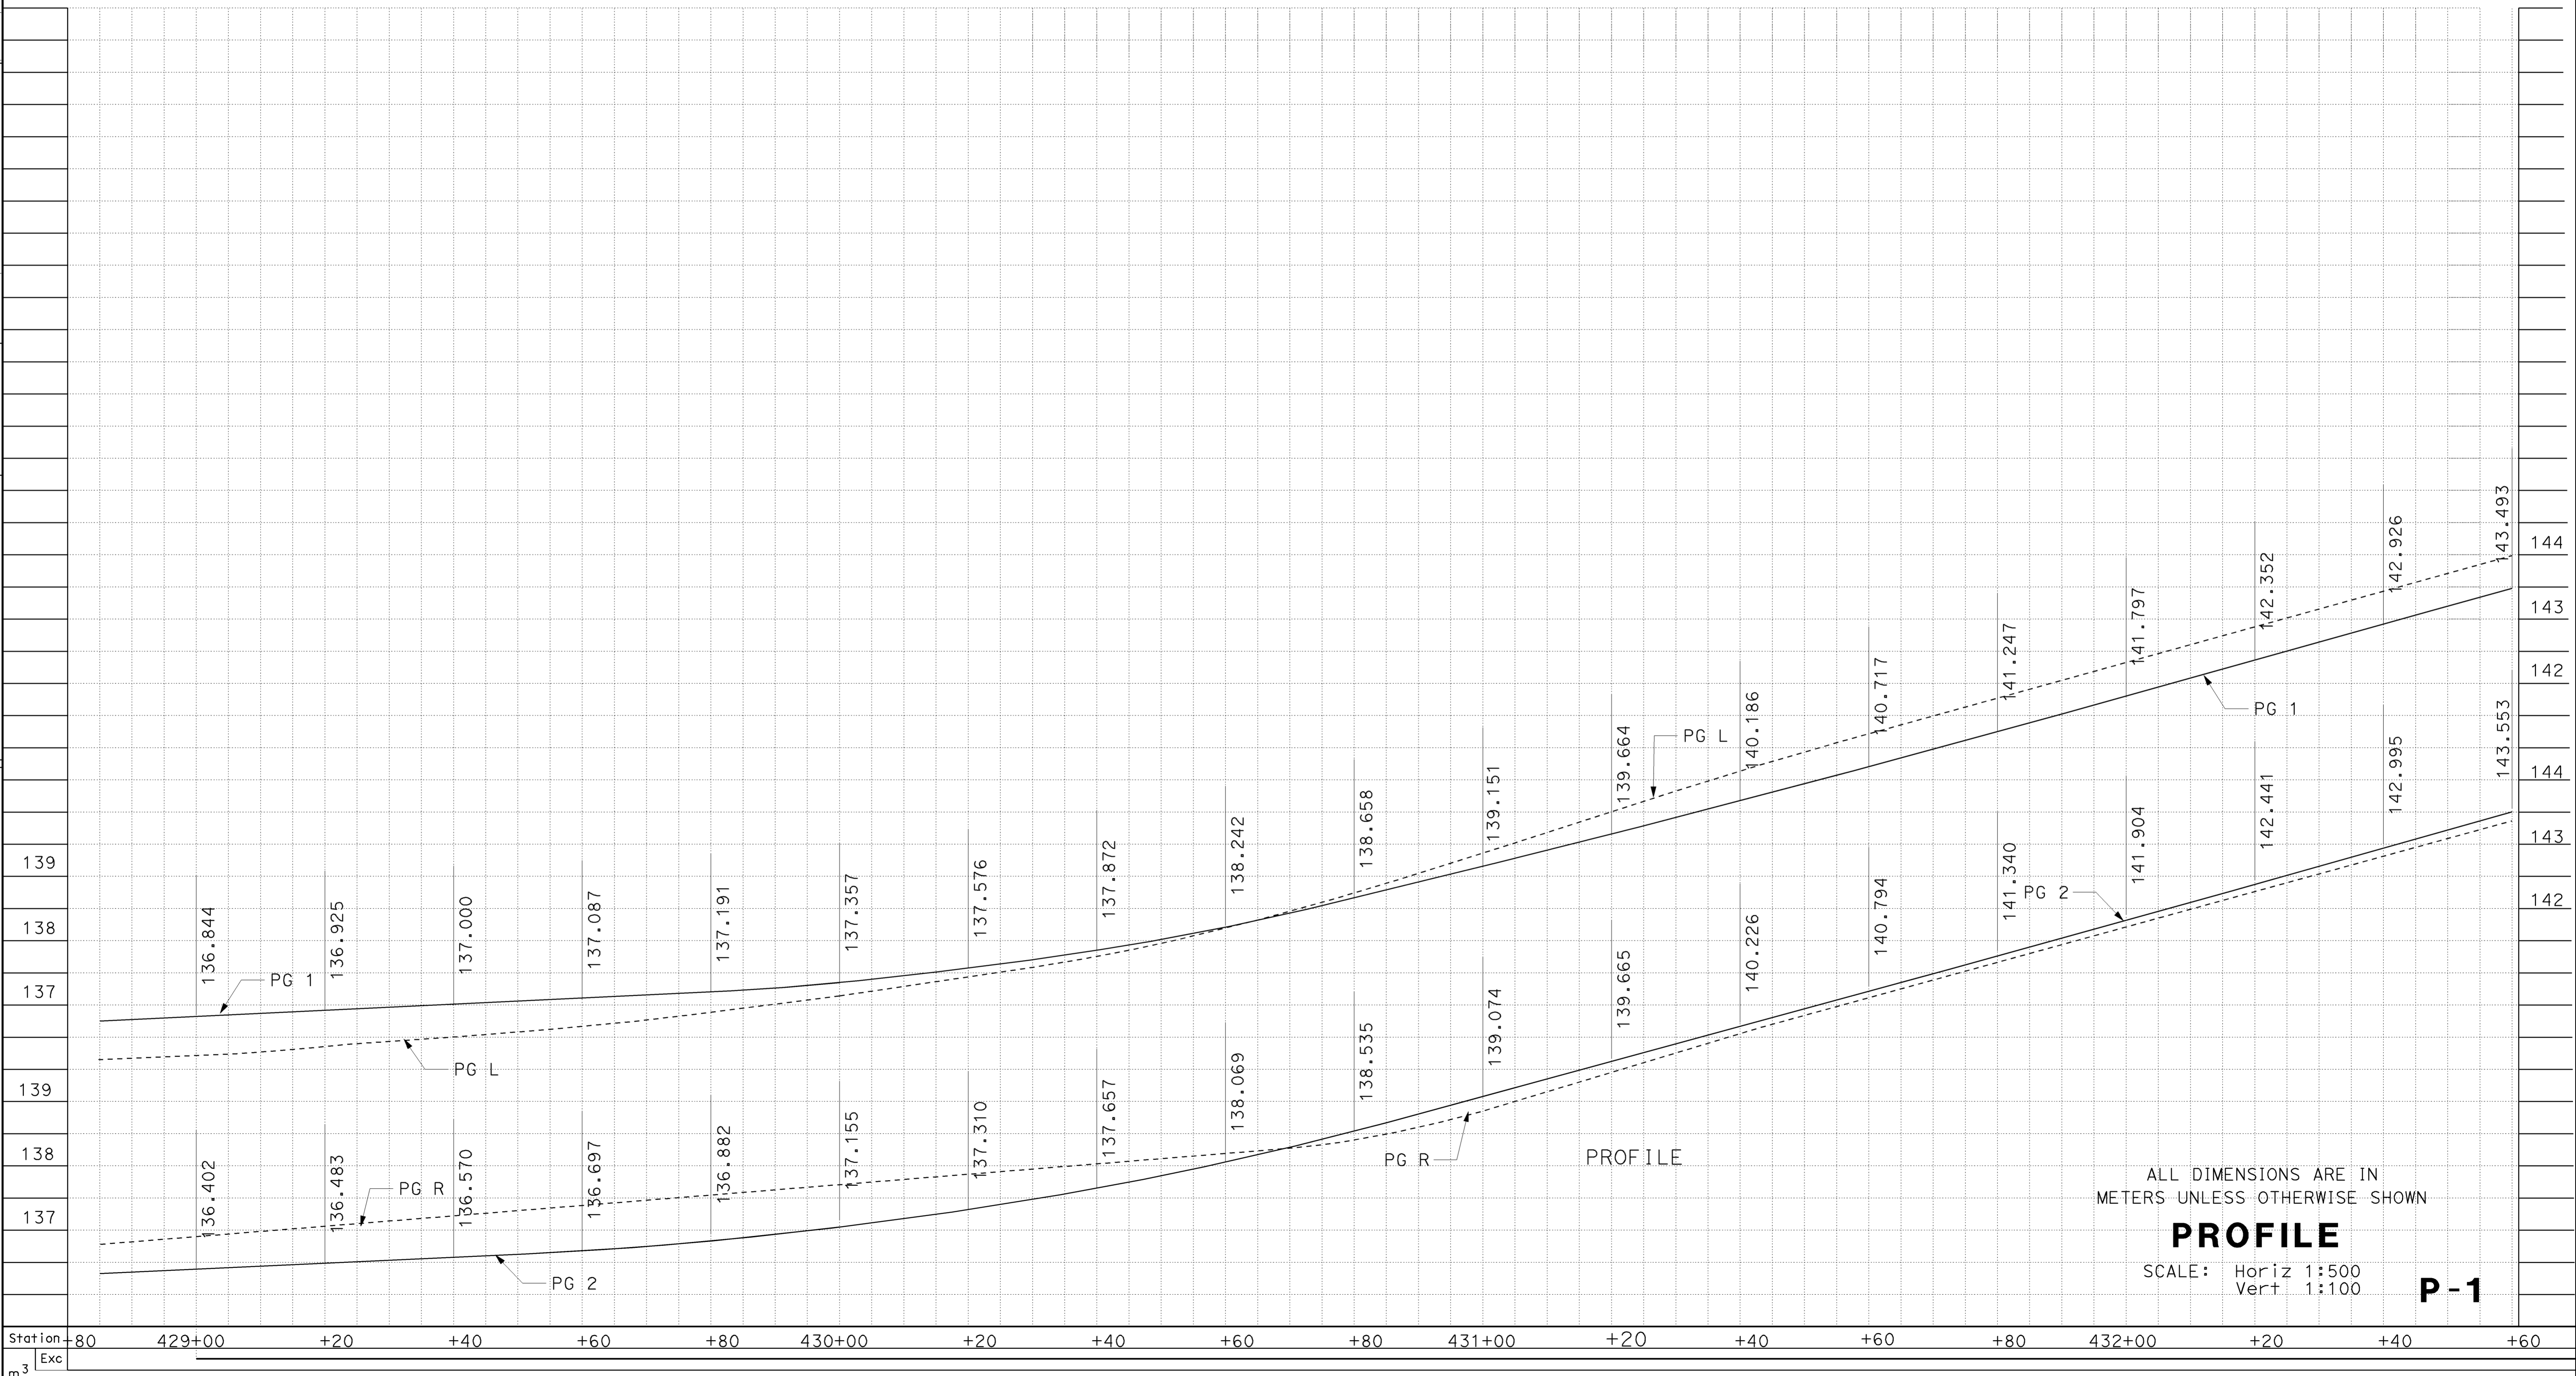


Dist	COUNTY	ROUTE	KILOMETER POST TOTAL PROJECT	SHEET No.	TOTAL SHEETS
07	LA	5	42.8/47.3	25	1073

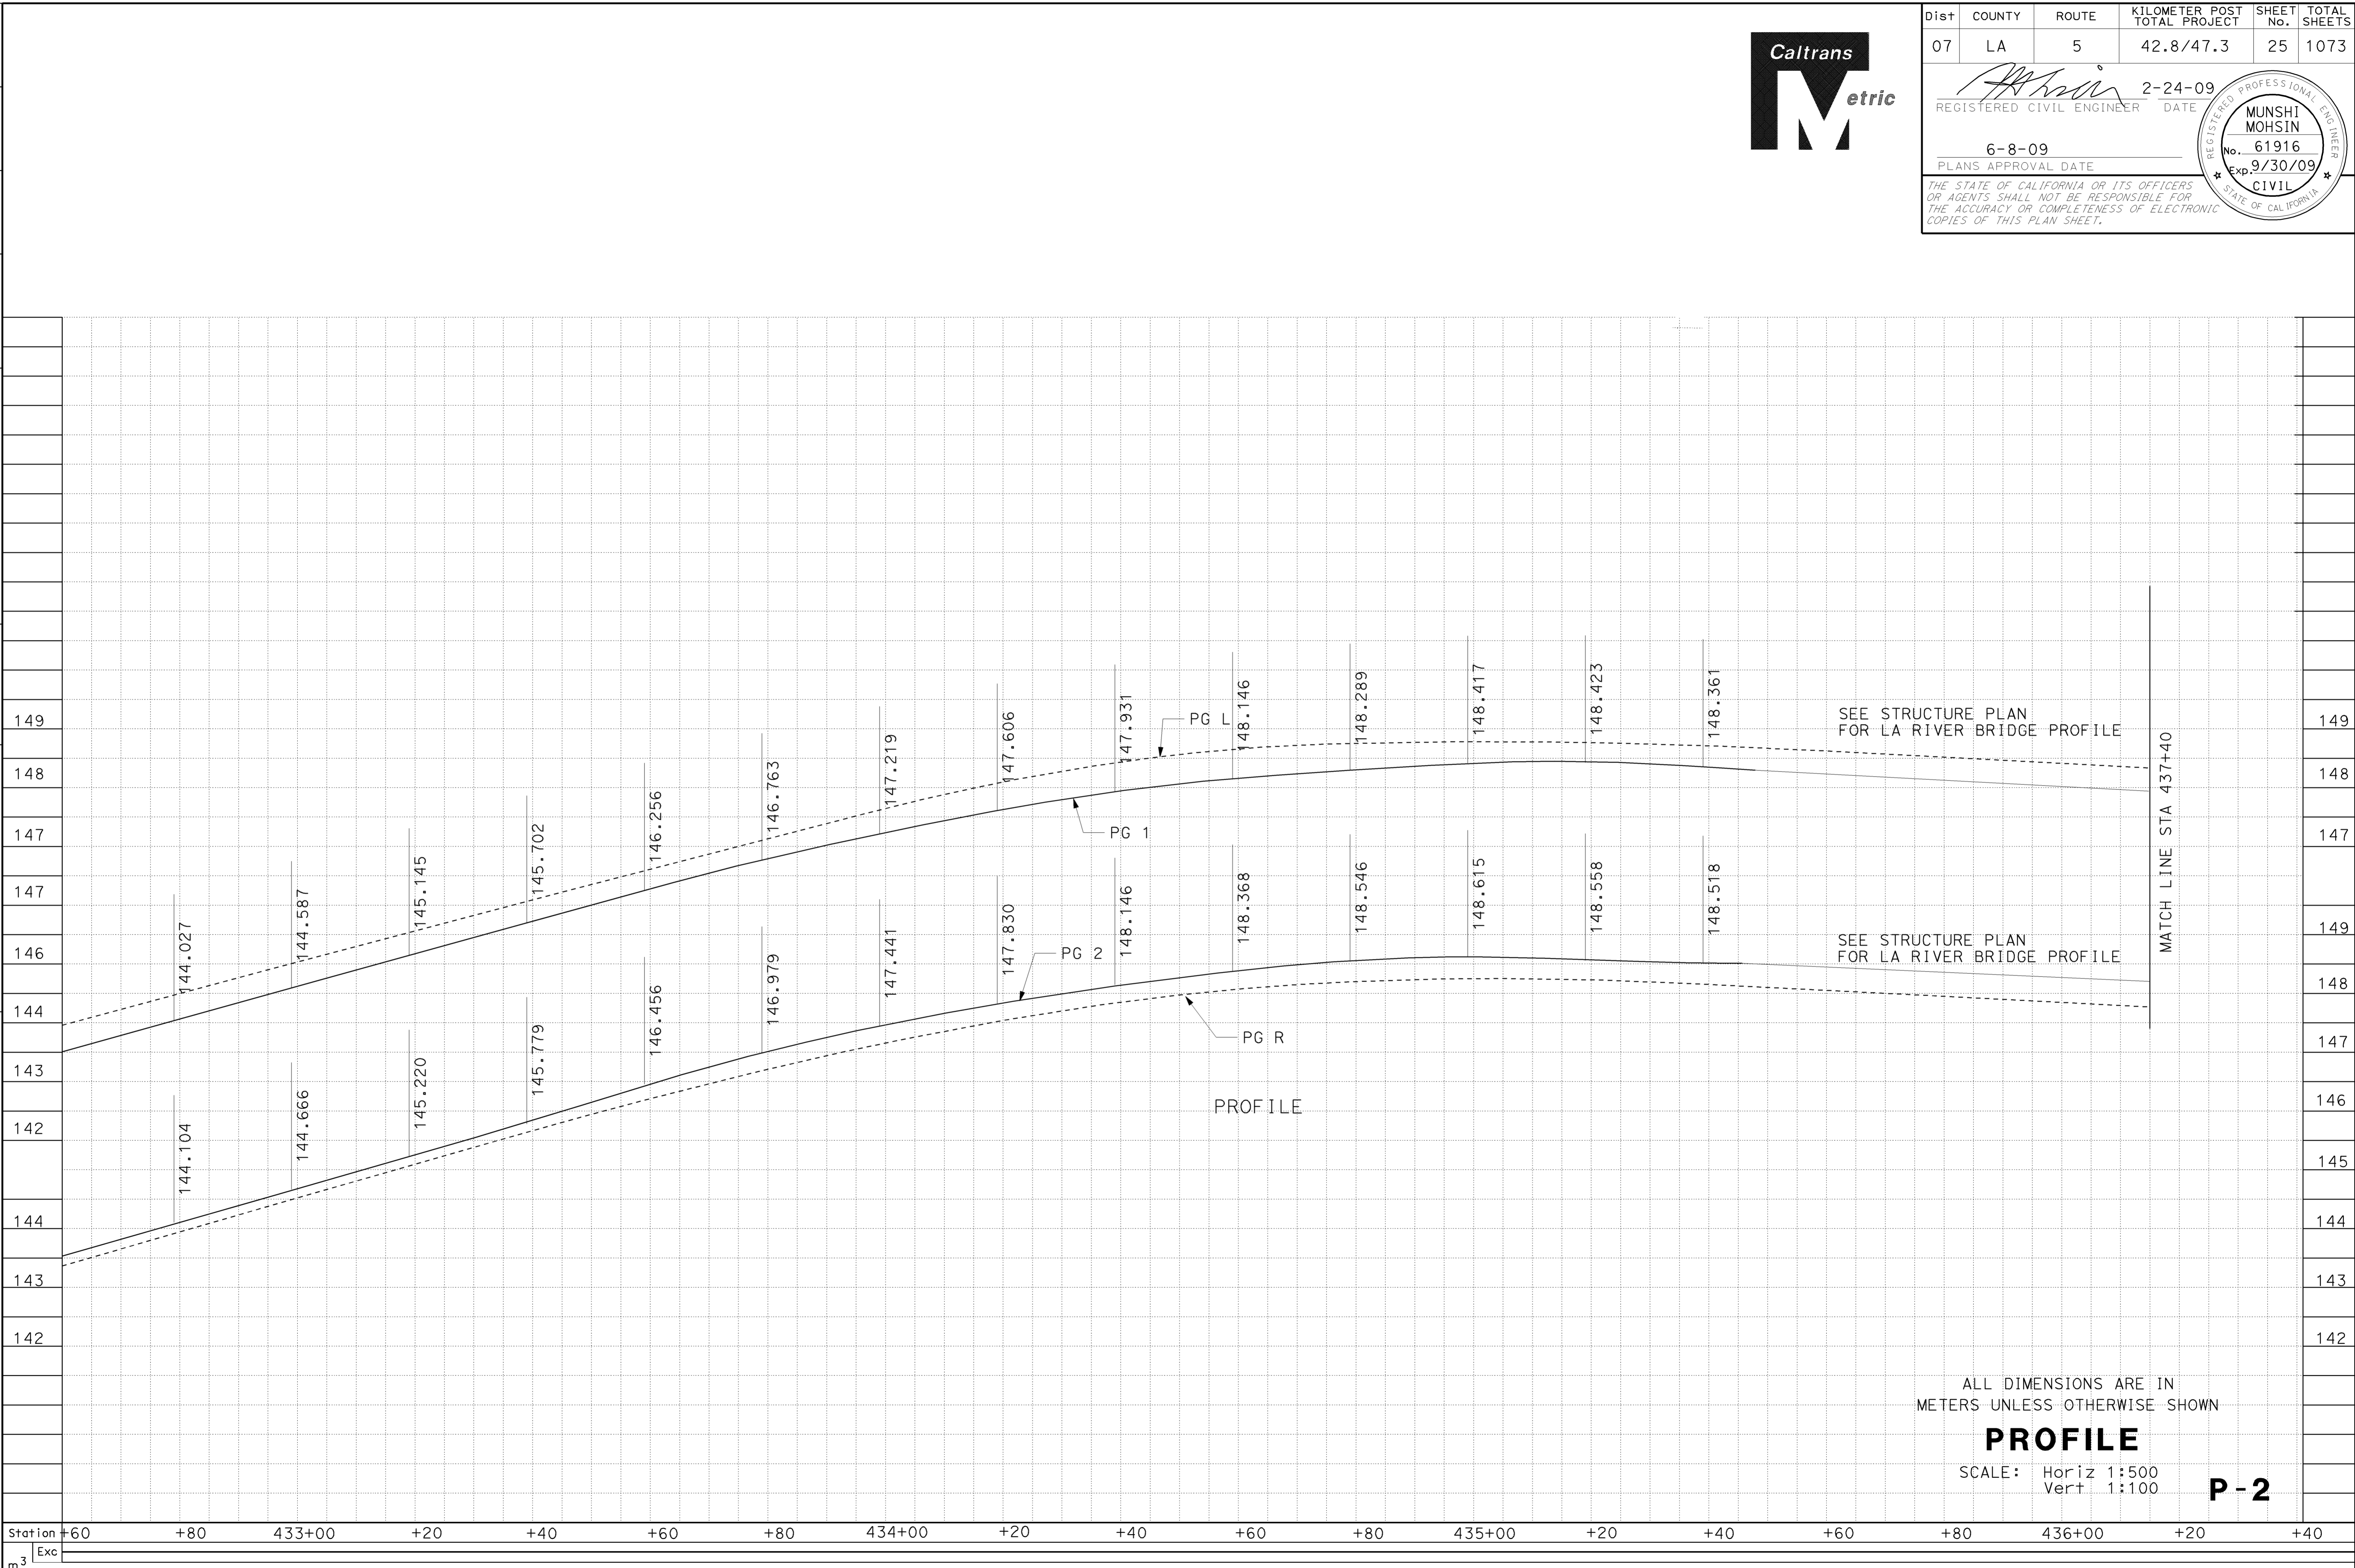REGISTERED CIVIL ENGINEER DATE 2-24-09
 PLANS APPROVAL DATE 6-8-09
 REGISTERED PROFESSIONAL ENGINEER
 MUNSHI MOHSIN
 No. 61916
 Exp. 9/30/09
 CIVIL
 STATE OF CALIFORNIA
THE STATE OF CALIFORNIA OR ITS OFFICERS OR AGENTS SHALL NOT BE RESPONSIBLE FOR THE ACCURACY OR COMPLETENESS OF ELECTRONIC COPIES OF THIS PLAN SHEET.

STATE OF CALIFORNIA - DEPARTMENT OF TRANSPORTATION
Caltrans OFFICE OF DESIGN D
 FUNCTIONAL SUPERVISOR
 CELINA AVILES
 DAWIT WORKU
 MUNSHI MOSHIN
 DW
 12/2008
 REVISOR BY
 DATE REVISED


Dist	COUNTY	ROUTE	KILOMETER POST TOTAL PROJECT	SHEET No.	TOTAL SHEETS
07	LA	5	42.8/47.3	26	1073

REGISTERED CIVIL ENGINEER DATE 2-24-09
 6-8-09
 PLANS APPROVAL DATE
 THE STATE OF CALIFORNIA OR ITS OFFICERS OR AGENTS SHALL NOT BE RESPONSIBLE FOR THE ACCURACY OR COMPLETENESS OF ELECTRONIC COPIES OF THIS PLAN SHEET.

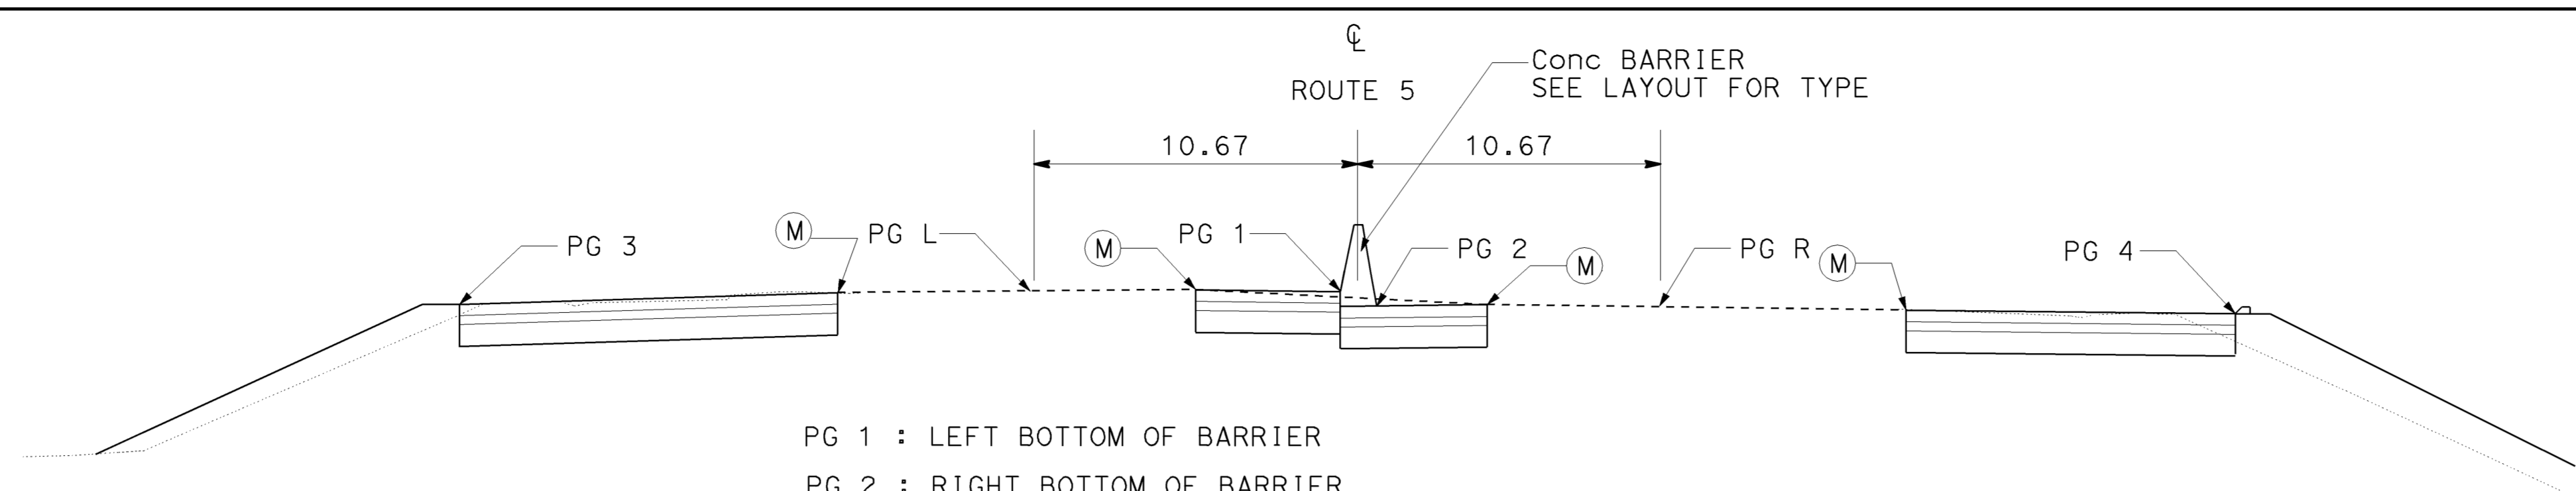

PG 1 : LEFT BOTTOM OF BARRIER
 PG 2 : RIGHT BOTTOM OF BARRIER
 PG 3 : LEFT PROPOSED OUTSIDE EDGE OF SHOULDER
 PG 4 : RIGHT PROPOSED OUTSIDE EDGE OF SHOULDER
 (M) : MATCH EXISTING PAVEMENT
 PG L : 10.67 m LEFT OF CL ROUTE 5 (AXIS OF ROTATION)
 PG R : 10.67 m RIGHT OF CL ROUTE 5 (AXIS OF ROTATION)

NOTE:
 FOR PG 3 AND PG 4 PROFILES NOT SHOWN
 SEE SOUND WALL PROFILE PLANS.

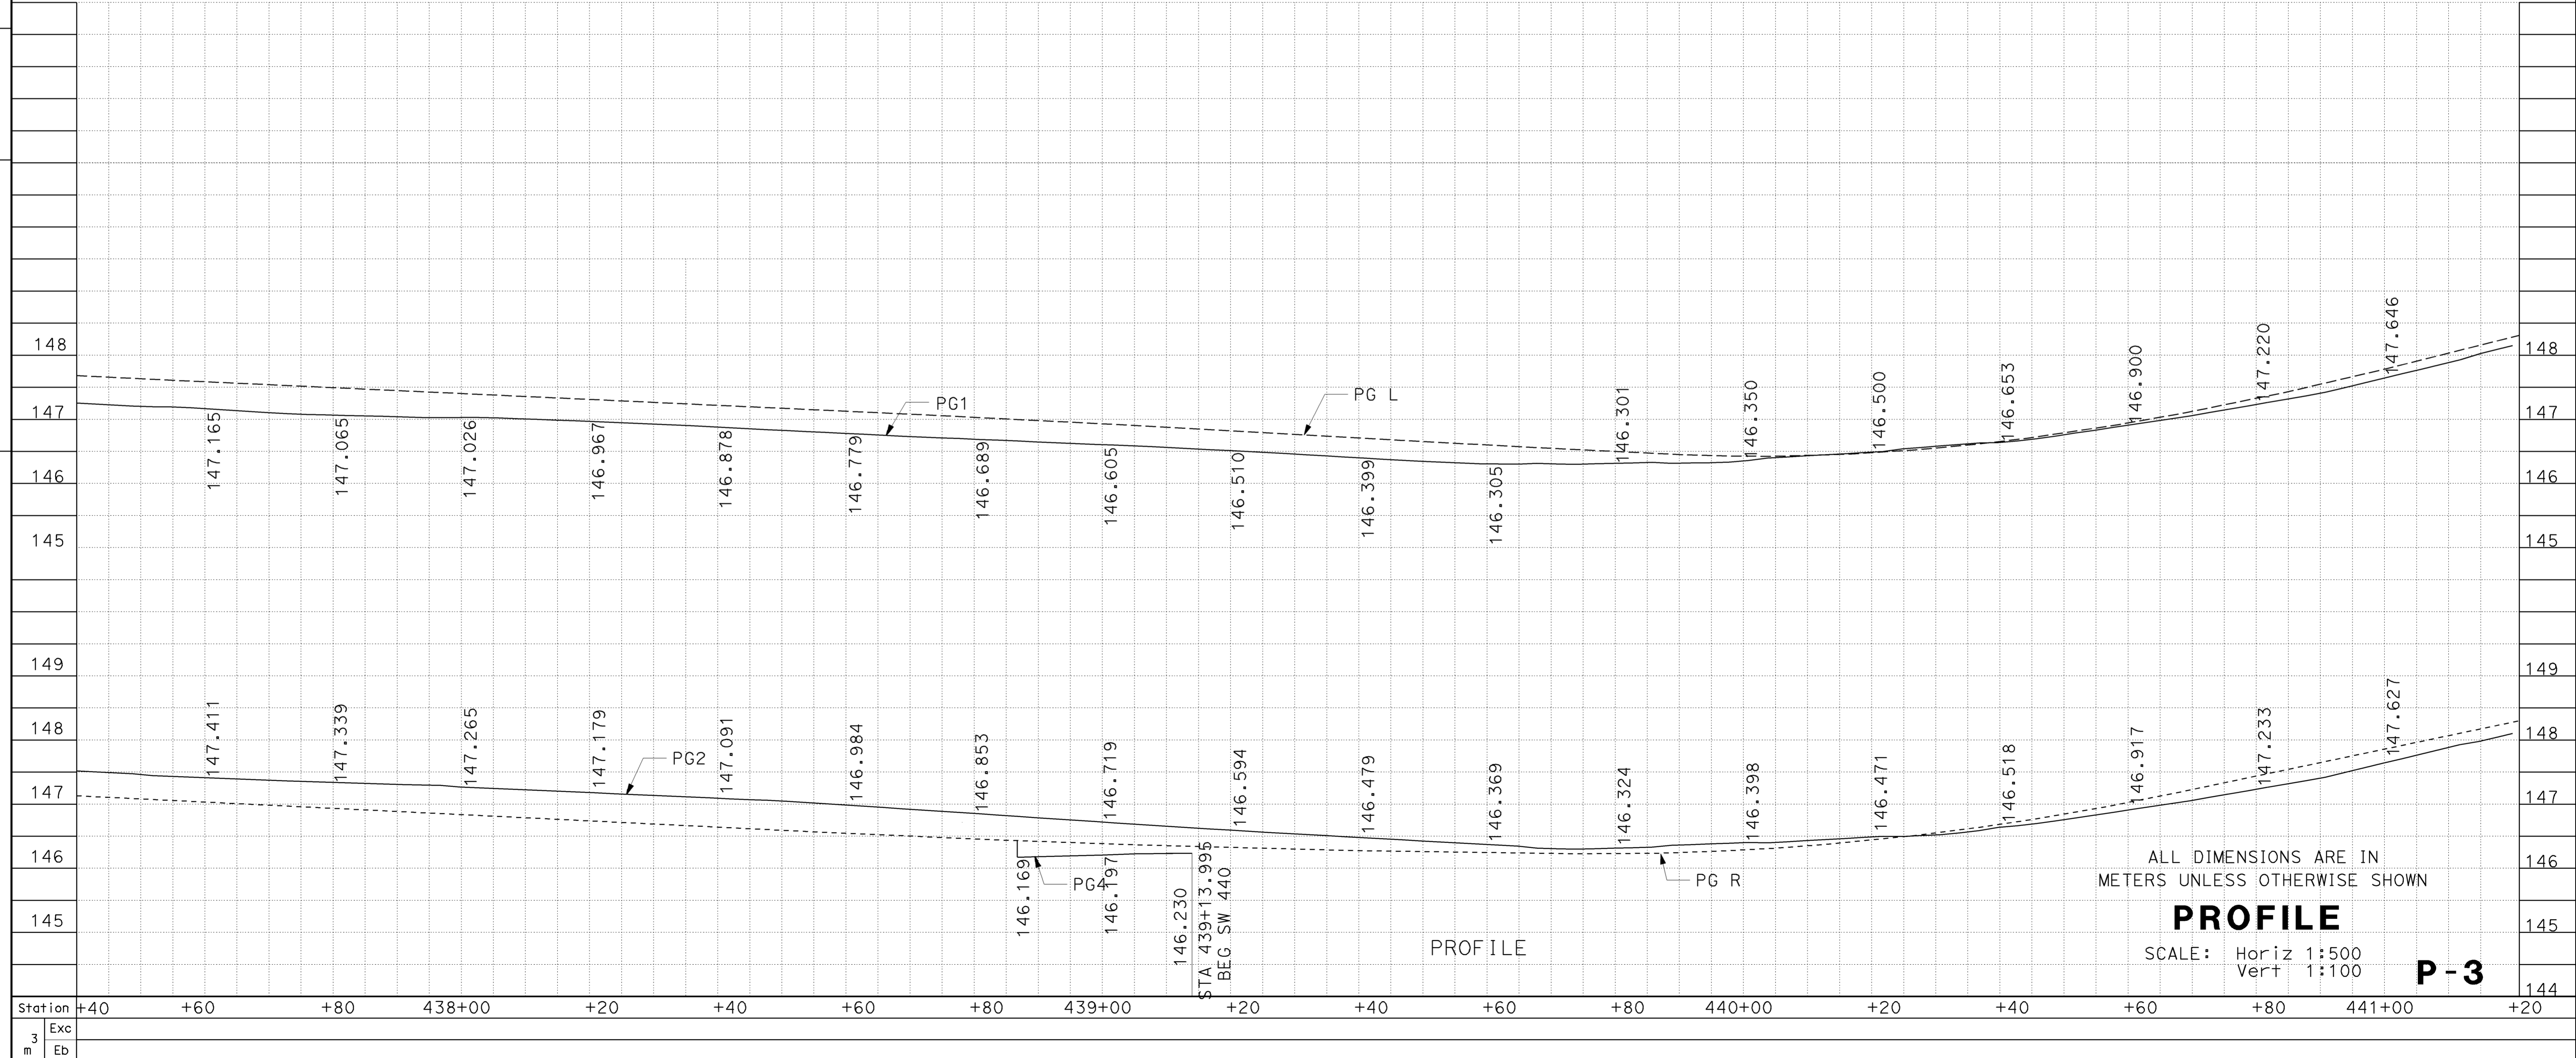


ALL DIMENSIONS ARE IN METERS UNLESS OTHERWISE SHOWN
PROFILE
 SCALE: Horiz 1:500
 Vert 1:100
P-3

x
x
STATE OF CALIFORNIA - DEPARTMENT OF TRANSPORTATION		FUNCTIONAL SUPERVISOR	CELINA AVILES
Caltrans OFFICE OF DESIGN D		CALCULATED-DESIGNED BY	
		CHECKED BY	
		DAWIT WORKU	MUNSHI MOSHIN
		REVISOR	DW
		DATE	12/2008




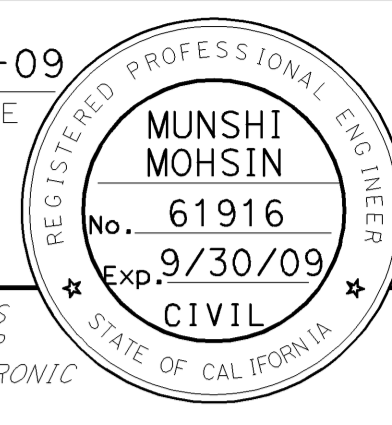
Dist	COUNTY	ROUTE	KILOMETER POST TOTAL PROJECT	SHEET No.	TOTAL SHEETS
07	LA	5	42.8/47.3	27	1073
			2-24-09	REGISTERED CIVIL ENGINEER DATE	
			6-8-09	PLANS APPROVAL DATE	
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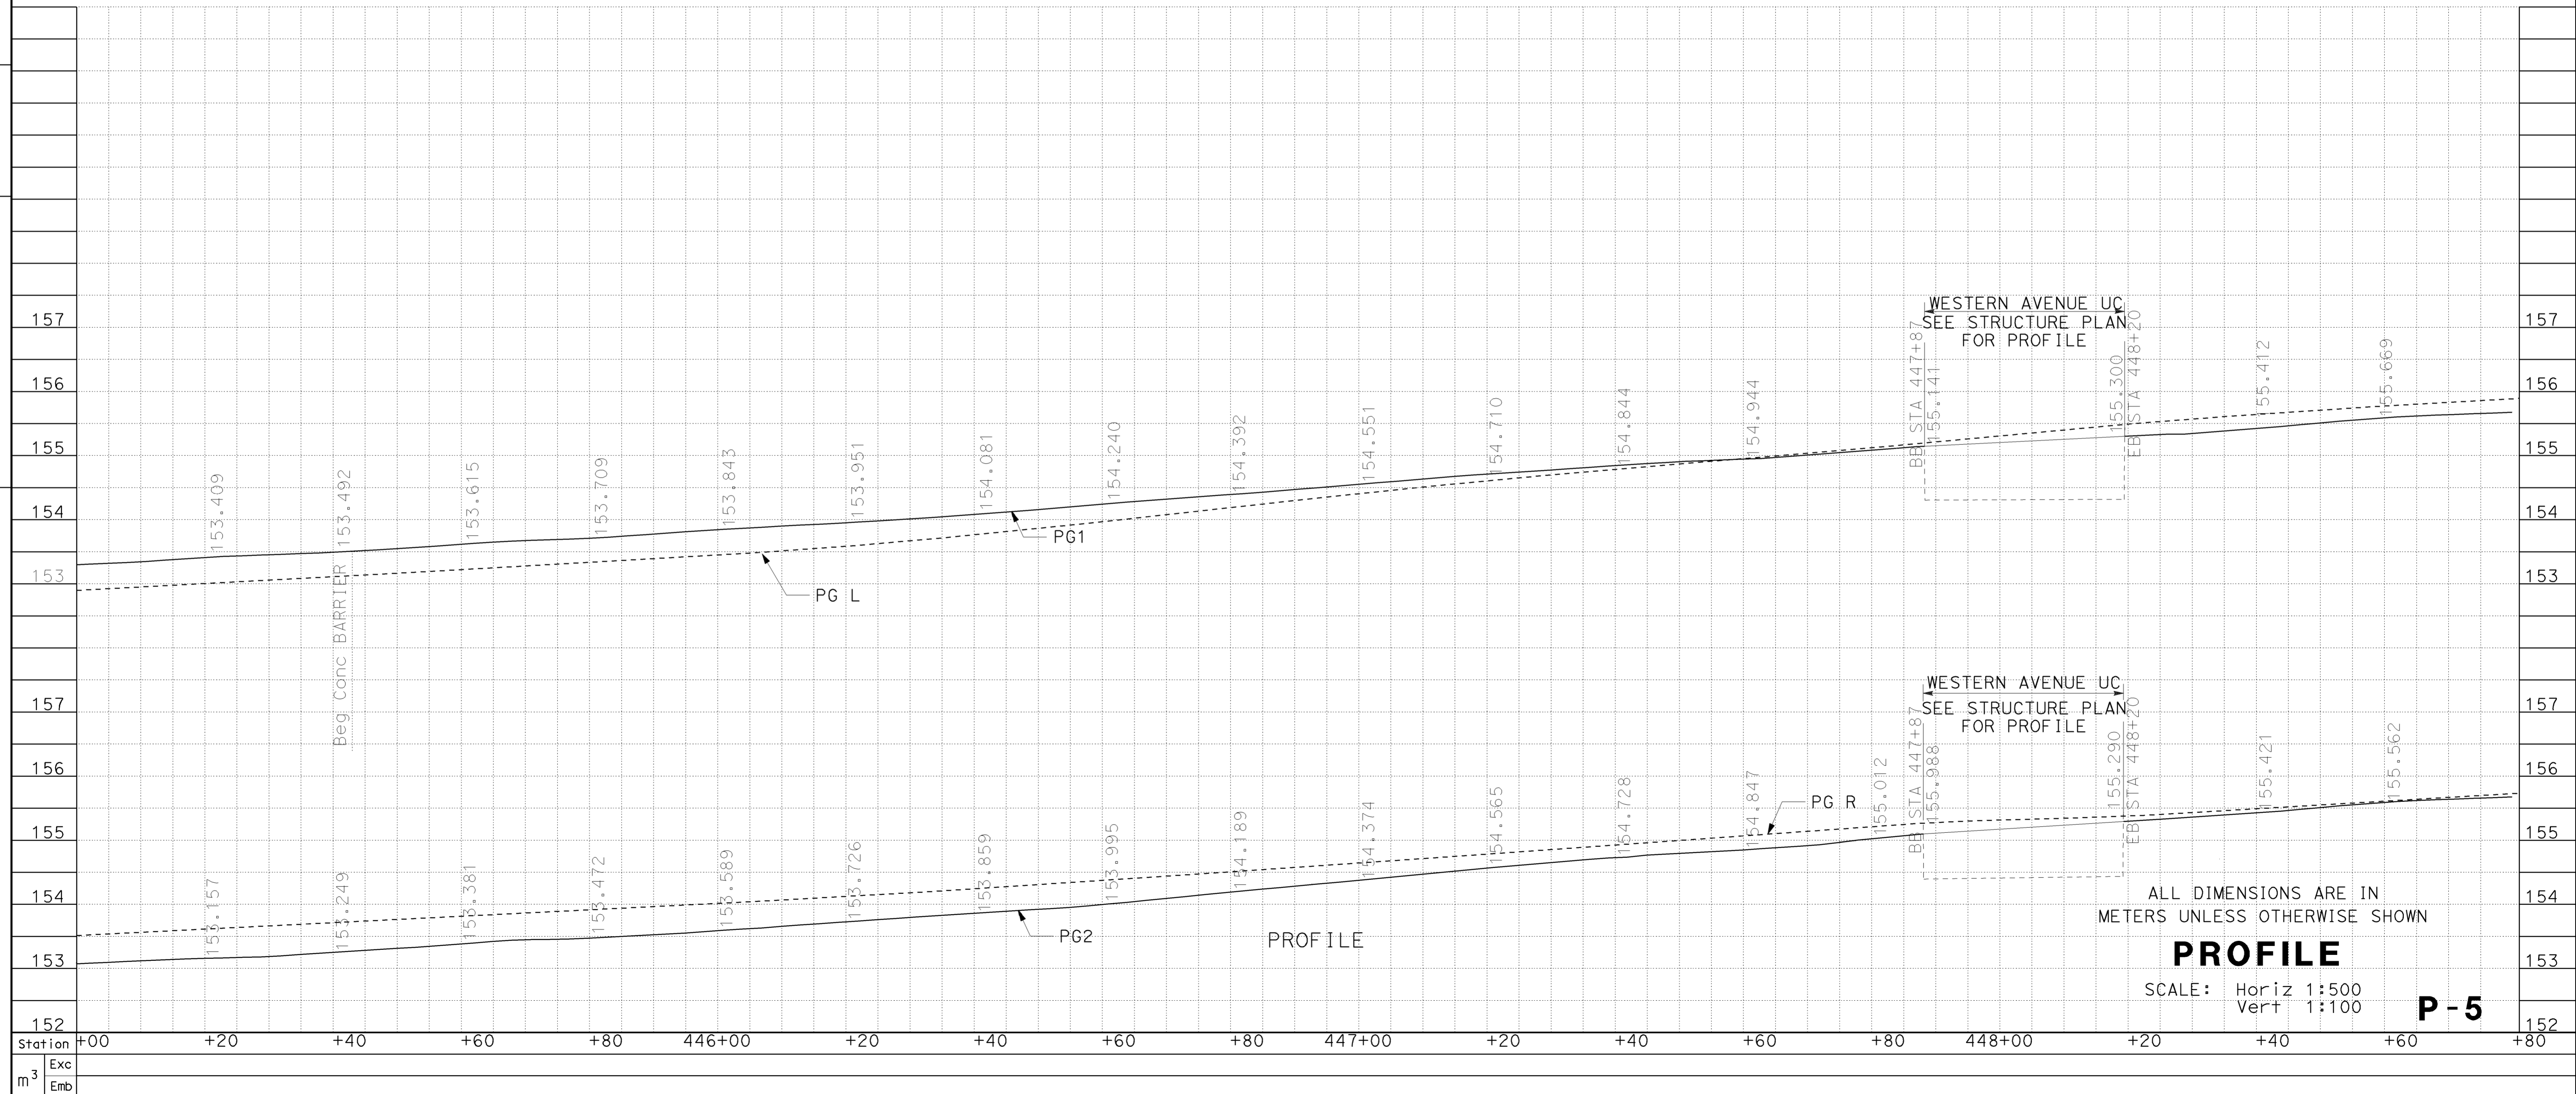
FUNCTIONAL SUPERVISOR	CELINA AVILES
CALCULATED-DESIGNED BY	
CHECKED BY	
DAWIT WORKU	MUNSHI MOSHIN
REVISOR BY	DW
DATE REVISED	12/2008

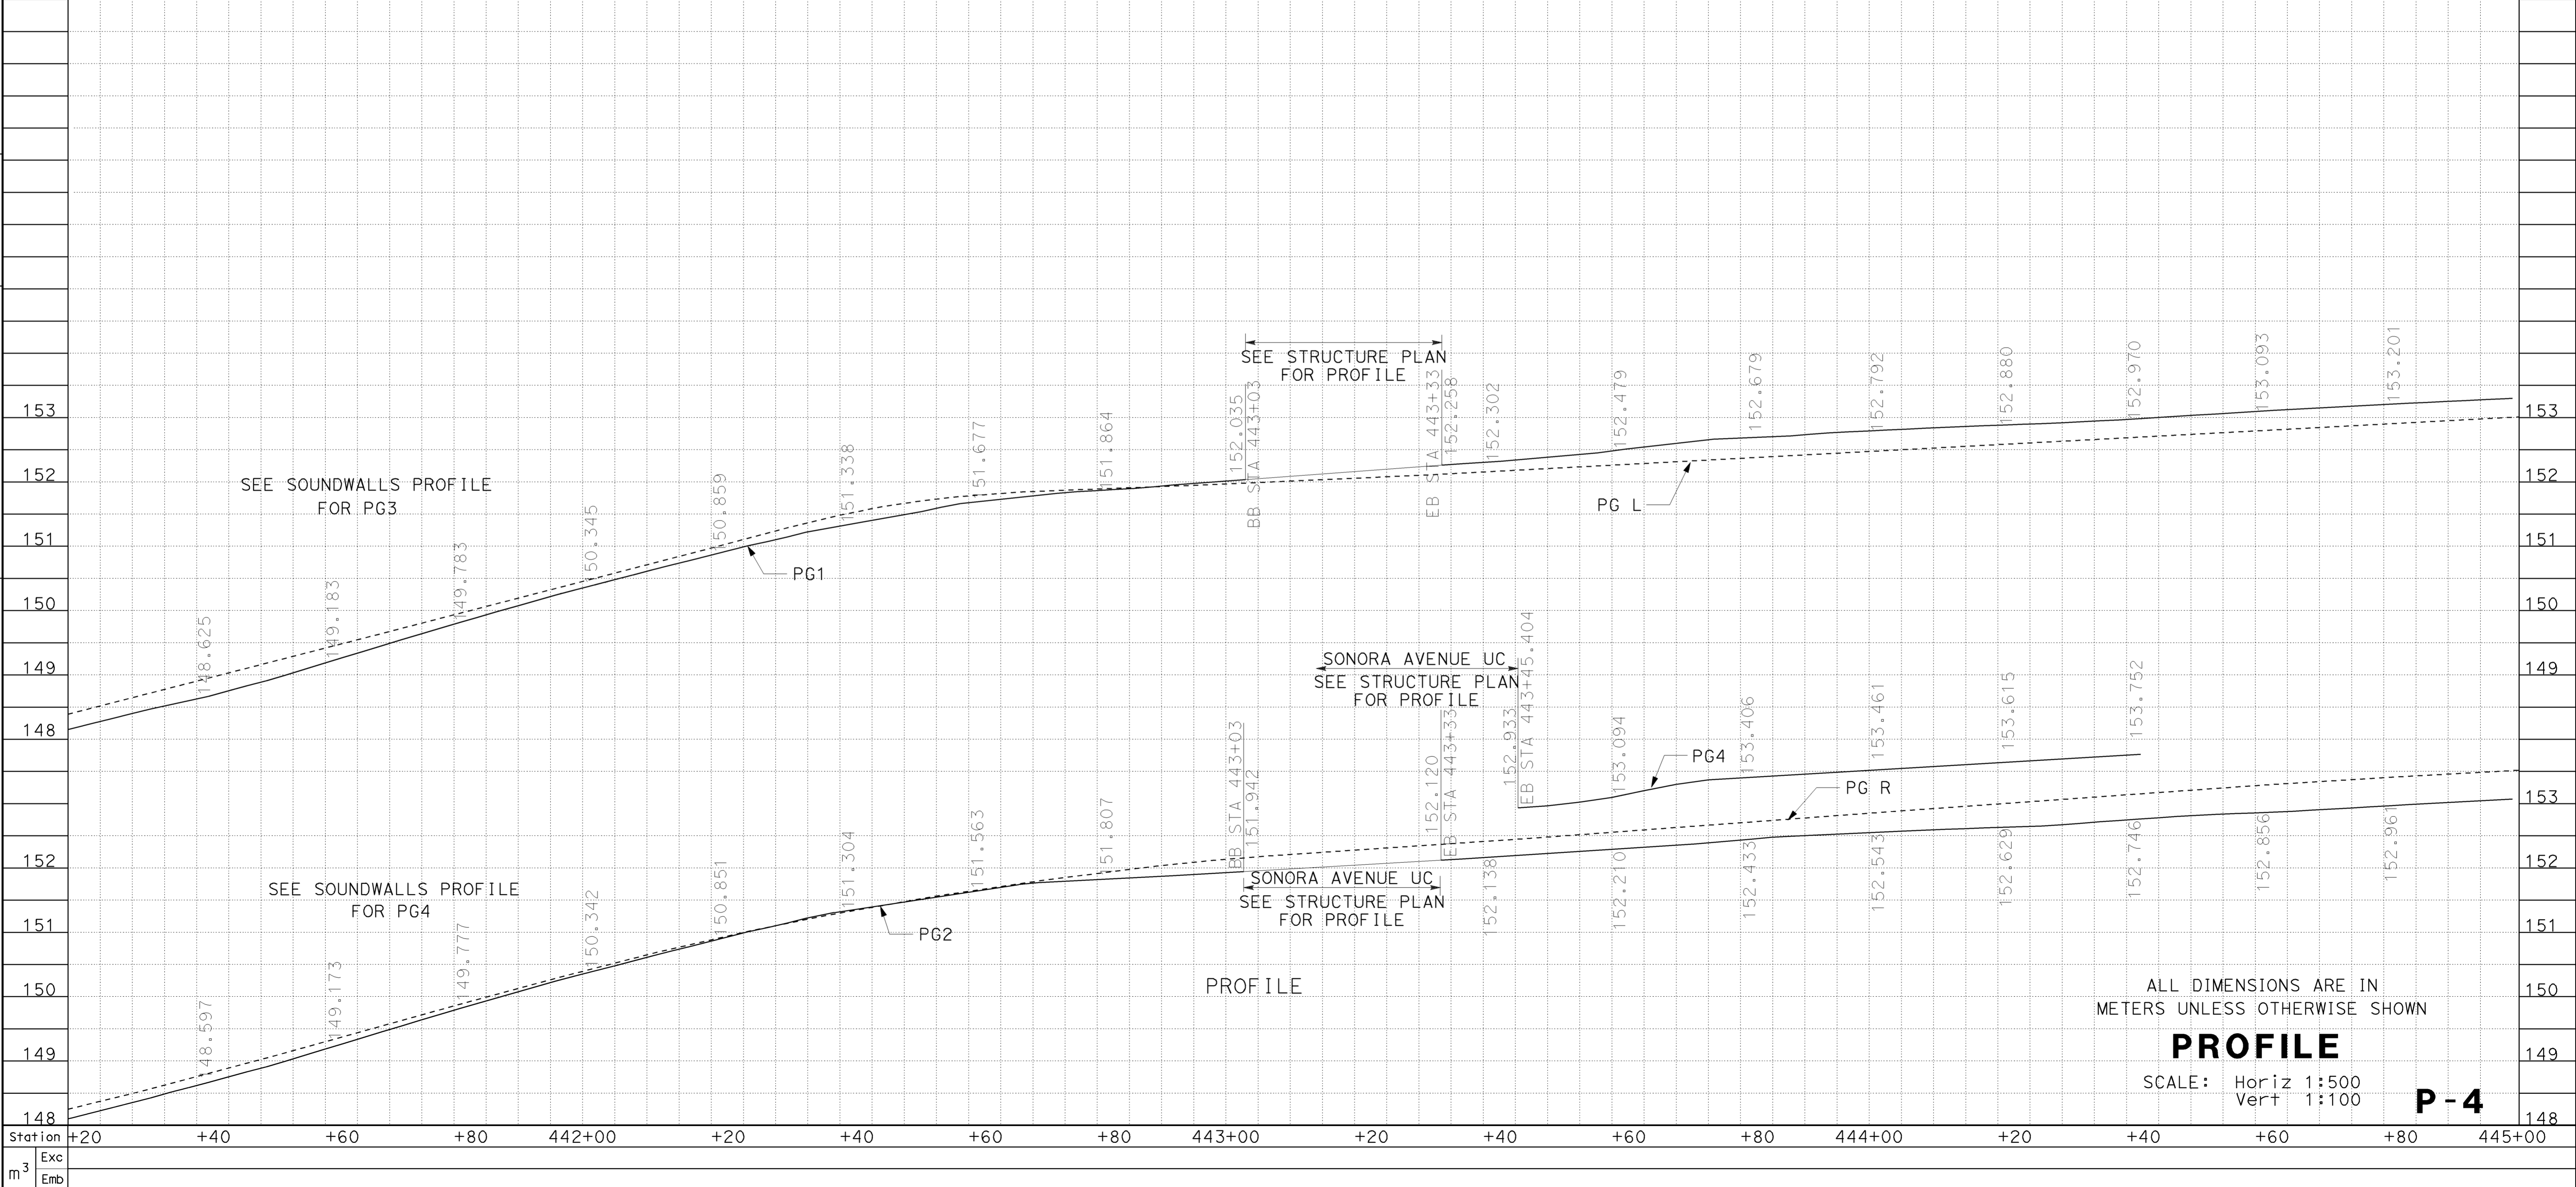
Dist	COUNTY	ROUTE	KILOMETER POST TOTAL PROJECT	SHEET No.	TOTAL SHEETS
07	LA	5	42.8/47.3	28	1073

 2-24-09
 REGISTERED CIVIL ENGINEER DATE
 6-8-09
 PLANS APPROVAL DATE



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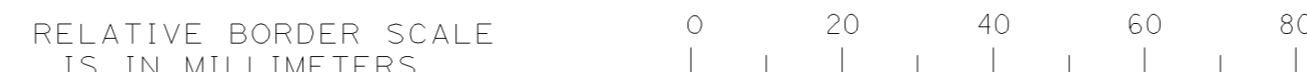
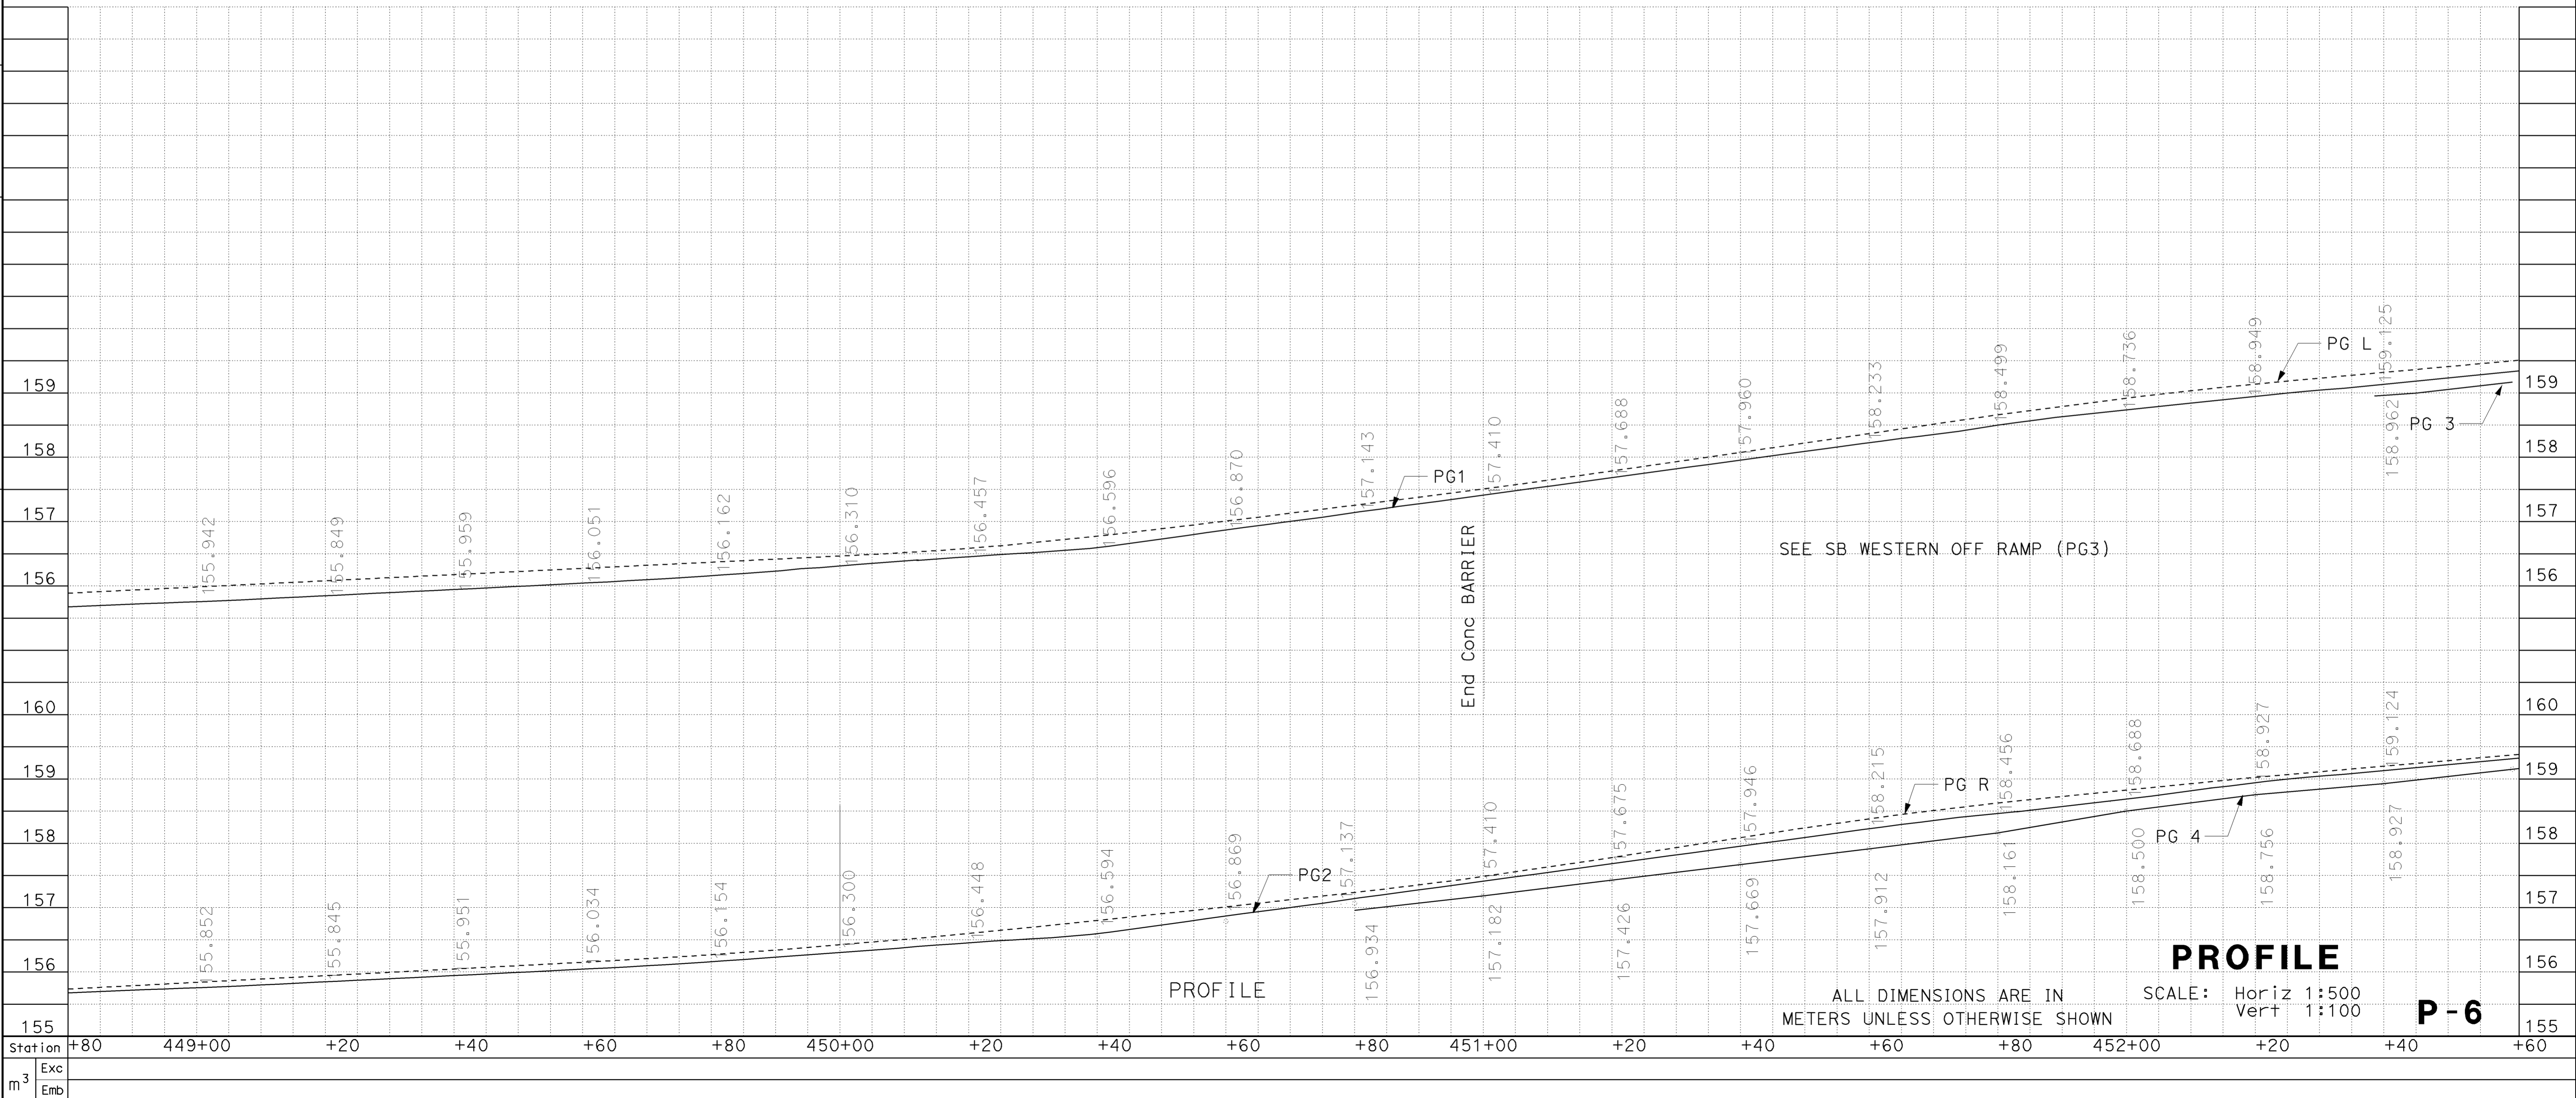


Dist	COUNTY	ROUTE	KILOMETER POST TOTAL PROJECT	SHEET No.	TOTAL SHEETS
07	LA	5	42.8/47.3	29	1073

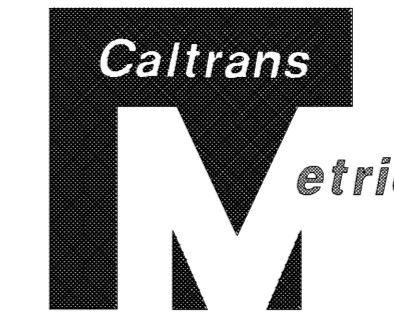2-24-09
 REGISTERED CIVIL ENGINEER DATE
 6-8-09
 PLANS APPROVAL DATE
 THE STATE OF CALIFORNIA OR ITS OFFICERS OR AGENTS SHALL NOT BE RESPONSIBLE FOR THE ACCURACY OR COMPLETENESS OF ELECTRONIC COPIES OF THIS PLAN SHEET.

REGISTERED PROFESSIONAL ENGINEER
MUNSHI MOHSIN
 No. 61916
 Exp. 9/30/09
 CIVIL
 STATE OF CALIFORNIA

STATE OF CALIFORNIA - DEPARTMENT OF TRANSPORTATION	FUNCTIONAL SUPERVISOR	CALCULATED-DESIGNED BY	DAWIT WORKU	REVISOR BY	DW
Caltrans OFFICE OF DESIGN D	CELINA AVILES	CHECKED BY	MUNSHI MOSHIN	DATE REVISED	12/2008



x
x
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x

STATE OF CALIFORNIA - DEPARTMENT OF TRANSPORTATION		FUNCTIONAL SUPERVISOR	CELINA AVILES	CALCULATED-DESIGNED BY		DAWIT WORKU	REVISOR BY	DW	
Caltrans OFFICE OF DESIGN D		CHECKED BY		CHECKED BY		MUNSHI MOSHIN	DATE REVISED	12/2008	




Dist	COUNTY	ROUTE	KILOMETER POST TOTAL PROJECT	SHEET No.	TOTAL SHEETS
07	LA	5	42.8/47.3	30	1073

2-24-09
 REGISTERED CIVIL ENGINEER DATE
 6-8-09
 PLANS APPROVAL DATE

MUNSHI MOHSIN
 No. 61916
 Exp. 9/30/09
 REGISTERED PROFESSIONAL ENGINEER CIVIL
 STATE OF CALIFORNIA

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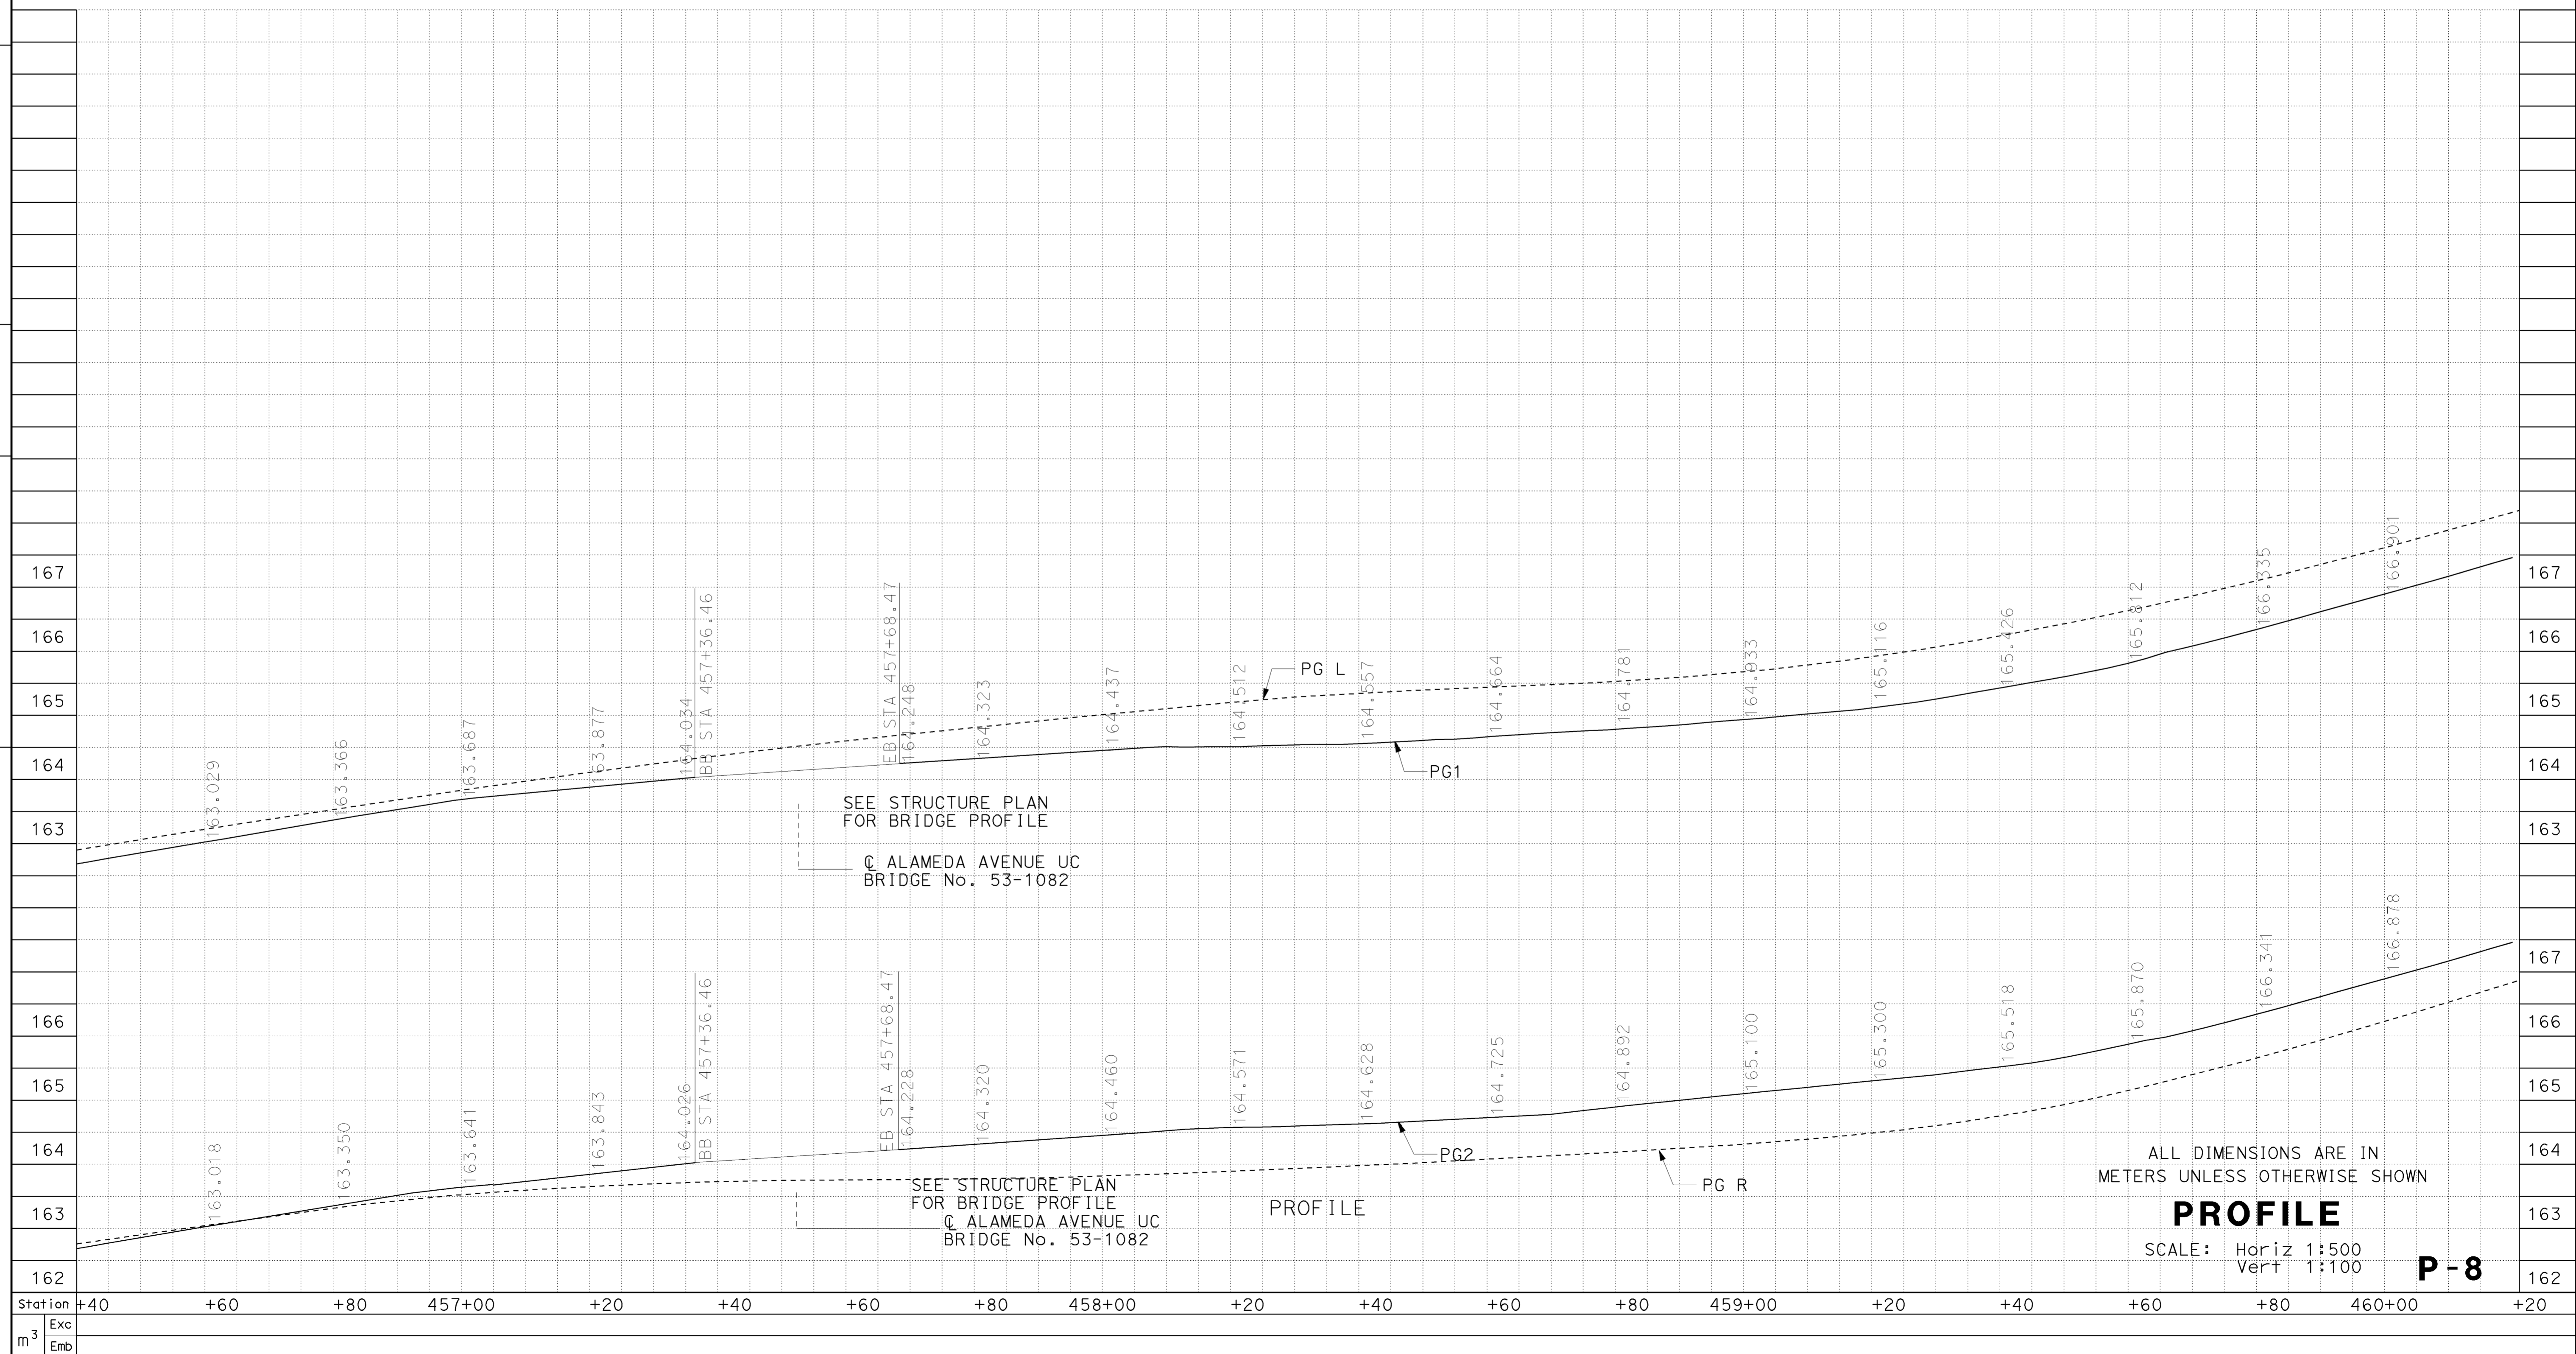
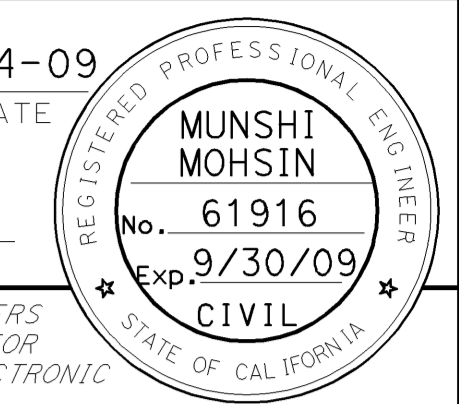

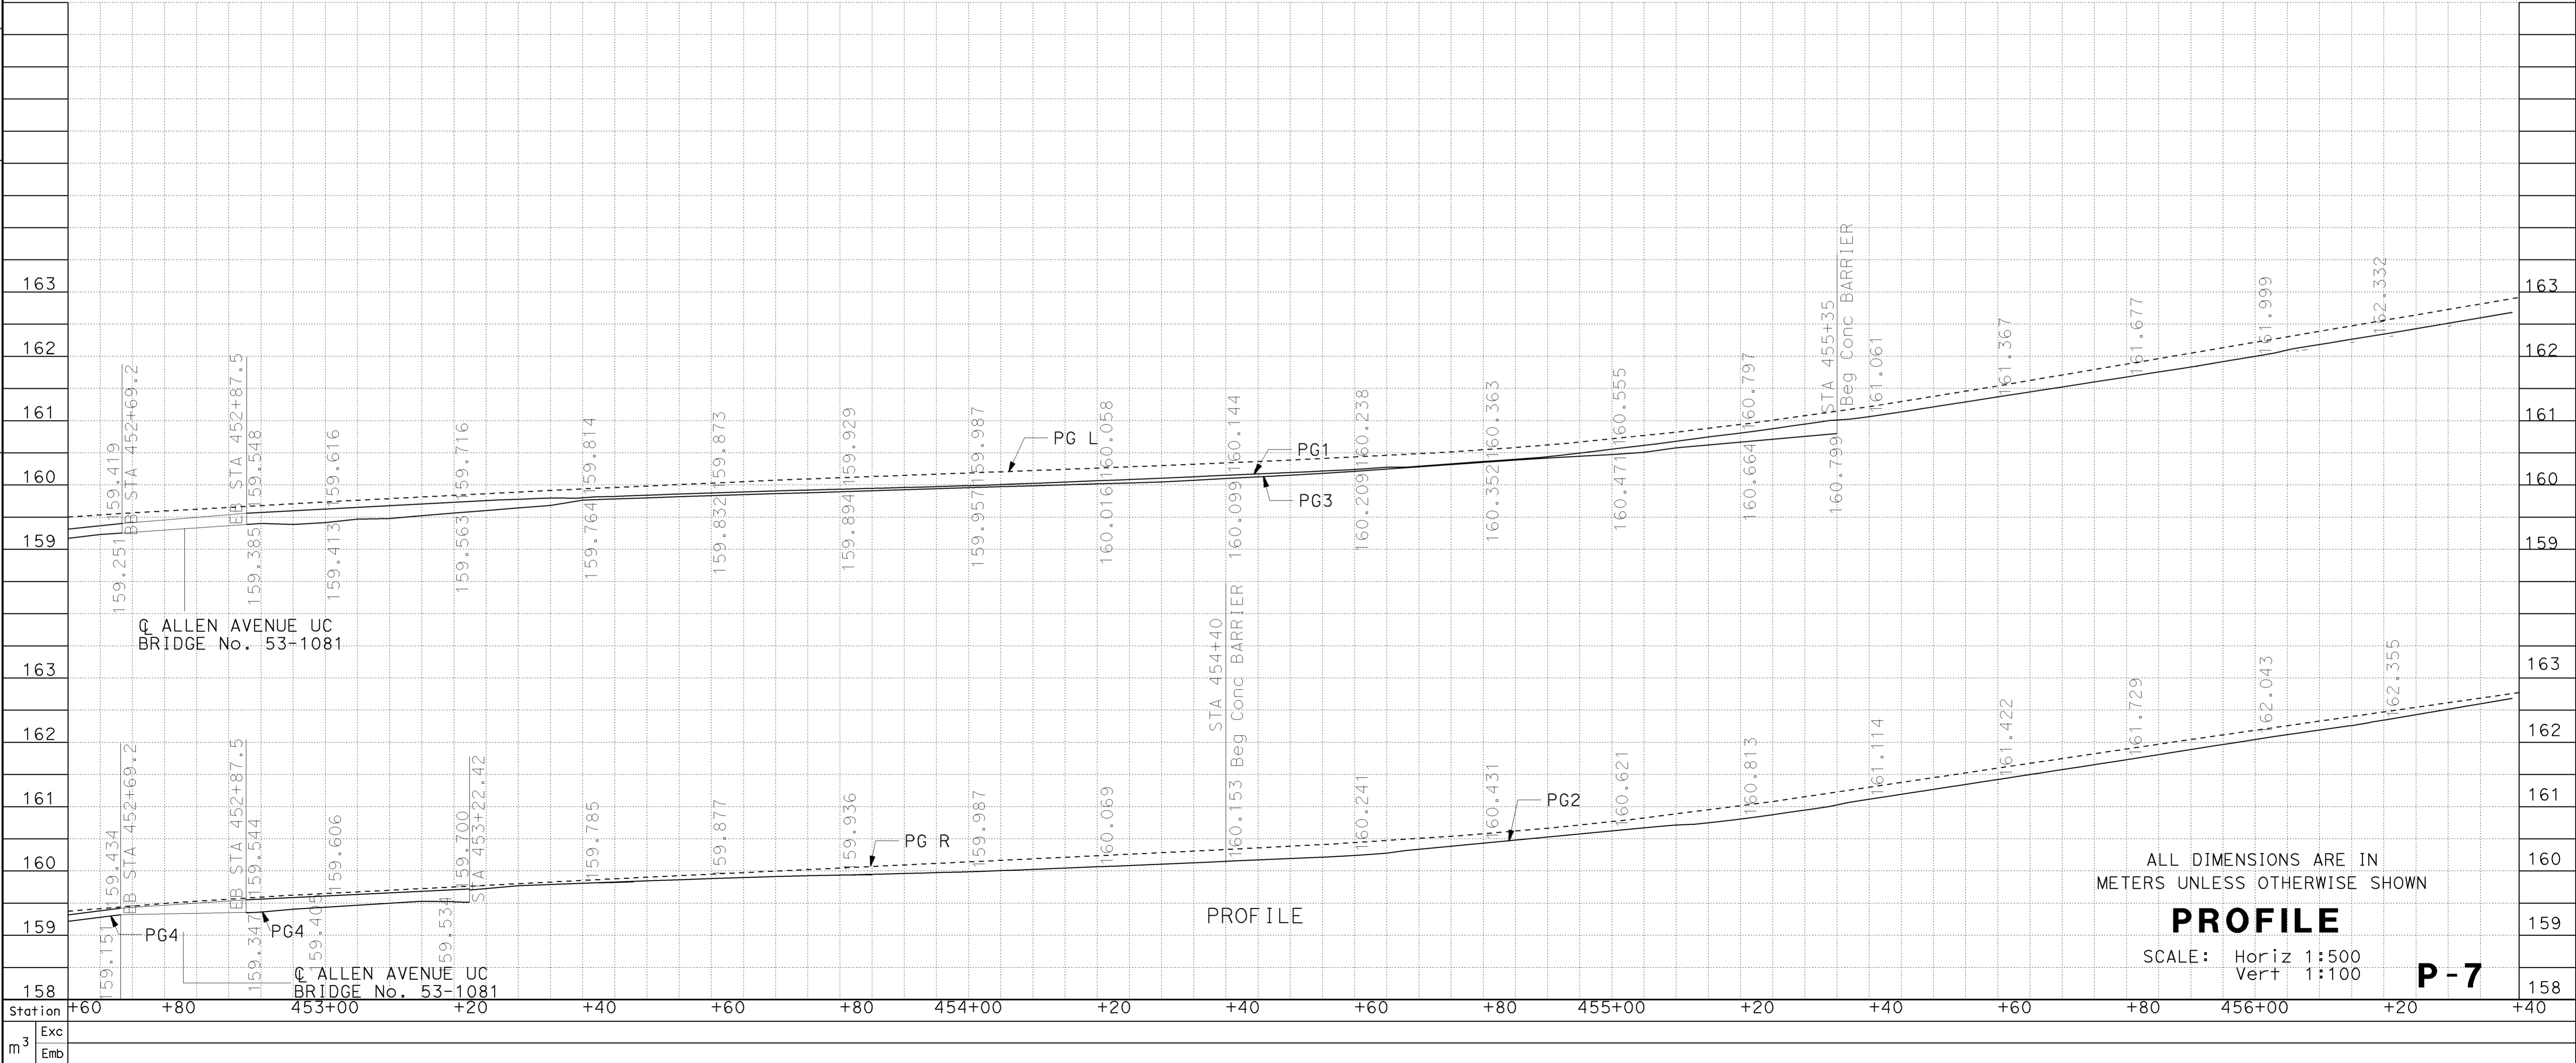
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STATE OF CALIFORNIA - DEPARTMENT OF TRANSPORTATION Caltrans OFFICE OF DESIGN D	FUNCTIONAL SUPERVISOR	CELINA AVILES
	CALCULATED-DESIGNED BY	CHECKED BY
DAWIT WORKU	MUNSHI MOSHIN	
REVISOR BY	DATE REVISOR	
DW	12/2008	



Dist	COUNTY	ROUTE	KILOMETER POST TOTAL PROJECT	SHEET No.	TOTAL SHEETS
07	LA	5	42.8/47.3	31	1073
			2-24-09		
			REGISTERED CIVIL ENGINEER DATE		
			6-8-09		
			PLANS APPROVAL DATE		
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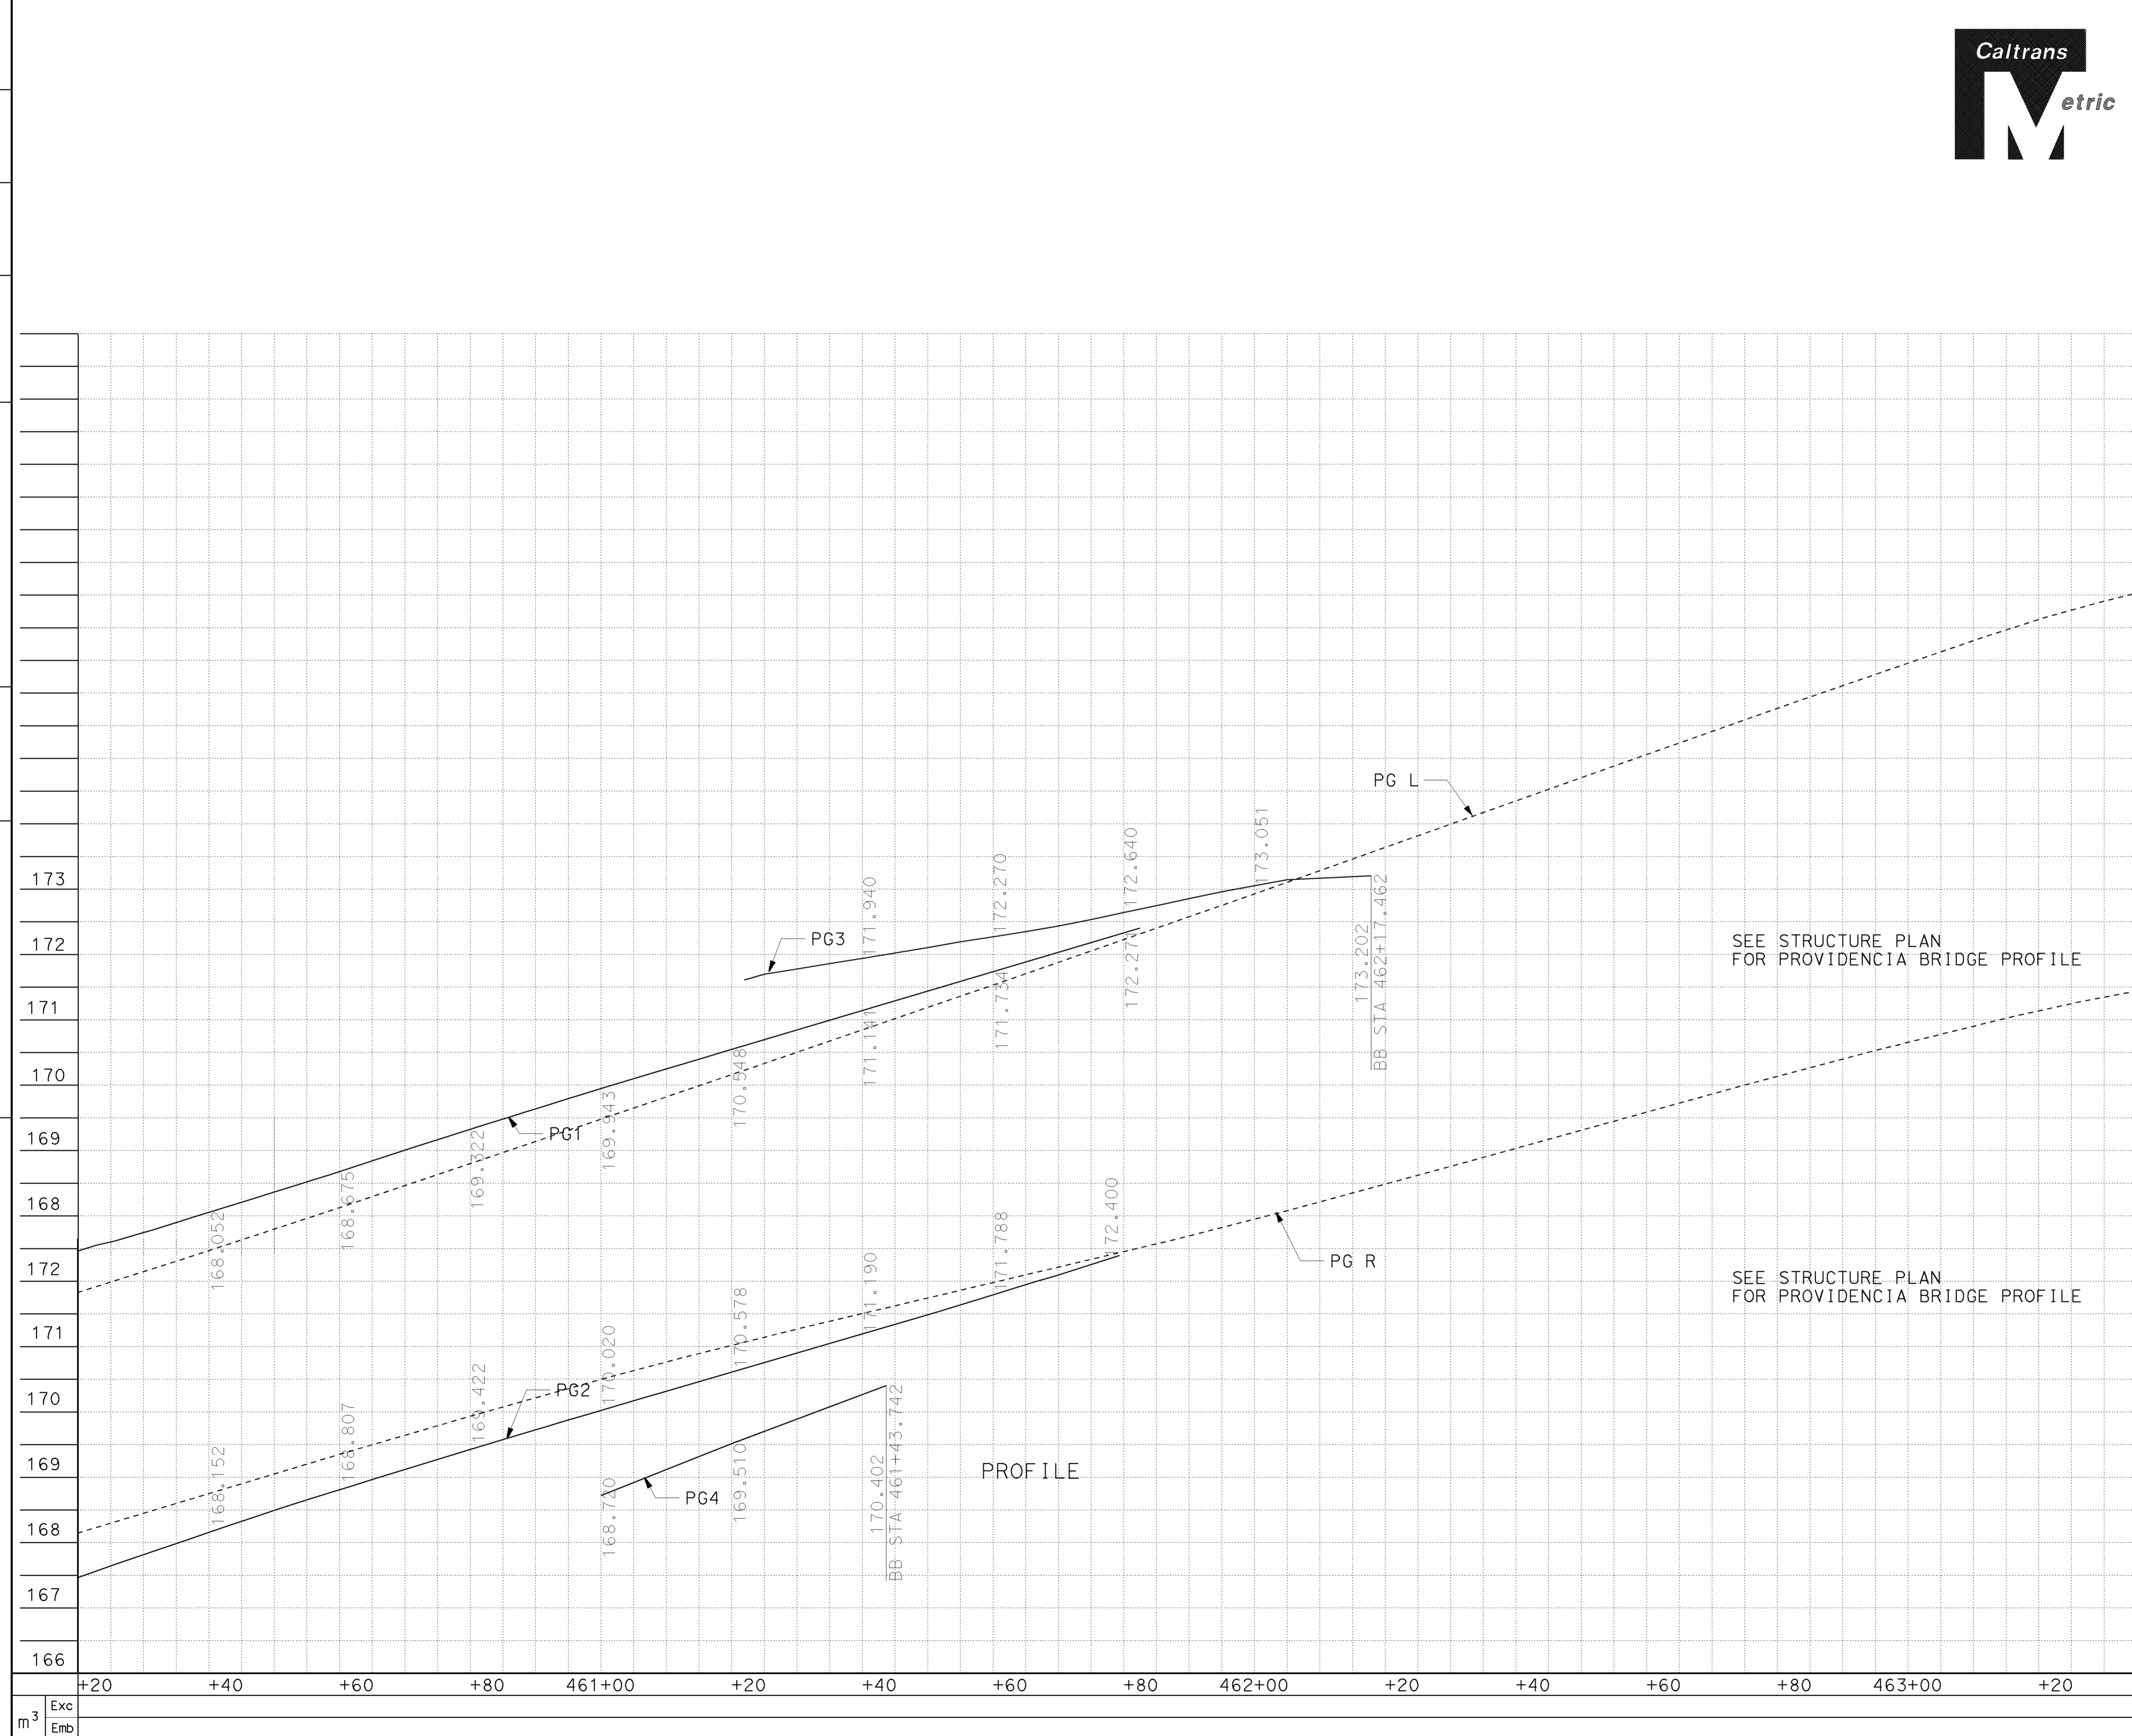
PROFILE

SCALE: Horiz 1:500
Vert 1:100

P-8

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STATE OF CALIFORNIA - DEPARTMENT OF TRANSPORTATION Caltrans OFFICE OF DESIGN D	FUNCTIONAL SUPERVISOR CELINA AVILES	CALCULATED-DESIGNED BY	DAWIT WORKU	REVISOR BY DW
	CHECKED BY	MUNSHI MOSHIN	DATE REVISOR	12/2008



Dist	COUNTY	ROUTE	KILOMETER POST TOTAL PROJECT	SHEET No.	TOTAL SHEETS
07	LA	5	42.8/47.3	32	1073

REGISTERED CIVIL ENGINEER DATE 2-24-09
 PLANS APPROVAL DATE 6-8-09

REGISTERED PROFESSIONAL ENGINEER
 MUNSHI MOHSIN
 No. 61916
 Exp. 9/30/09
 CIVIL
 STATE OF CALIFORNIA

THE STATE OF CALIFORNIA OR ITS OFFICERS OR AGENTS SHALL NOT BE RESPONSIBLE FOR THE ACCURACY OR COMPLETENESS OF ELECTRONIC COPIES OF THIS PLAN SHEET.




FUNCTIONAL SUPERVISOR	CELINA AVILES
CALCULATED-DESIGNED BY	178
CHECKED BY	177
DAWIT WORKU	MUNSHI MOSHIN
REVISOR	DW
DATE REVISOR	12/2008



Dist	COUNTY	ROUTE	KILOMETER TOTAL PROJECT	POST TOTAL PROJECT	SHEET No.	TOTAL SHEETS
07	LA	5	42.8/47.3		33	1073

REGISTERED CIVIL ENGINEER DATE 2-24-09
 PLANS APPROVAL DATE 6-8-09
 REGISTERED PROFESSIONAL ENGINEER
 MUNSHI MOHSIN
 No. 61916
 Exp. 9/30/09
 CIVIL
 STATE OF CALIFORNIA
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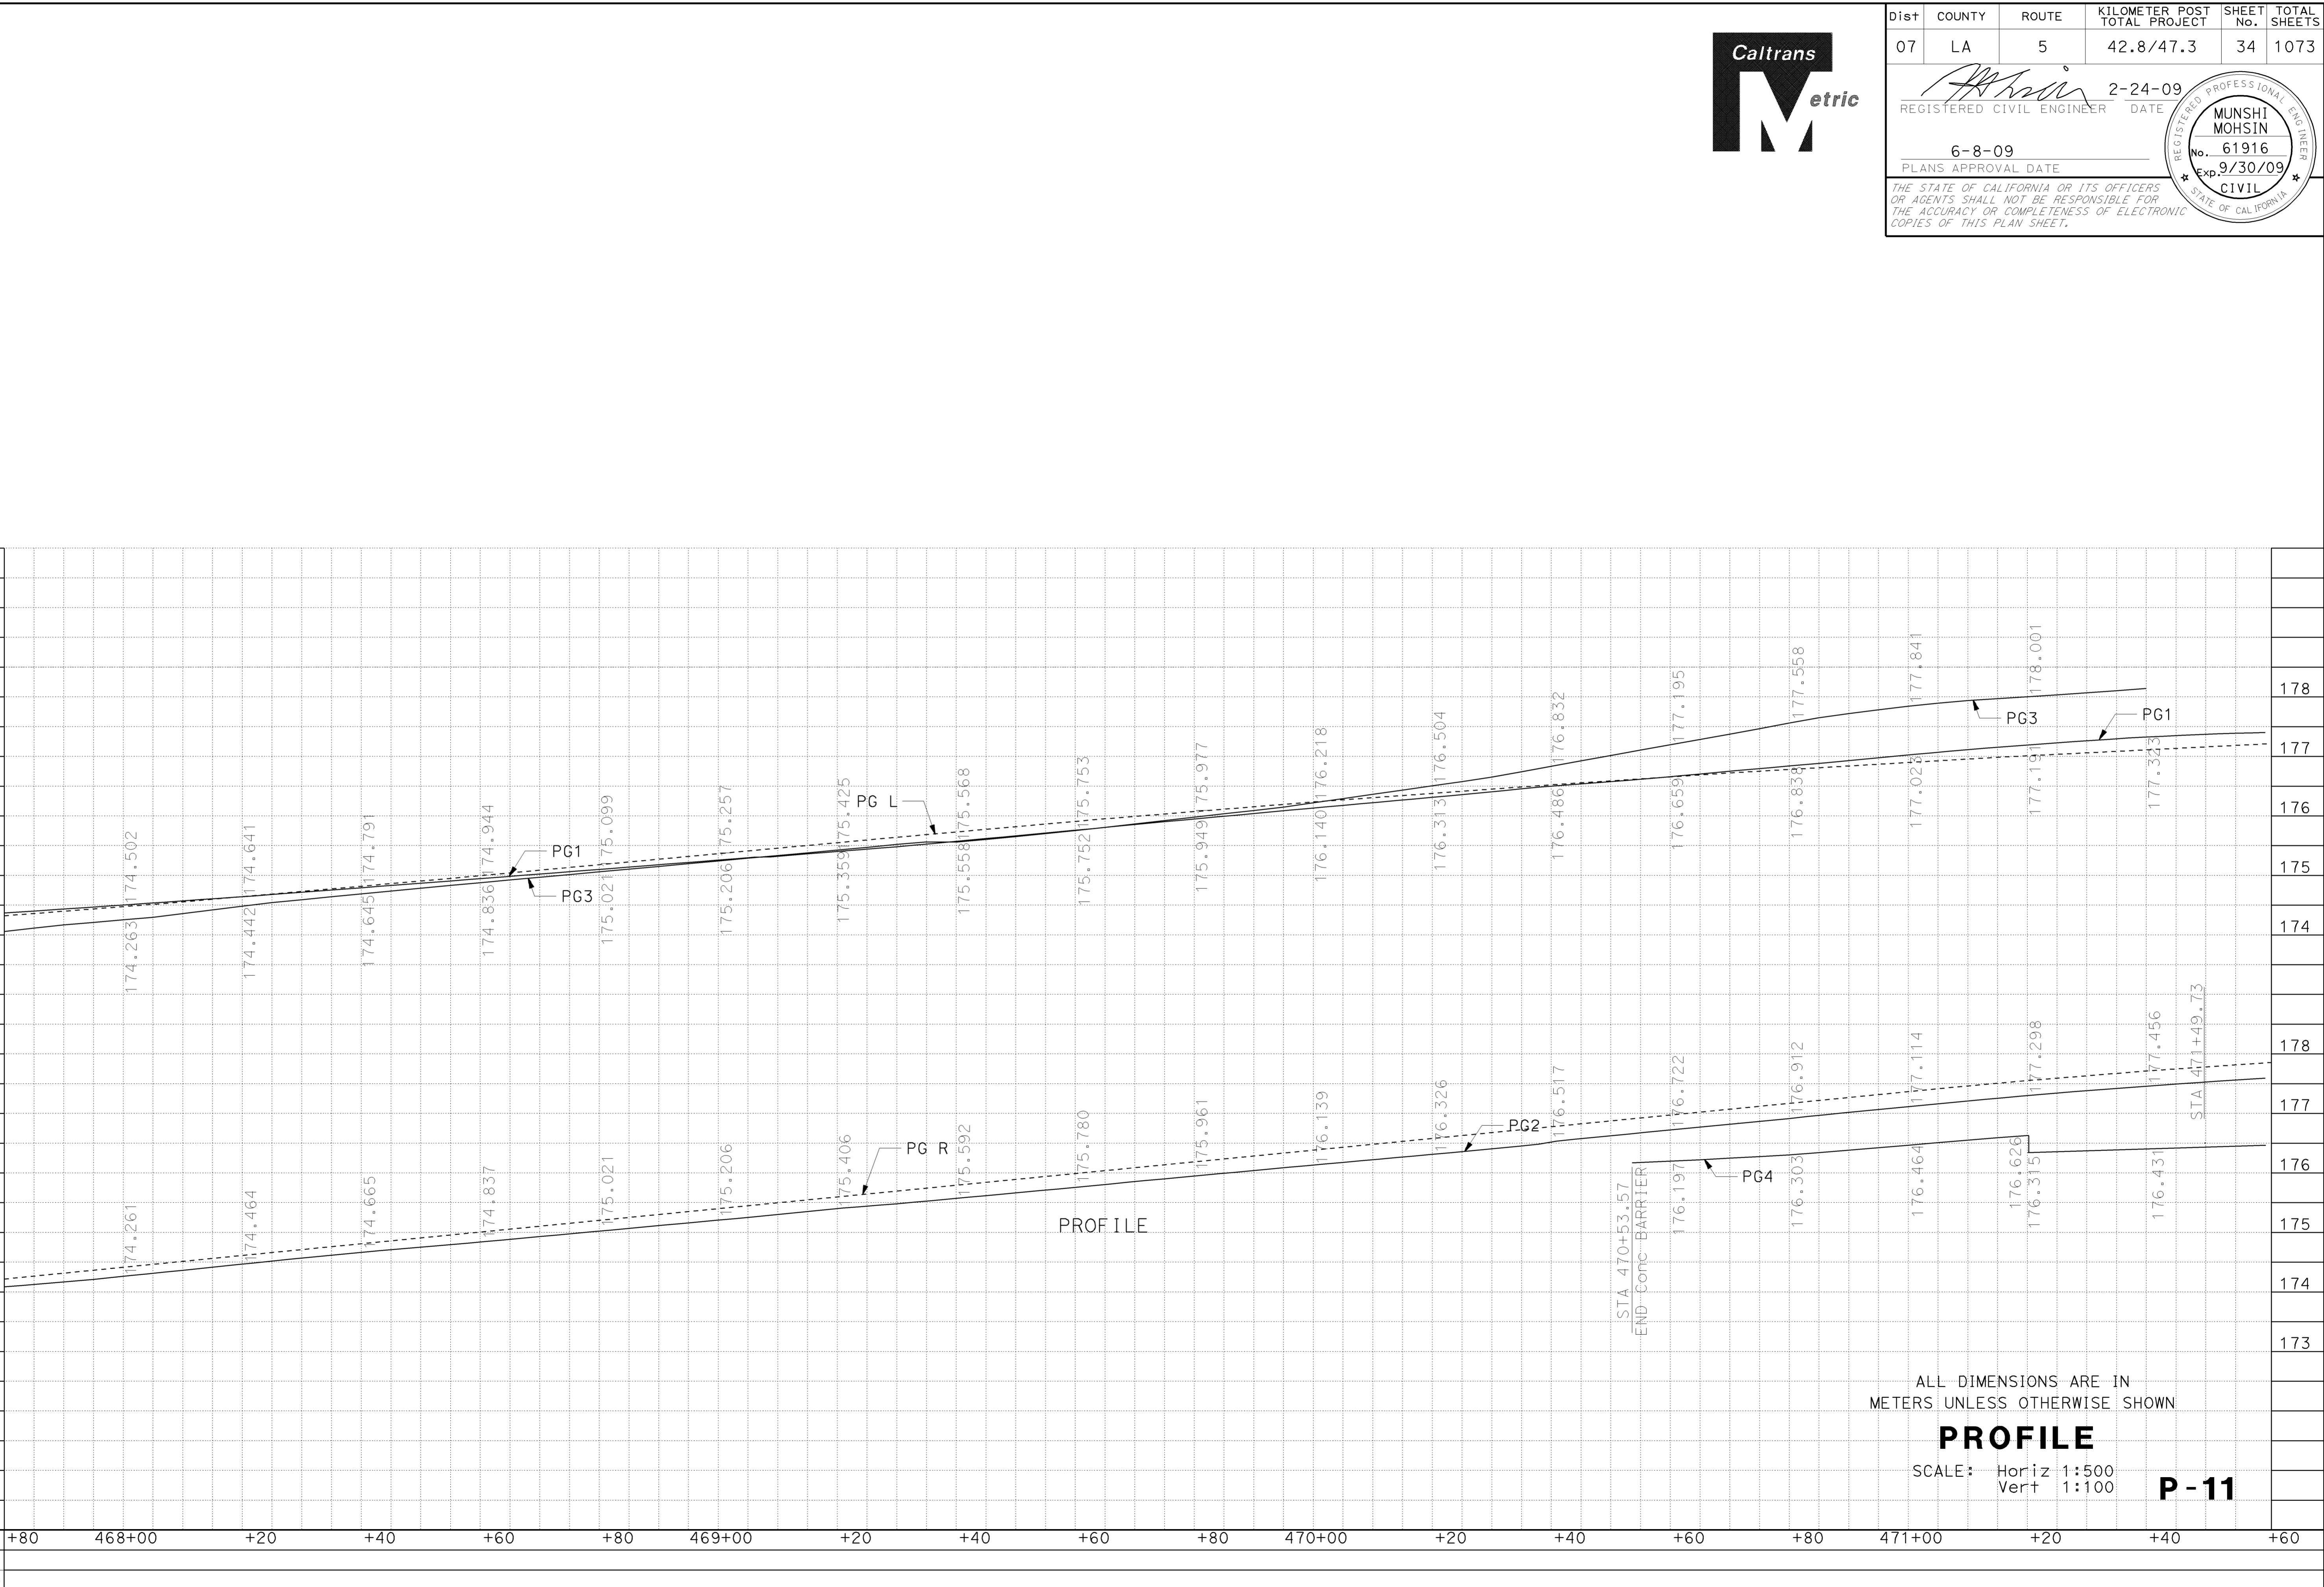
PROFILE

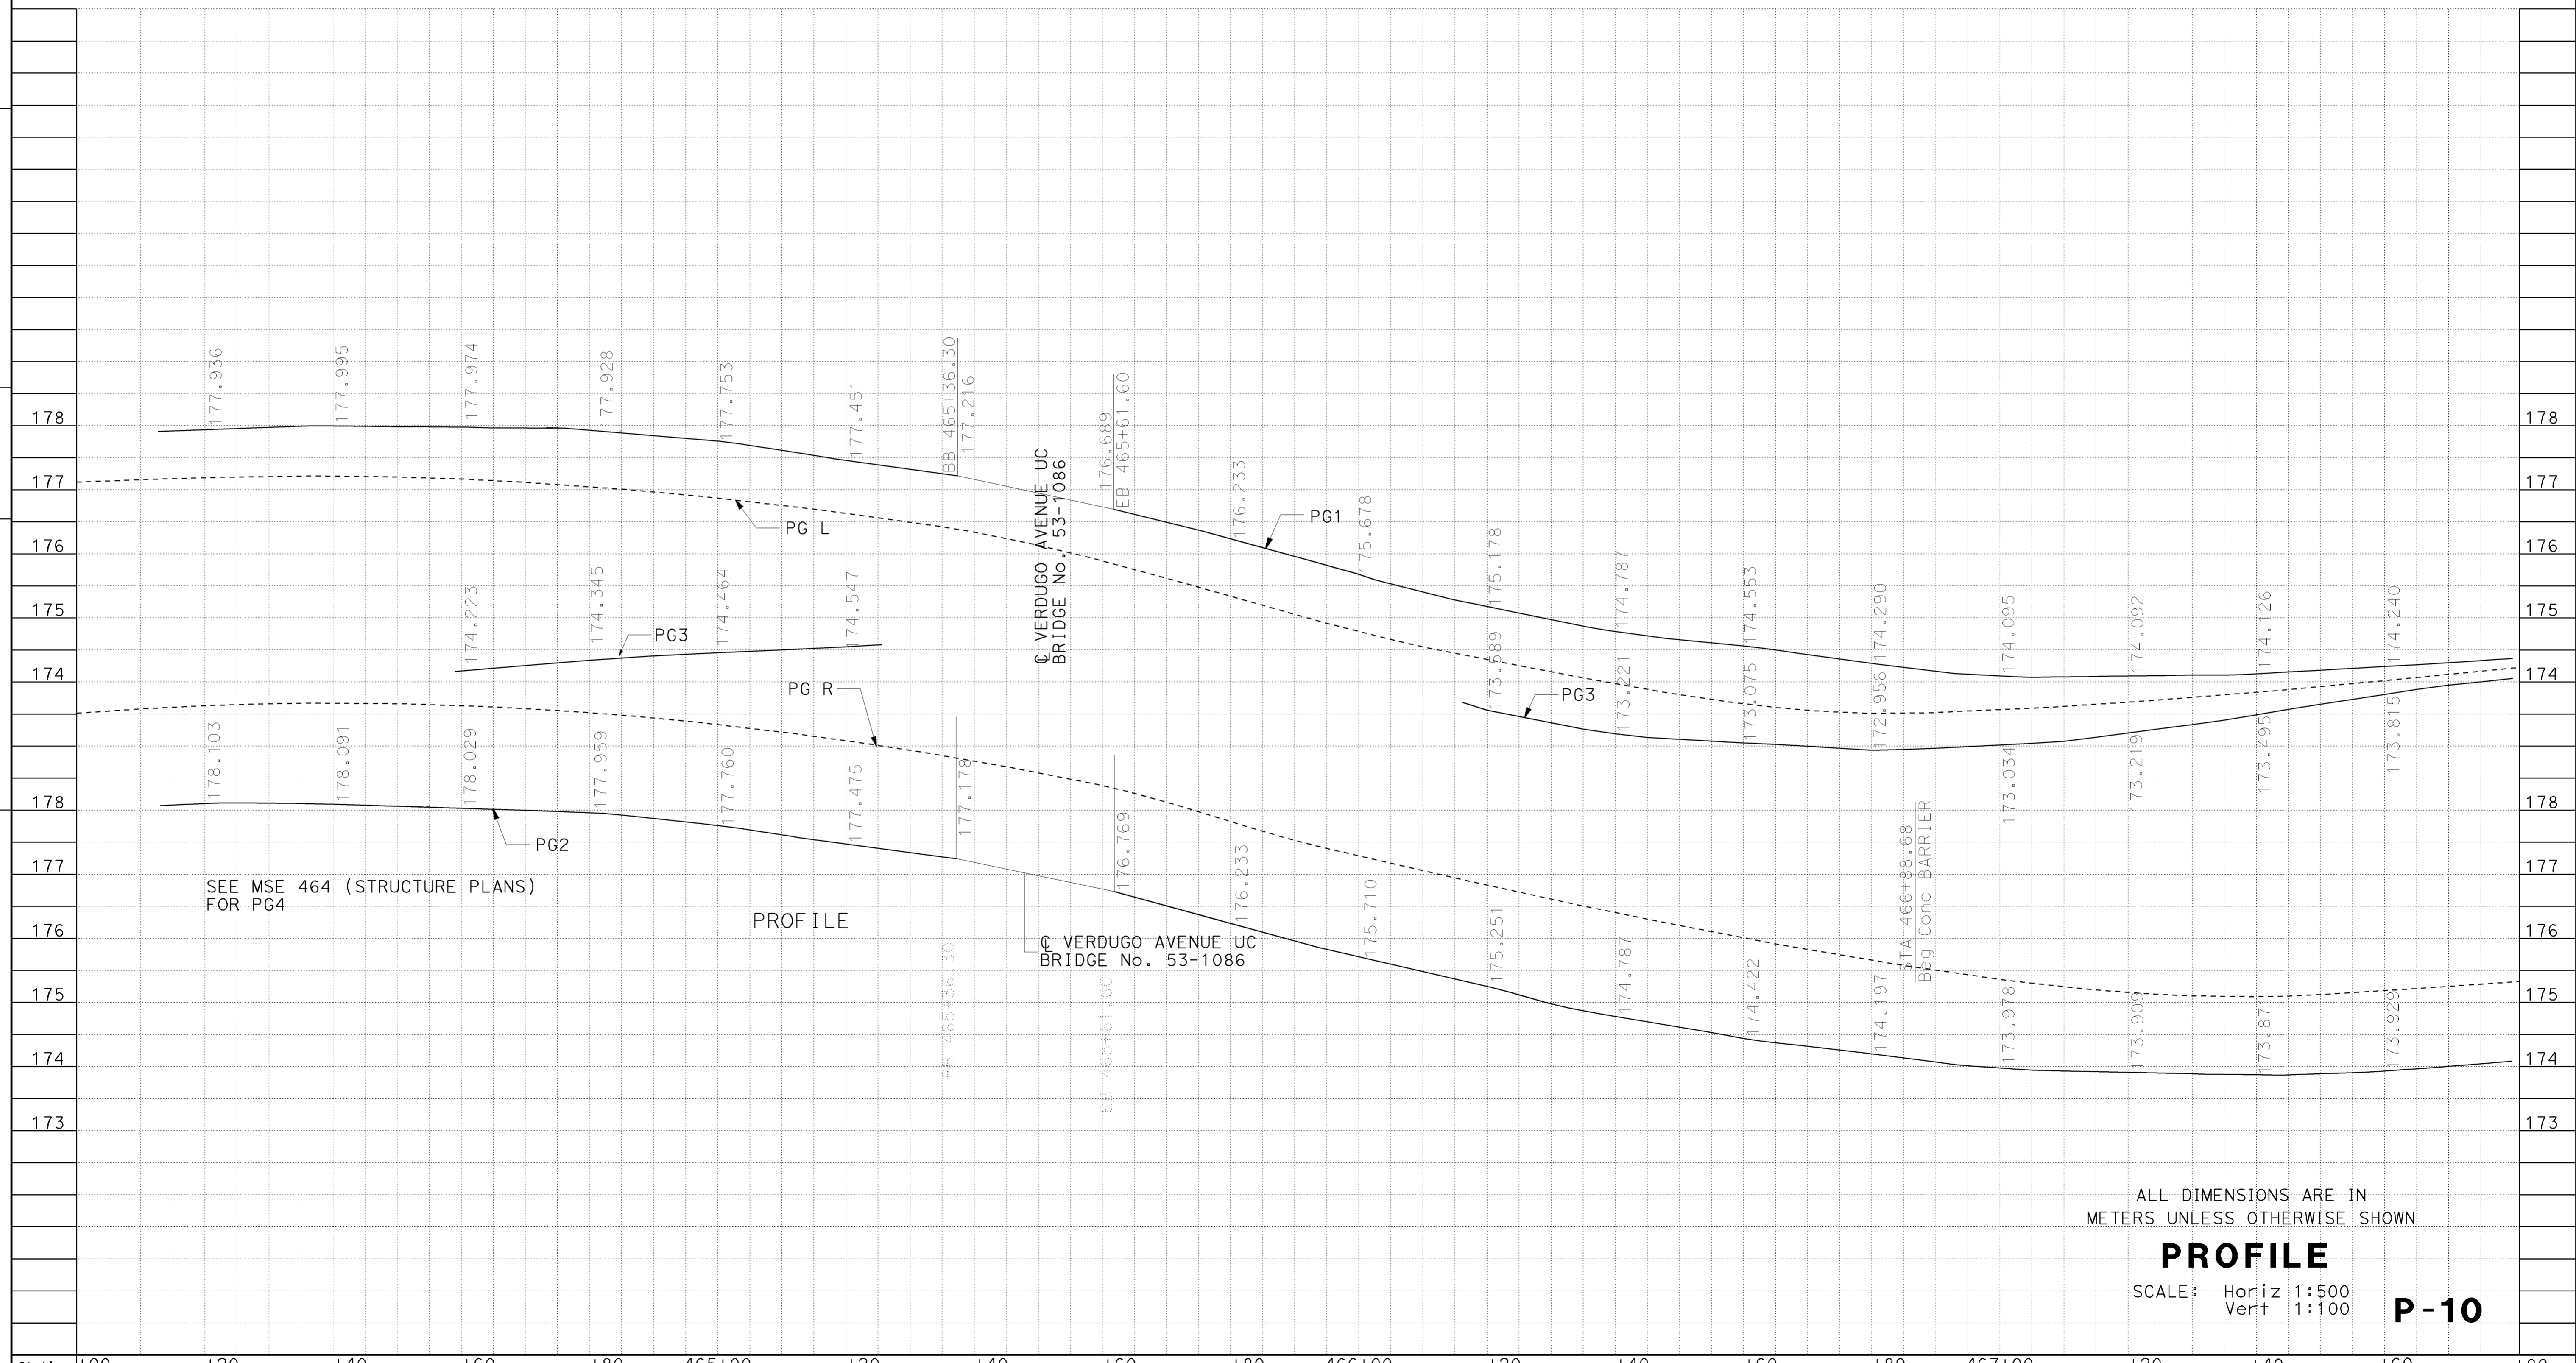SCALE: Horiz 1:500
Vert 1:100

P-10



FUNCTIONAL SUPERVISOR	CELINA AVILES
DAWIT WORKU	MUNSHI MOSHIN
REVISOR BY	DW
DATE REVISED	12/2008
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DESIGNED BY	



ALL DIMENSIONS ARE IN METERS UNLESS OTHERWISE SHOWN
PROFILE
 SCALE: Horiz 1:500
 Vert 1:100
P-11



Dist	COUNTY	ROUTE	KILOMETER TOTAL PROJECT	POST TOTAL PROJECT	SHEET No.	TOTAL SHEETS
07	LA	5	42.8/47.3		34	1073
			 REGISTERED CIVIL ENGINEER DATE 2-24-09			
			PLANS APPROVAL DATE 6-8-09			
THE STATE OF CALIFORNIA OR ITS OFFICERS OR AGENTS SHALL NOT BE RESPONSIBLE FOR THE ACCURACY OR COMPLETENESS OF ELECTRONIC COPIES OF THIS PLAN SHEET.						




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STATE OF CALIFORNIA - DEPARTMENT OF TRANSPORTATION		FUNCTIONAL SUPERVISOR	DAWIT WORKU	REVISOR	DW
Caltrans OFFICE OF DESIGN D		CELINA AVILES	MUNSHI MOSHIN	DATE REVISED	12/2008
Station					
m ³	Exc				
	Emb				



Dist	COUNTY	ROUTE	KILOMETER TOTAL PROJECT	POST No.	SHEET No.	TOTAL SHEETS
07	LA	5	42.8/47.3		35	1073
			2-24-09			
			REGISTERED CIVIL ENGINEER DATE			
			6-8-09			
			PLANS APPROVAL DATE			
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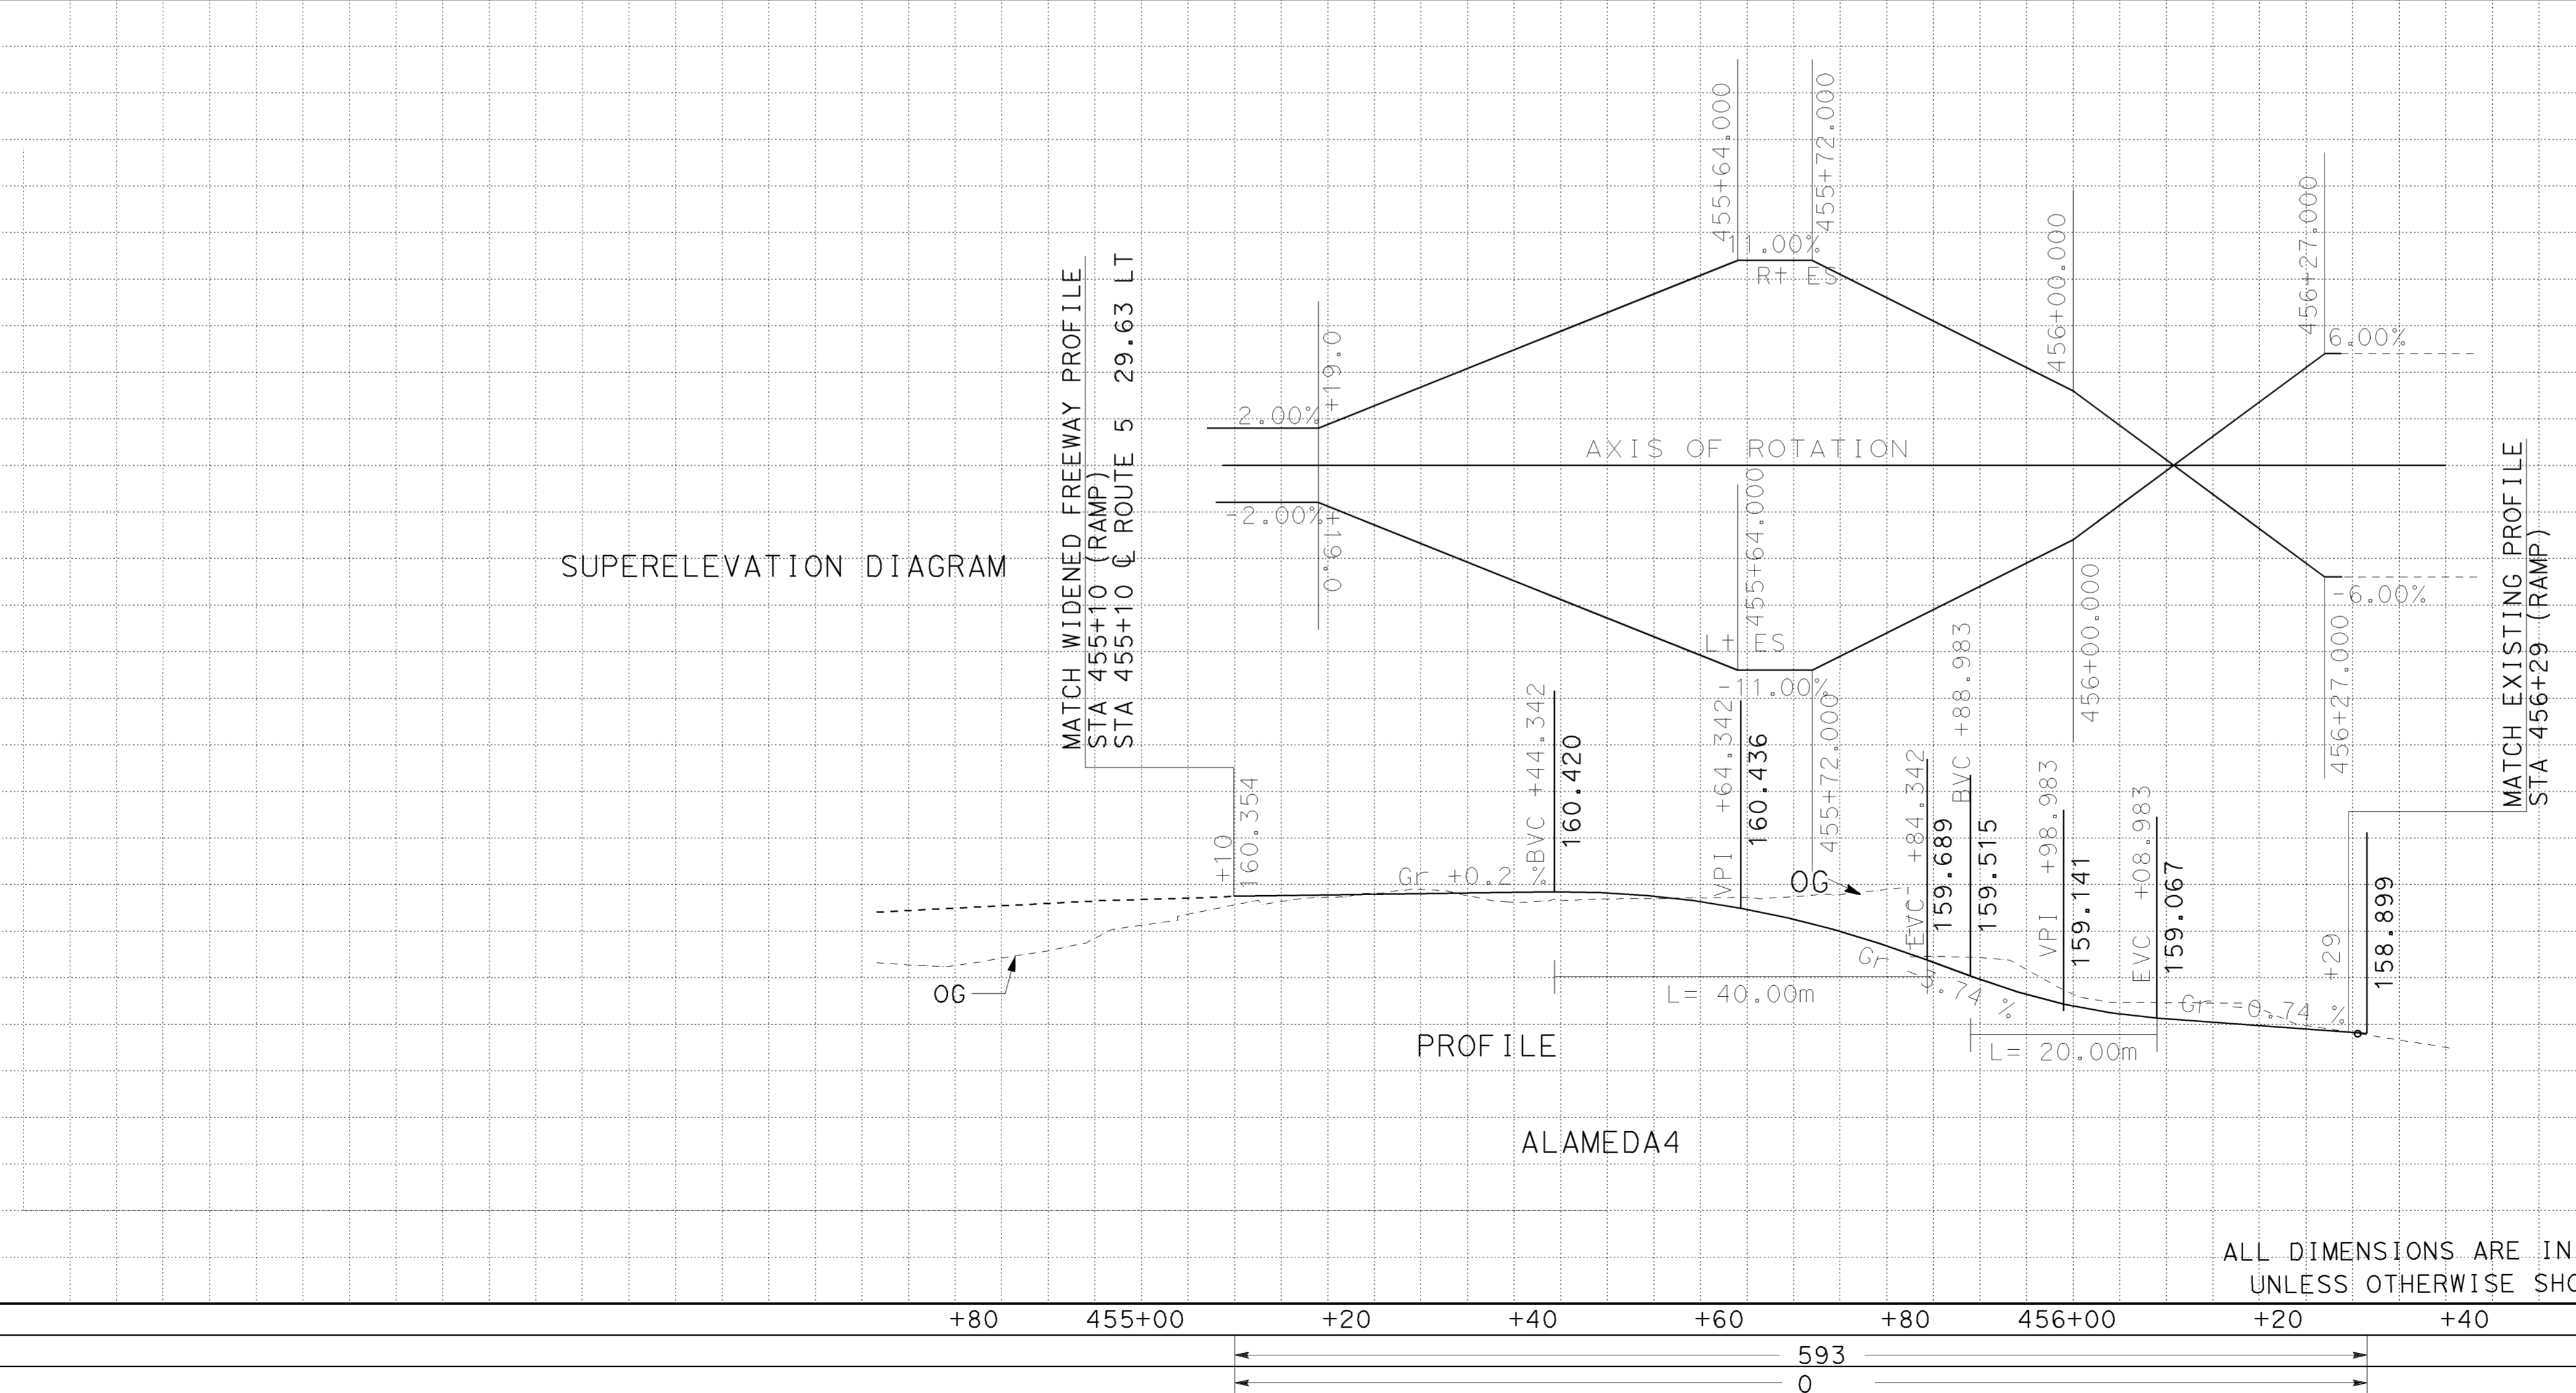
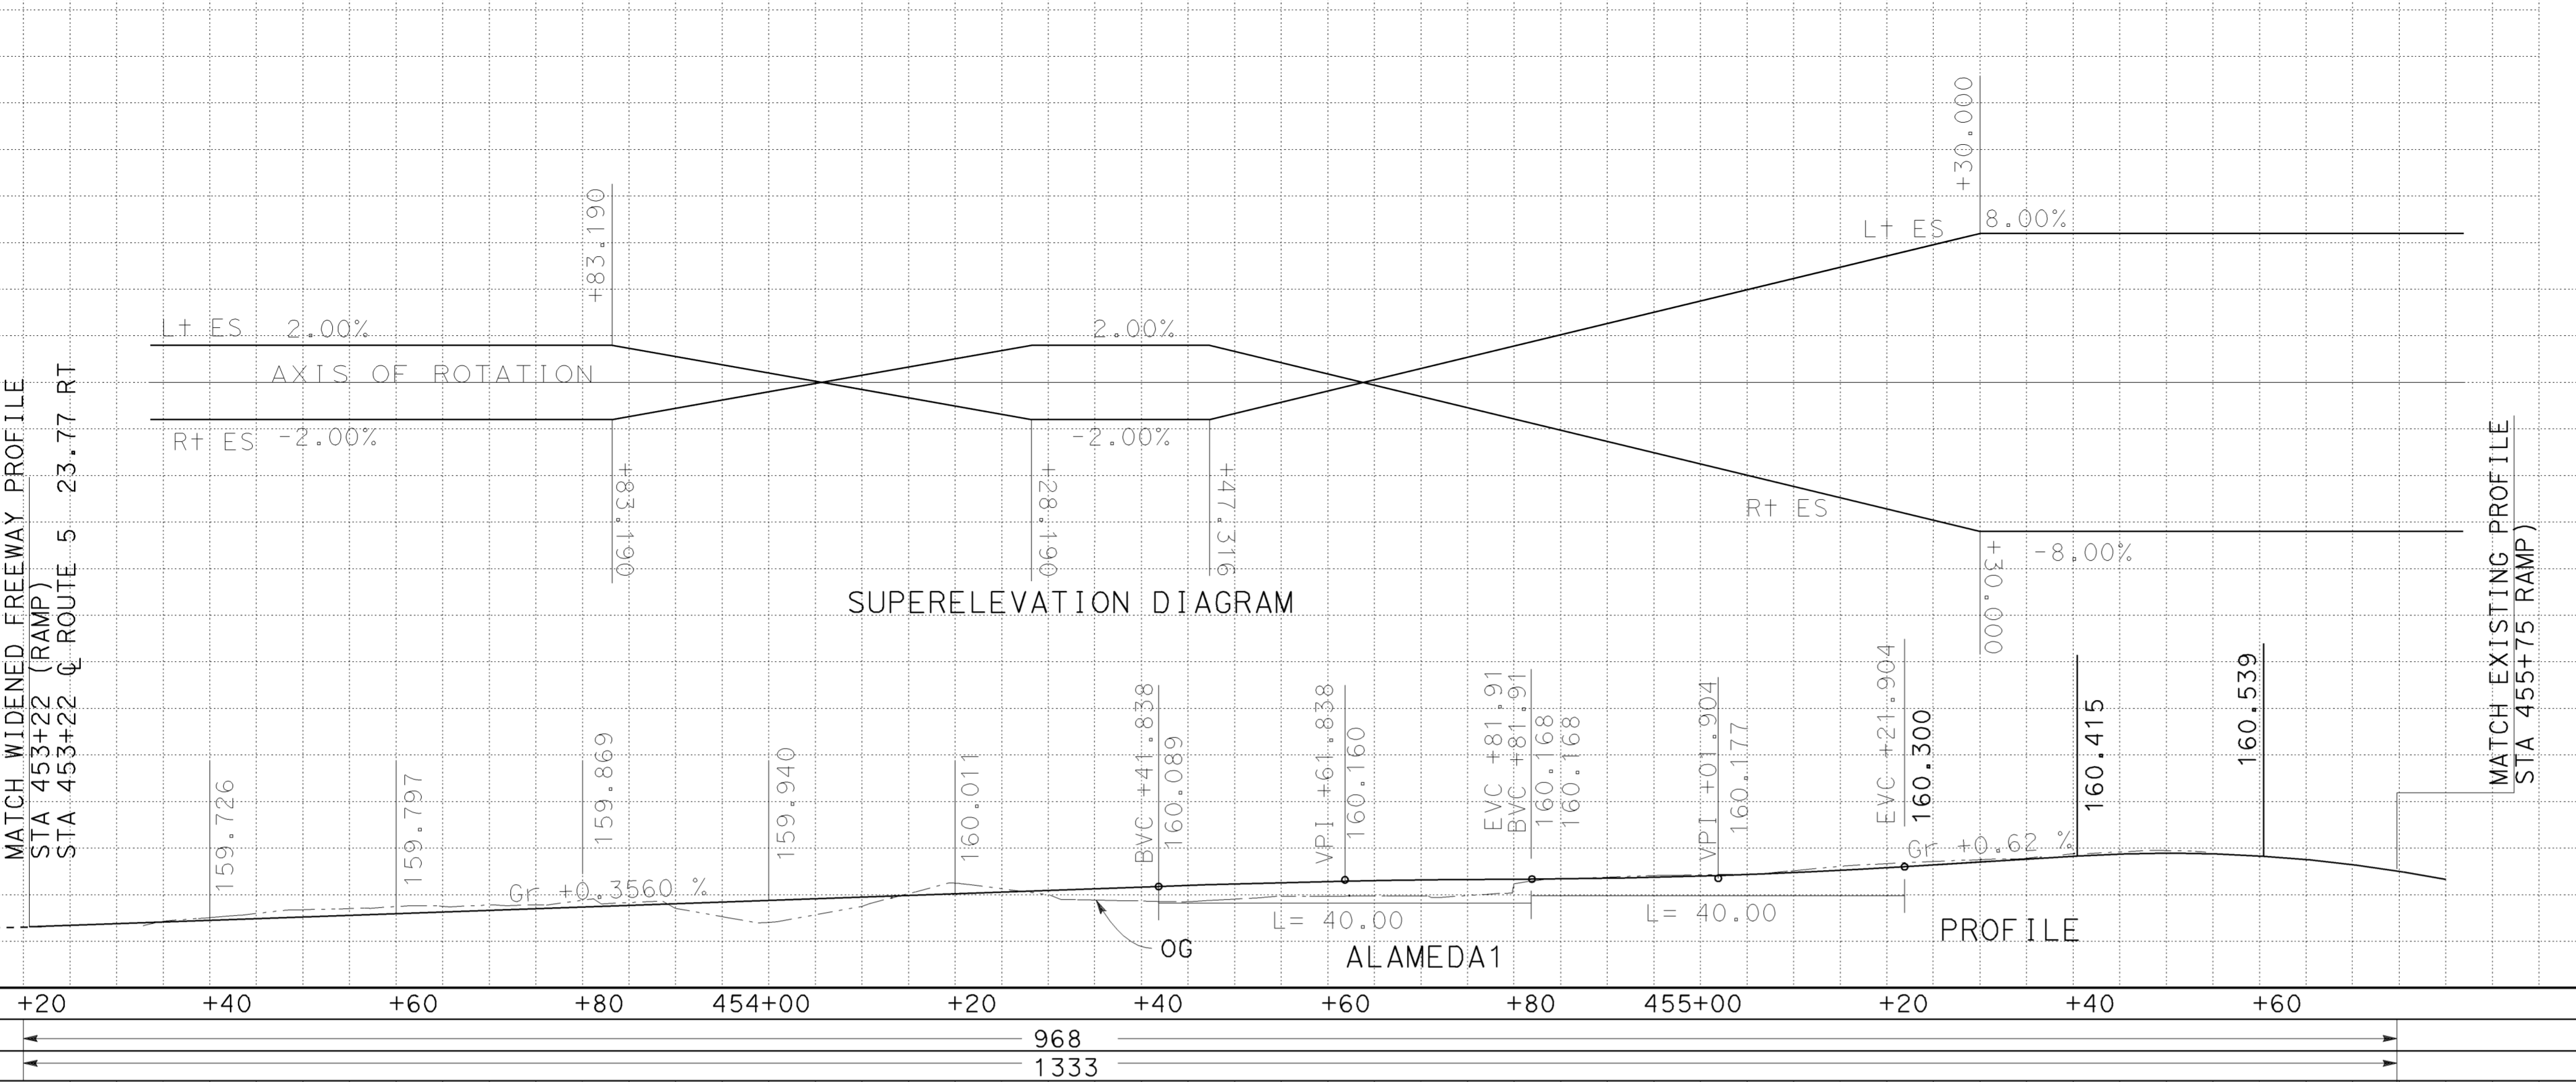
ALL DIMENSIONS ARE IN METERS UNLESS OTHERWISE SHOWN

PROFILE

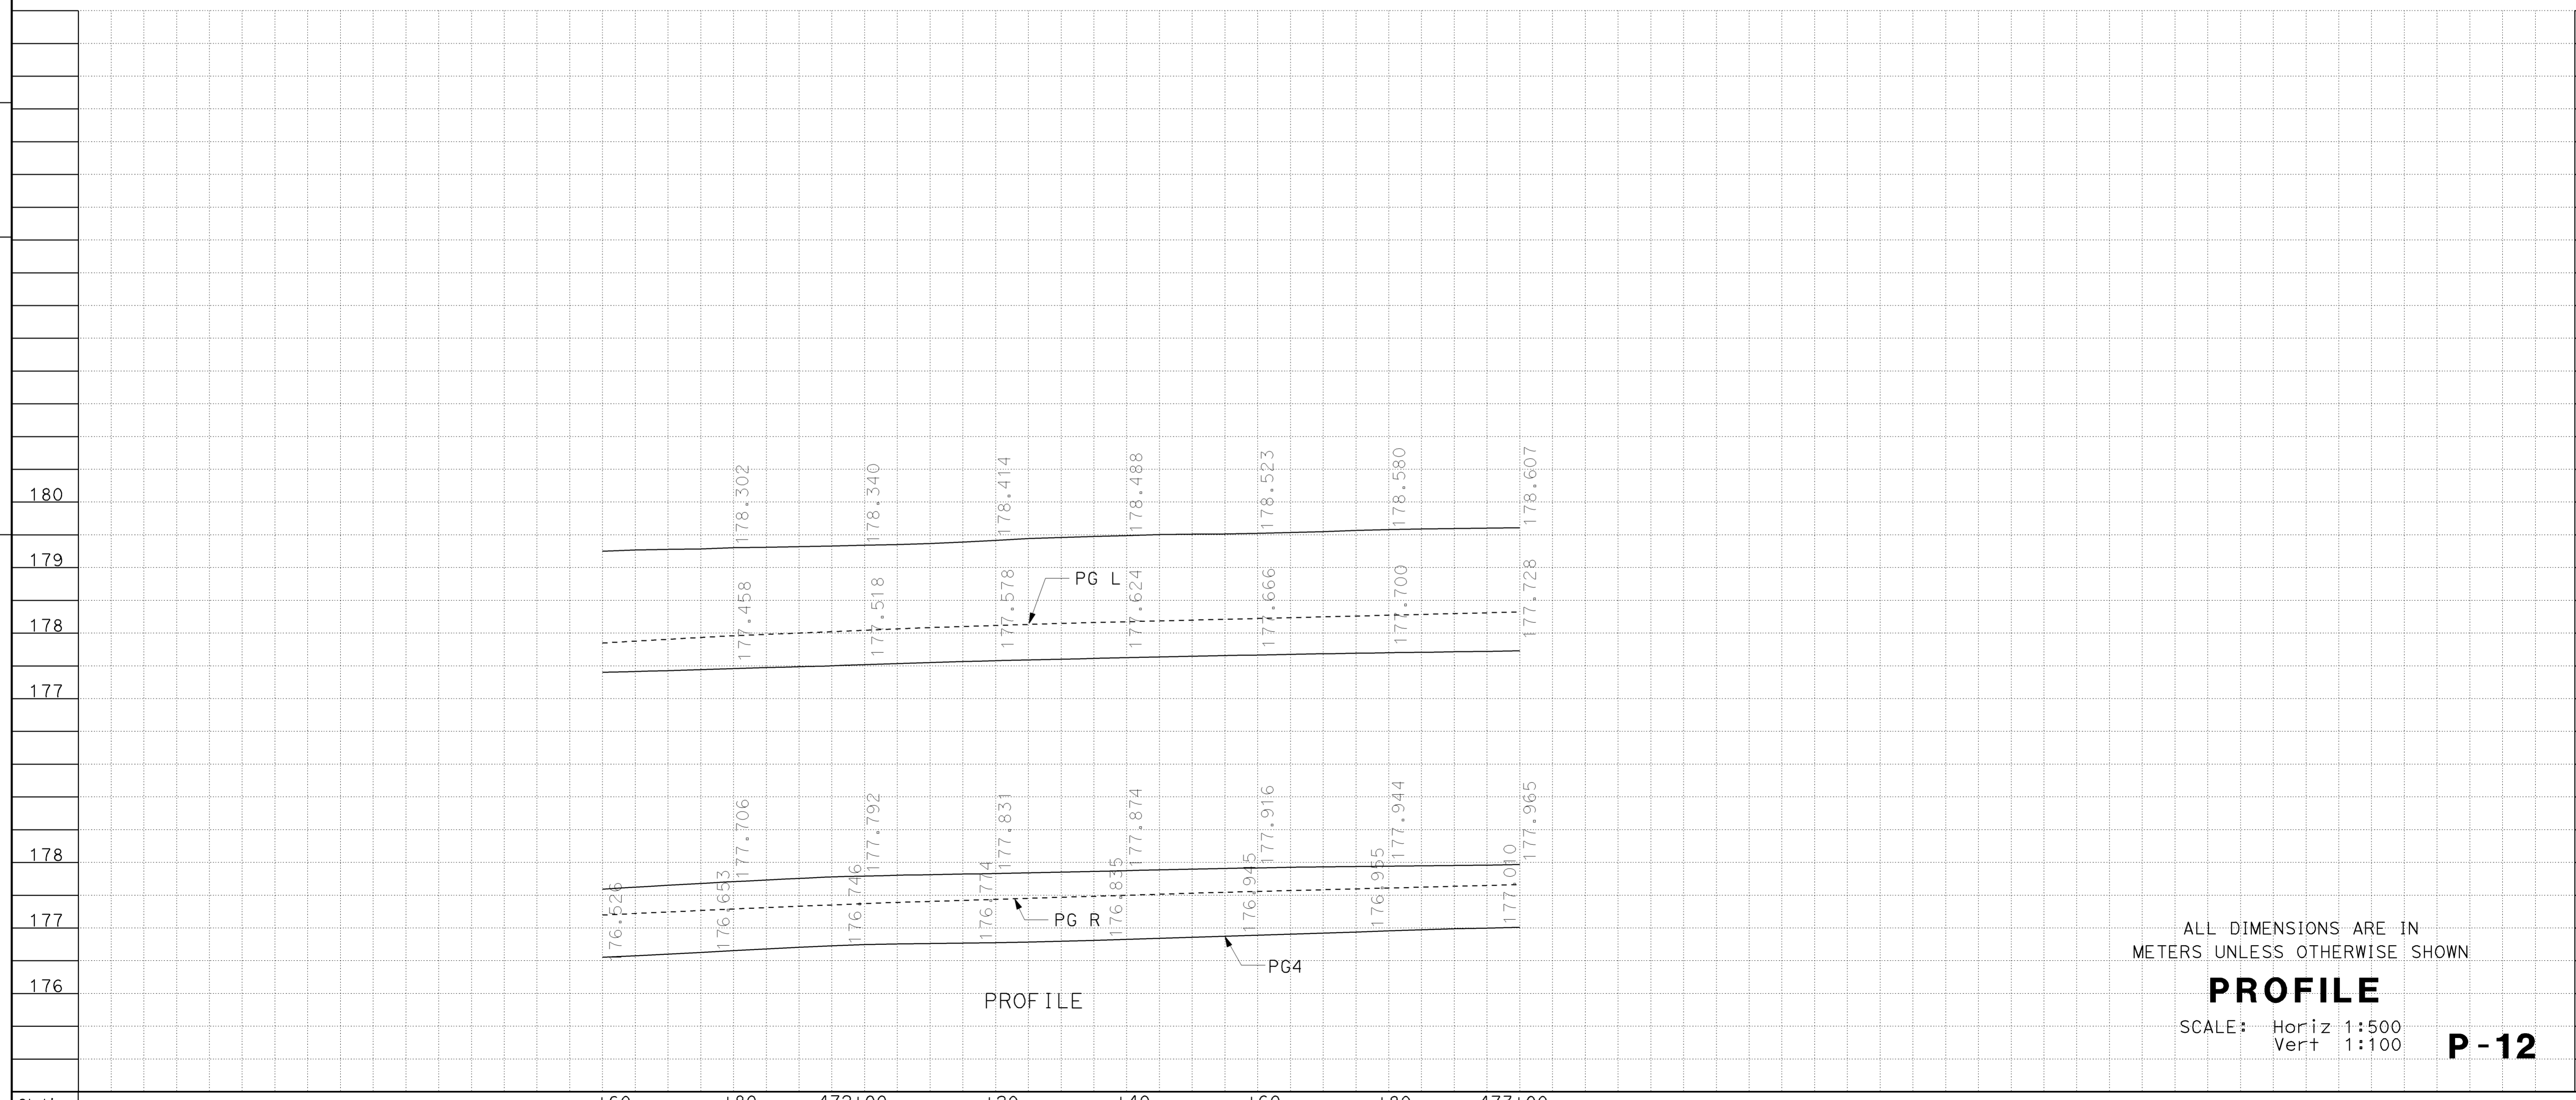SCALE: Horiz 1:500
Vert 1:100

P-12

FUNCTIONAL SUPERVISOR	CELINA AVILES
DAWIT WORKU	MUNSHI MOSHIN
REVISOR	DW
REVISION DATE	12/2008
CHECKED BY	
DESIGNED BY	
Station	
m ³ Exc	
m ³ Emb	



Caltrans
Metric

Dist: 07 COUNTY: LA ROUTE: 5 KILOMETER POST TOTAL PROJECT: 42.8/47.3 SHEET No.: 36 TOTAL SHEETS: 1073

REGISTERED CIVIL ENGINEER: *Munshi Mohsin* DATE: 2-24-09

PLANS APPROVAL DATE: 6-8-09

REGISTERED PROFESSIONAL ENGINEER: **MUNSHI MOHSIN** No. 61916 Exp. 9/30/09 CIVIL STATE OF CALIFORNIA

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PROFILE AND SUPERELEVATION DIAGRAM

SCALE: Horiz 1:500
 Vert 1:50

PS-1

ALL DIMENSIONS ARE IN METERS UNLESS OTHERWISE SHOWN

STATE OF CALIFORNIA - DEPARTMENT OF TRANSPORTATION
Caltrans OFFICE OF DESIGN D

FUNCTIONAL SUPERVISOR	CELINA AVILES		
DESIGNED BY	171		
CHECKED BY	171		
REVISIONS			
NO.	DATE	BY	DESCRIPTION
1	12/2008	DW	

REVISIONS	
NO.	DATE
1	12/2008

REVISIONS	
NO.	DATE
1	12/2008

REVISIONS	
NO.	DATE
1	12/2008

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NO.	DATE
1	12/2008




Dist	COUNTY	ROUTE	KILOMETER POST TOTAL PROJECT	SHEET No.	TOTAL SHEETS
07	LA	5	42.8/47.3	37	1073

2-24-09
 REGISTERED CIVIL ENGINEER DATE

6-8-09
 PLANS APPROVAL DATE

MUNSHI MOHSIN
 No. 61916
 Exp. 9/30/09
 CIVIL
 STATE OF CALIFORNIA

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PROFILE AND SUPERELEVATION DIAGRAM

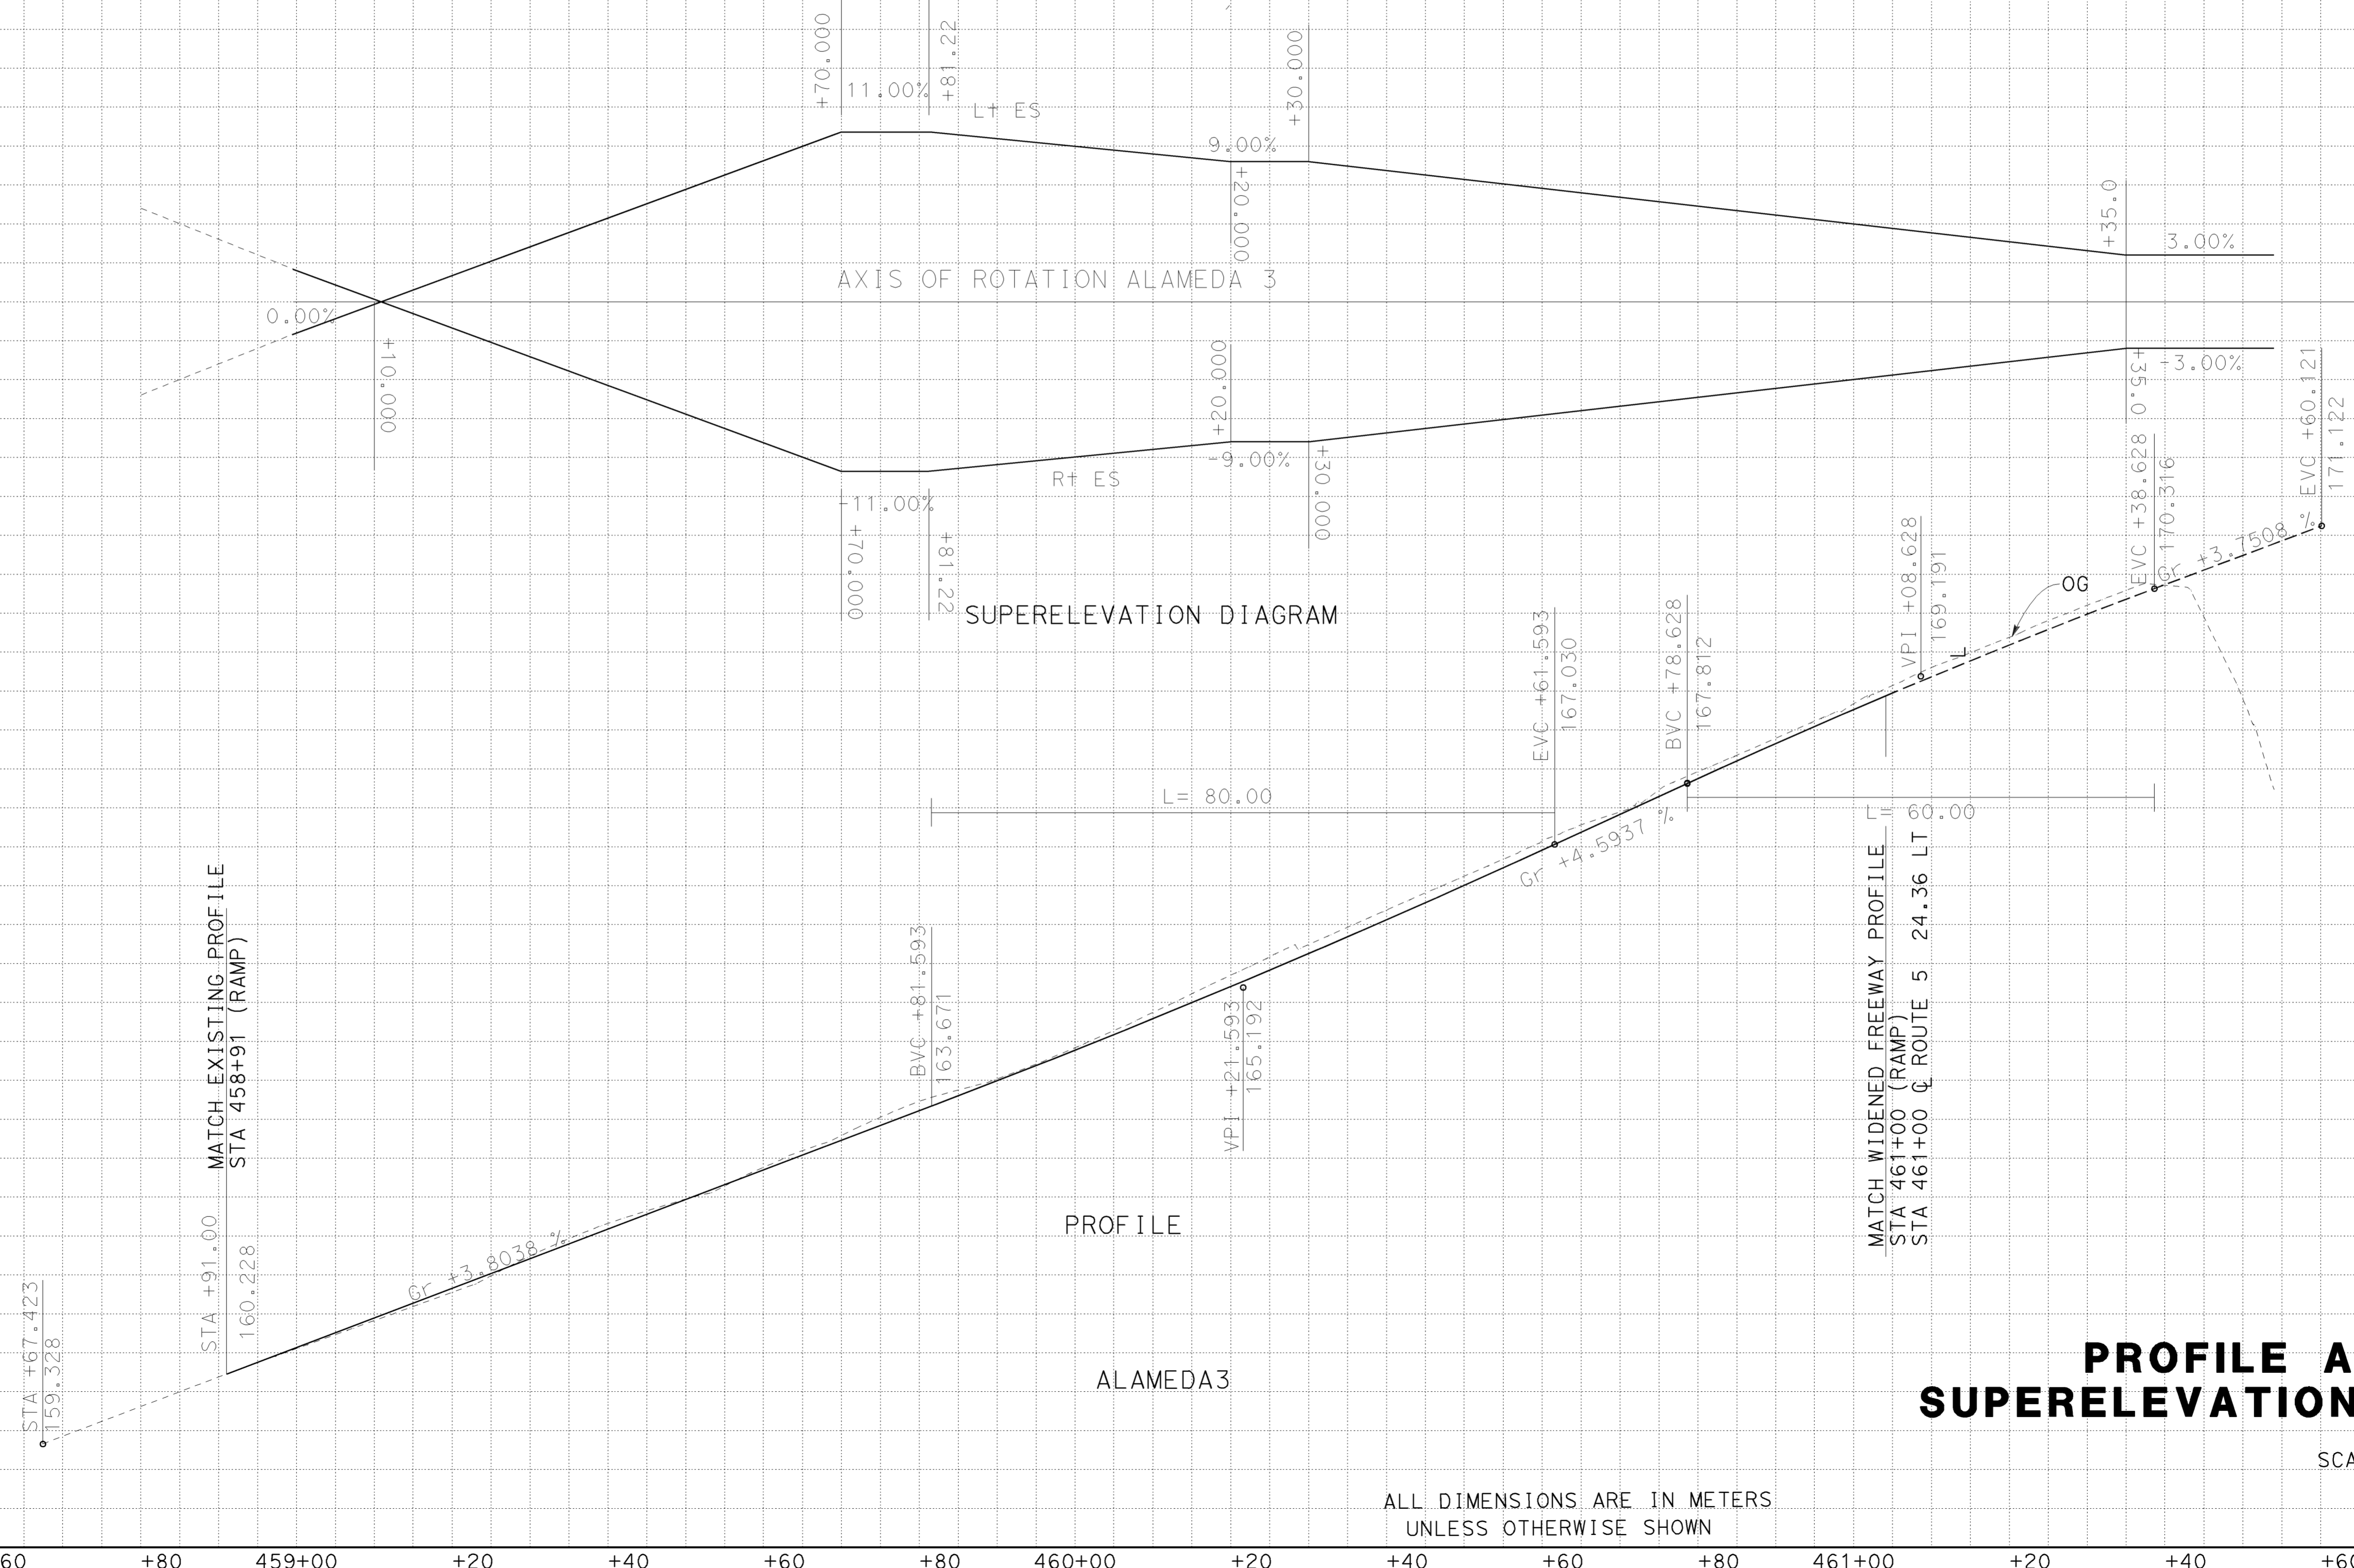SCALE: Horiz 1:500
 Vert 1:50


PS-2

ALL DIMENSIONS ARE IN METERS
 UNLESS OTHERWISE SHOWN

Station	+60	+80	459+00	+20	+40	+60	+80	460+00	+20	+40	+60	+80	461+00	+20	+40	+60	+80
Exc								1143									
Emb								913									

STATE OF CALIFORNIA - DEPARTMENT OF TRANSPORTATION
Caltrans OFFICE OF DESIGN D

FUNCTIONAL SUPERVISOR	CELINA AVILES
DAWIT WORKU	MUNSHI MOSHIN
REVISOR	DW
DATE REVISOR	12/2008
CHECKED BY	
DESIGNED BY	
171	
170	
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Station	+60 +80 459+00 +20 +40 +60 +80 460+00 +20 +40 +60 +80 461+00 +20 +40 +60 +80
Exc	
Emb	

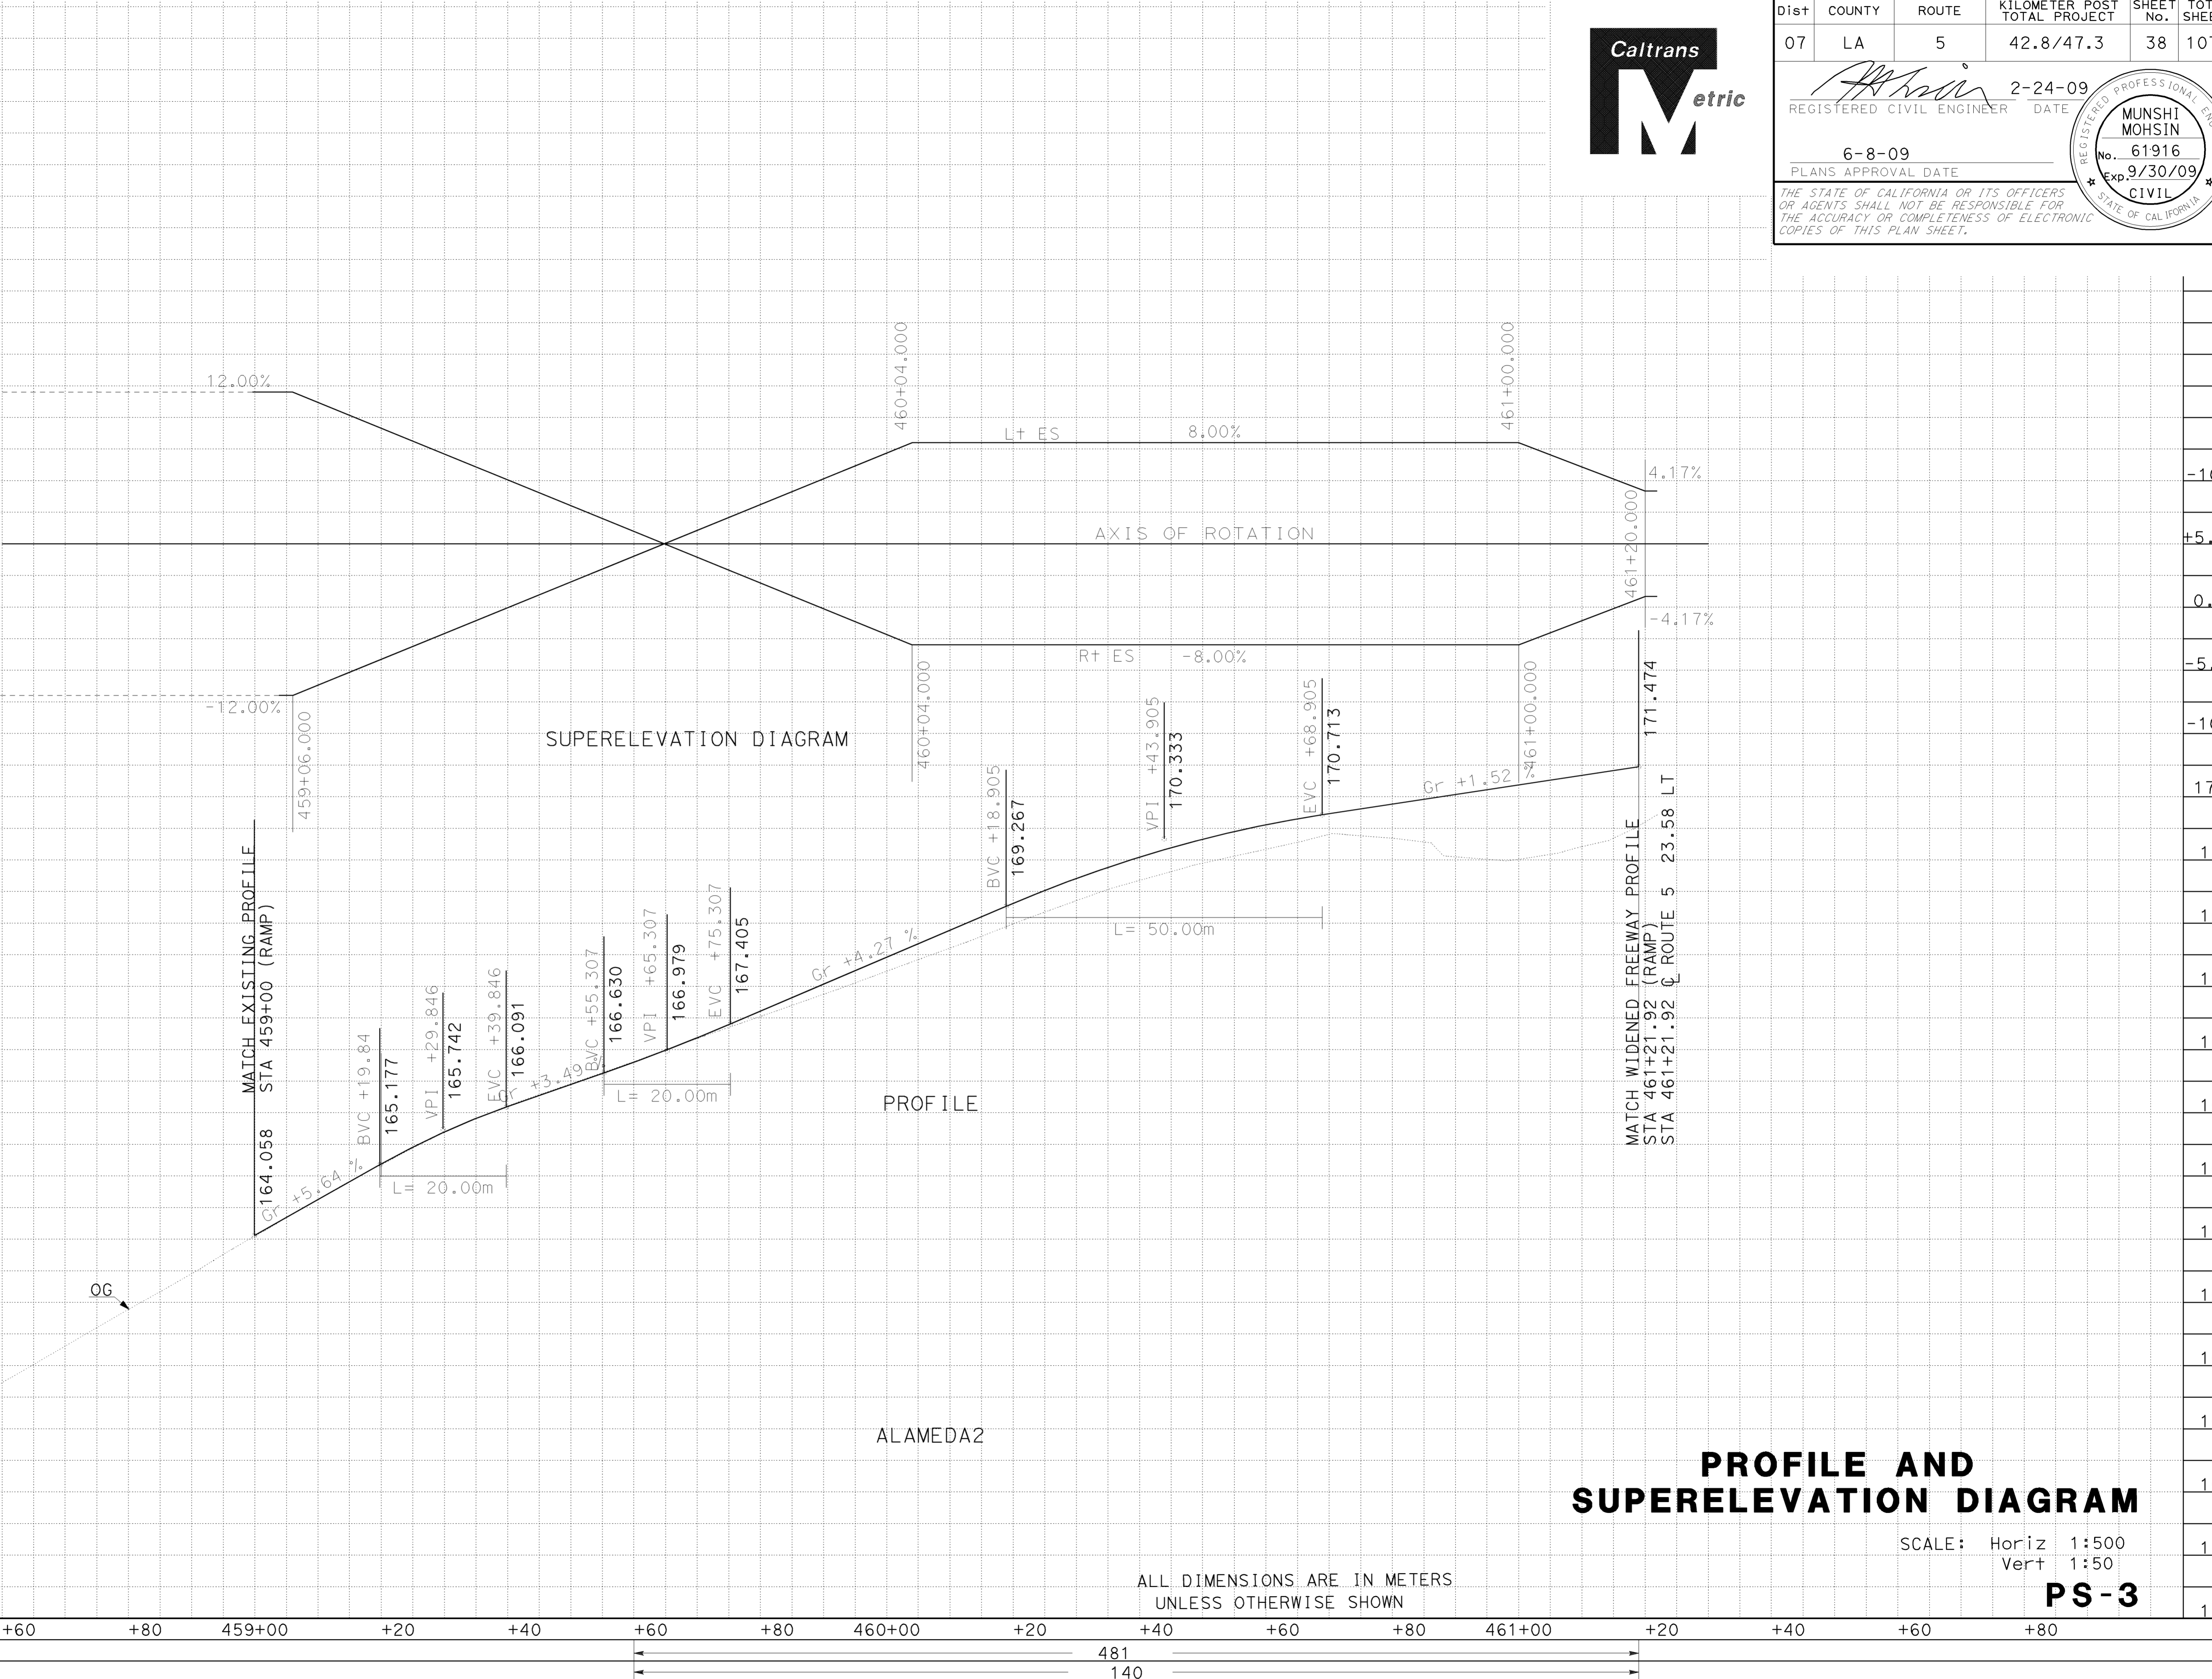

Dist	COUNTY	ROUTE	KILOMETER POST TOTAL PROJECT	SHEET No.	TOTAL SHEETS
07	LA	5	42.8/47.3	38	1073



REGISTERED CIVIL ENGINEER DATE 2-24-09

PLANS APPROVAL DATE 6-8-09

MUNSHI MOHSIN No. 61916 Exp. 9/30/09 CIVIL

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STATE OF CALIFORNIA - DEPARTMENT OF TRANSPORTATION
Caltrans OFFICE OF DESIGN D

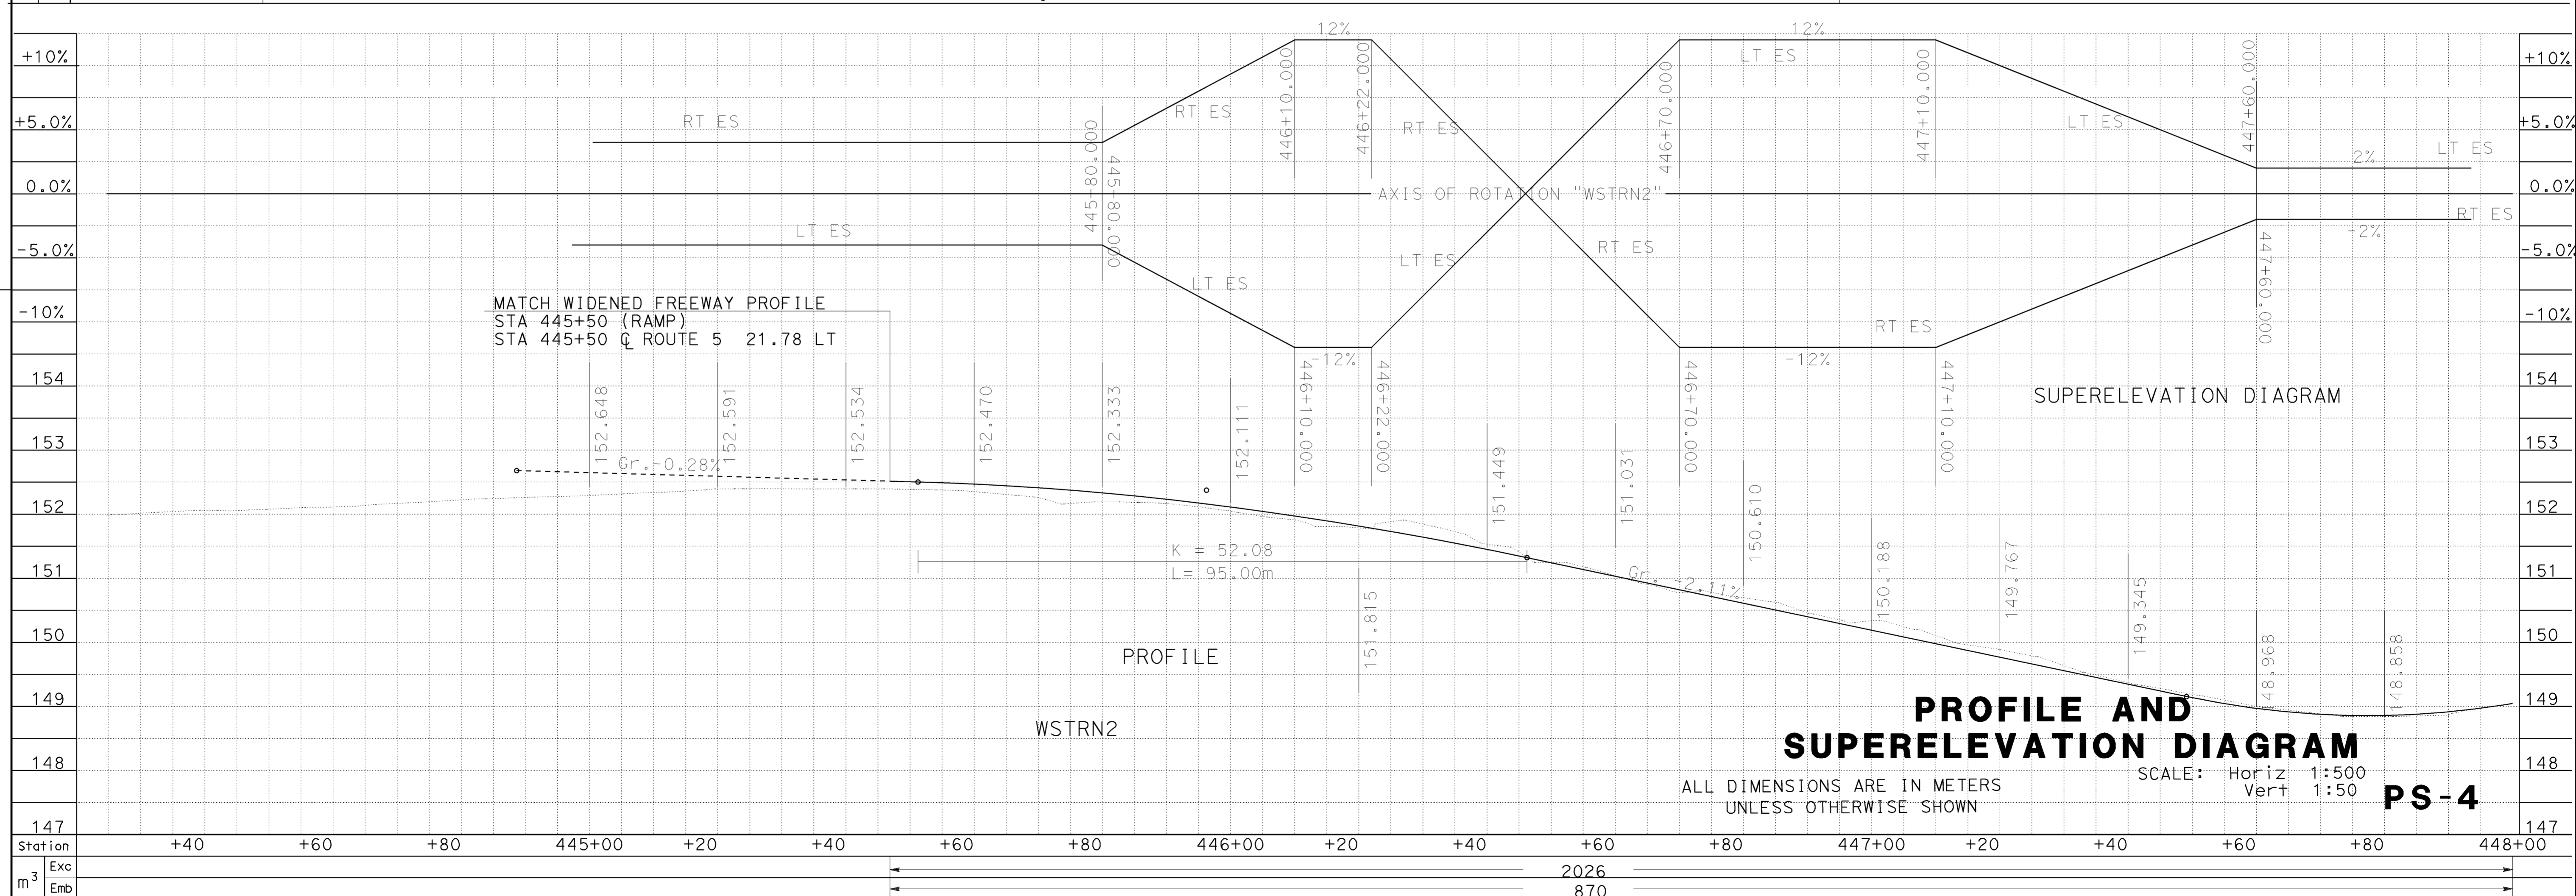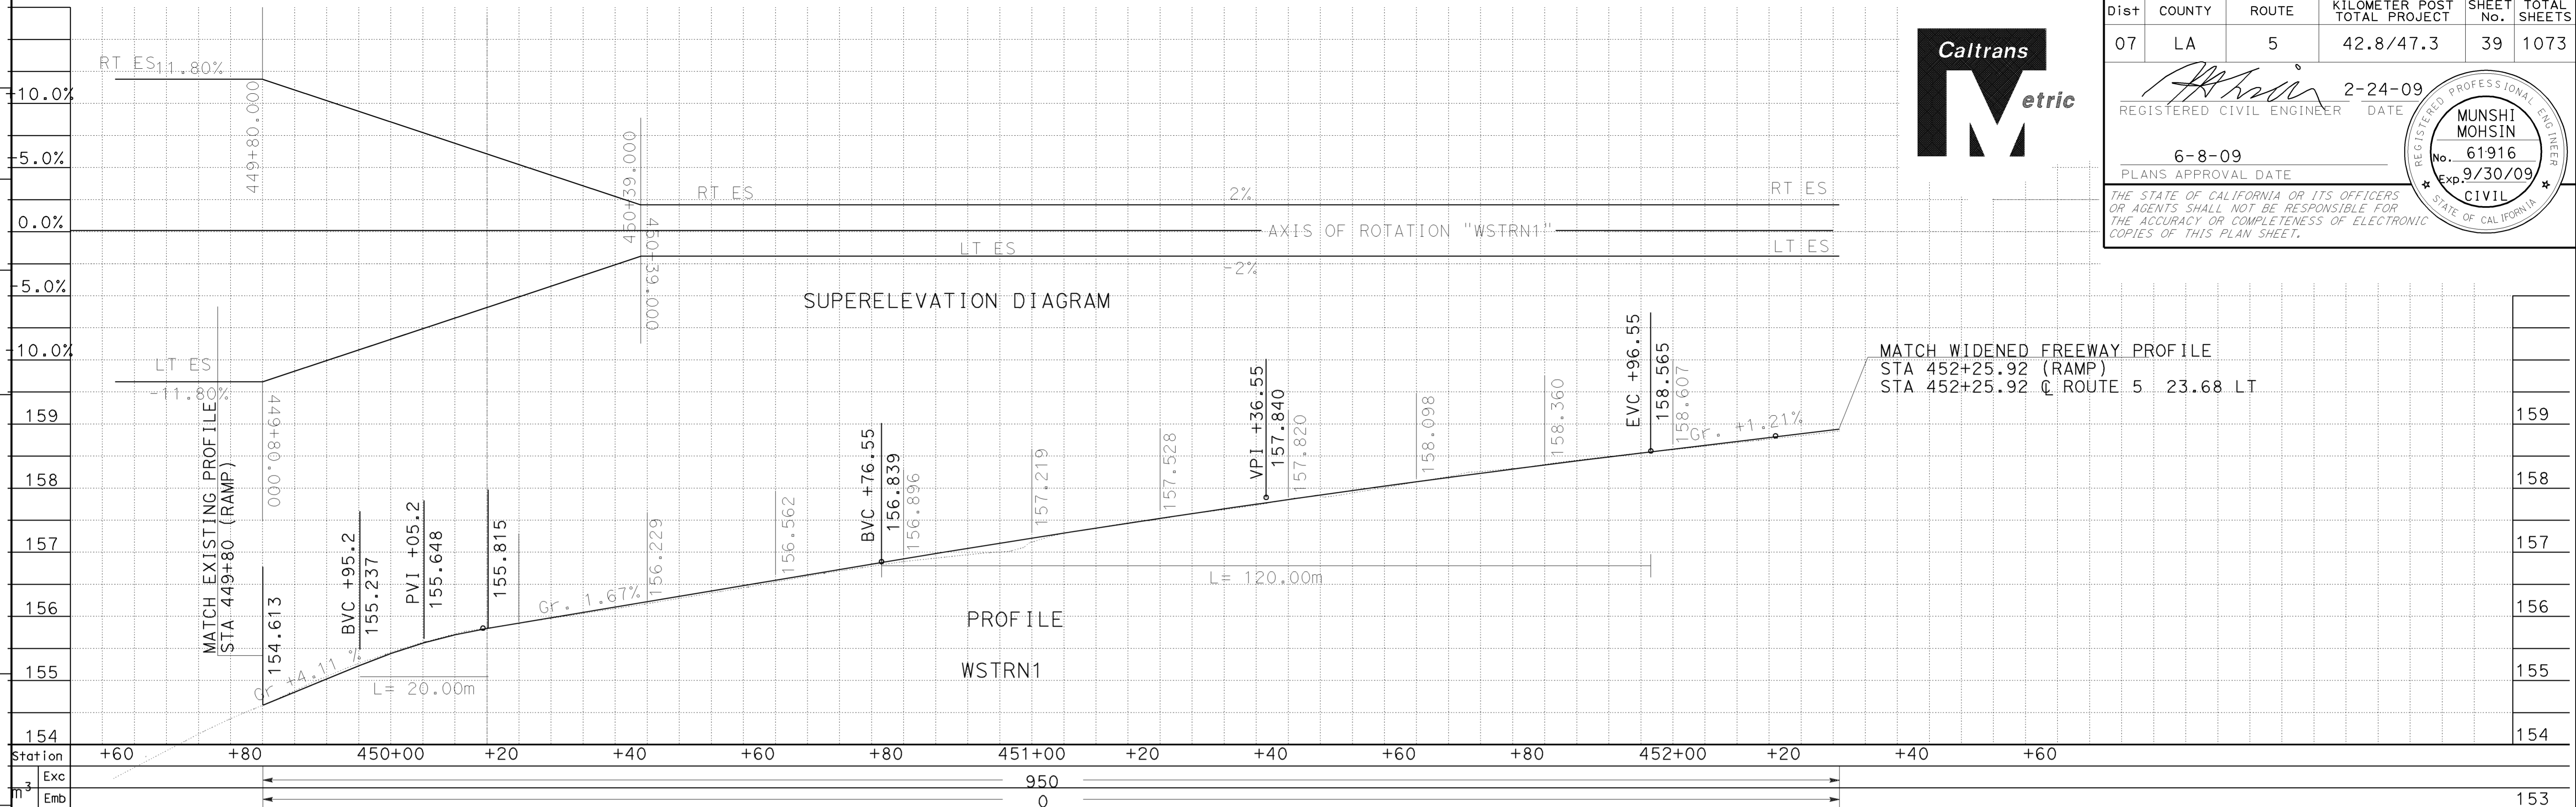

PROFILE AND SUPERELEVATION DIAGRAM


ALL DIMENSIONS ARE IN METERS UNLESS OTHERWISE SHOWN

SCALE: Horiz 1:500
Vert 1:50


PS-4



Dist	COUNTY	ROUTE	KILOMETER POST TOTAL PROJECT	SHEET No.	TOTAL SHEETS
07	LA	5	42.8/47.3	39	1073
			REGISTERED CIVIL ENGINEER	DATE	
			6-8-09	PLANS APPROVAL DATE	
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STATE OF CALIFORNIA - DEPARTMENT OF TRANSPORTATION
Caltrans OFFICE OF DESIGN D

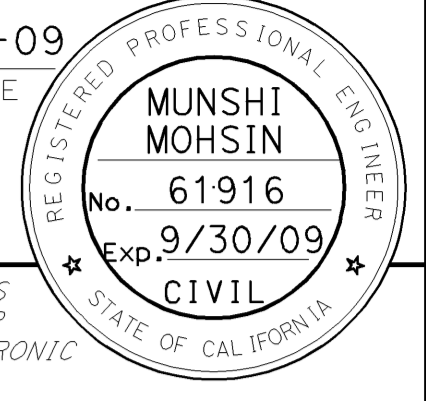

PROFILE AND SUPERELEVATION DIAGRAM
 SCALE: Horiz 1:500
 Vert 1:50
PS-5

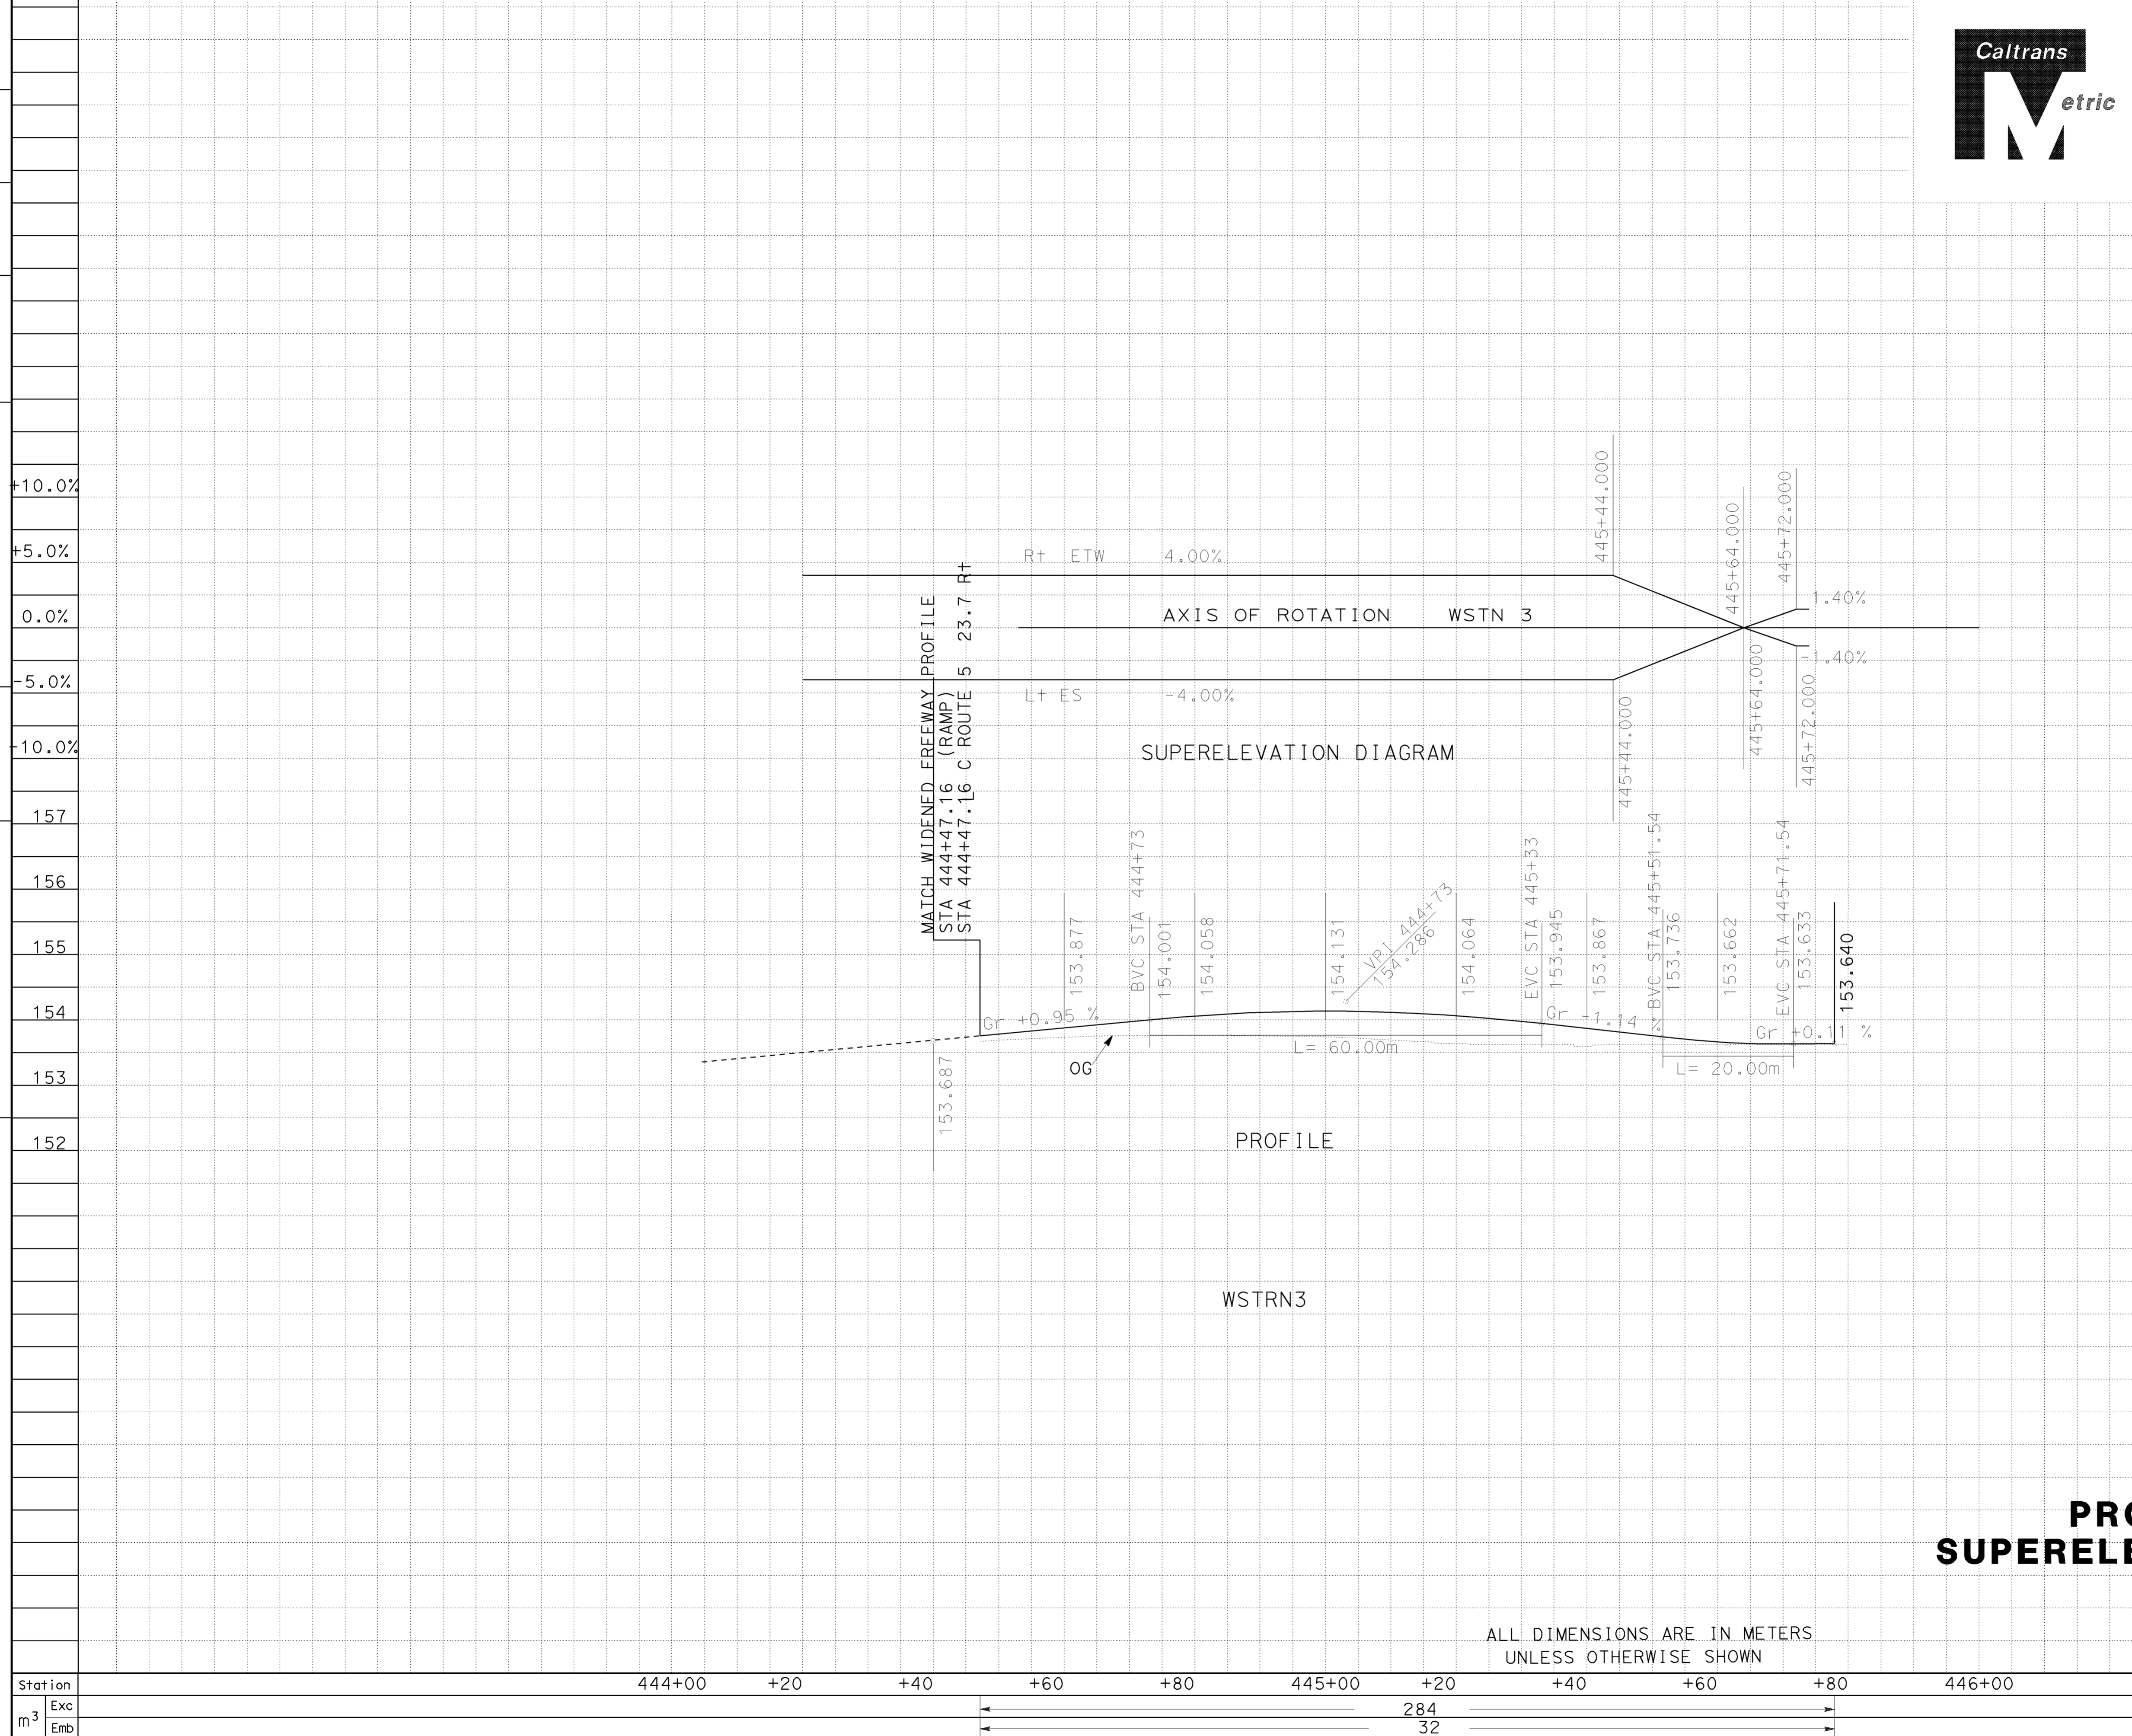ALL DIMENSIONS ARE IN METERS
 UNLESS OTHERWISE SHOWN

Station	444+00	+20	+40	+60	+80	445+00	+20	+40	+60	+80	446+00
Exc											
Emb											



USERNAME => trphits
 DGN FILE => 712184fa017.dgn

Dist	COUNTY	ROUTE	KILOMETER POST TOTAL PROJECT	SHEET No.	TOTAL SHEETS
07	LA	5	42.8/47.3	40	1073

2-24-09
 REGISTERED CIVIL ENGINEER DATE

6-8-09
 PLANS APPROVAL DATE

MUNSHI MOHSIN
 No. 61916
 Exp. 9/30/09
 CIVIL
 STATE OF CALIFORNIA






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FUNCTIONAL SUPERVISOR	CELINA AVILES
DAWIT WORKU	MUNSHI MOSHIN
REVISOR	DW
DATE	12/2008
CHECKED BY	
DESIGNED BY	
STATION	175
	174
	173
	172
	171

Dist	COUNTY	ROUTE	KILOMETER TOTAL PROJECT	POST TOTAL SHEETS	SHEET No.	TOTAL SHEETS
07	LA	5	42.8/47.3	41	1073	1073

REGISTERED CIVIL ENGINEER
 2-24-09
 DATE
 6-8-09
 PLANS APPROVAL DATE
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PROFILE AND SUPERELEVATION DIAGRAM PS-6

ALL DIMENSIONS ARE IN METERS UNLESS OTHERWISE SHOWN

SCALE Horiz 1:500 Vert 1:50

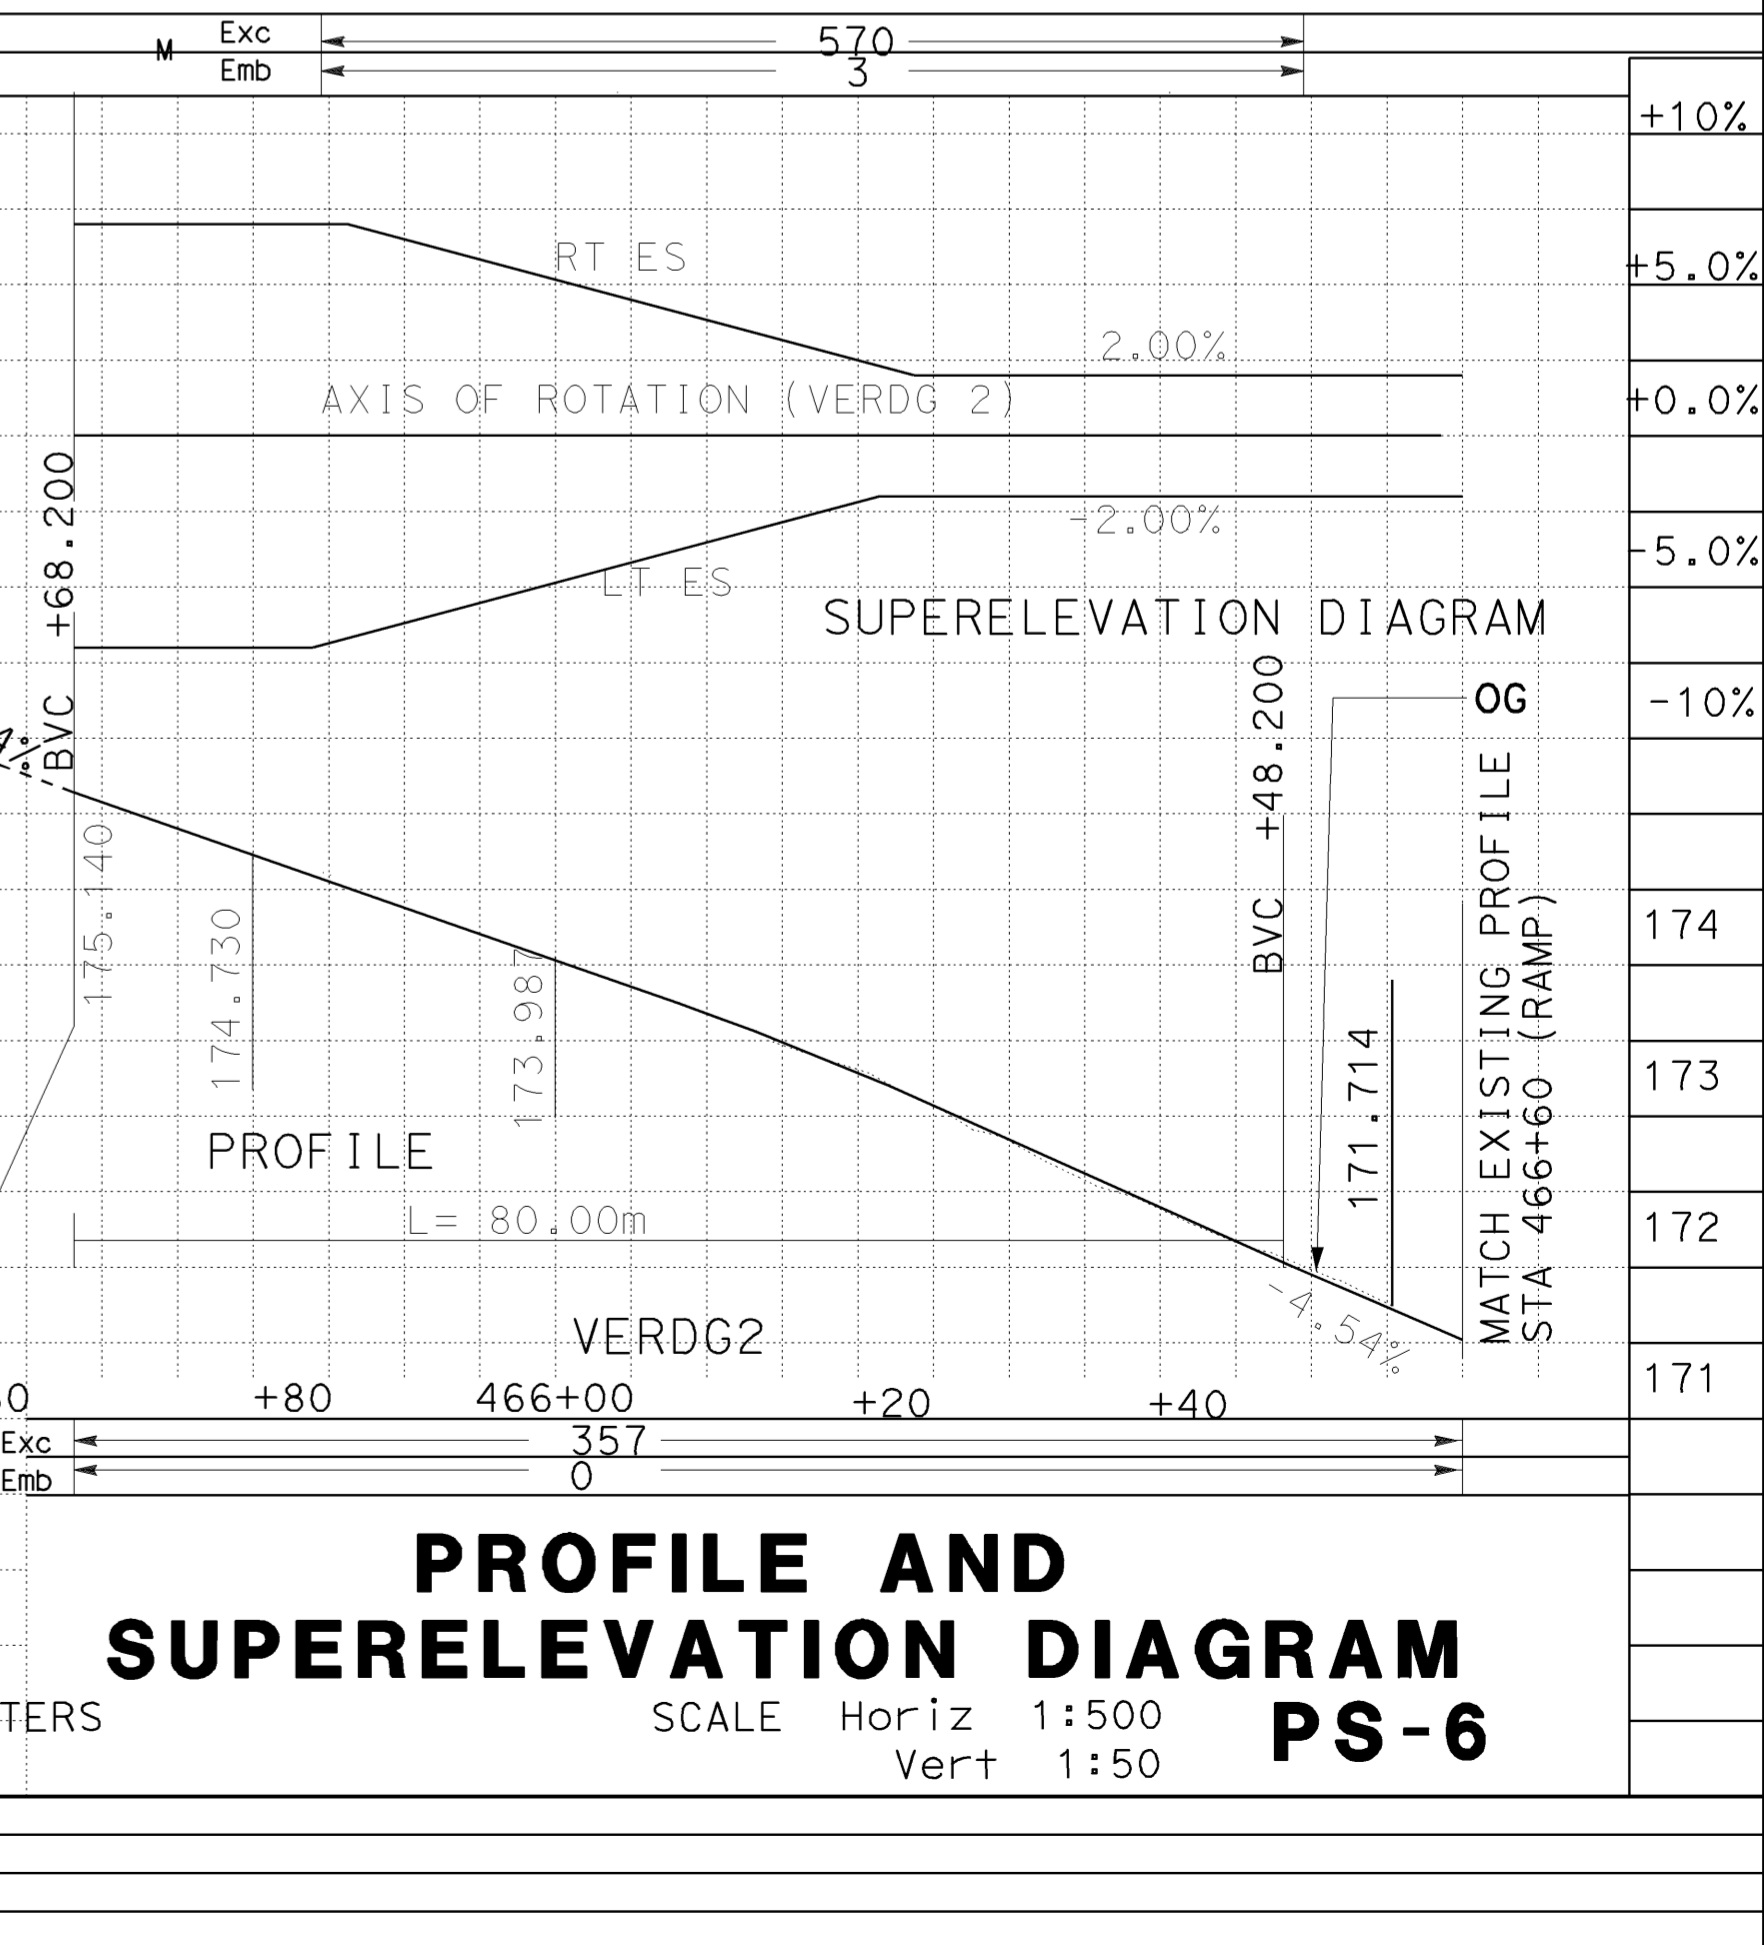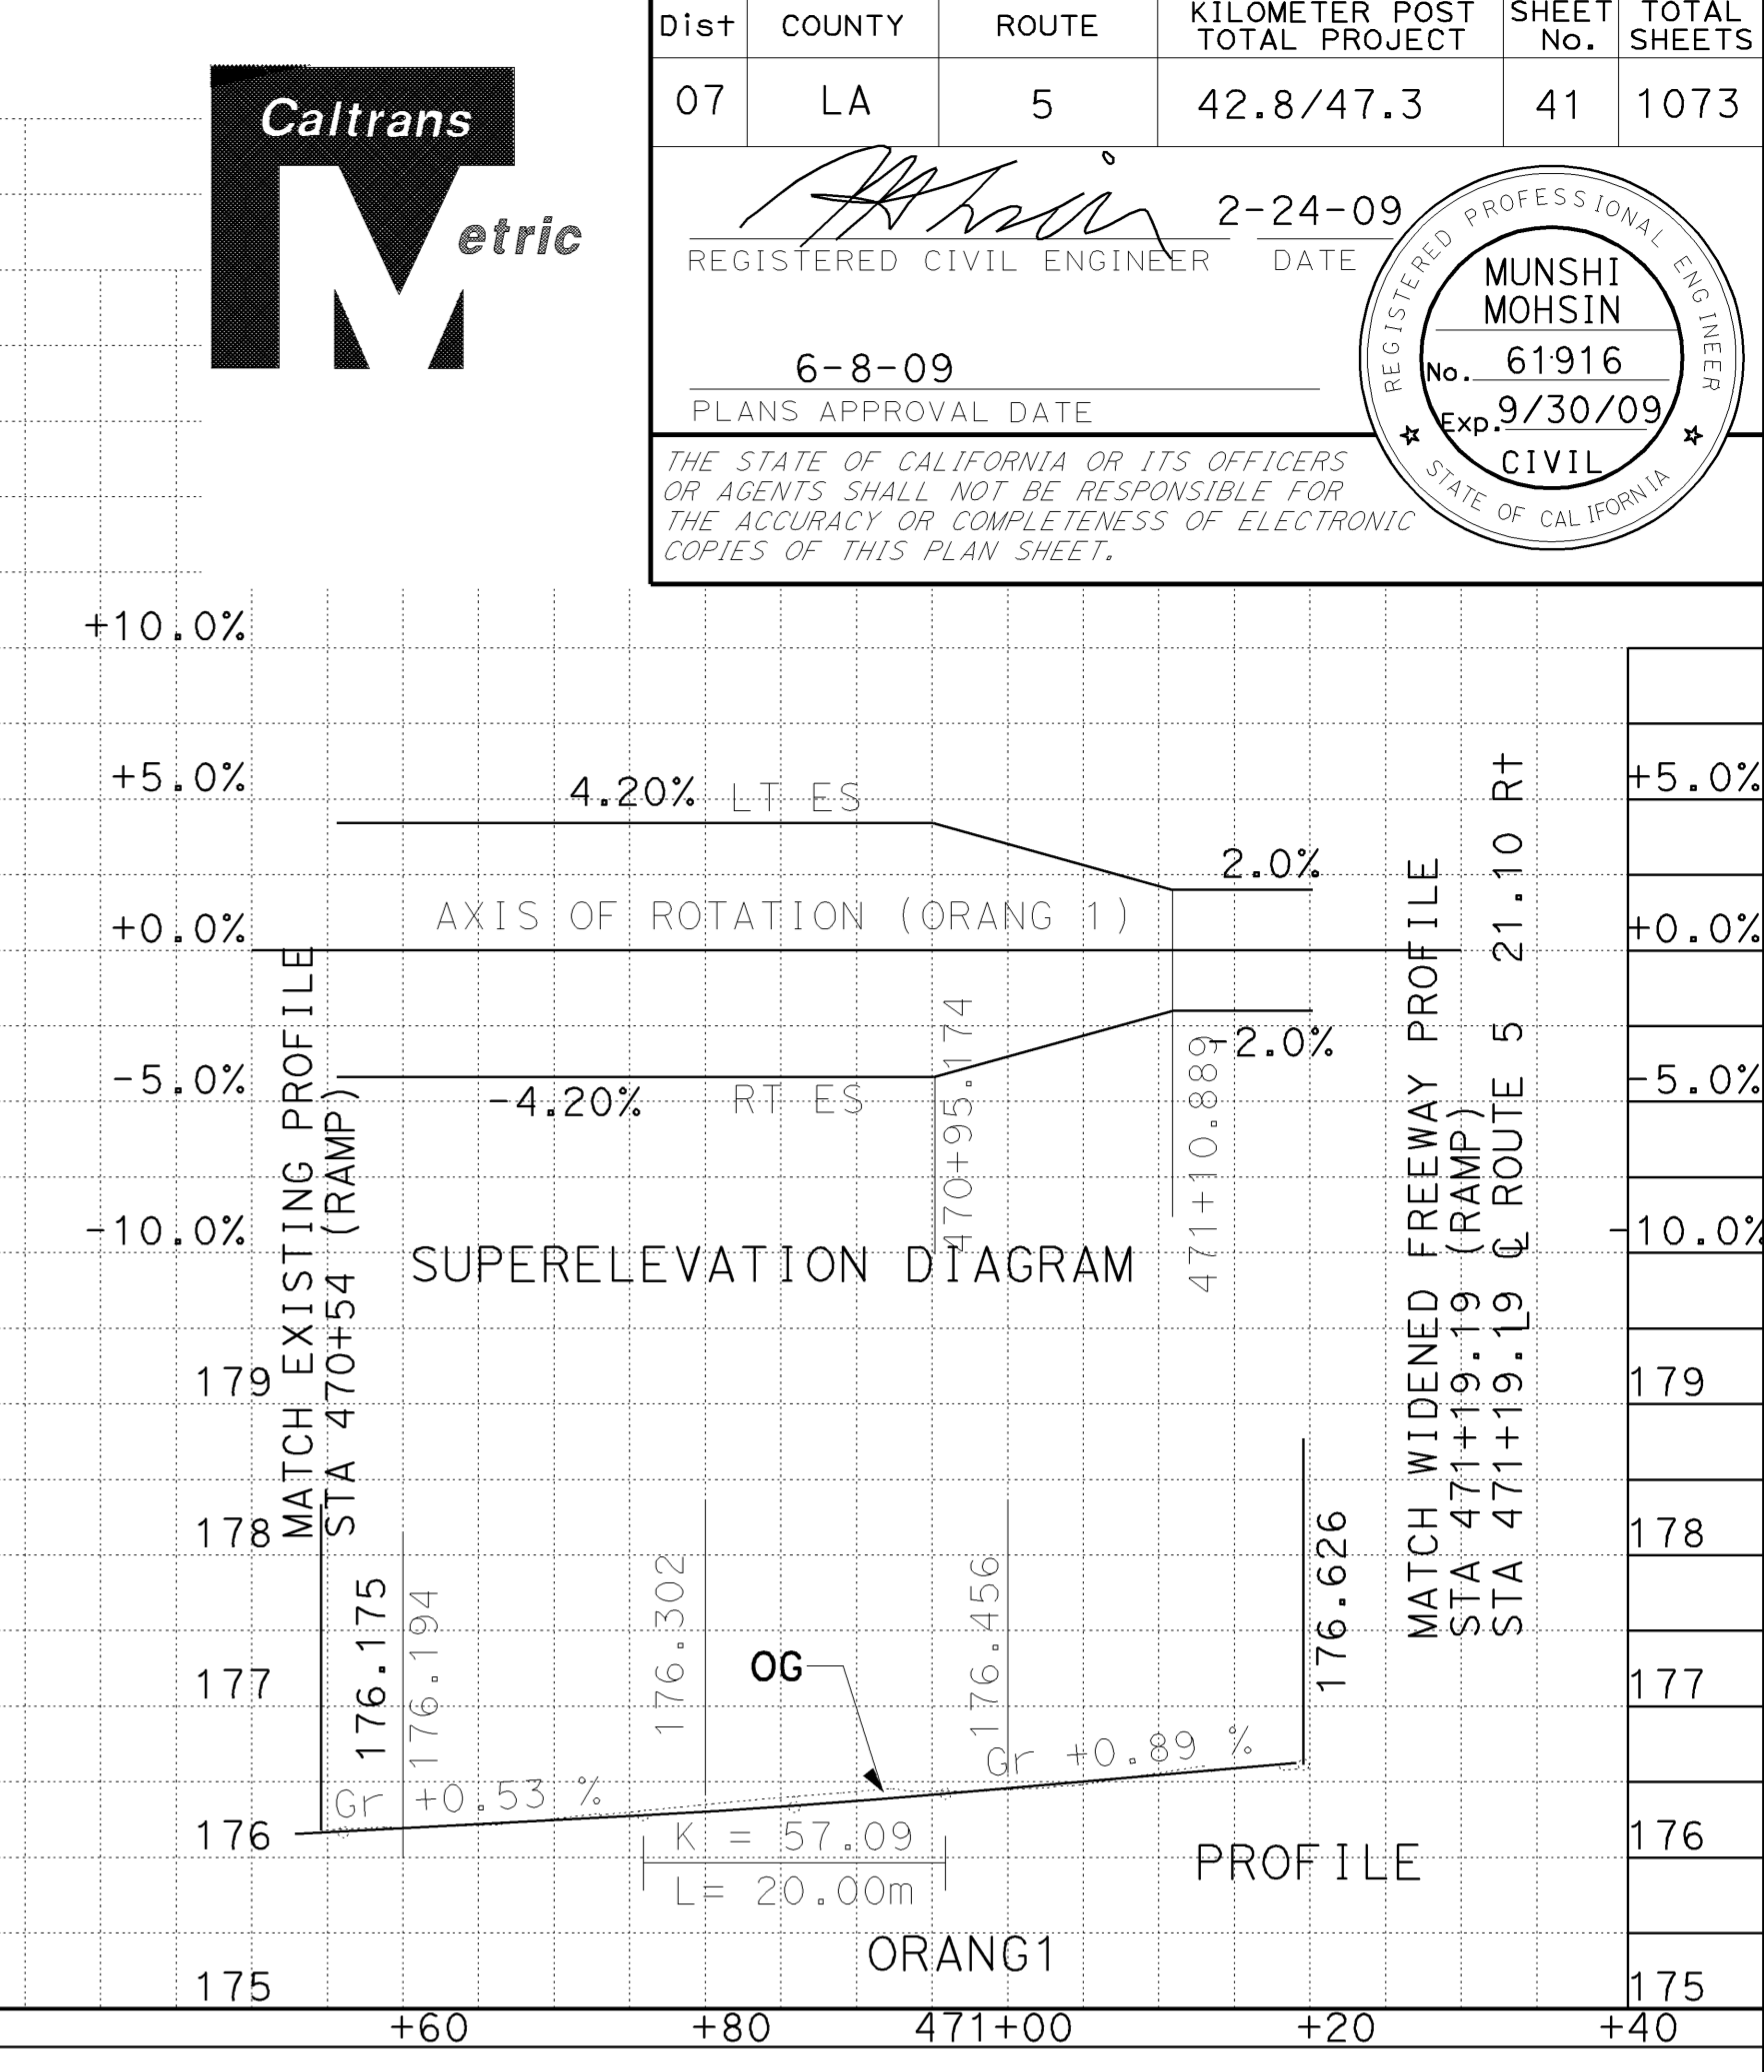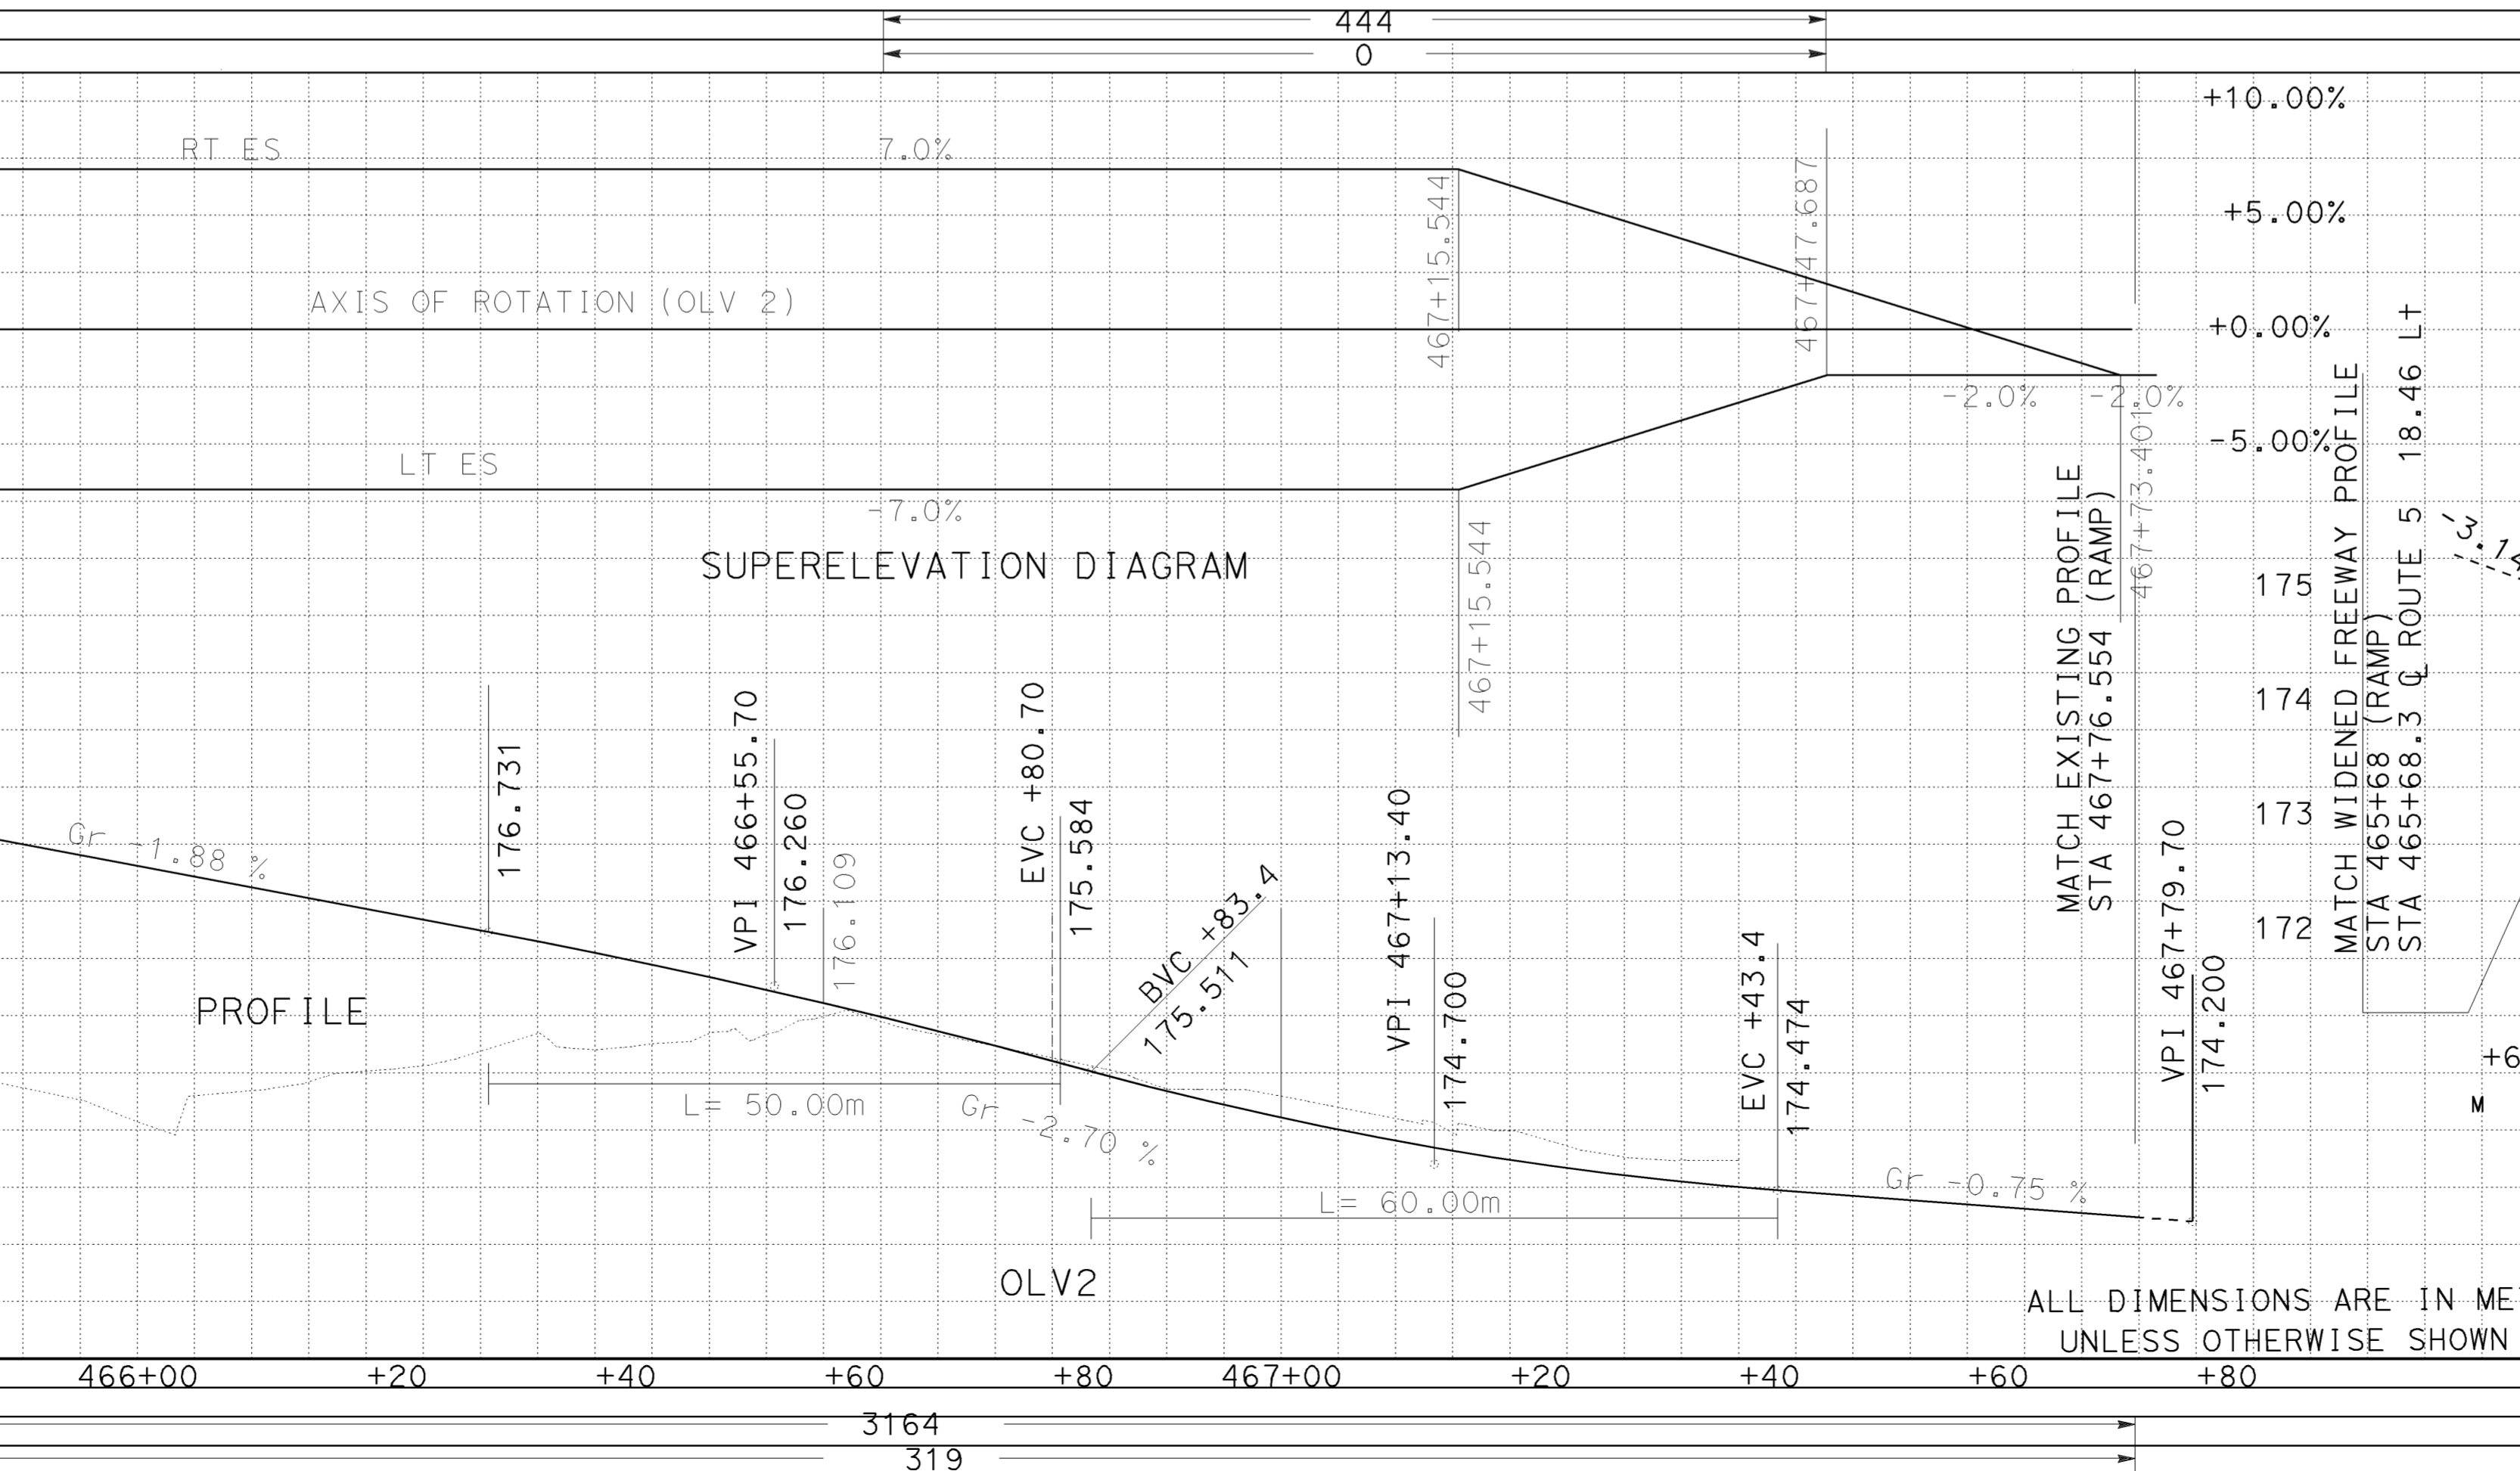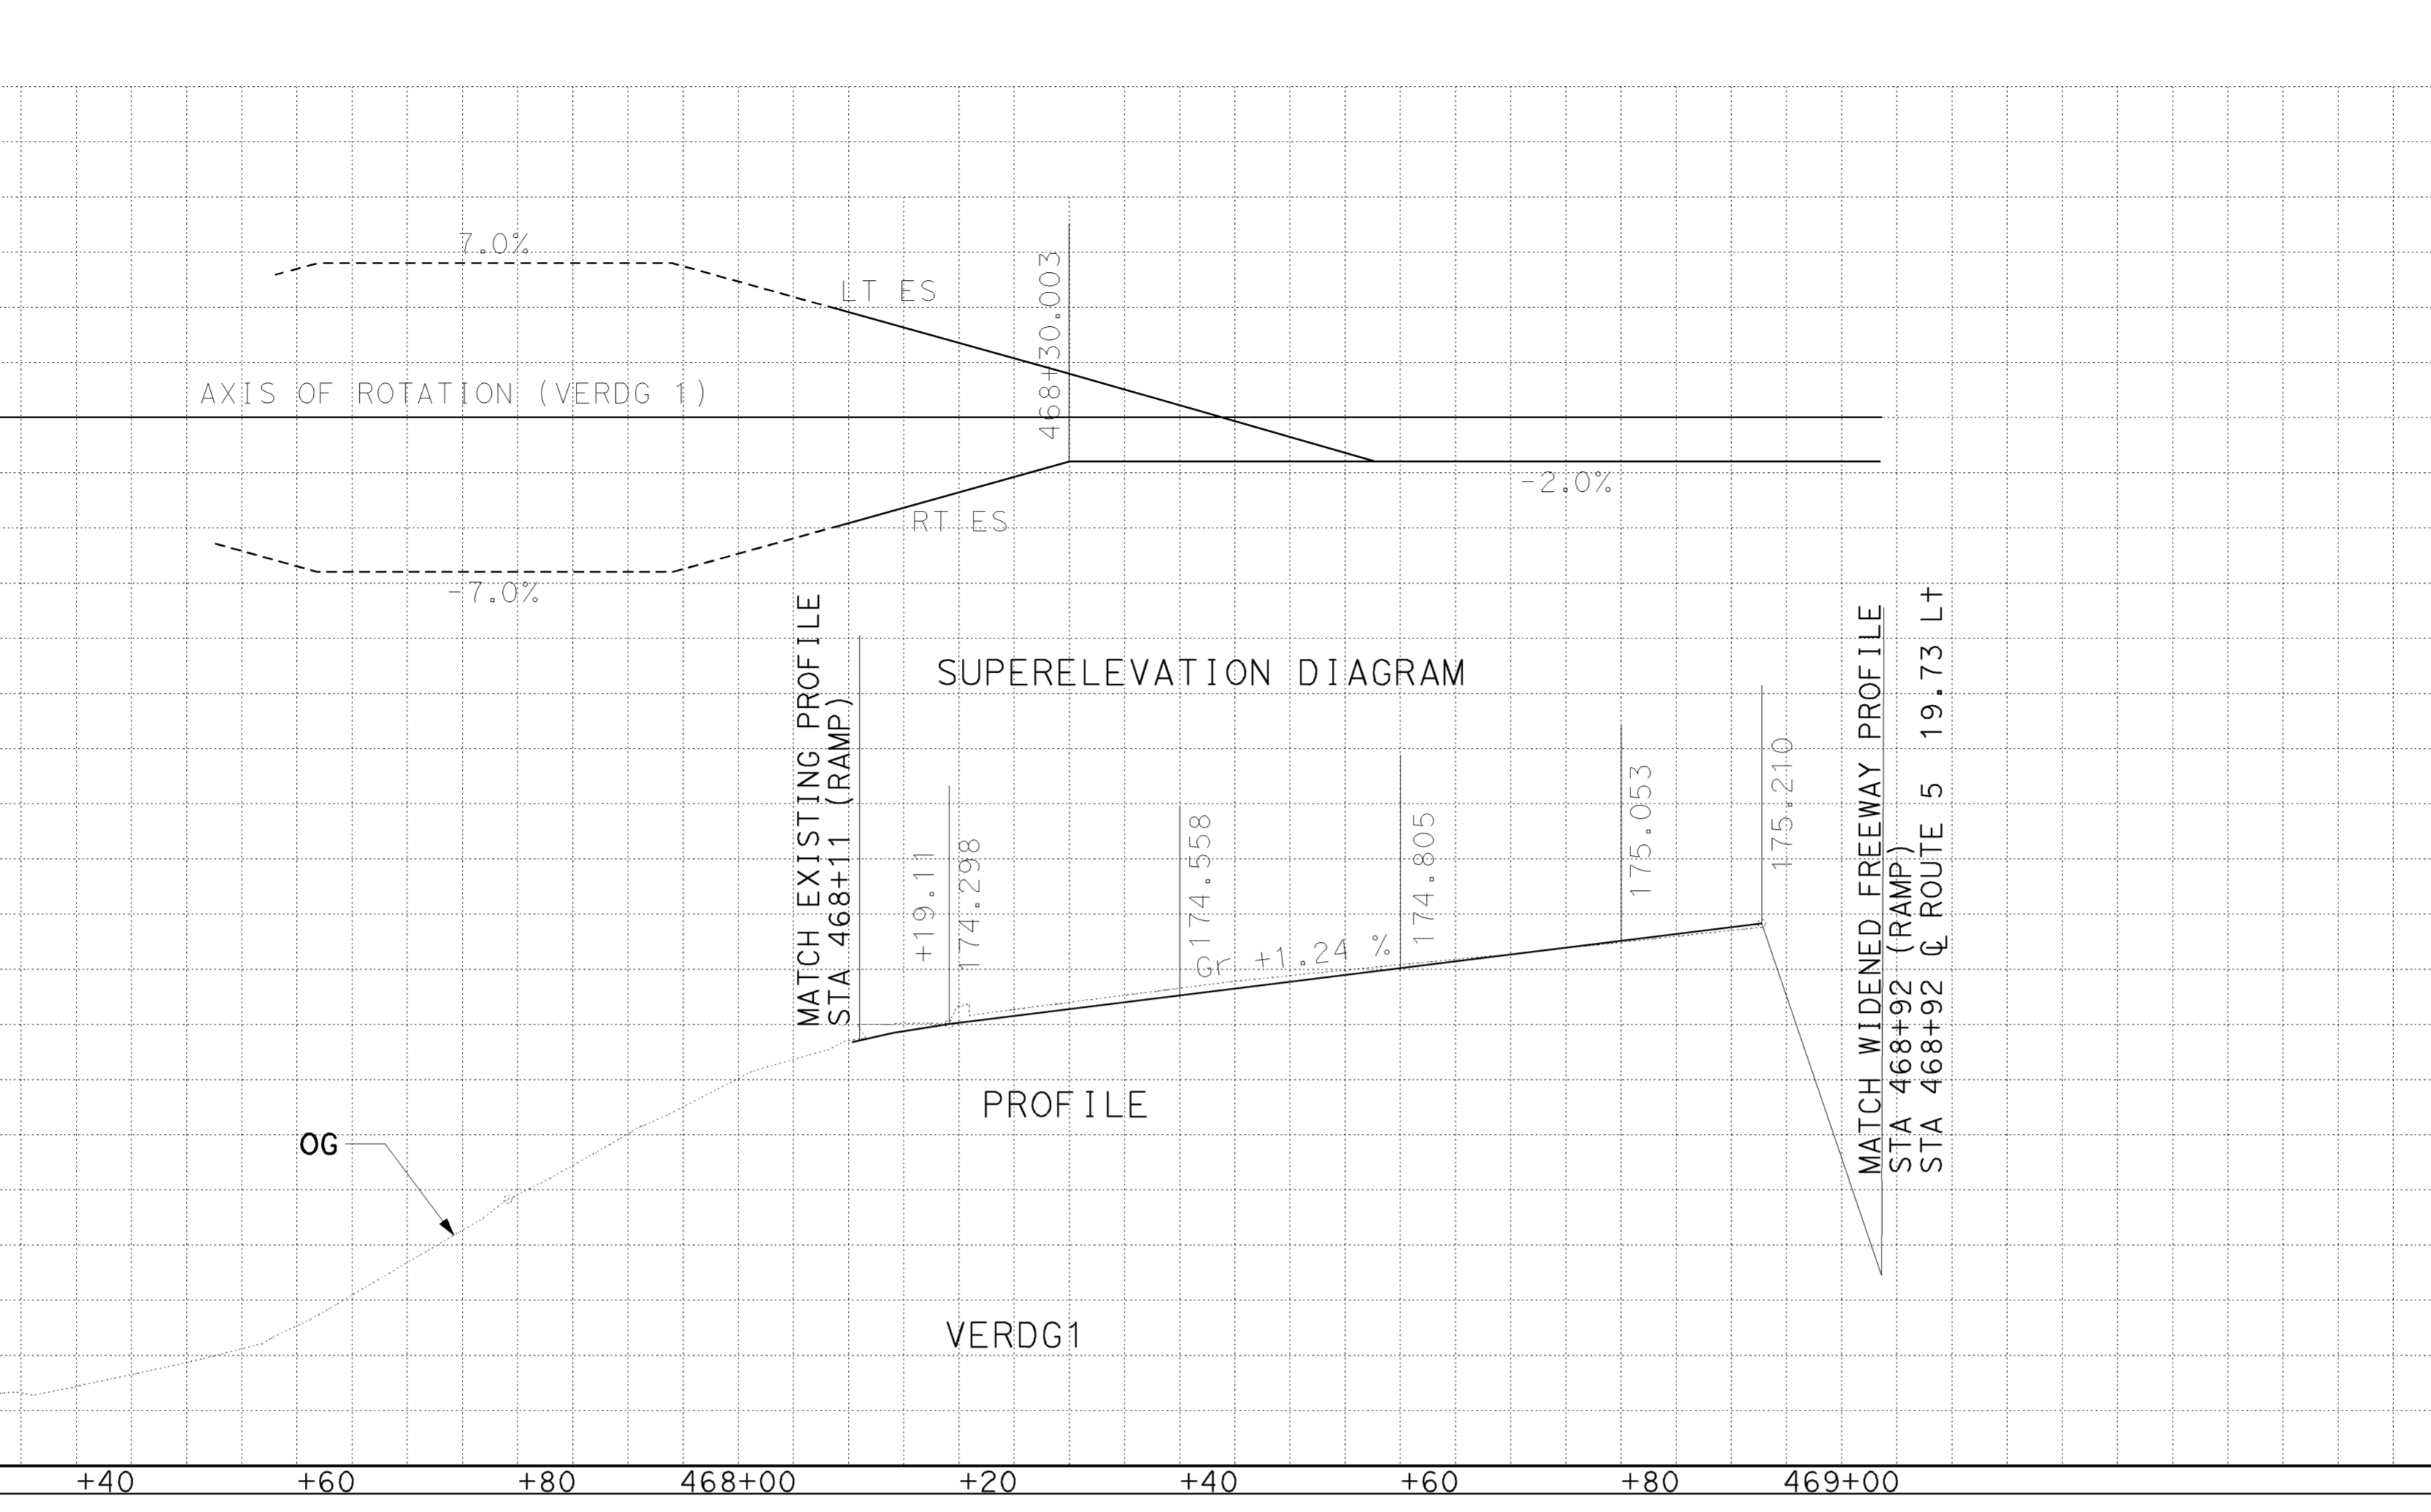
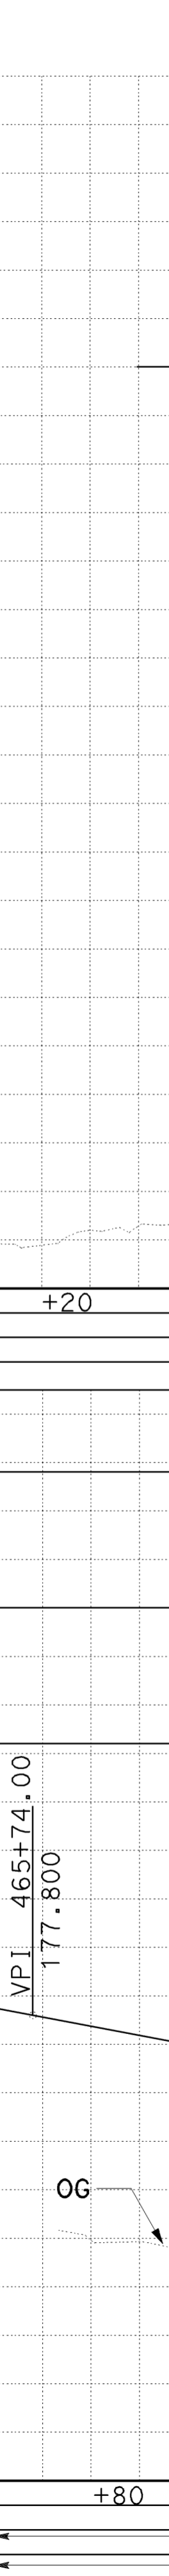





DIST.	COUNTY	ROUTE	KILOMETER POST TOTAL PROJECT	SHEET NO.	TOTAL SHEETS
07	LA	5	42.8/47.3	42	1073

REGISTERED ENGINEER - CIVIL 6-8-09 PLANS APPROVAL DATE <small>The State of California or its officers or agents shall not be responsible for the accuracy or completeness of electronic copies of this plan sheet.</small>	


① 16 mm Ø Sleeve nut anchorage (See Detail E) or Resin capsule anchorage (See Alternative Anchorage). A total of 8 anchorage units required per plate. All metal plates to be galvanized after fabrication. Hardware to be galvanized or non-corrosive

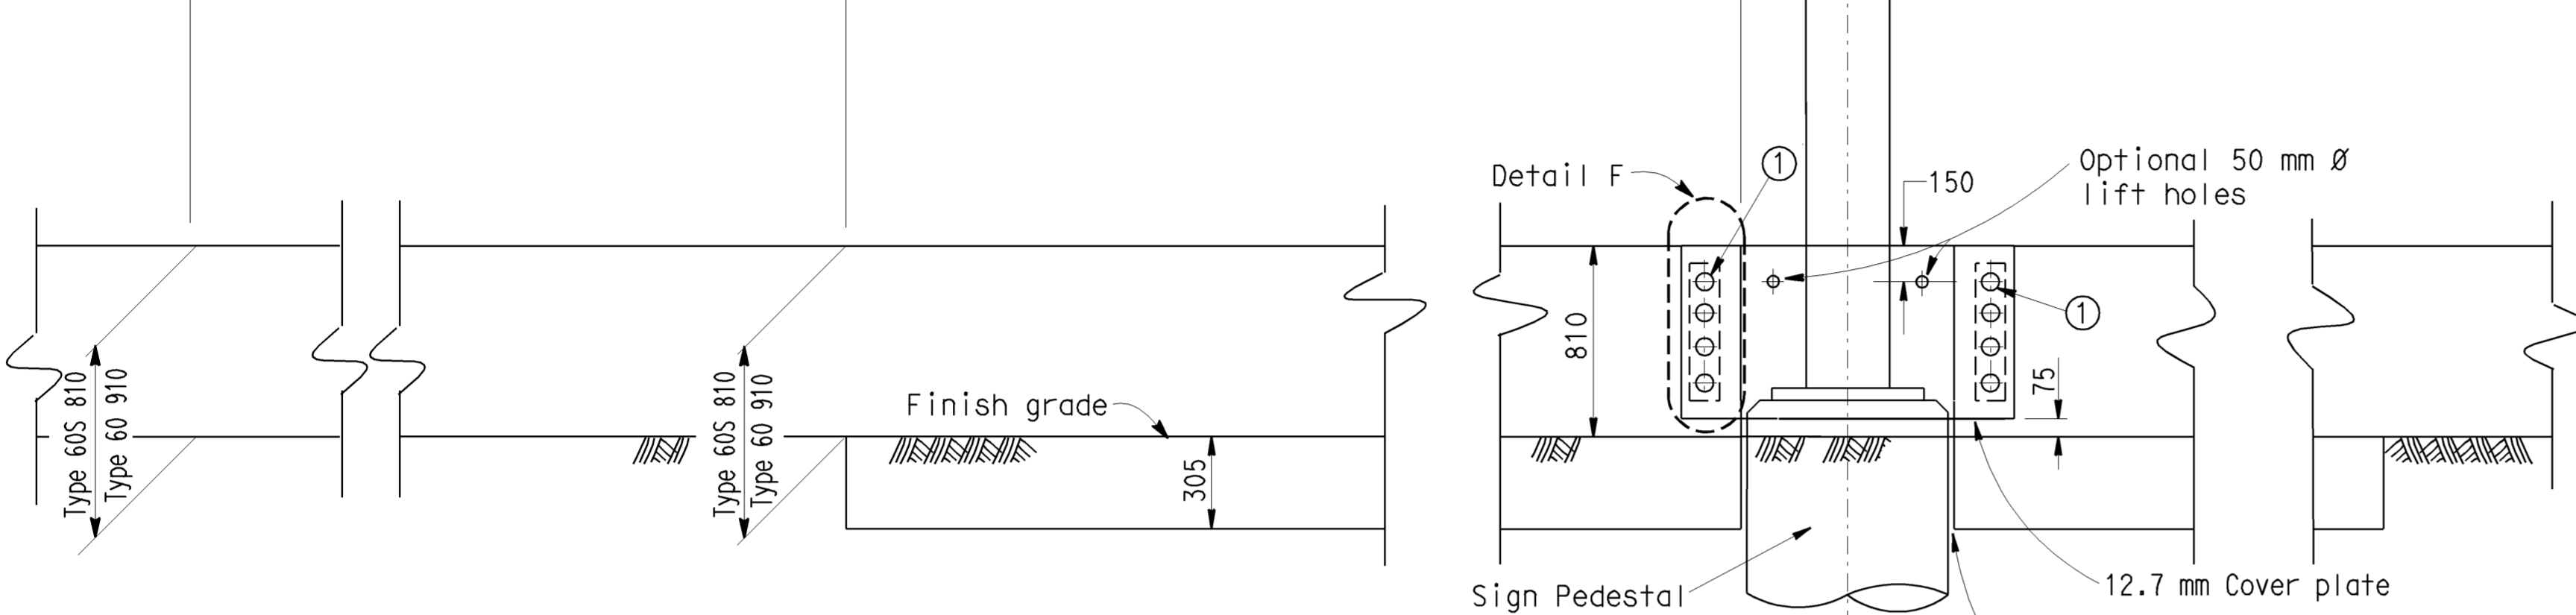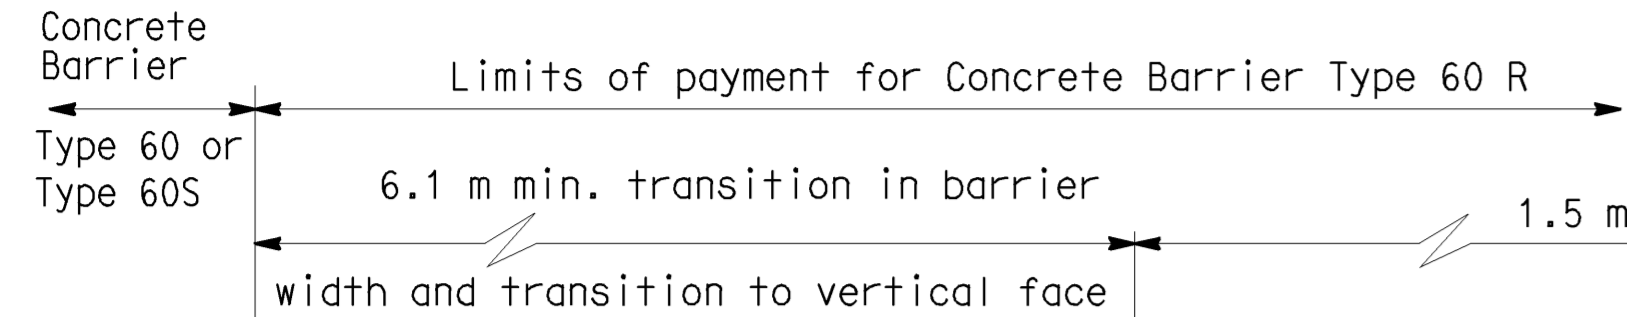



ELEVATION

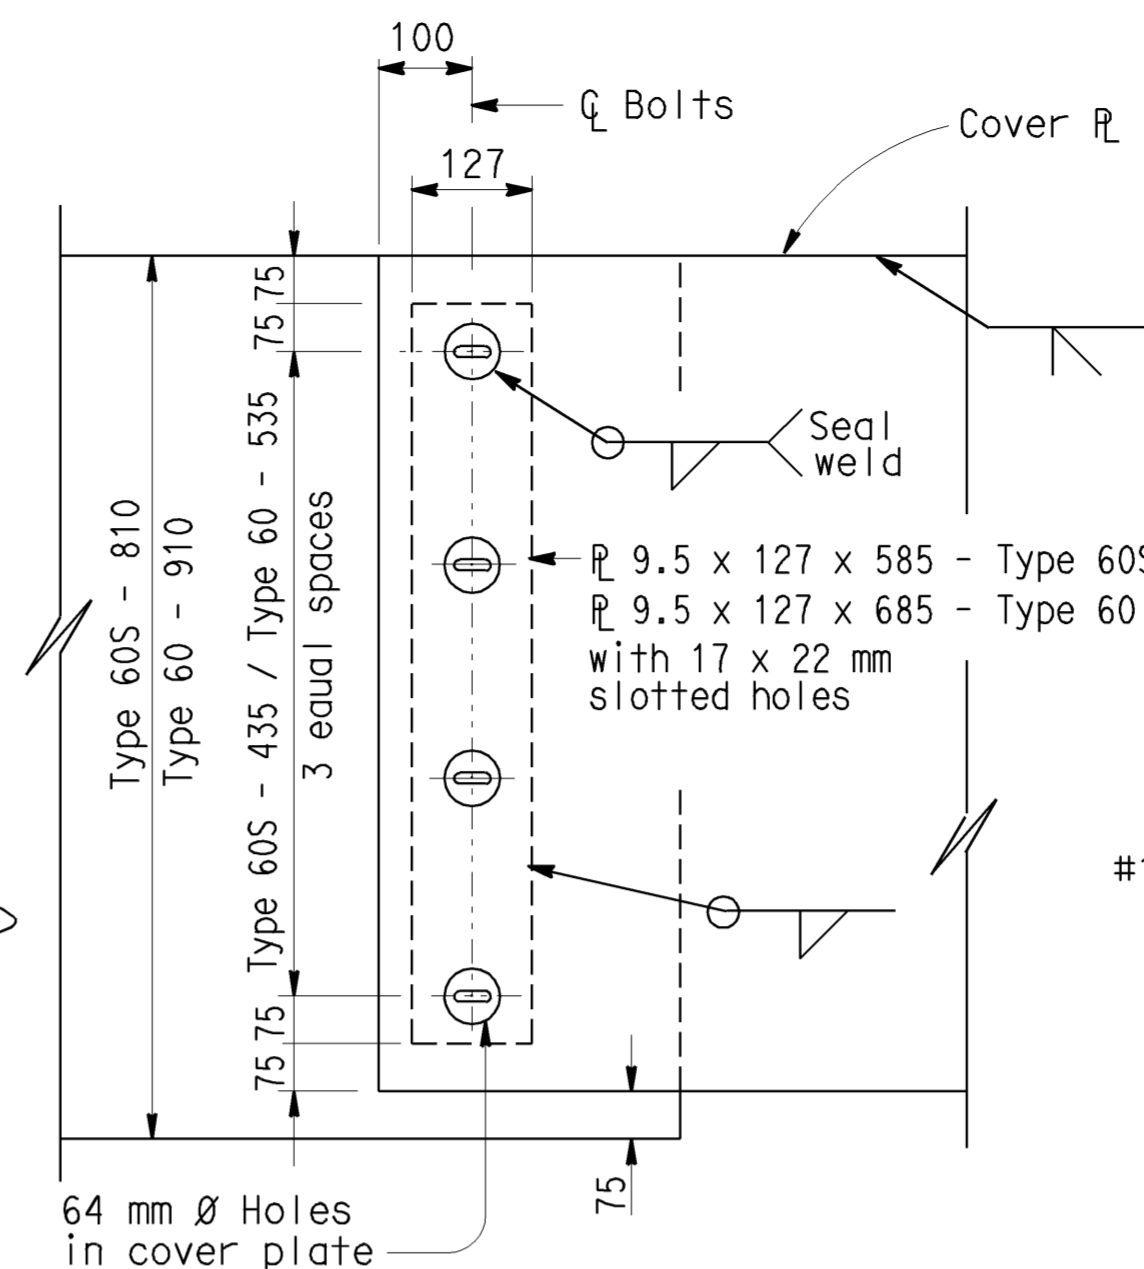


DETAIL F

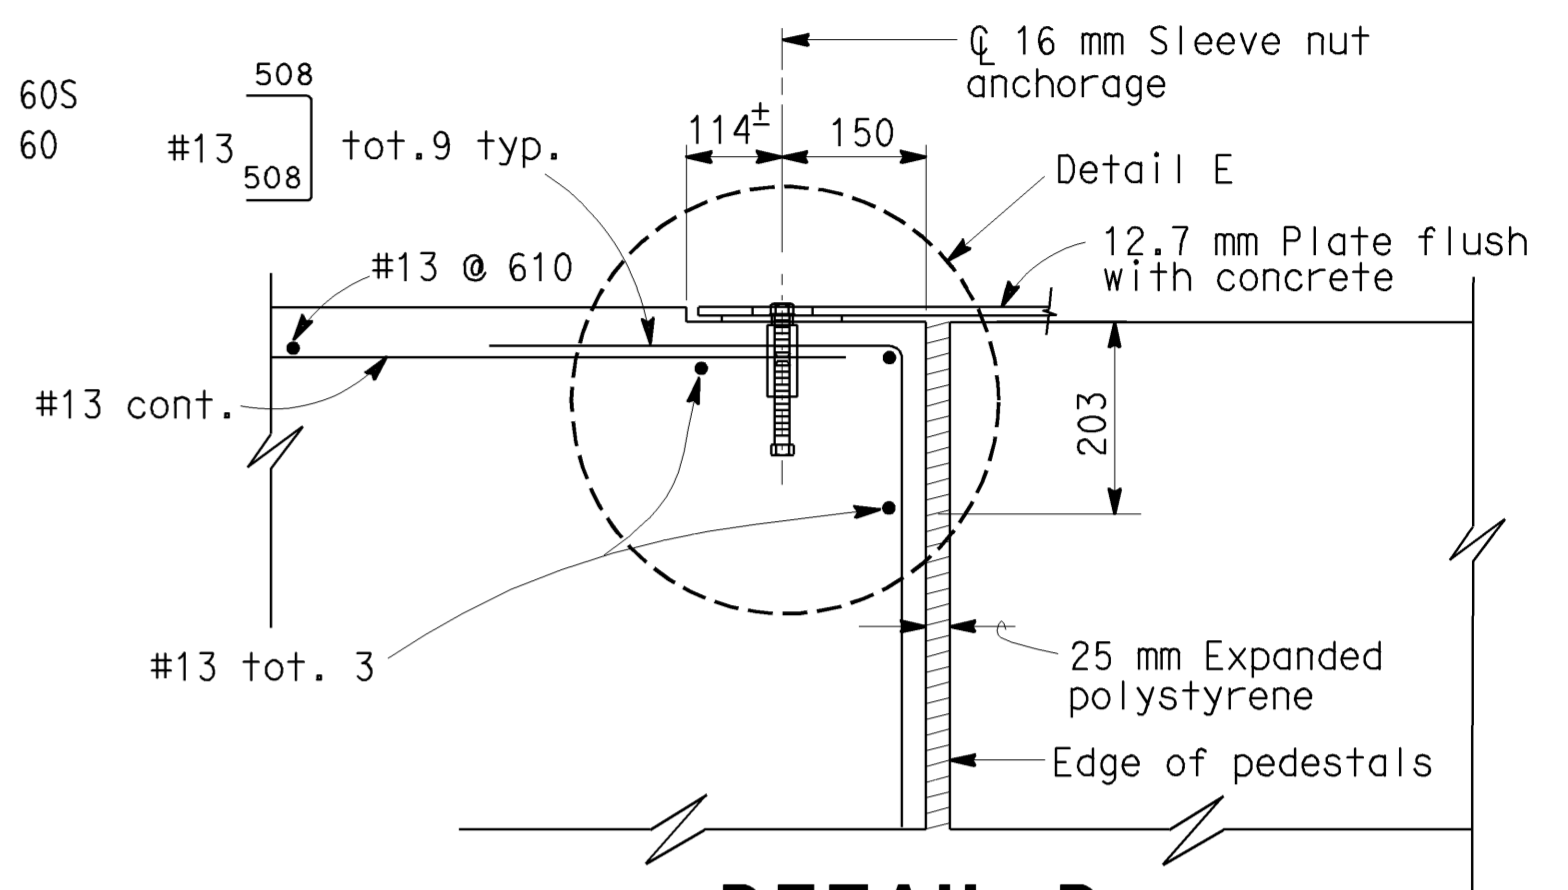


DETAIL D

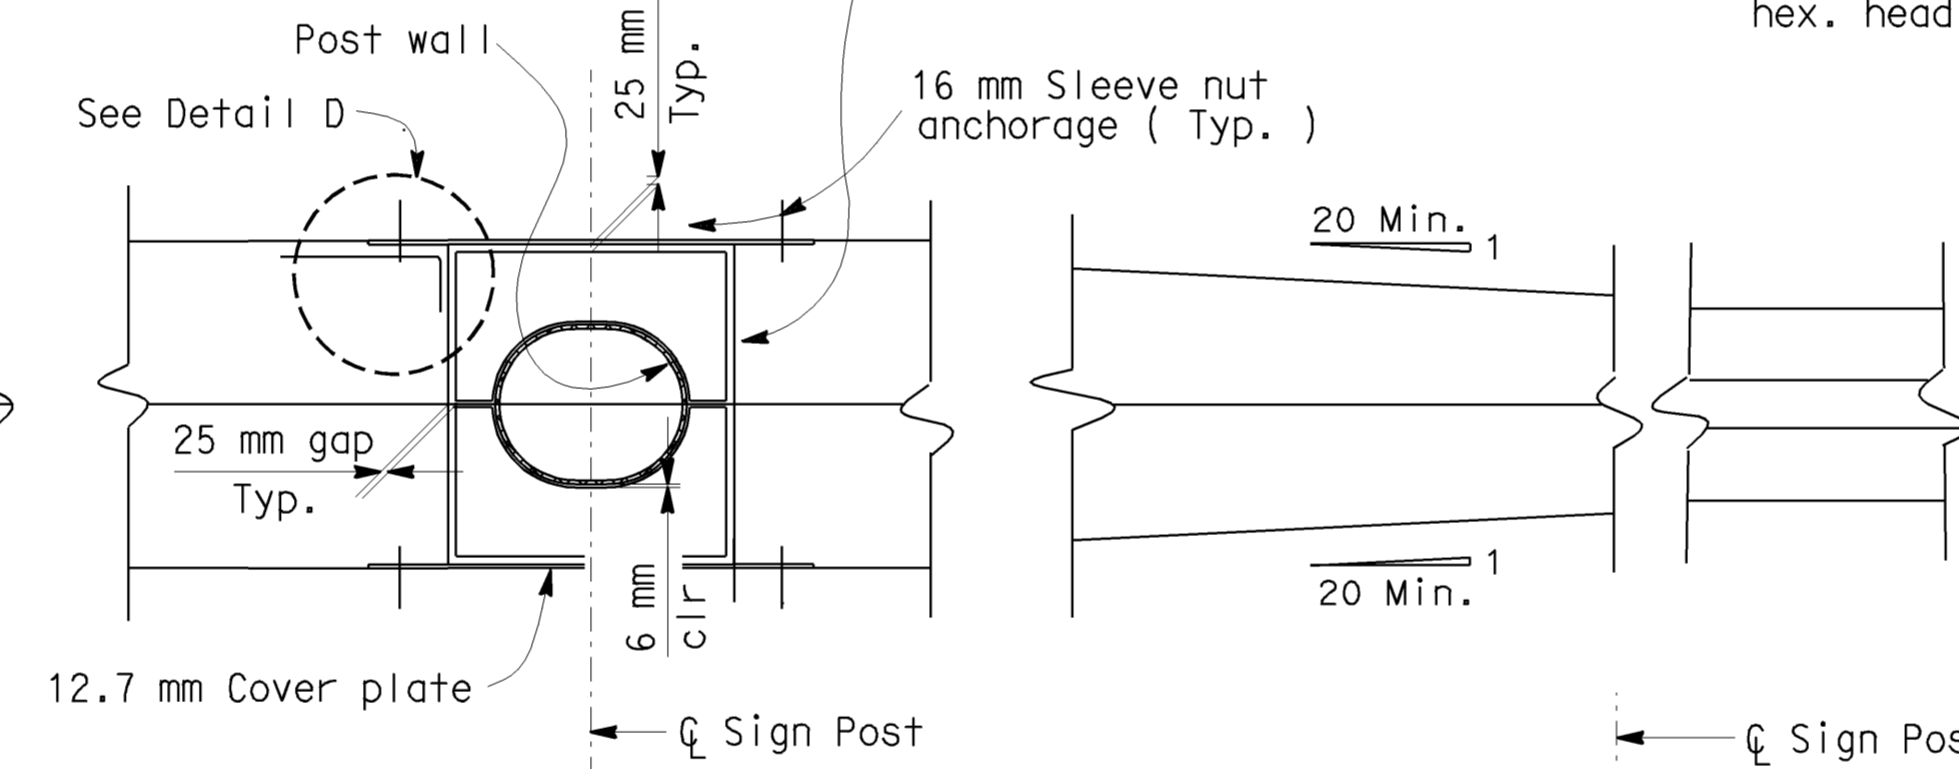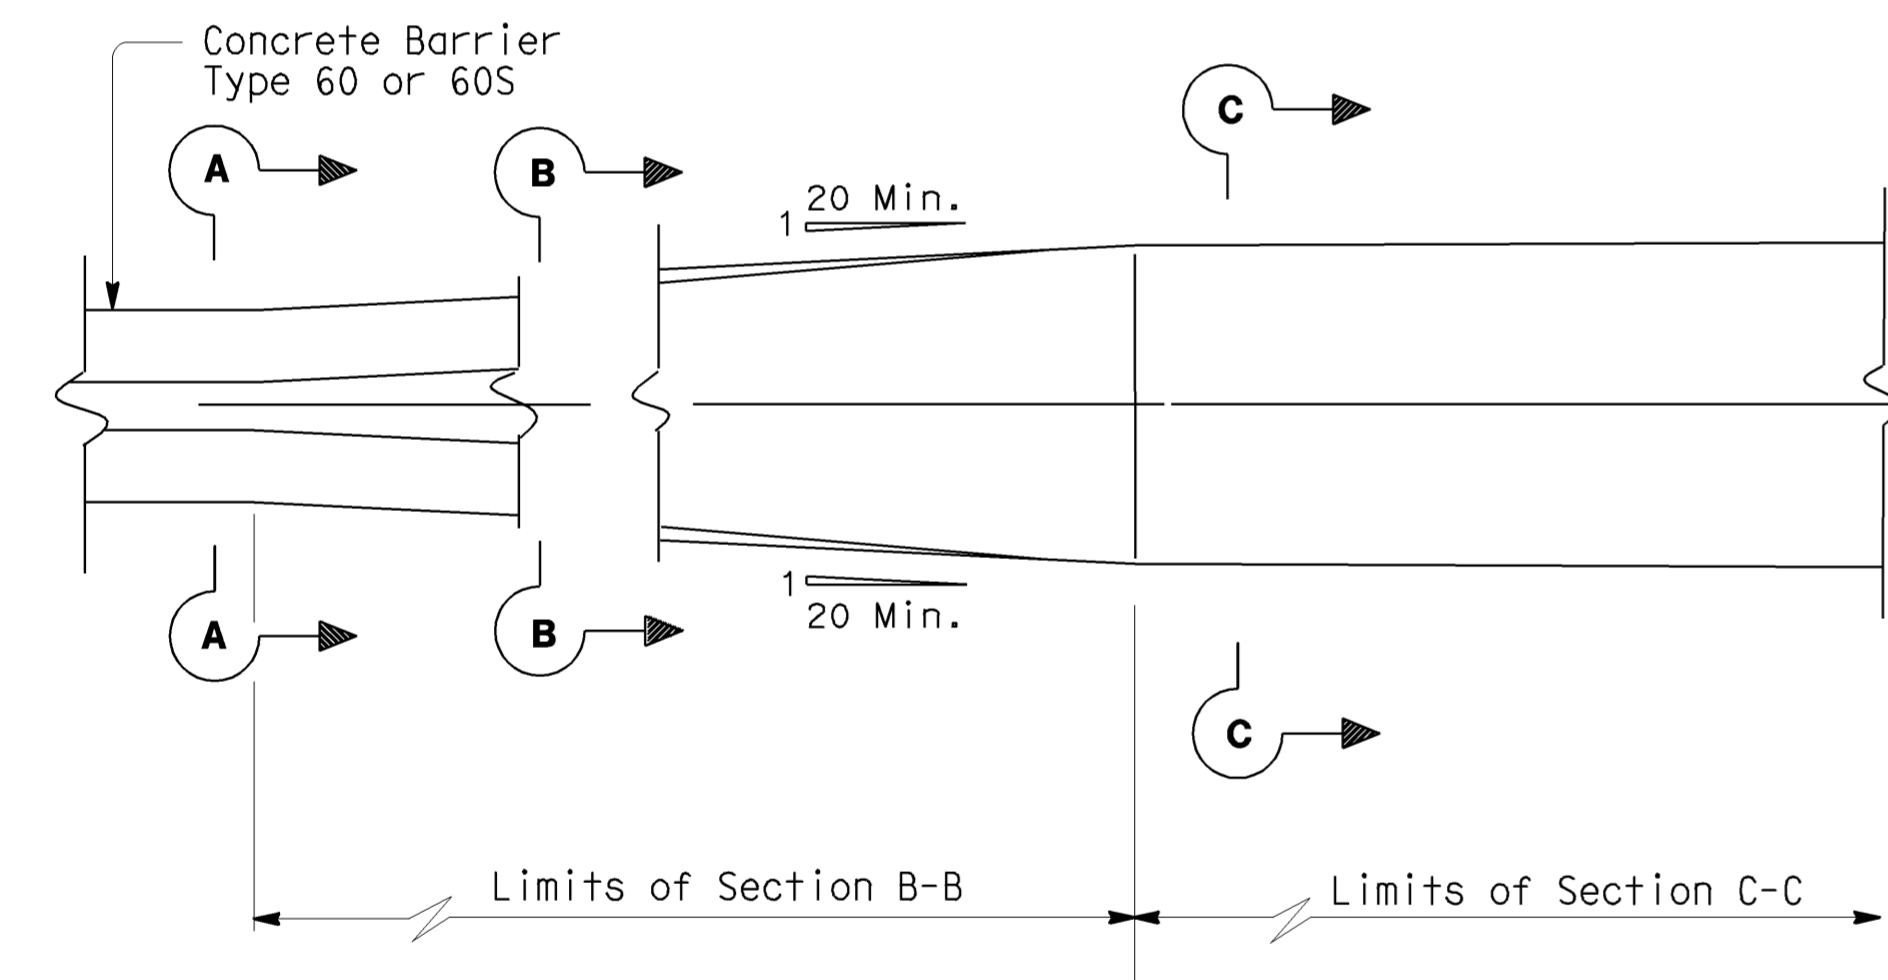


PLAN

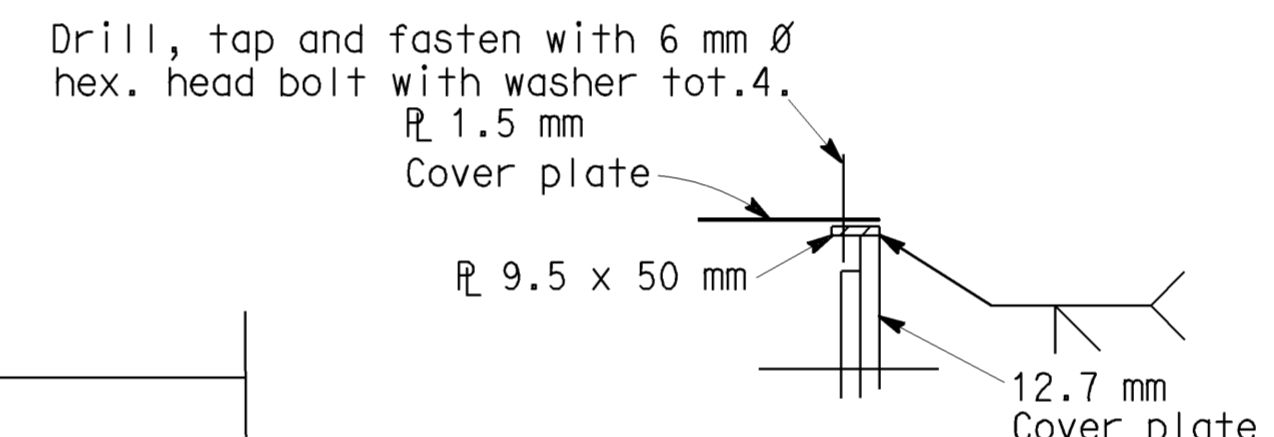

DETAIL G

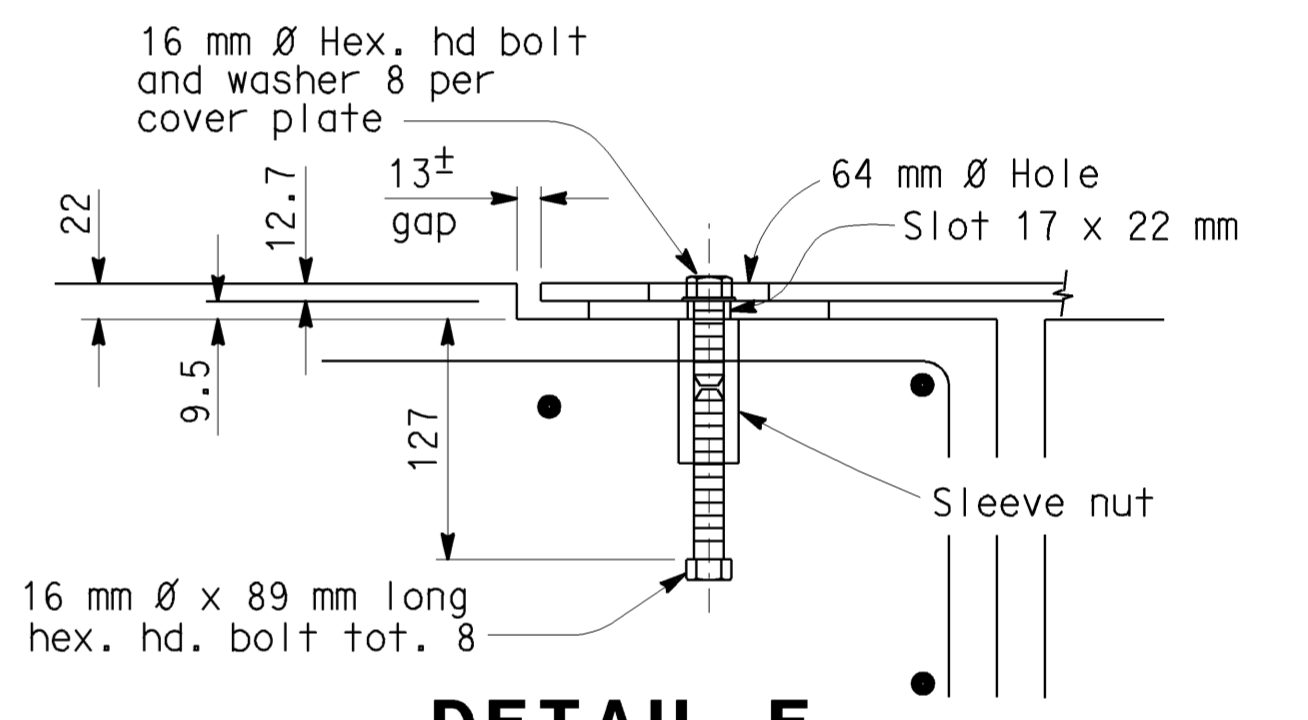


DETAIL E

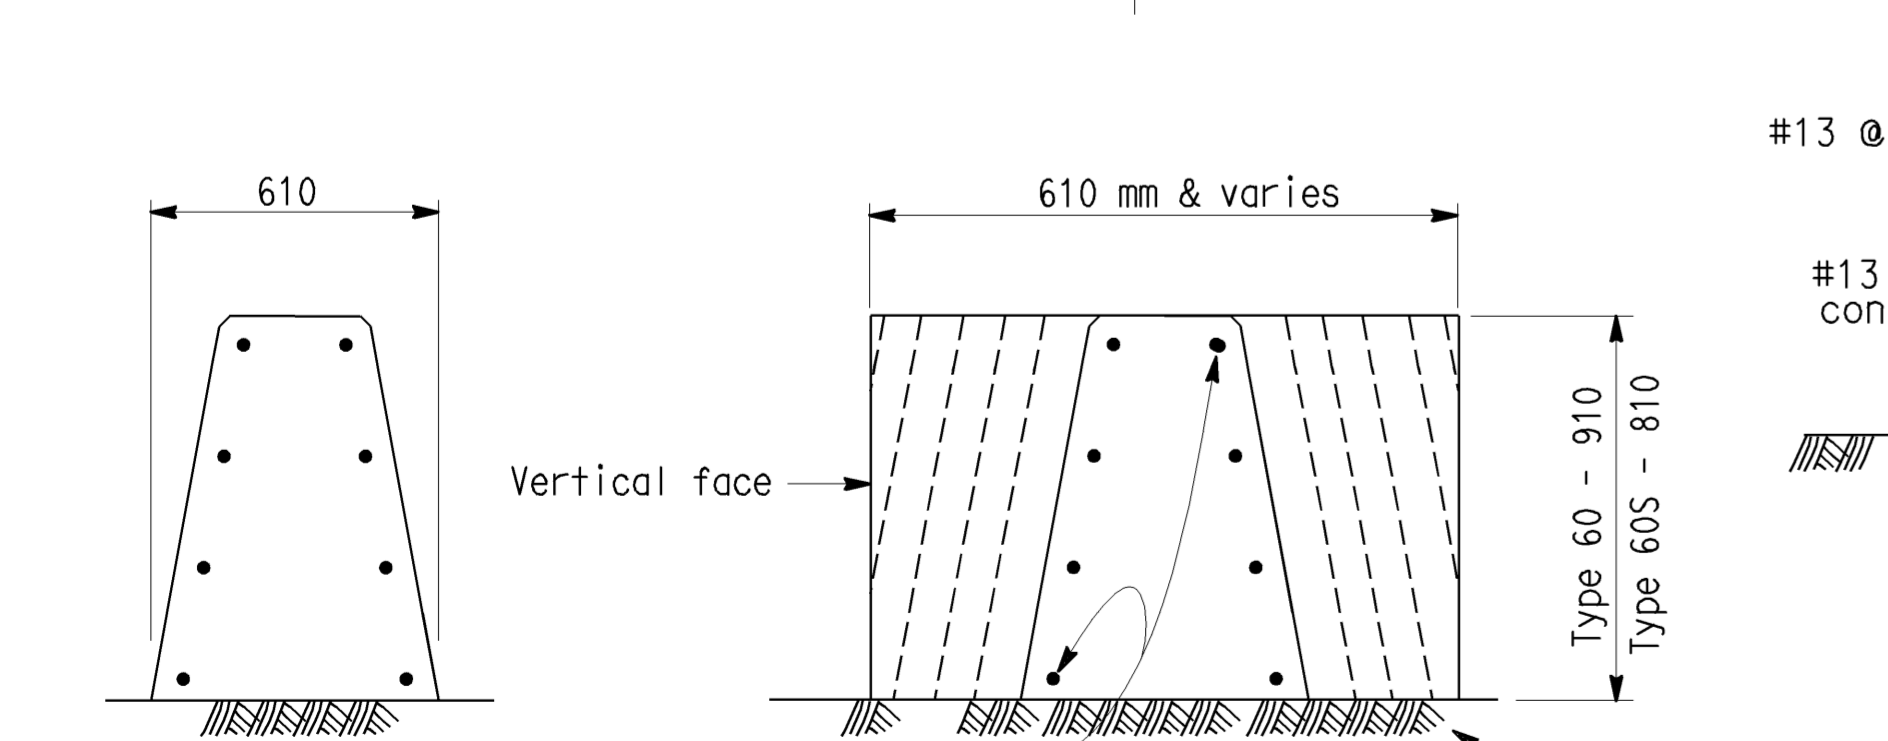


SECTION A-A

SECTION B-B

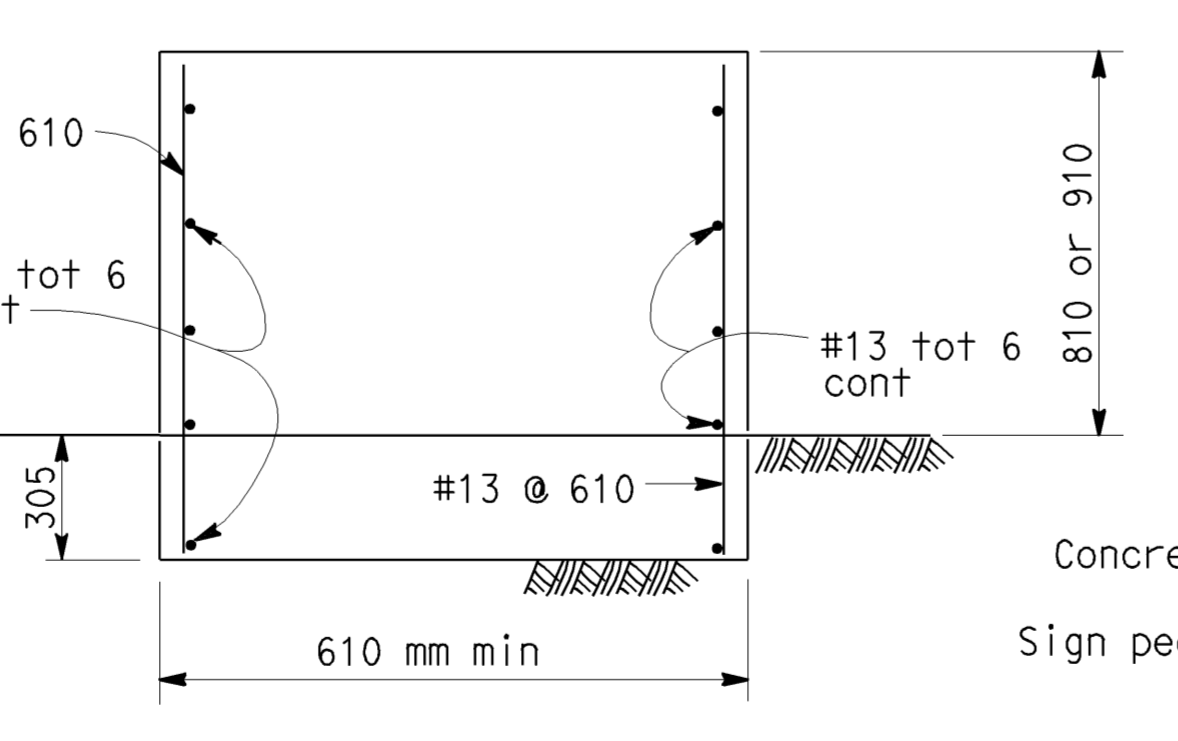


SECTION C-C

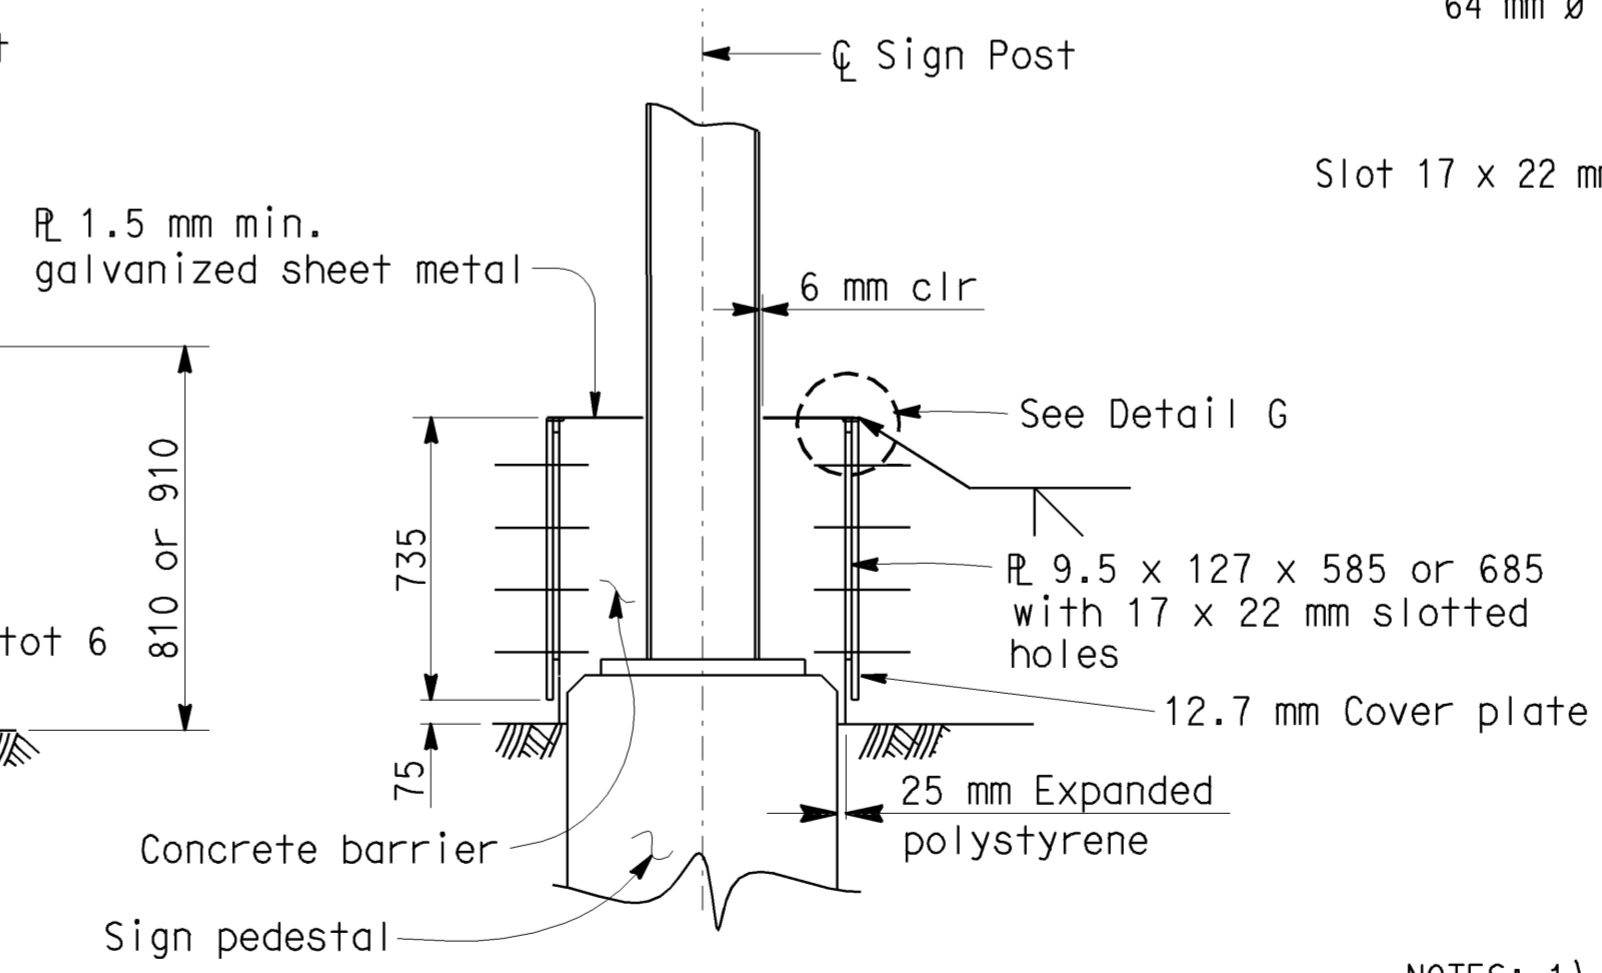

SECTION D-D

Note: Concrete Barrier Type 60 R is symmetrical about ϕ of sign post.

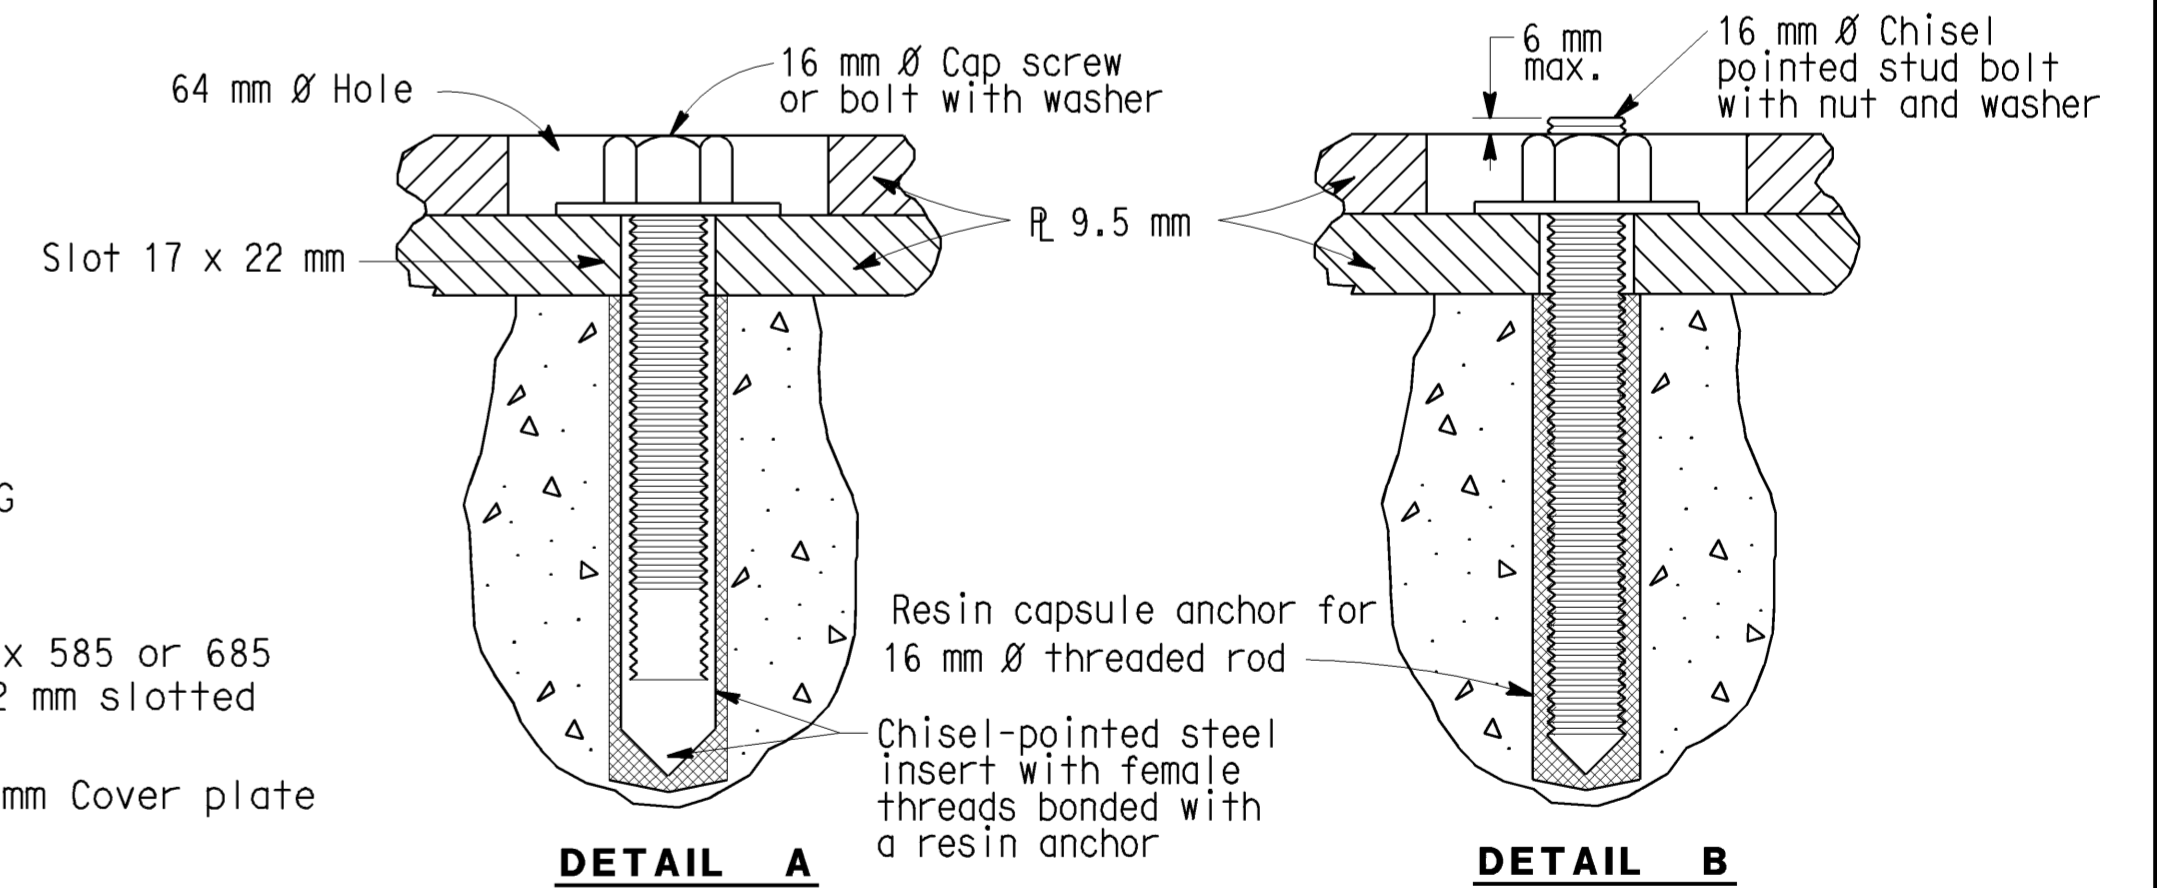

DETAIL A

DETAIL B

ALTERNATIVE ANCHORAGE

NOTES: 1) Resin capsule anchorage is subject to approval of the Engineer. Installation procedures shall comply with manufacturer's instructions.
 2) Detail B similar to Detail A except for anchorage devices.

CONSTRUCTION DETAILS

ALL DIMENSIONS ARE IN MILLIMETERS UNLESS OTHERWISE SHOWN

NO SCALE C-1

STANDARD DRAWING			
RELEASE DATE 8/26/03	DESIGN BY <i>R. Bishop</i>	CHECKED <i>N ABDIN</i>	RELEASED BY <i>Roberto Ince</i>
FILE NO. xs16-080	DETAILS BY <i>Ben Matsuo</i>	CHECKED <i>N ABDIN</i>	OFFICE CHIEF
	SUBMITTED BY <i>R.C. Anderson</i>	DRAWING DATE <i>6/99</i>	

STATE OF CALIFORNIA
DEPARTMENT OF TRANSPORTATION

DIVISION OF ENGINEERING SERVICES


BRIDGE NO.
KILOMETER POST

**CONCRETE BARRIER (TYPE 60R)
TRANSITION AT SIGN POST**




DIST.	COUNTY	ROUTE	KILOMETER POST TOTAL PROJECT	SHEET NO.	TOTAL SHEETS
07	LA	5	42.8/47.3	43	1073


REGISTERED ENGINEER - CIVIL	
6-8-09	
PLANS APPROVAL DATE	
<small>The State of California or its officers or agents shall not be responsible for the accuracy or completeness of electronic copies of this plan sheet.</small>	

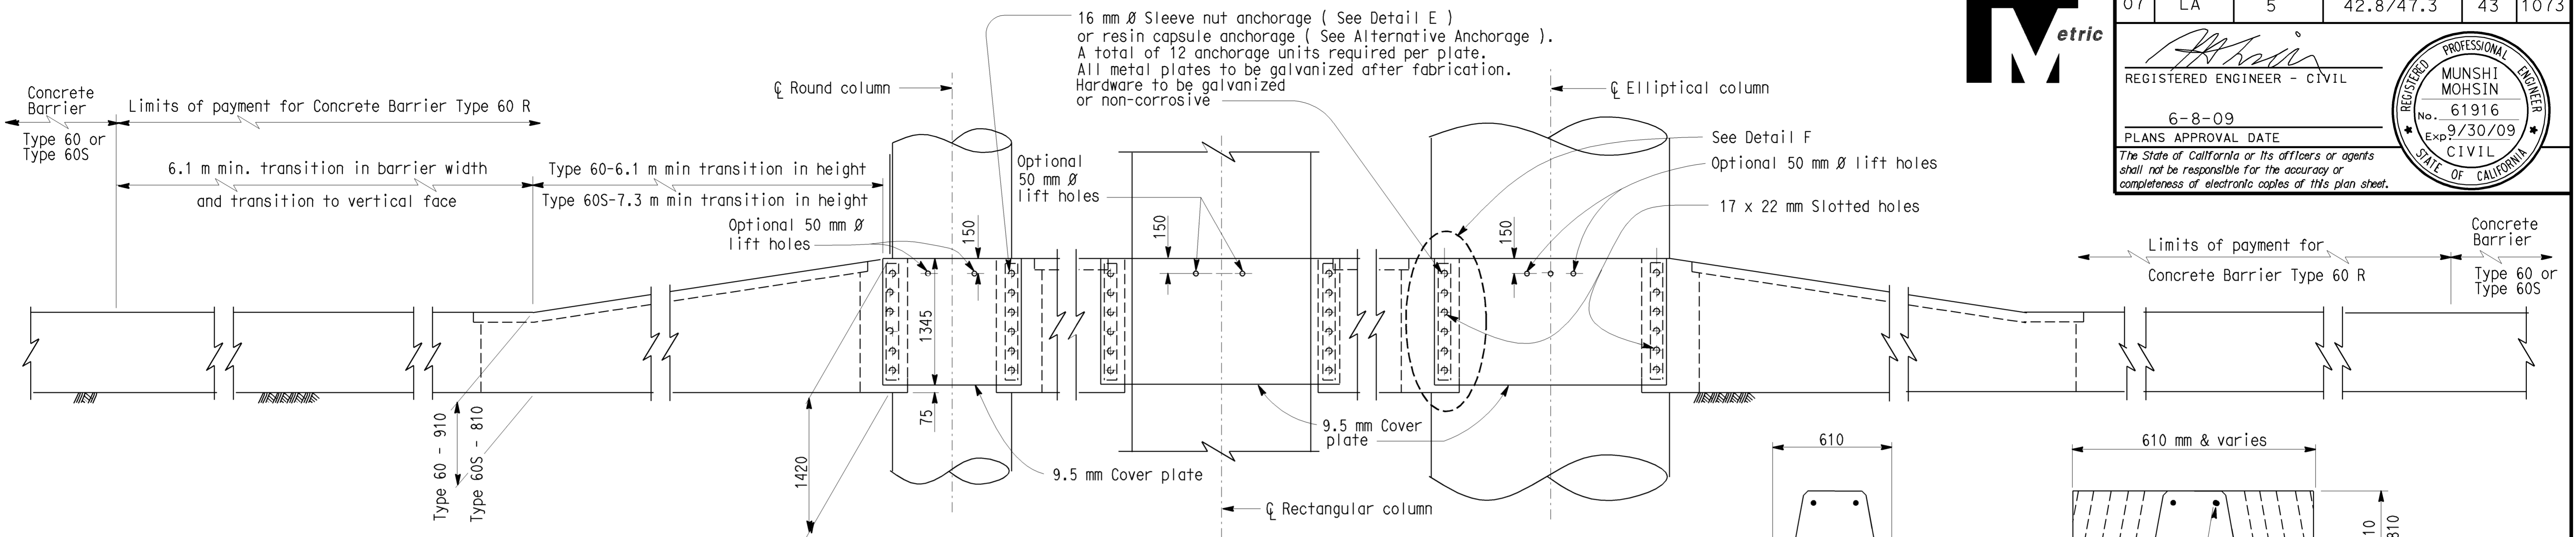


ELEVATION

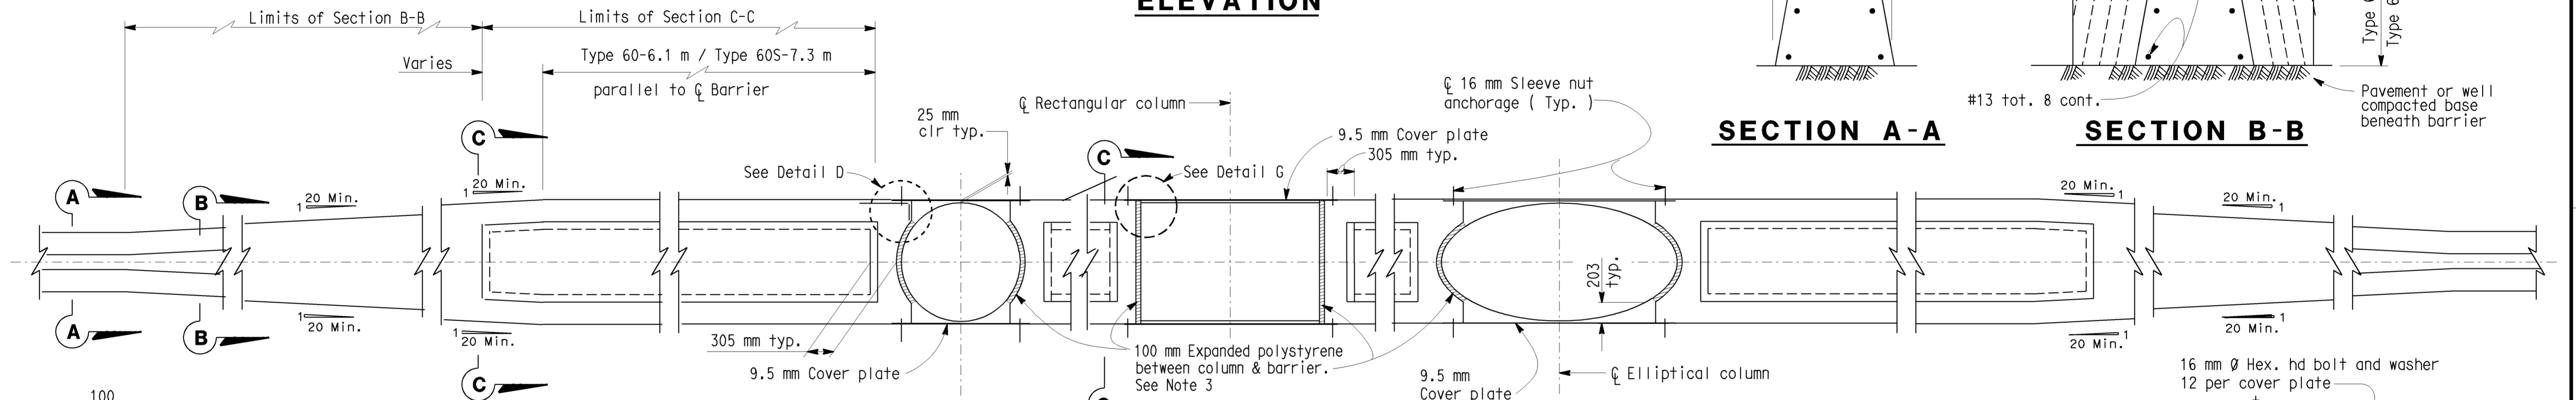


PLAN

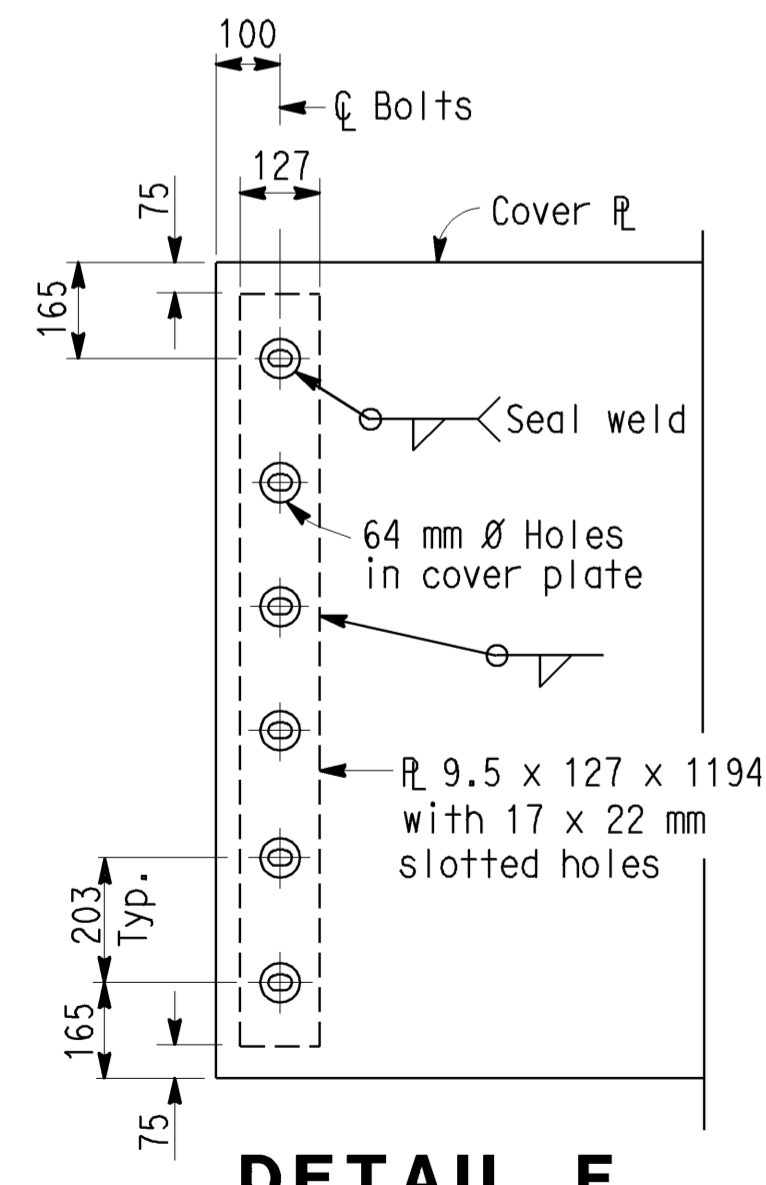

DETAIL F

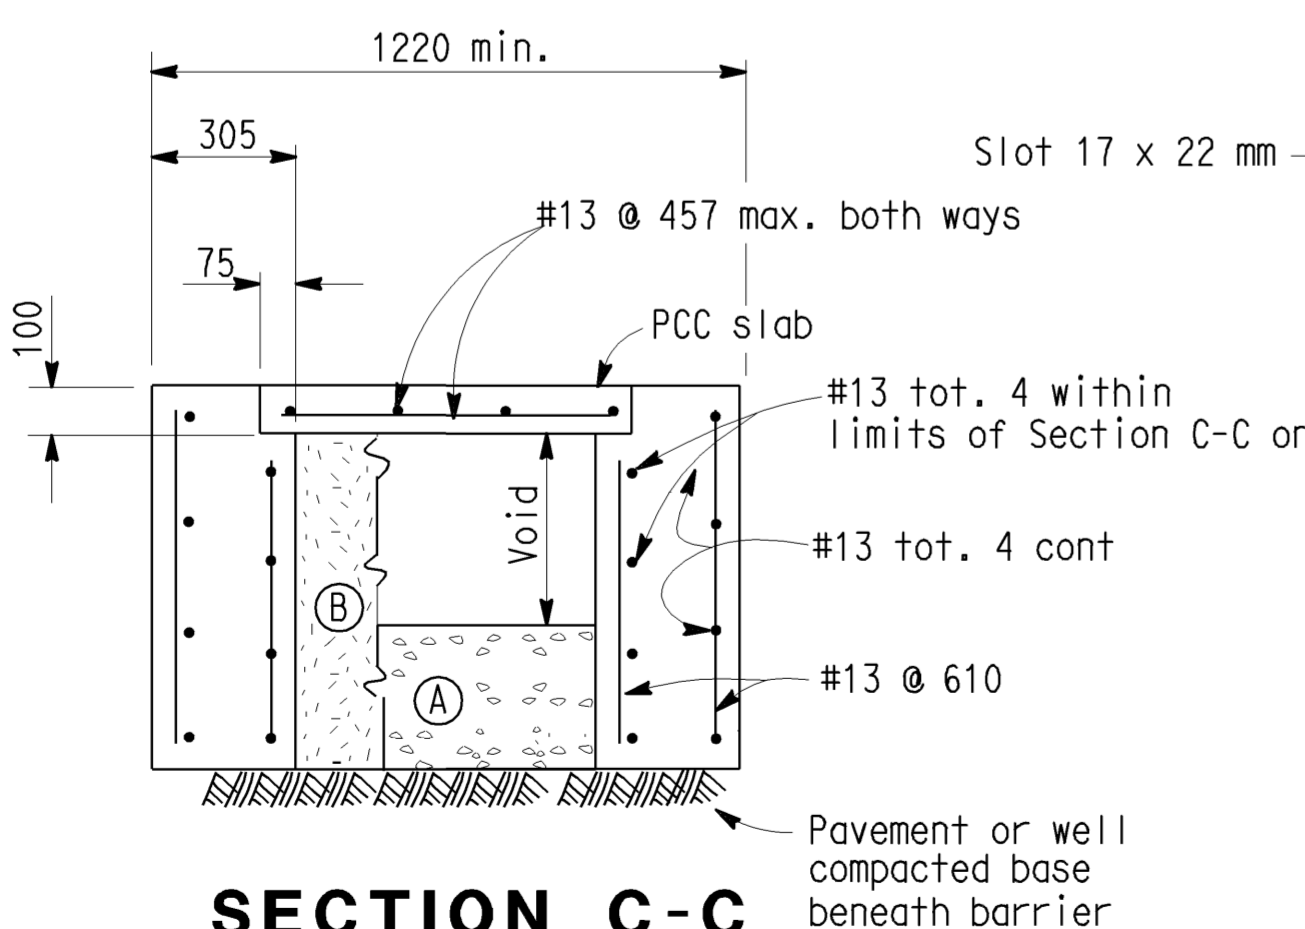


SECTION C-C

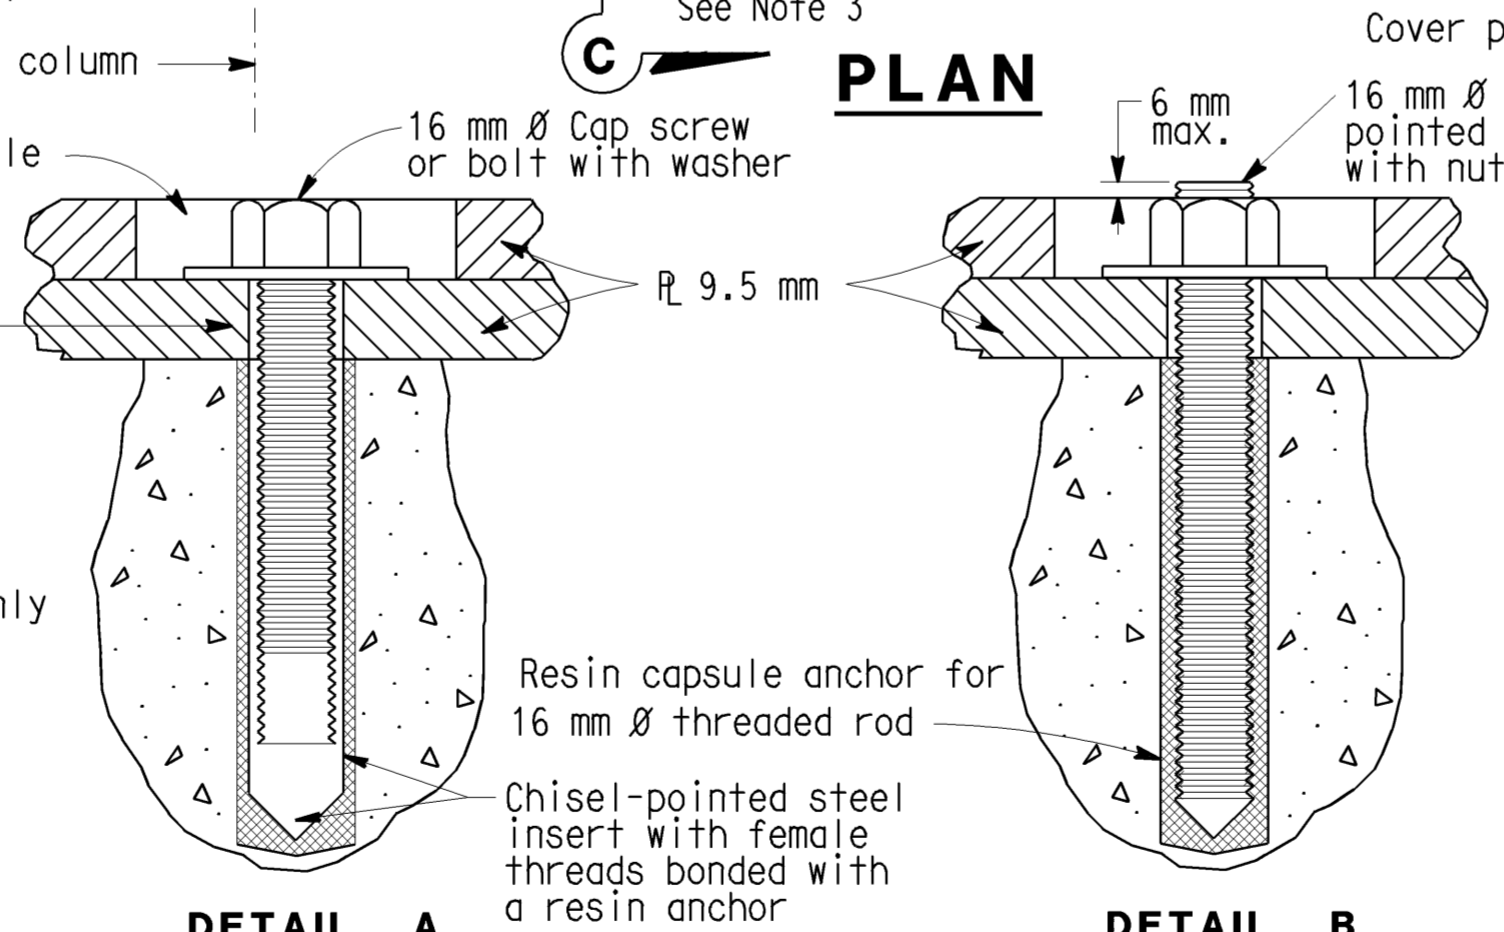


ALTERNATIVE ANCHORAGE

NOTES: 1) Resin capsule anchorage is subject to approval of the Engineer. Installation procedures shall comply with manufacturer's instructions. 2) Detail B similar to Detail A except for anchorage devices.

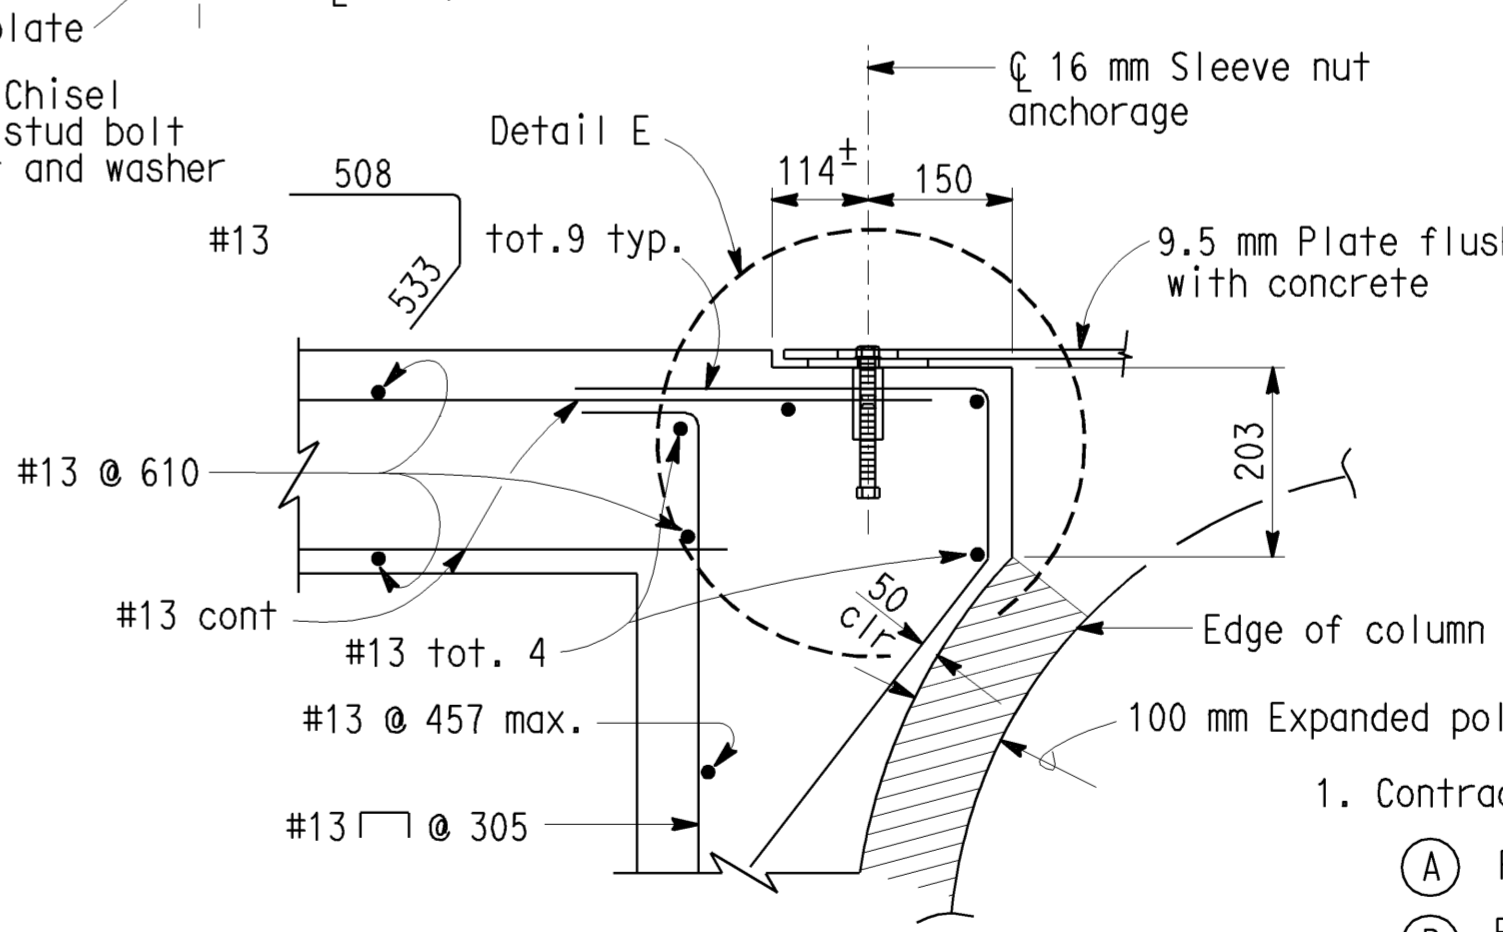

DETAIL D

NO SCALE
ALL DIMENSIONS ARE IN MILLIMETERS UNLESS OTHERWISE SHOWN

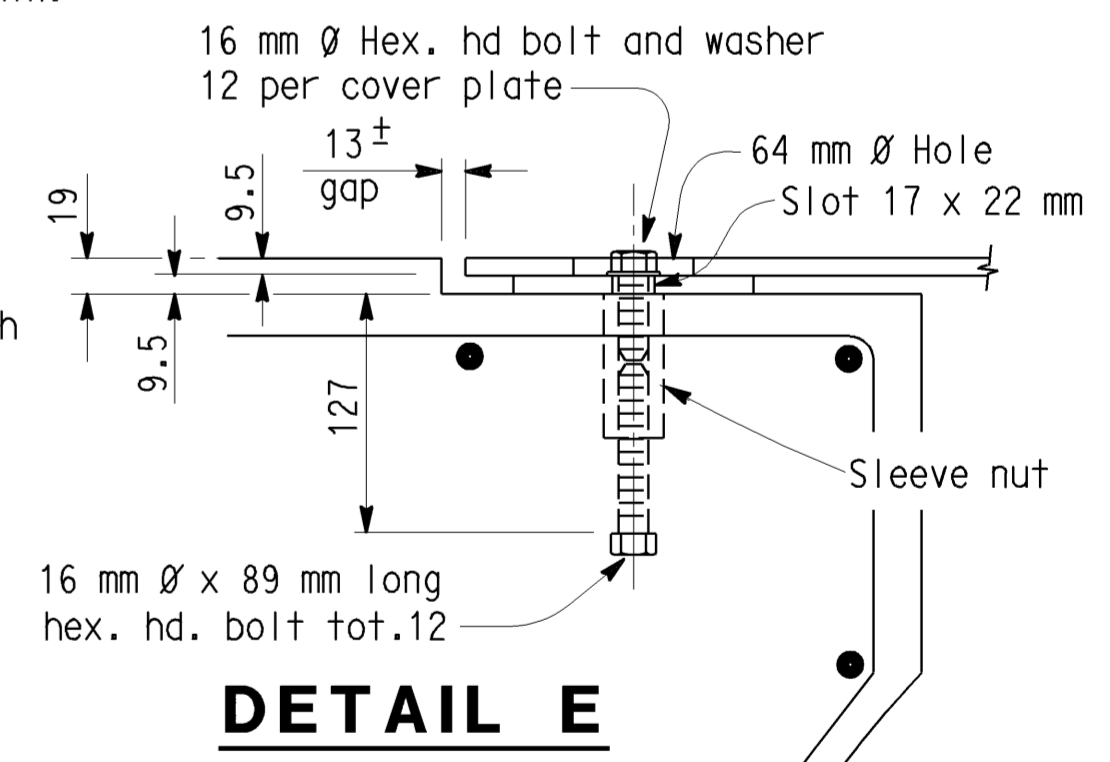

DETAIL E


- NOTES:**
- Contractor options for fill between barrier walls.
 - (A) Place 610 mm PCC at base between barrier walls.
 - (B) Place granular material from base to bottom of 100 mm cap.
 - Forming material for 100 mm cap may remain in place.
 - Enclose column with 100 mm expanded polystyrene at locations where concrete or cement treated base encases the column.
 - For Detail G, see Transition at Bridge Column sheet 2 of 2.

C-2

STANDARD DRAWING			
RELEASE DATE 8/26/03	DESIGN BY RALPH BISHOP	CHECKED N ABDIN	RELEASED BY
FILE NO. xs16-090-1	DETAILS BY BEN MATSUO	CHECKED N ABDIN	
	SUBMITTED BY R.C. ANDERSON	DRAWING DATE 6/99	OFFICE CHIEF


STATE OF CALIFORNIA
DEPARTMENT OF TRANSPORTATION
DIVISION OF ENGINEERING SERVICES

BRIDGE NO.		CONCRETE BARRIER (TYPE 60R)	
Var		TRANSITION AT BRIDGE COLUMN	
KILOMETER POST			
Var			

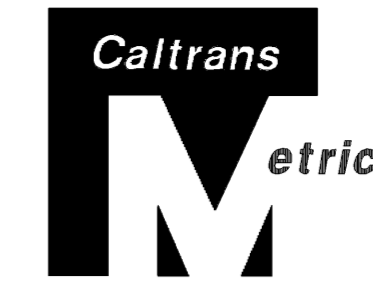


DIST.	COUNTY	ROUTE	KILOMETER POST TOTAL PROJECT	SHEET NO.	TOTAL SHEETS
07	LA	5	42.8/47.3	44	1073

REGISTERED ENGINEER - CIVIL 6-8-09 PLANS APPROVAL DATE <small>The State of California or its officers or agents shall not be responsible for the accuracy or completeness of electronic copies of this plan sheet.</small>	

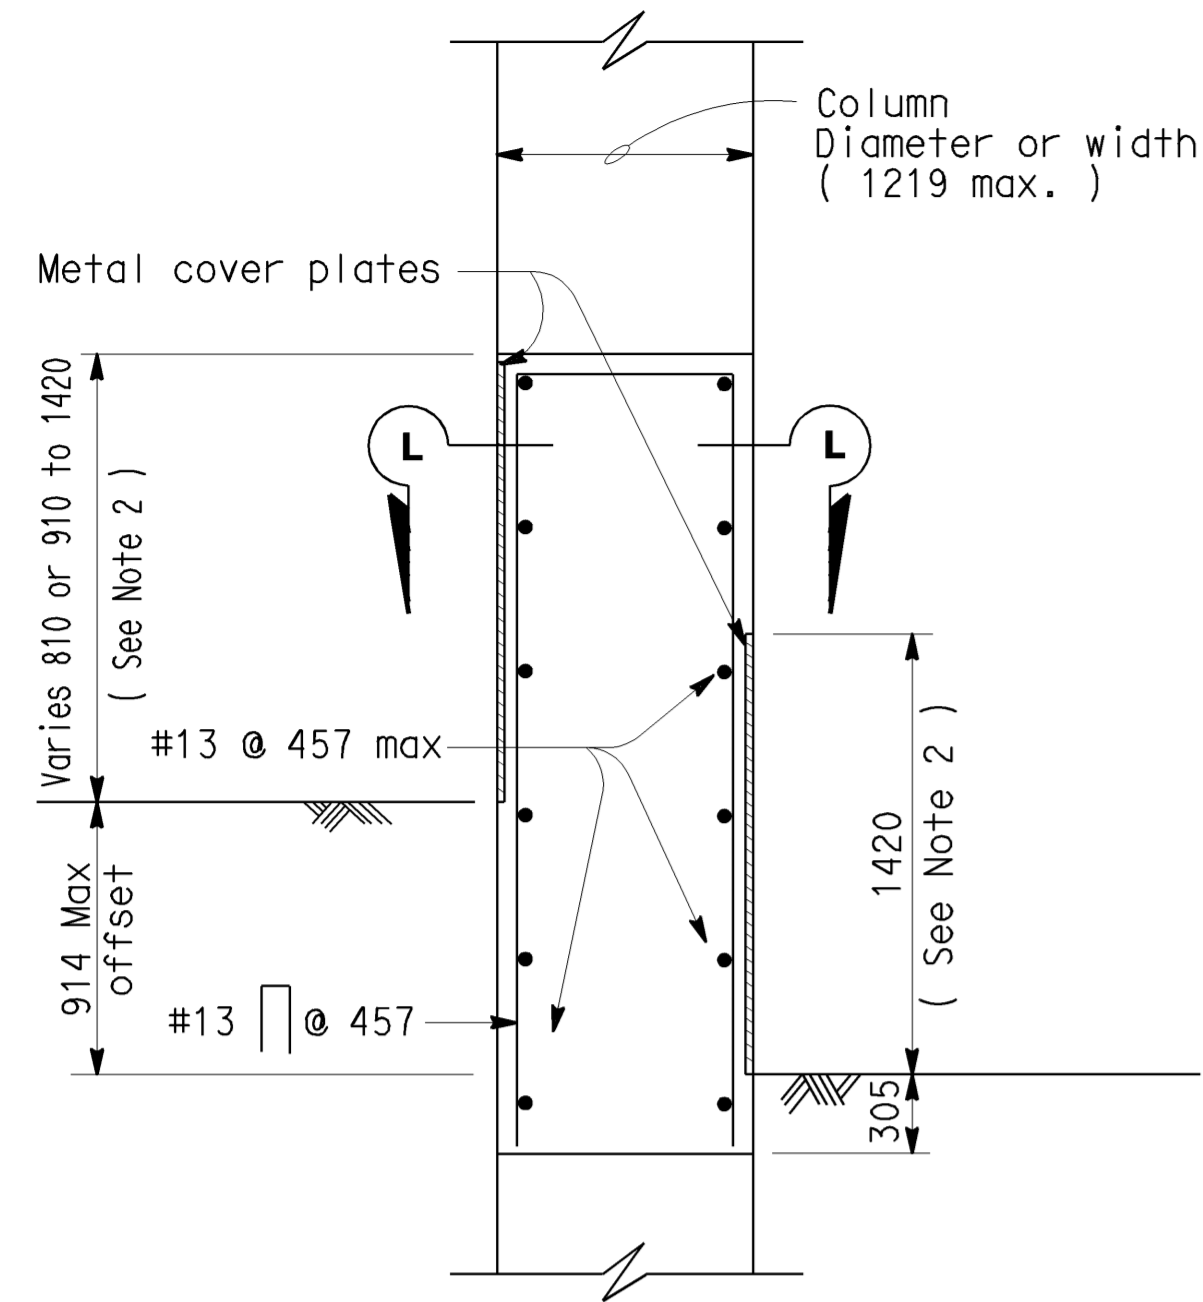


TYPICAL SECTION

Roadway offset 914 mm or less
Column width less than 1219 mm

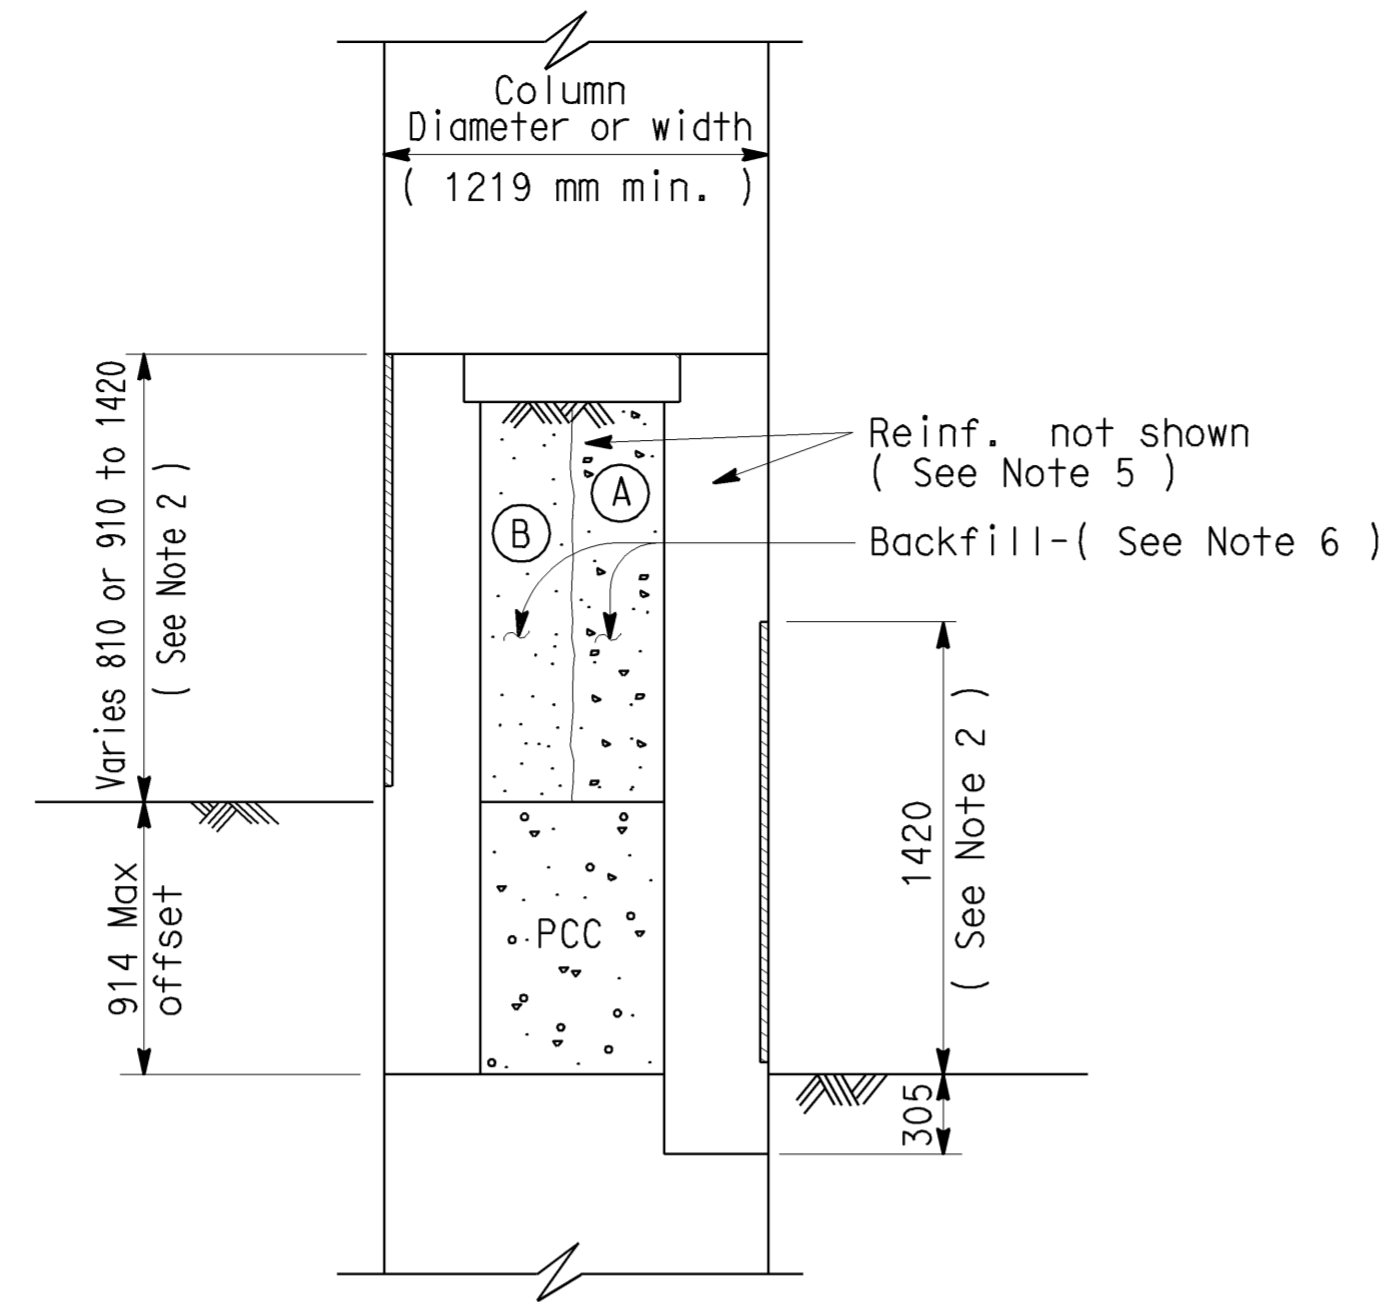


TYPICAL SECTION

Roadway offset 914 mm or less
Column widths greater than 1219 mm

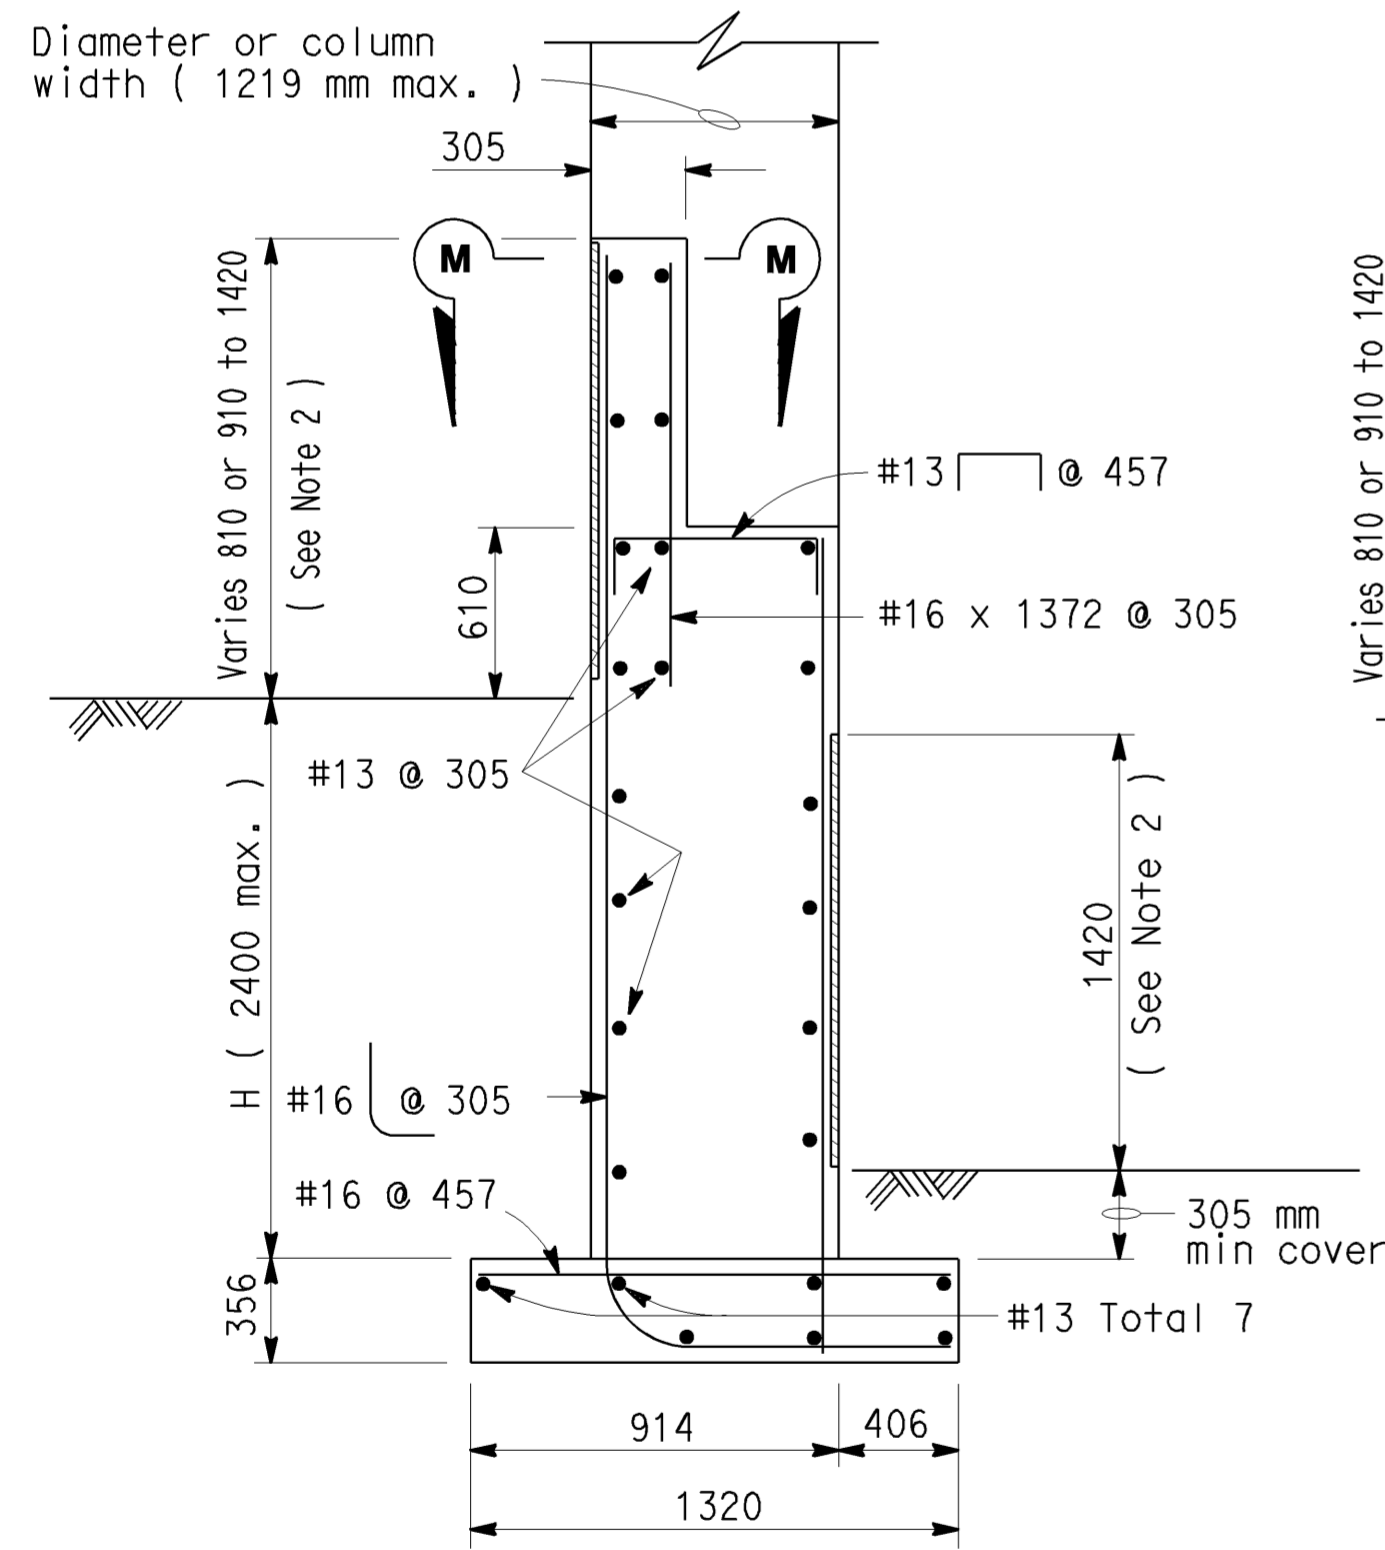


TYPICAL SECTION

Roadway offsets greater than 914 mm
Column widths 1219 mm or less

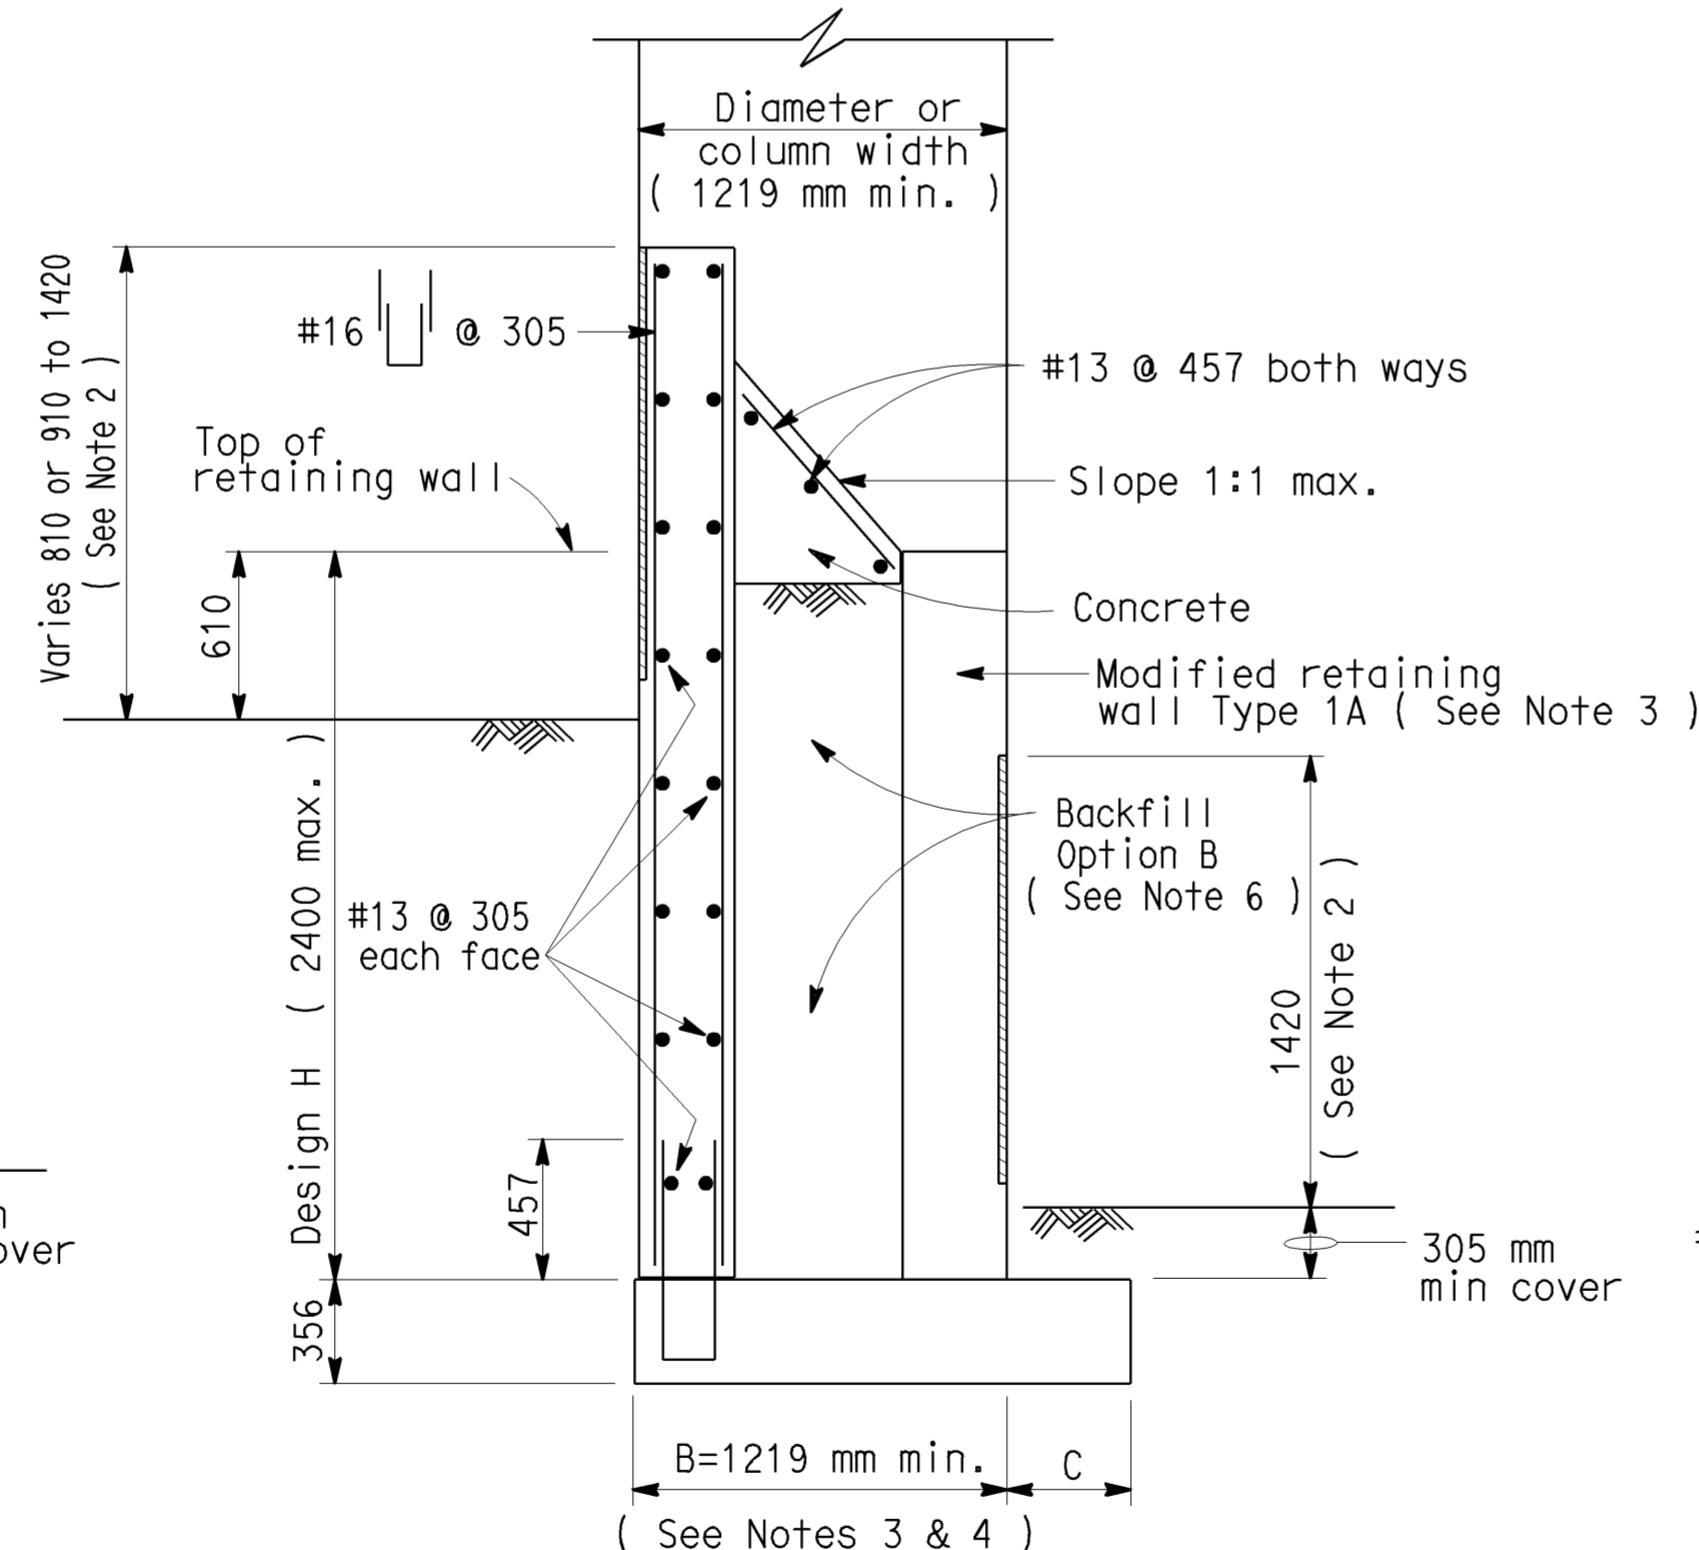


TYPICAL SECTION


Roadway offsets greater than 914 mm
Column widths greater than 1219 mm

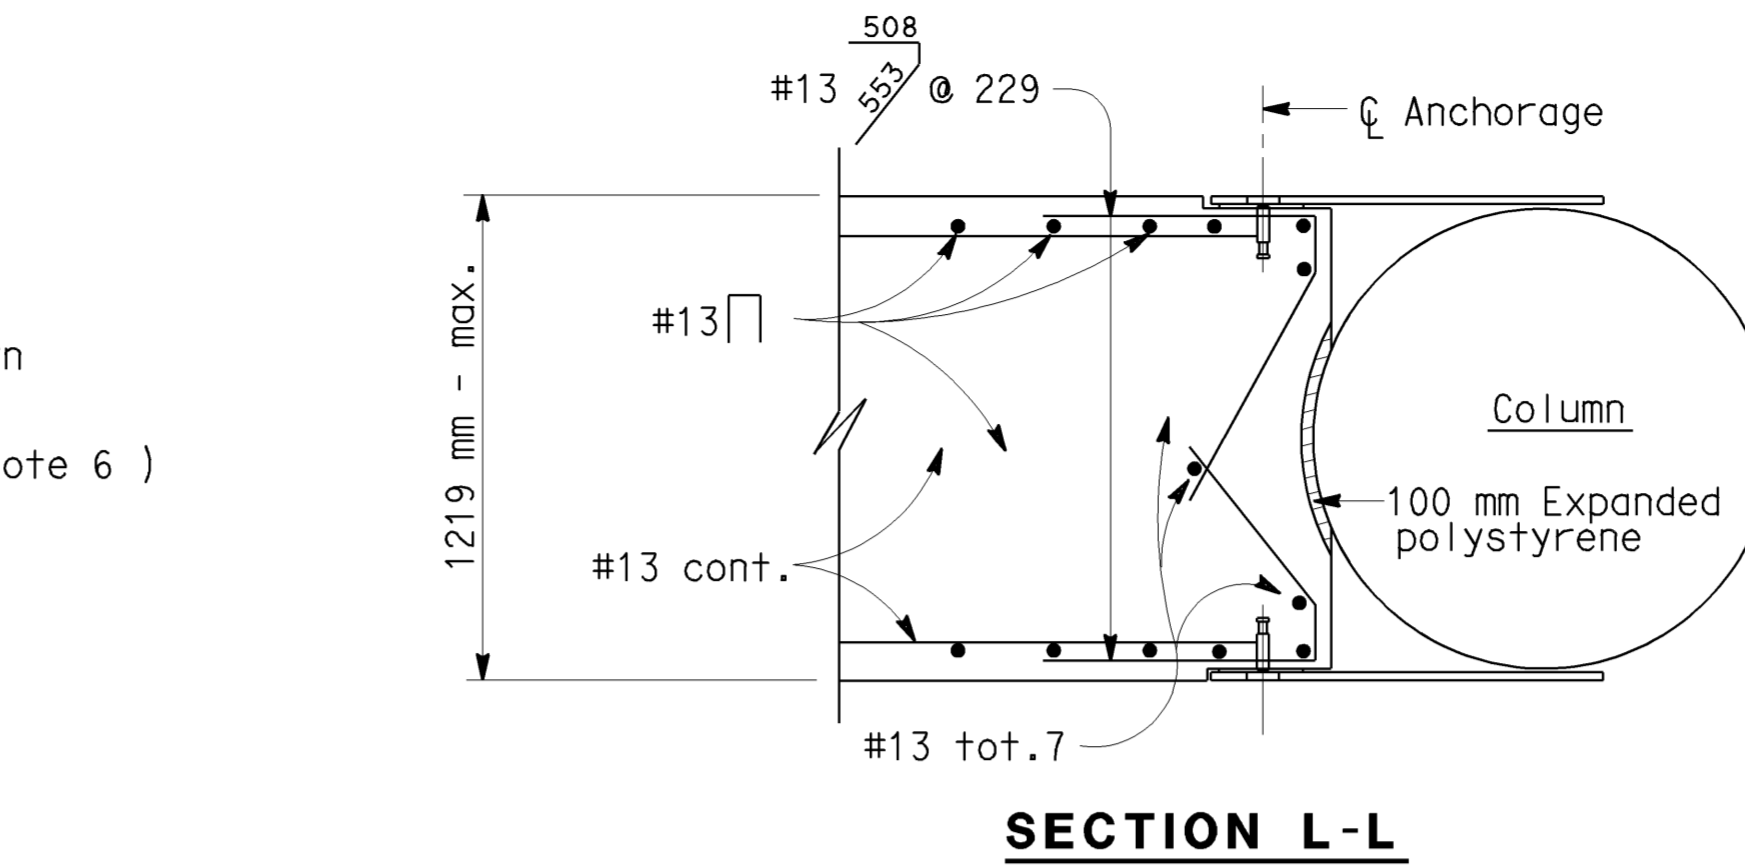


SECTION L-L

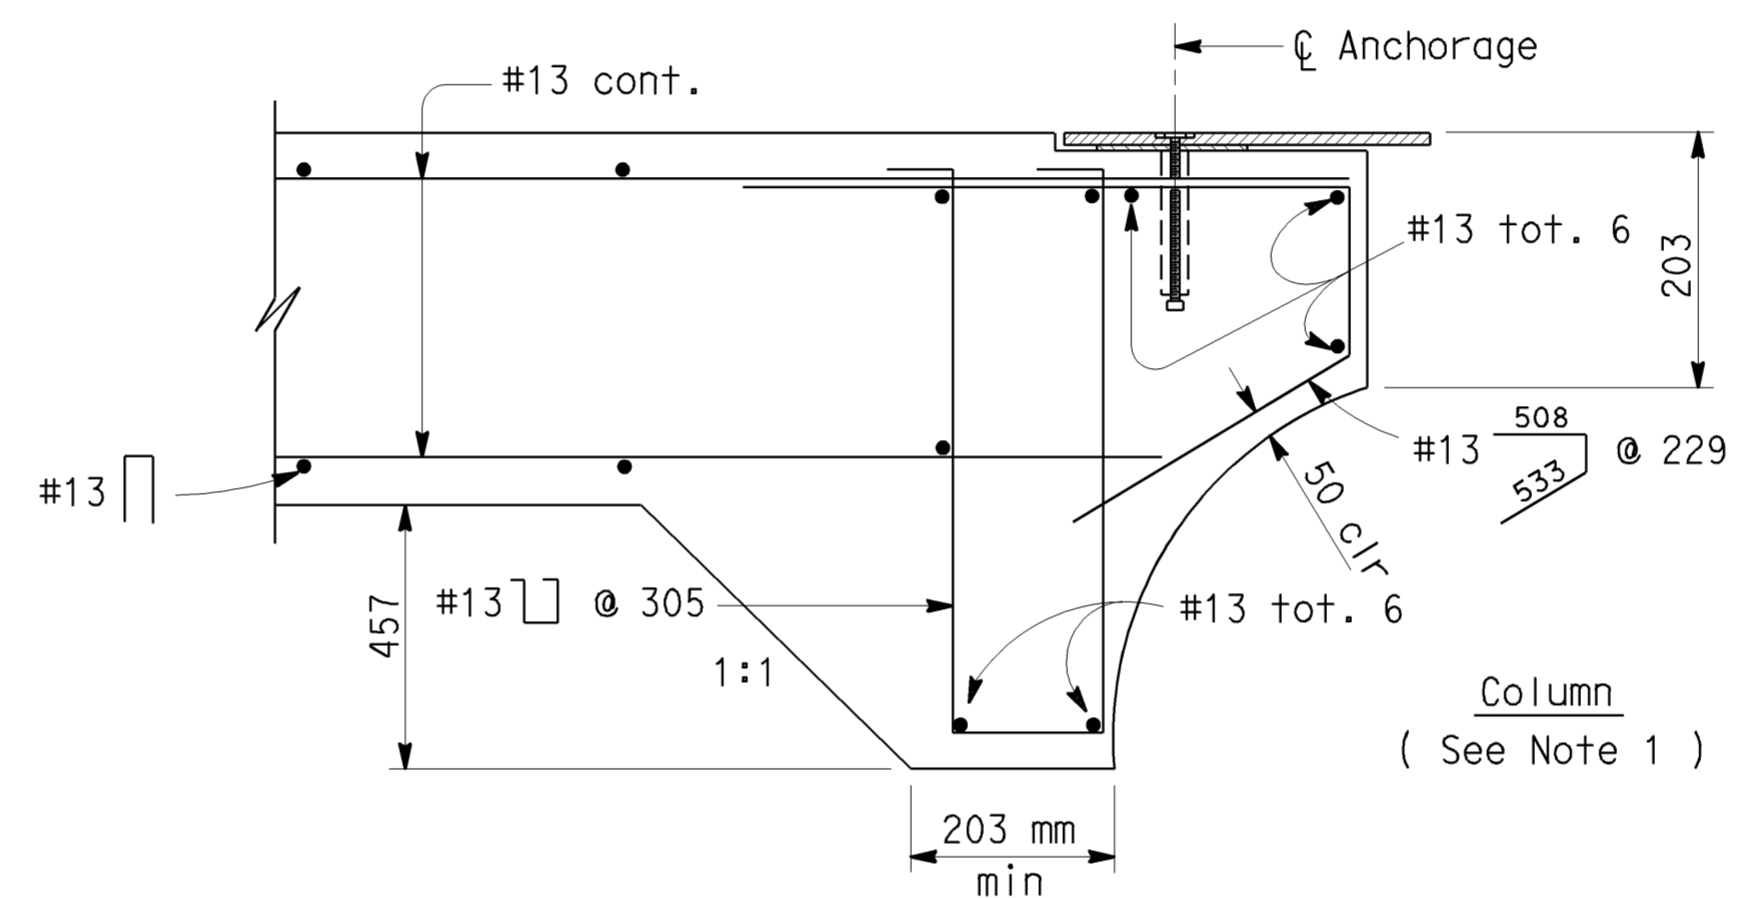

SECTION M-M

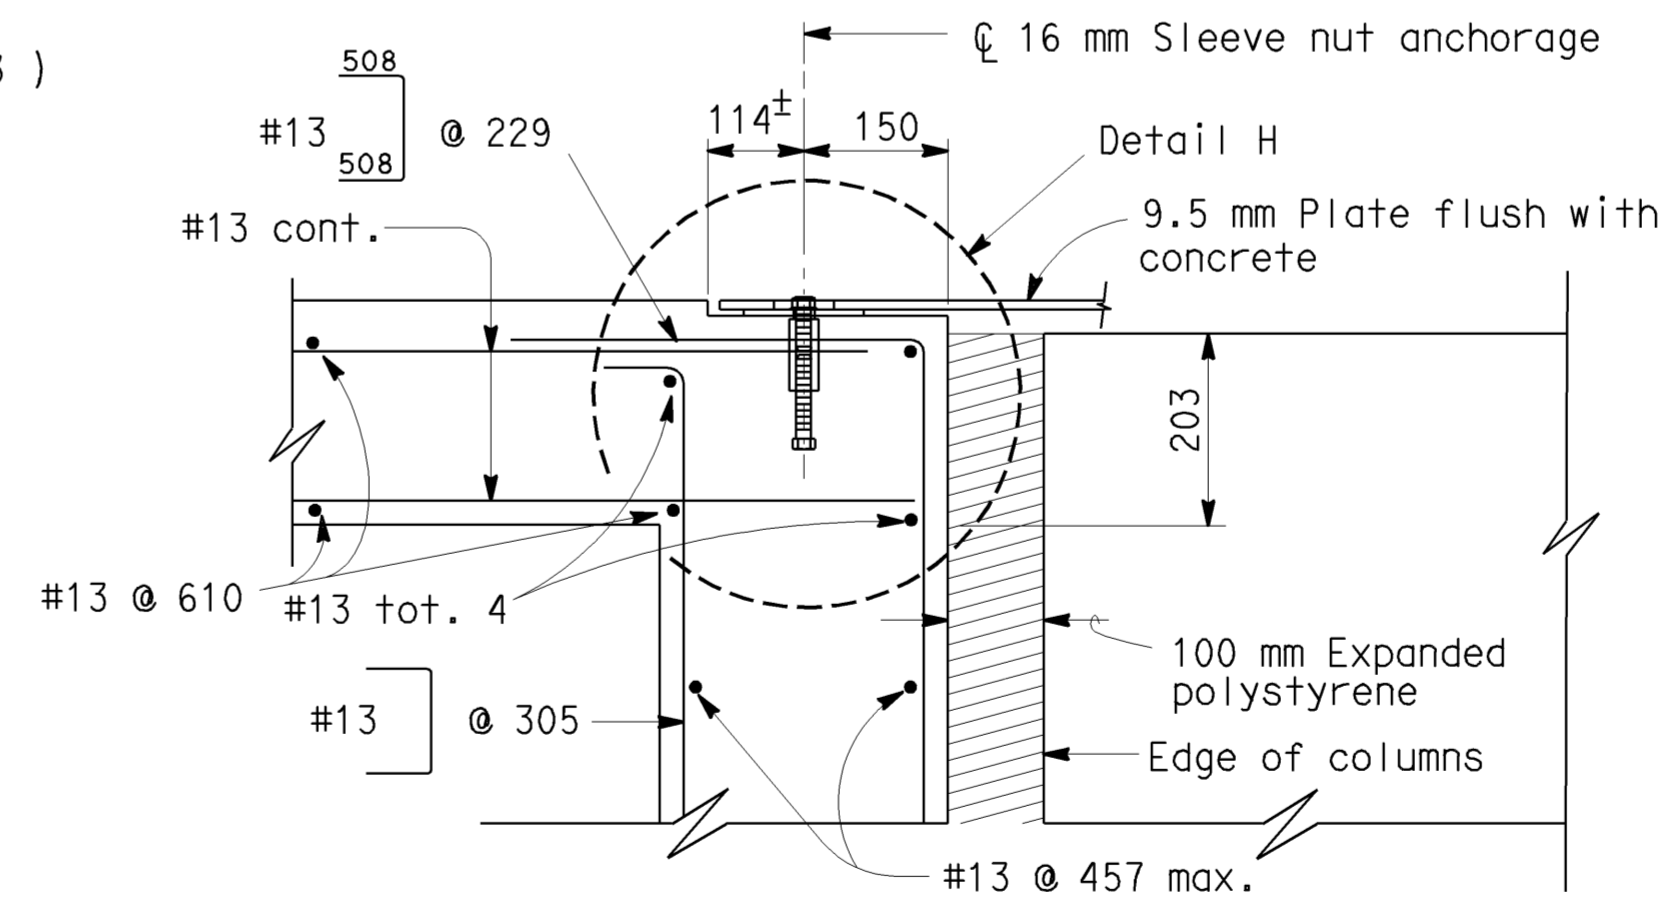

DETAIL G

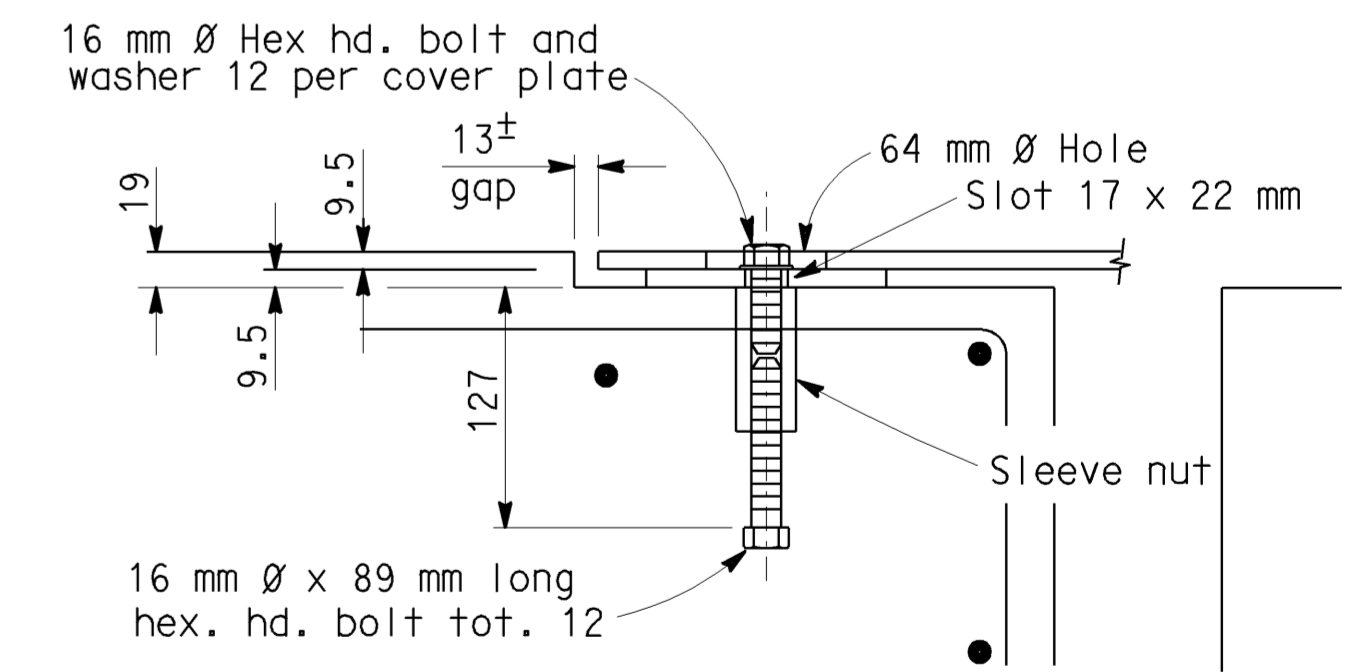

DETAIL H

- NOTES:**
- These details are to be combined with "Concrete Barrier Type 60 R" Sheet No.1. Details not indicated are similar to the details shown elsewhere on said sheet.
 - Metal plate details at columns shown on Concrete Barrier Type 60 R Sheet No.1.
 - For Retaining Wall Type 1A details, see Standard Plans.
 - Extend retaining wall footing dimension "B" to satisfy column width as indicated.
 - Extend reinforcement as shown in Section C-C on Concrete Barrier Type 60 R Sheet No.1.
 - Contractor options for fill between barrier walls:
 - (A) Place PCC between barrier walls, may be placed monolithic.
 - (B) Place granular material from base to bottom of concrete cap.

NO SCALE
ALL DIMENSIONS ARE IN MILLIMETERS UNLESS OTHERWISE SHOWN

C-3

STANDARD DRAWING			
RELEASE DATE 8/26/03	DESIGN BY R. BISHOP	CHECKED D. SOON	RELEASED BY
FILE NO. xs16-090-2	DETAILS BY BEN MATSUO	CHECKED R. BISHOP	
	SUBMITTED BY R.C. ANDERSON	DRAWING DATE 6/99	OFFICE CHIEF

STATE OF CALIFORNIA
DEPARTMENT OF TRANSPORTATION
DIVISION OF ENGINEERING SERVICES

BRIDGE NO. Var
KILOMETER POST Var

CONCRETE BARRIER (TYPE 60R)
TRANSITION AT BRIDGE COLUMN

DS OSD 2147A (METRIC) (REV. 2/25/97)

ORIGINAL SCALE IN MILLIMETERS FOR REDUCED PLANS

CU 07276
EA 121841

DISREGARD PRINTS BEARING EARLIER REVISION DATES

REVISION DATES (PRELIMINARY STAGE ONLY)

SHEET 2 OF 2

USERNAME => trpierce

712184g003.dgn


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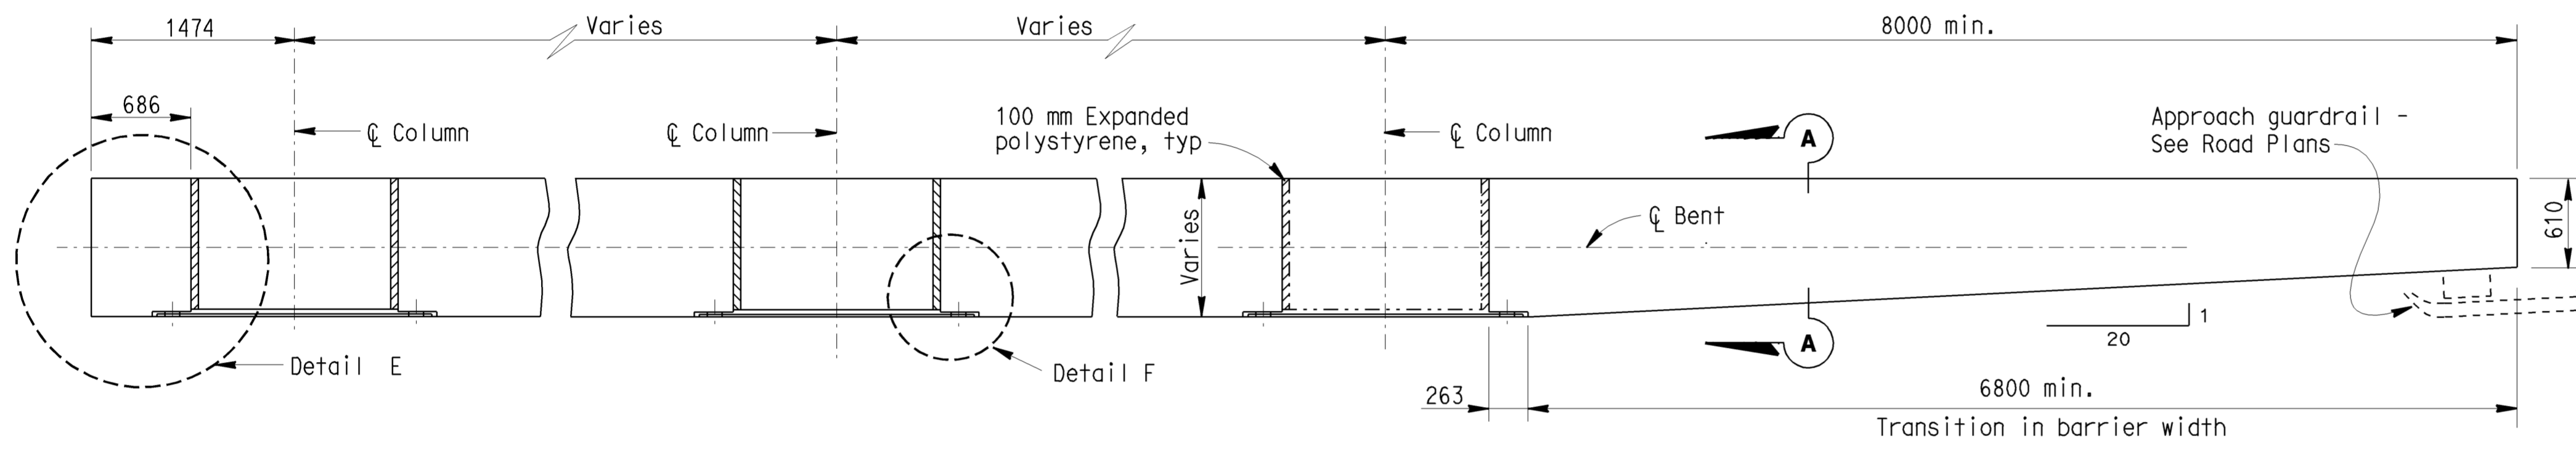
DIST	COUNTY	ROUTE	KILOMETER POST TOTAL PROJECT	SHEET No	TOTAL SHEETS
07	LA	5	42.8/47.3	45	1073

REGISTERED CIVIL ENGINEER	
6-8-09	
PLANS APPROVAL DATE	


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PLAN-CIRCULAR COLUMNS



PLAN-RECTANGULAR COLUMNS

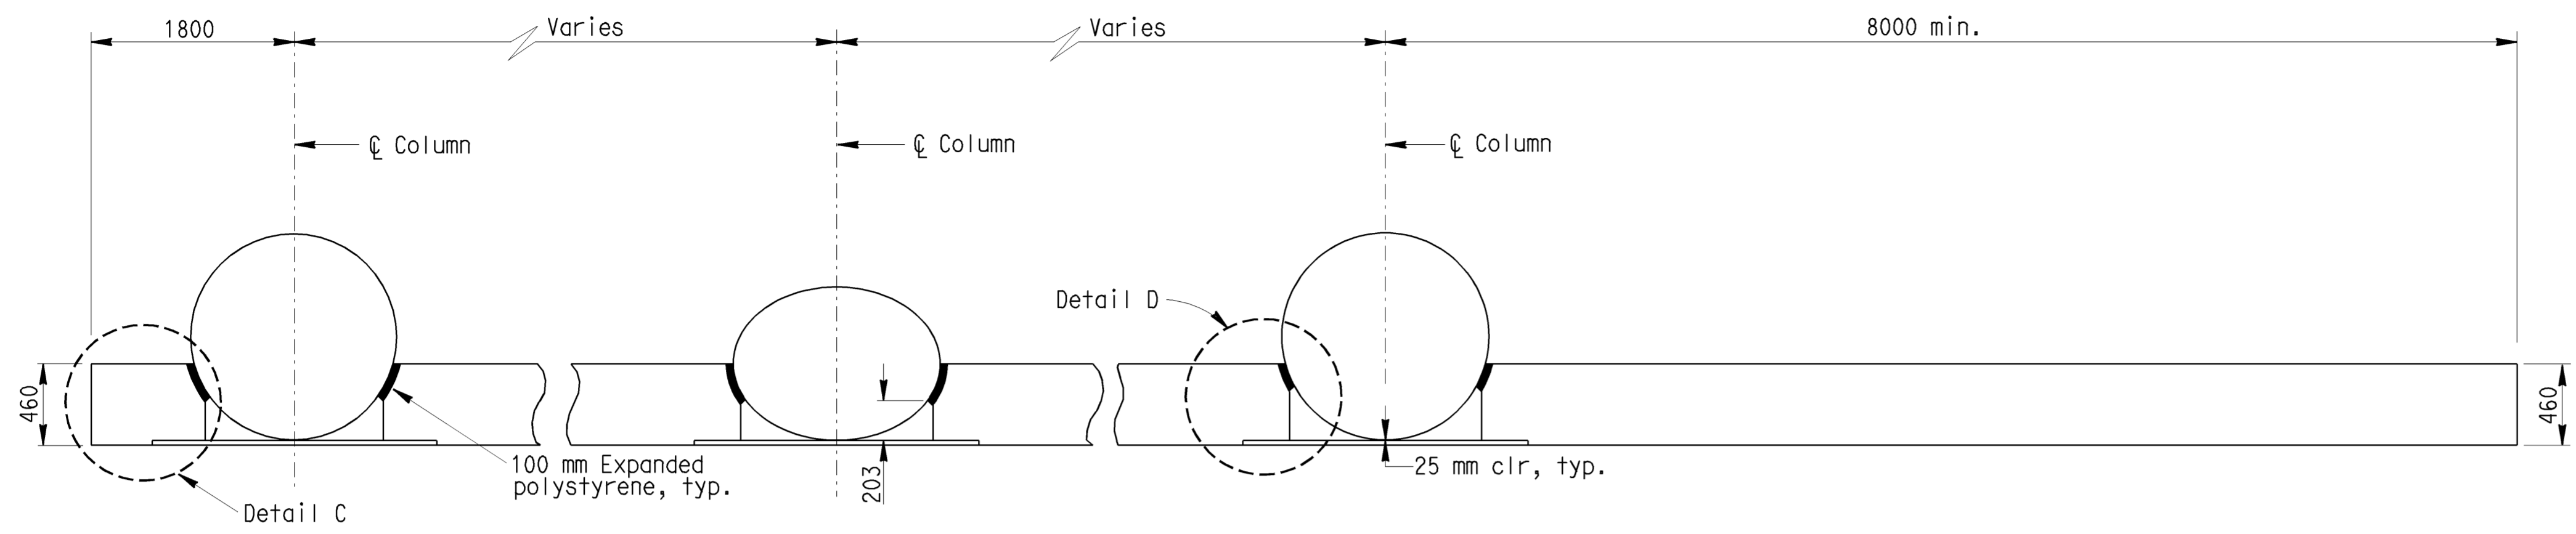


ALTERNATIVE ANCHORAGE

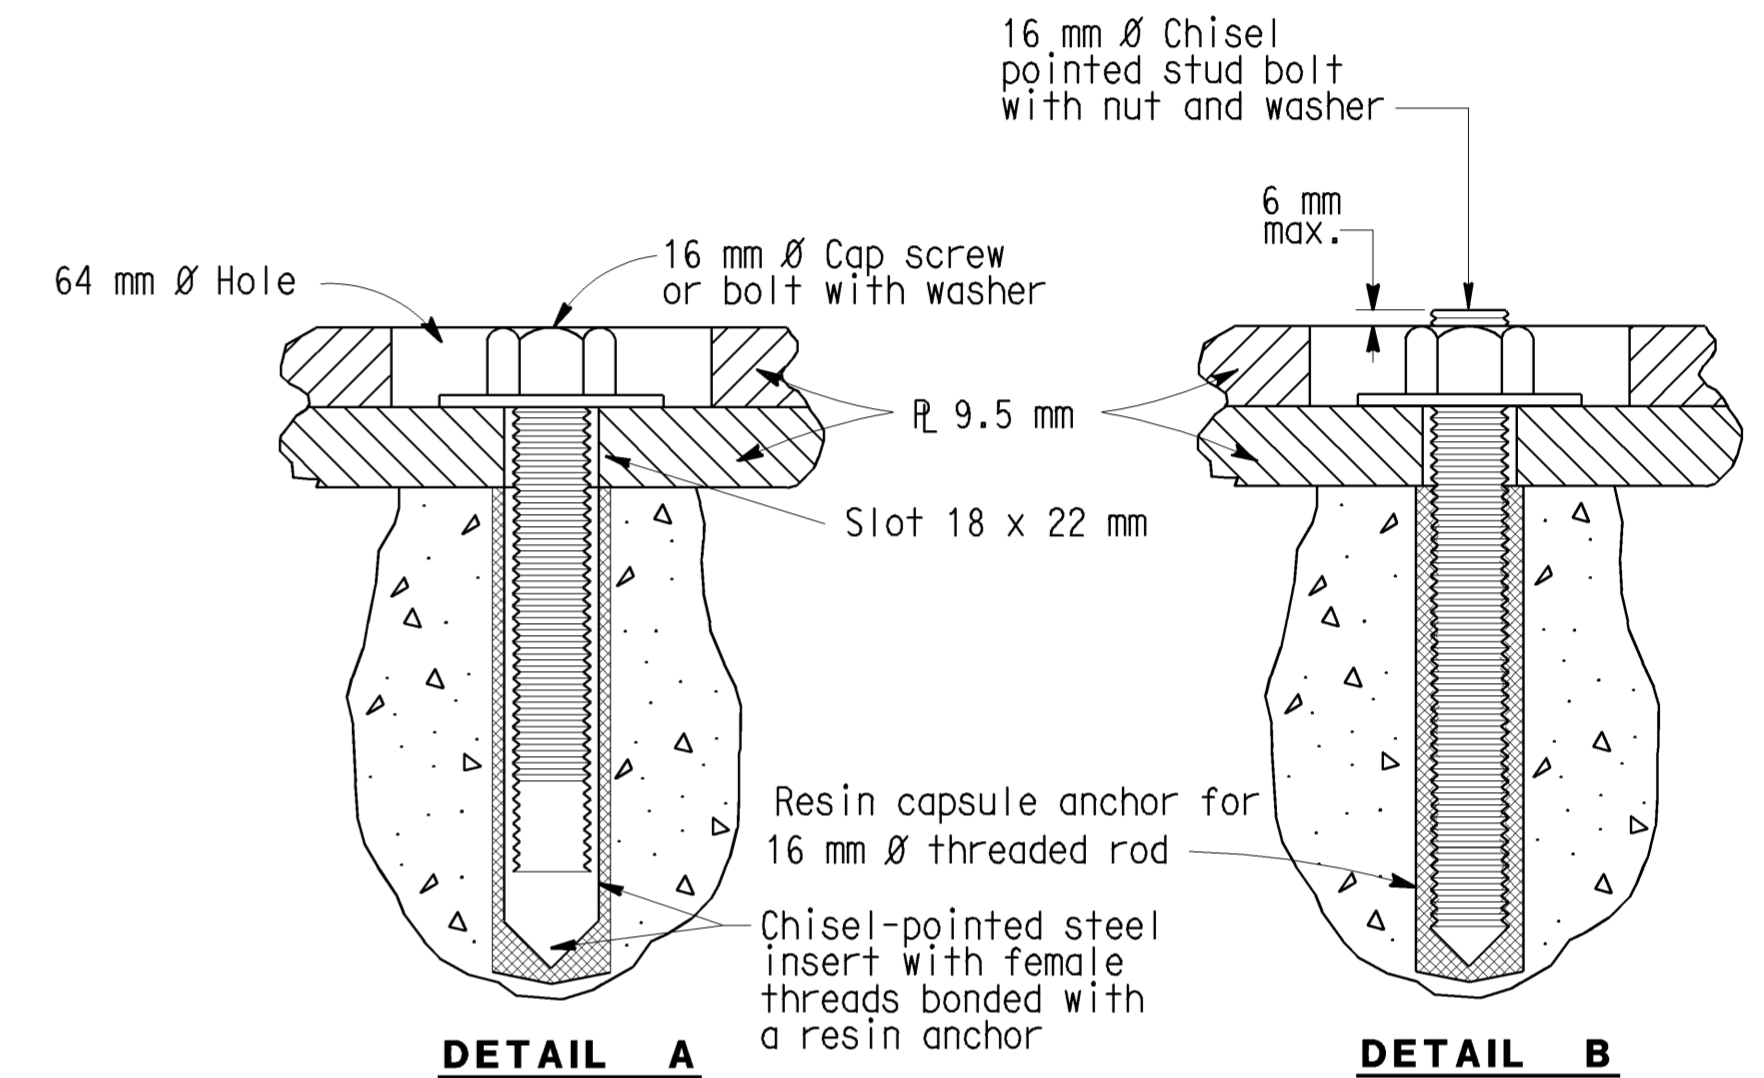See Notes 1 and 2

NOTES:

1. Resin capsule anchorage is subject to approval of the engineer. Installation procedures shall comply with manufacturer's instructions.
2. Detail B similar to Detail A except for anchorage devices.
3. For drainage control, see "Roadway Plans".
4. The contractor shall verify all controlled field dimensions before ordering or fabricating any materials.

16 mm Ø Sleeve nut anchorage (See Detail D) or resin capsule anchorage (See Alternative Anchorage). A total of 12 anchorage units required per plate. All material plates to be galvanized after fabrication. Hardware to be galvanized or non-corrosive

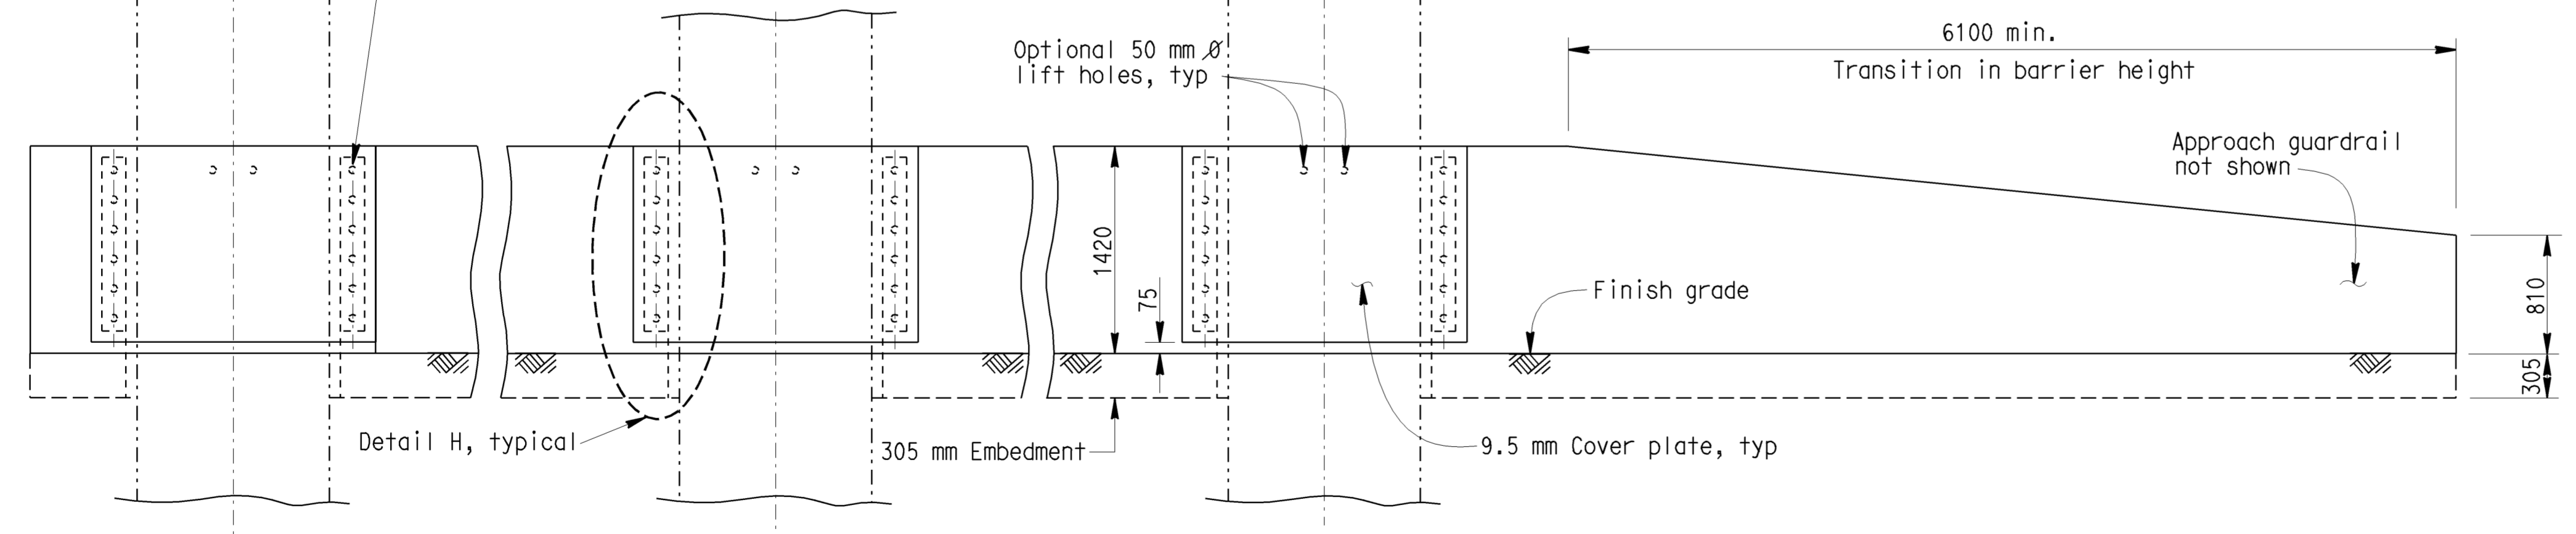

ELEVATION

NO SCALE
ALL DIMENSIONS ARE IN MILLIMETERS UNLESS OTHERWISE SHOWN **C-4**


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RELEASE DATE 8/26/03	DESIGN BY N ABDIN	CHECKED FELIX ALTAMIRANO	RELEASED BY <i>Roberto Conalle</i>
FILE NO. xs16-110-1	DETAILS BY R YEE	CHECKED N ABDIN	OFFICE CHIEF
	SUBMITTED BY N ABDIN	DRAWING DATE 8/99	

STATE OF CALIFORNIA
DEPARTMENT OF TRANSPORTATION

DIVISION OF ENGINEERING SERVICES

BRIDGE NO. Var	BARRIER - CONCRETE TYPE 60
KILOMETER POST Var	
VERTICAL FACE FOR SIDE OF ROAD	

STRUCTURES STANDARD DRAWING SHEET (METRIC) (REV. 3/1/99)

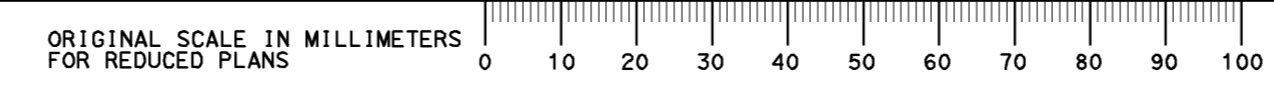

CU 07276
EA 121841

DISREGARD PRINTS BEARING EARLIER REVISION DATES

REVISION DATES (PRELIMINARY STAGE ONLY)

SHEET 1 OF 2

USERNAME => trmikes1

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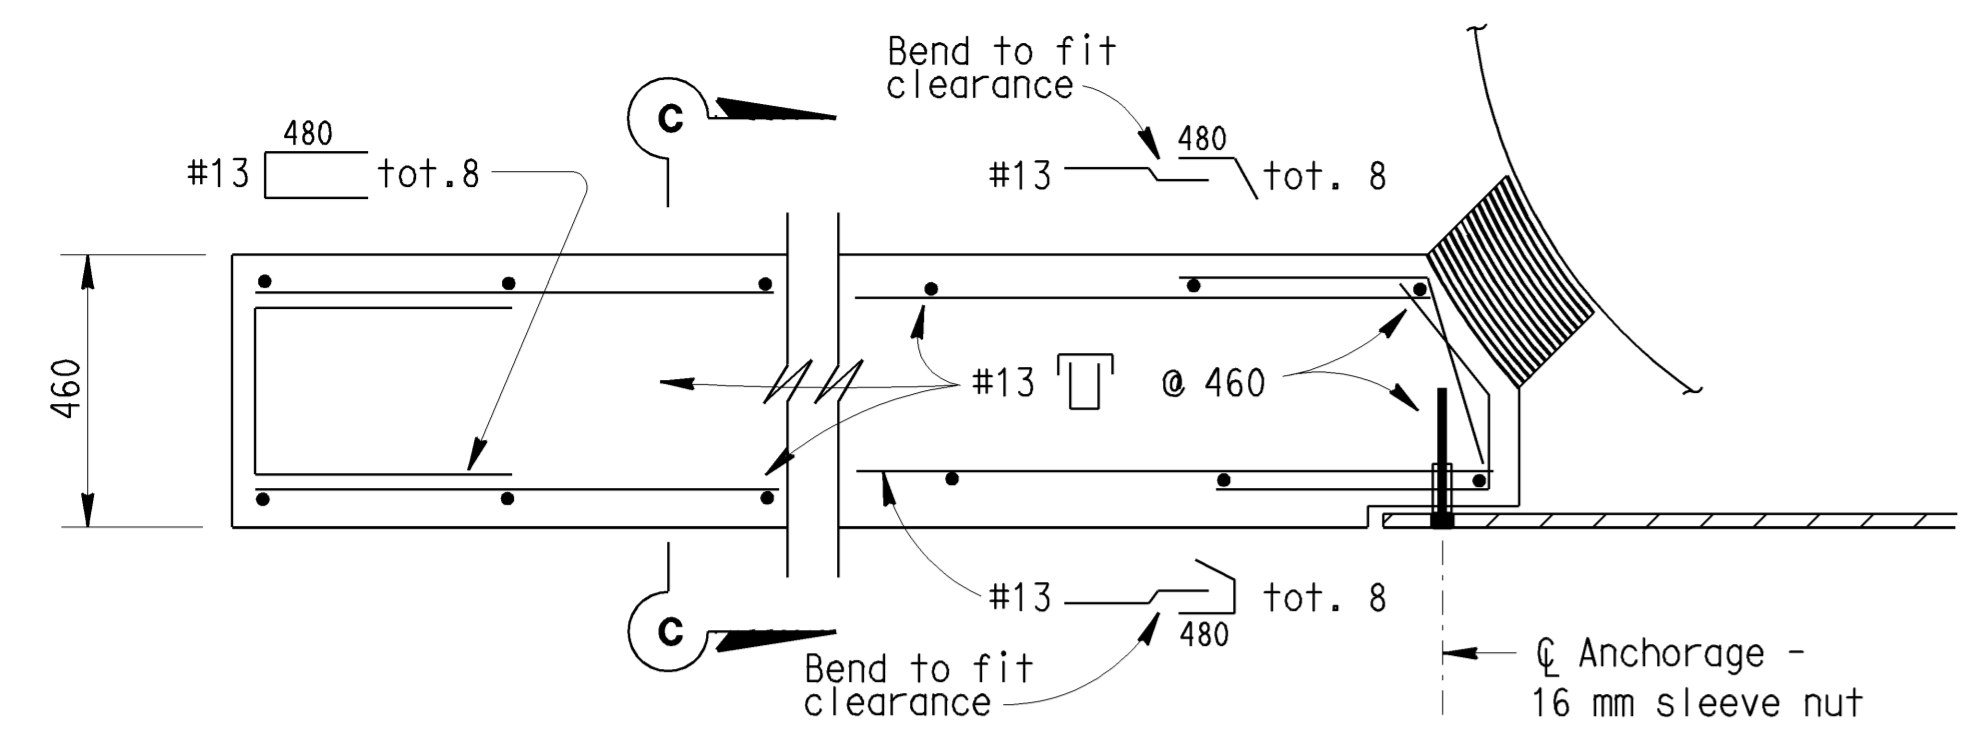
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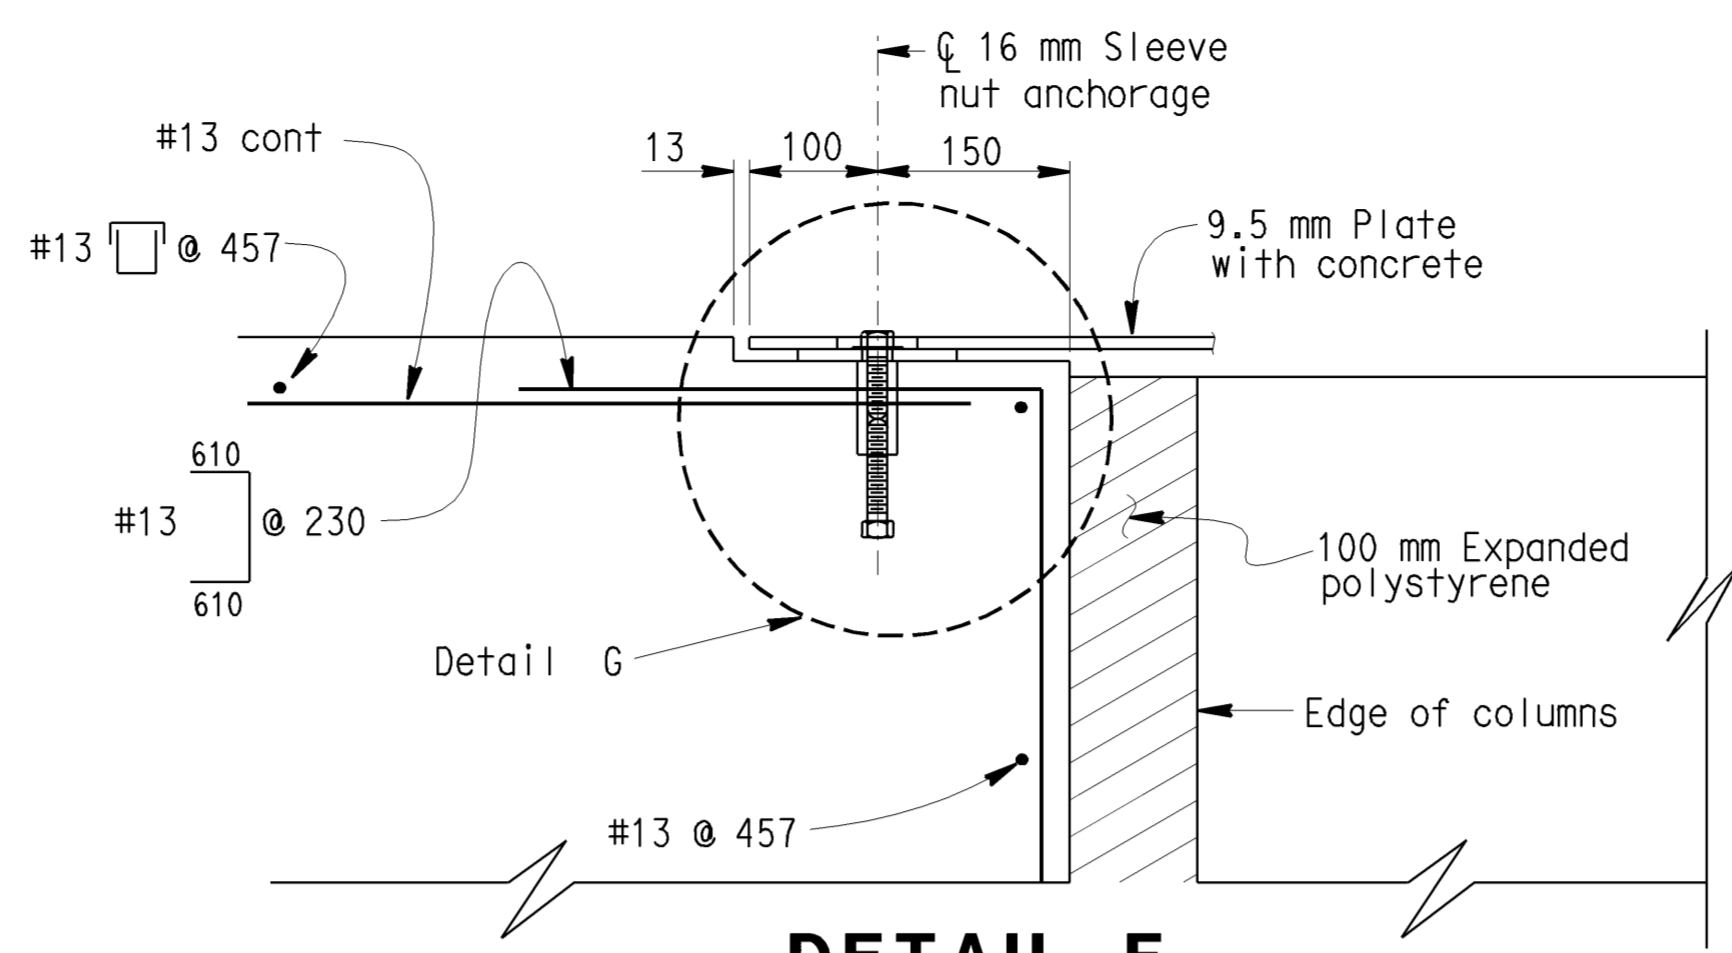
DIST	COUNTY	ROUTE	KILOMETER POST TOTAL PROJECT	SHEET No	TOTAL SHEETS
07	LA	5	42.8/47.3	46	1073

REGISTERED CIVIL ENGINEER	
6-8-09	
PLANS APPROVAL DATE	
REGISTERED PROFESSIONAL ENGINEER MUNSHI MOHSIN No. 61916 Exp. 9/30/09 STATE OF CALIFORNIA	


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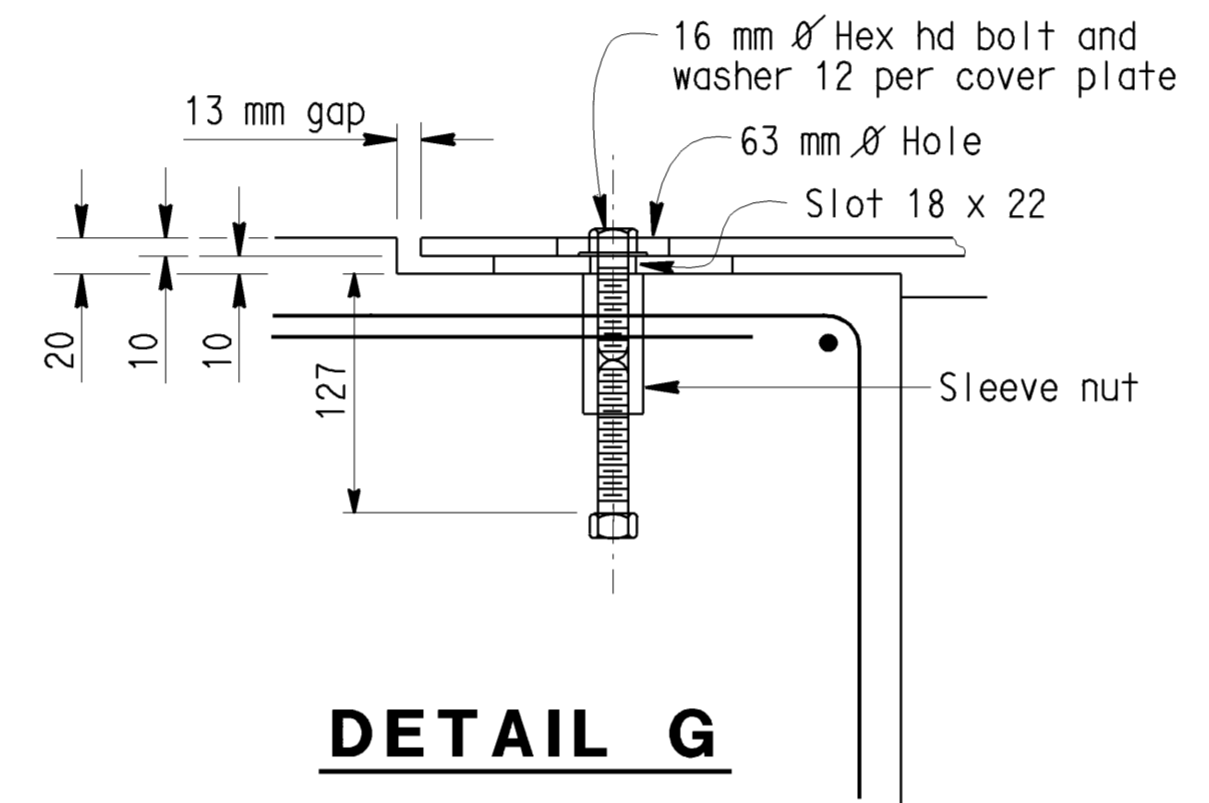
DETAIL C




DETAIL F




DETAIL D

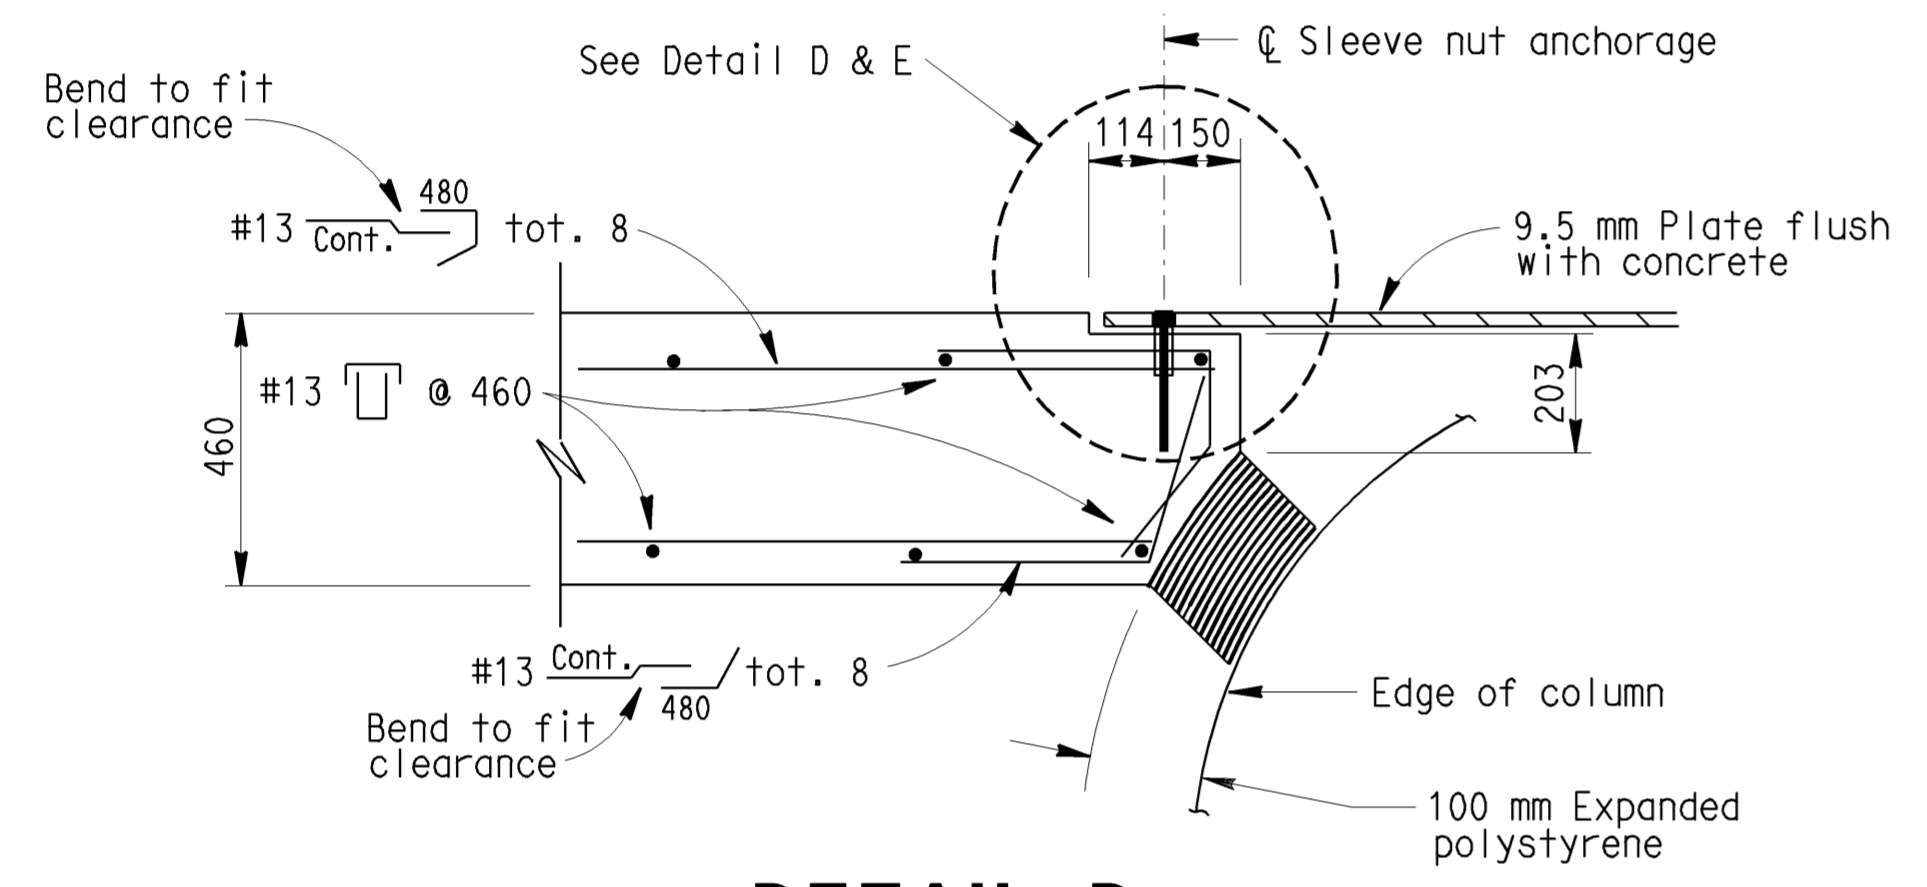


DETAIL G

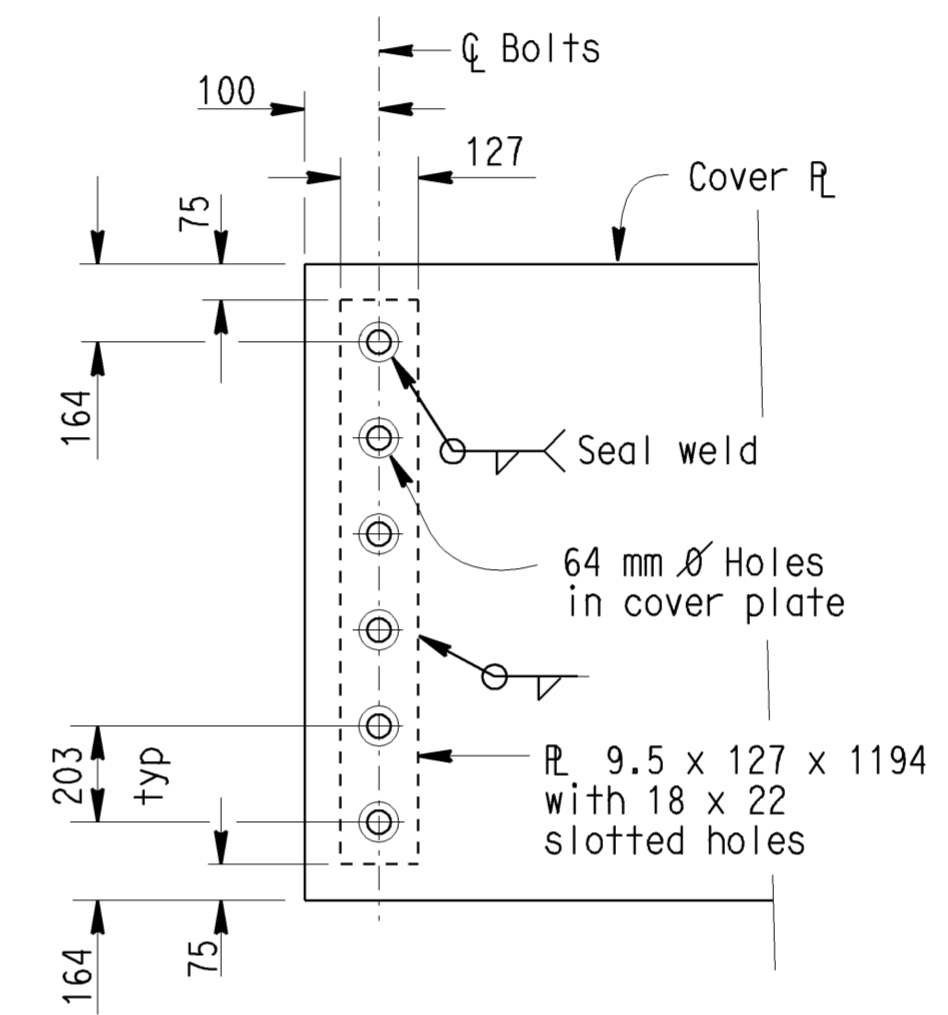


DETAIL H

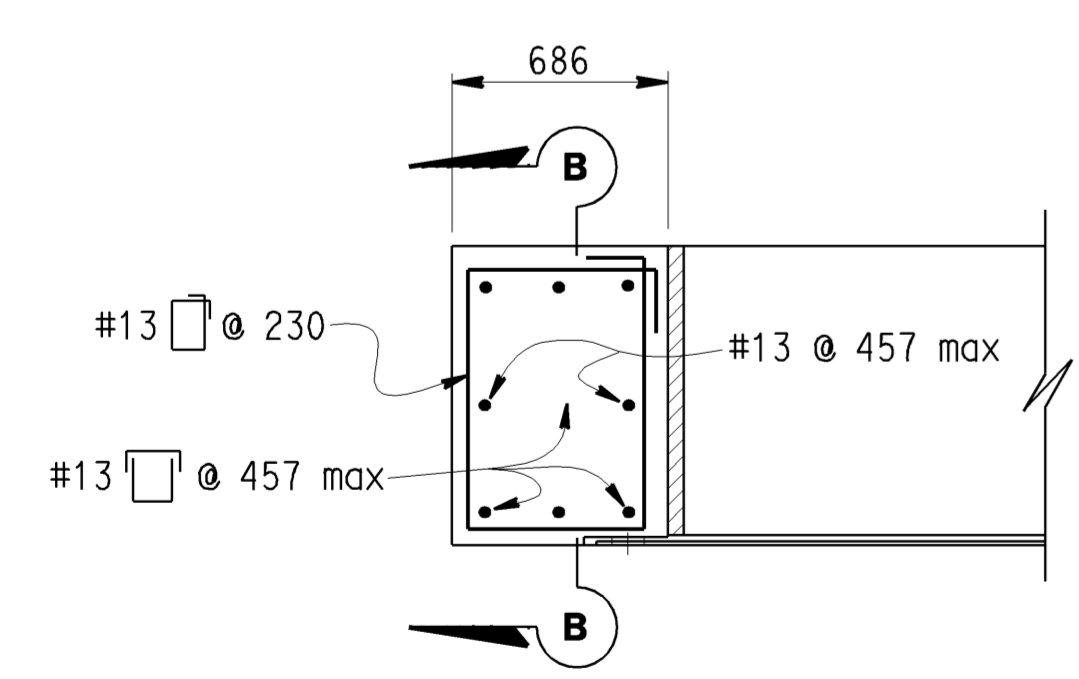


DETAIL E

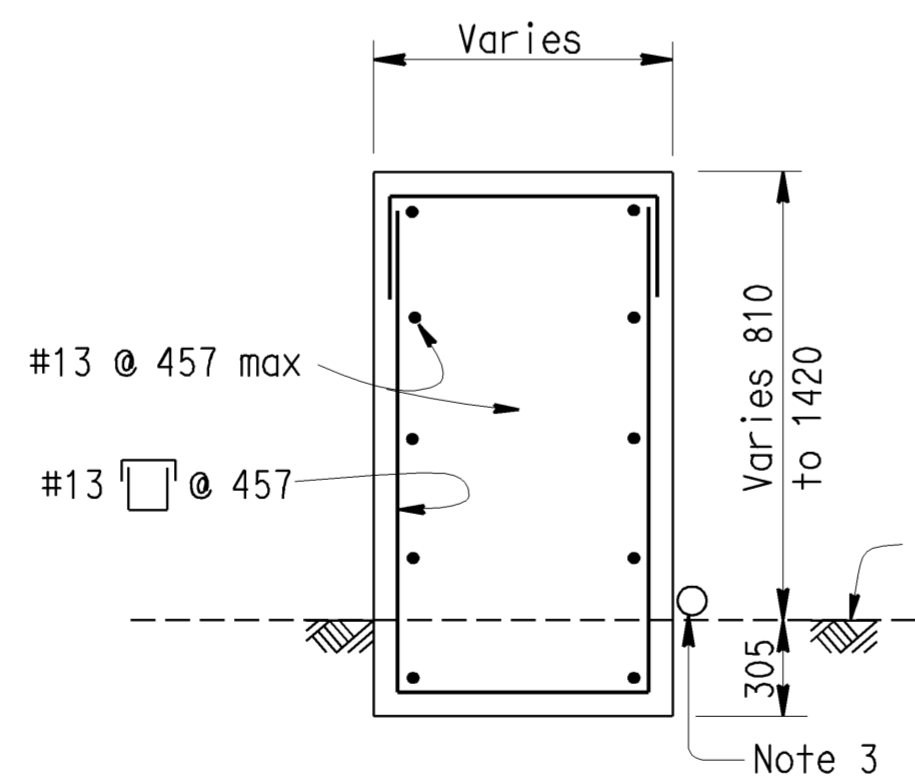

SECTION A-A

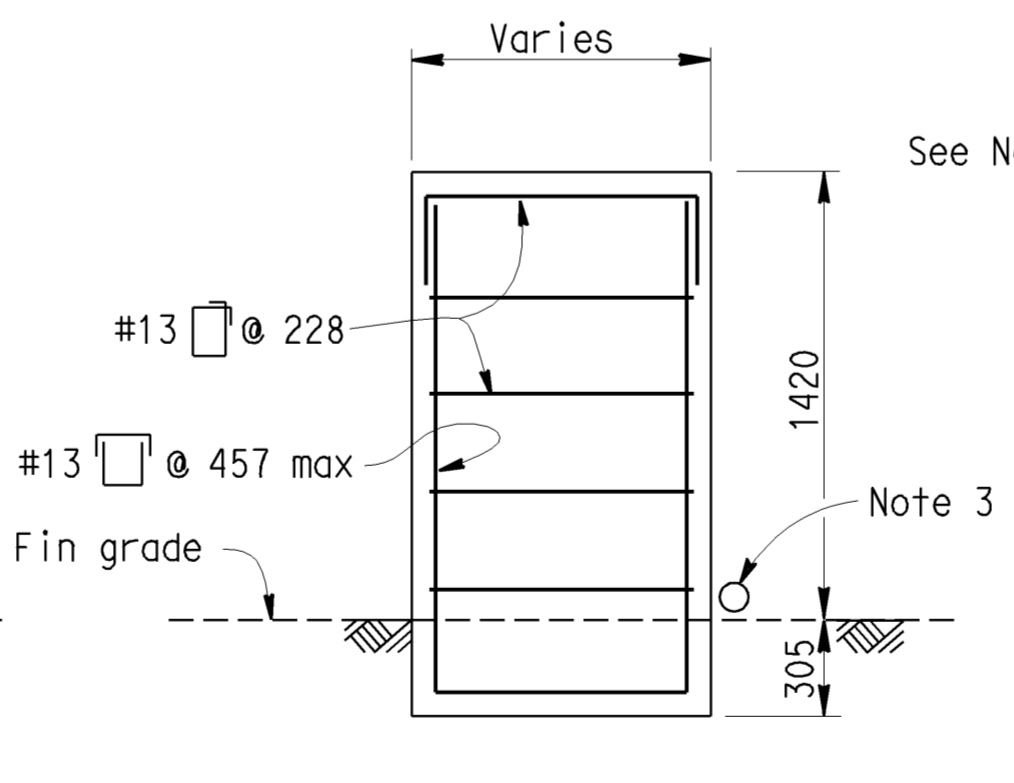

SECTION B-B

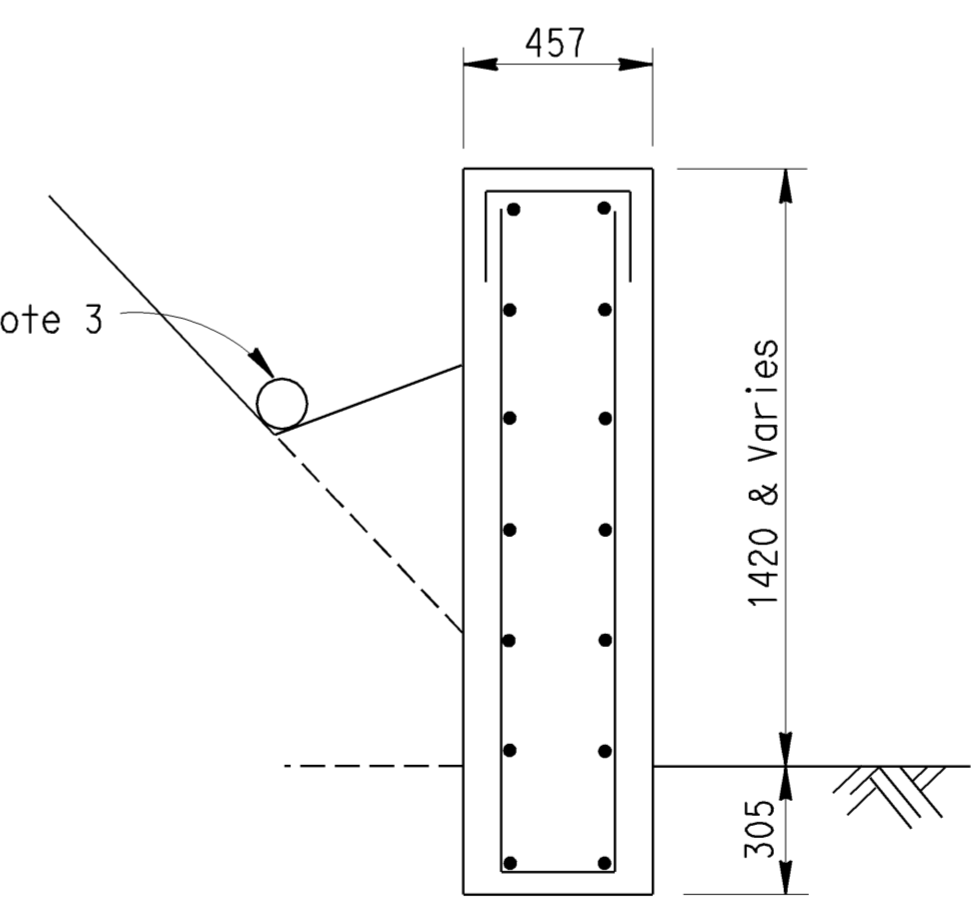

SECTION C-C

NO SCALE
 ALL DIMENSIONS ARE IN MILLIMETERS UNLESS OTHERWISE SHOWN **C-5**

STANDARD DRAWING			
RELEASE DATE 8/26/03	DESIGN BY N ABDIN	CHECKED FELIX ALTAMIRANO	RELEASED BY
FILE NO. xs16-110-2	SUBMITTED BY N ABDIN	CHECKED N ABDIN	<i>Roberto Trucillo</i> OFFICE CHIEF
DRAWING DATE 8/99			

STATE OF CALIFORNIA
 DEPARTMENT OF TRANSPORTATION
 DIVISION OF ENGINEERING SERVICES

BRIDGE NO. Var	BARRIER - CONCRETE TYPE 60
KILOMETER POST Var	
VERTICAL FACE FOR SIDE OF ROAD	

STATE OF CALIFORNIA - DEPARTMENT OF TRANSPORTATION
Caltrans OFFICE OF DESIGN D

FUNCTIONAL SUPERVISOR
 CELINA AVILES

CALCULATED-DESIGNED BY
 CHECKED BY

DESIGNED BY
 MUNSHI MOHSIN

REVISOR BY
 DATE REVISED

KP
 11/08

CTT
 03/04/09





Dist	COUNTY	ROUTE	KILOMETER POST TOTAL PROJECT	SHEET No.	TOTAL SHEETS
07	LA	5	42.8/47.3	47	1073

REGISTERED CIVIL ENGINEER
 2-24-09
 DATE

PLANS APPROVAL DATE
 6-8-09

REGISTERED PROFESSIONAL ENGINEER
 MUNSHI MOHSIN
 No. 61916
 Exp. 9/30/09
 CIVIL
 STATE OF CALIFORNIA


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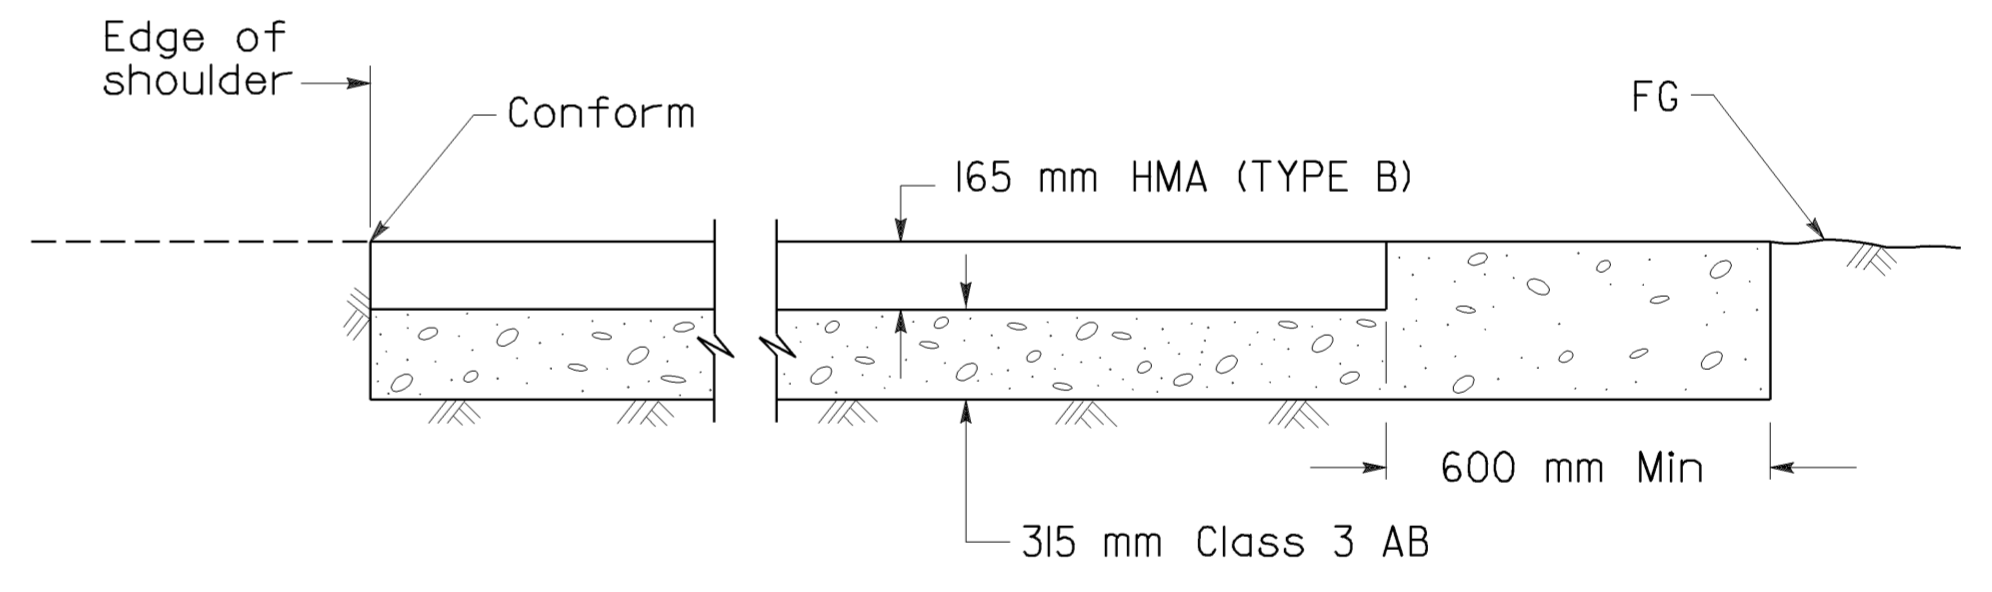
**TRANSITION CONCRETE BARRIER (TYPE 60W)
 TO CONCRETE BARRIER (TYPE 50)**

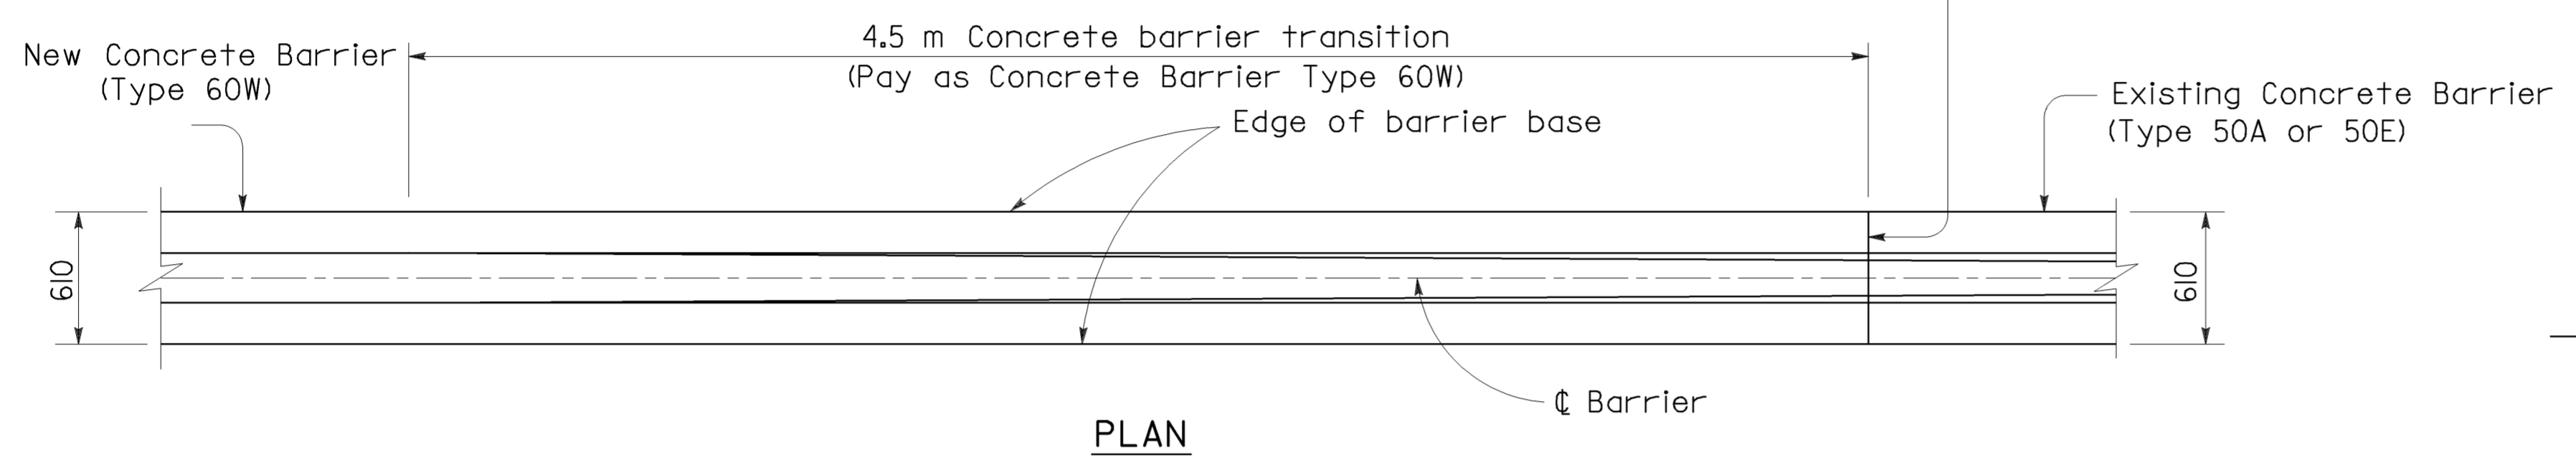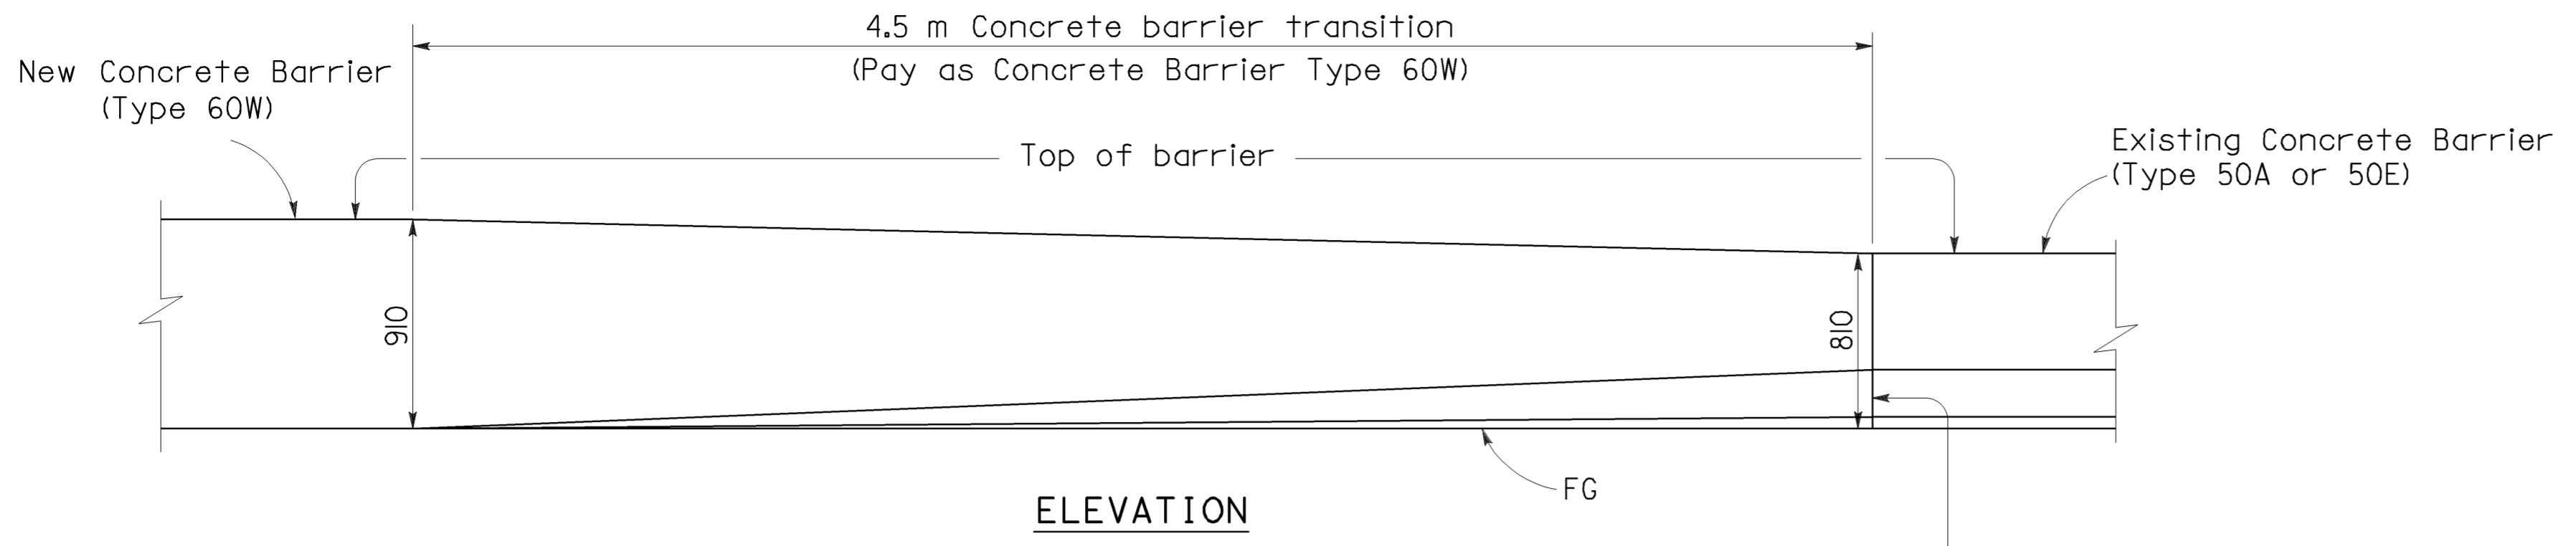NOTES

1. See Drainage Detail Sheets for Concrete Barrier Type 60W.
2. Footing monolithic or doweled with 2-#25x205 mm @ 610 mm. The footing is required at concrete barrier ends and at interruptions in concrete barrier.
3. Expansion joints in concrete barrier shall be located at all deck, pavement and principal wall joints. Expansion joint filler material shall be the same size as joint or 13 mm minimum.




PLAN

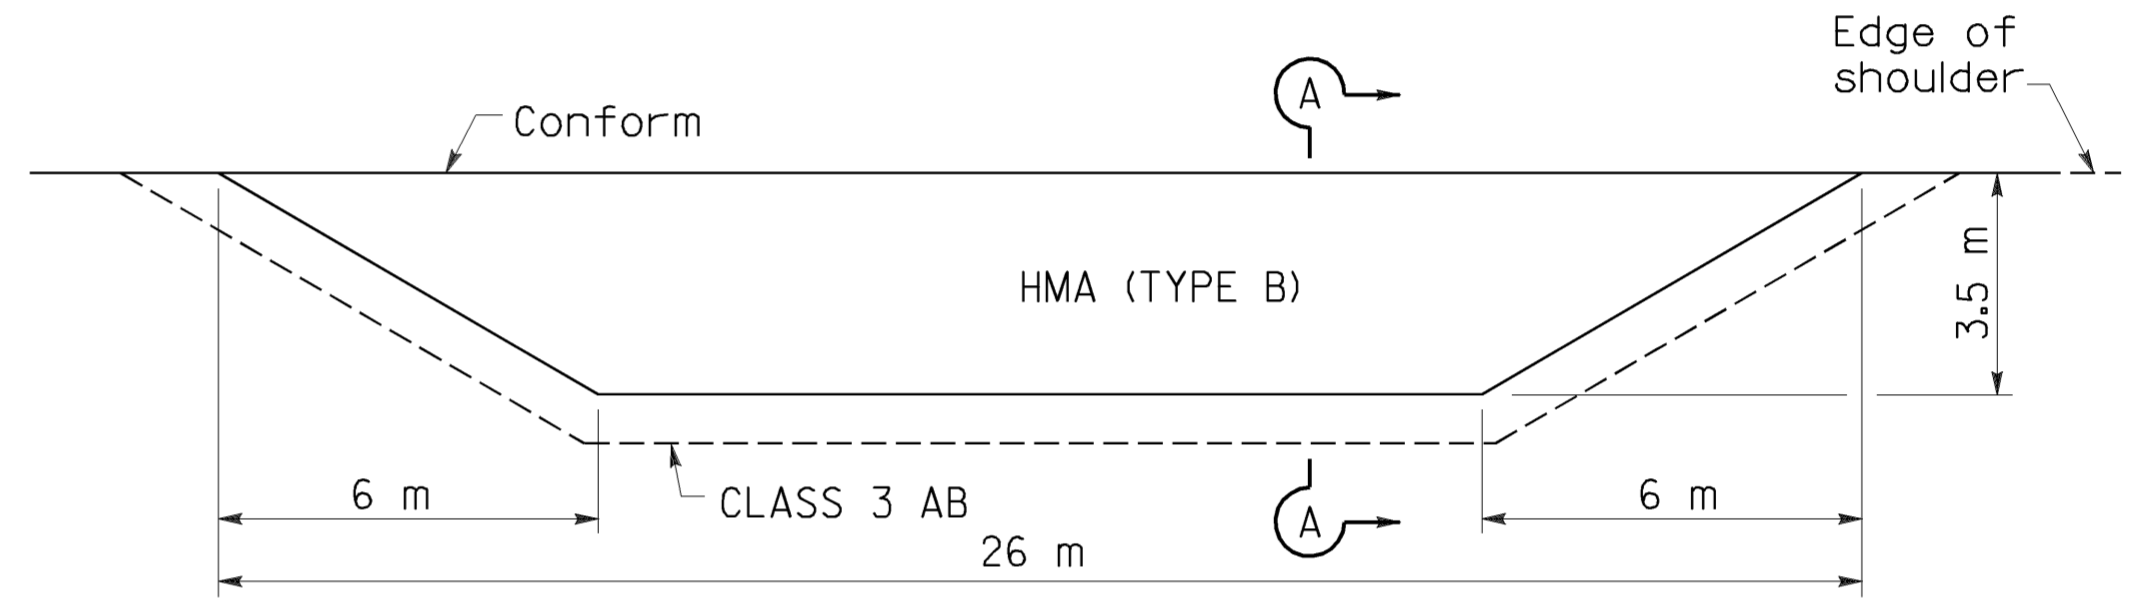

SECTION A-A

MAINTENANCE VEHICLE PULLOUT

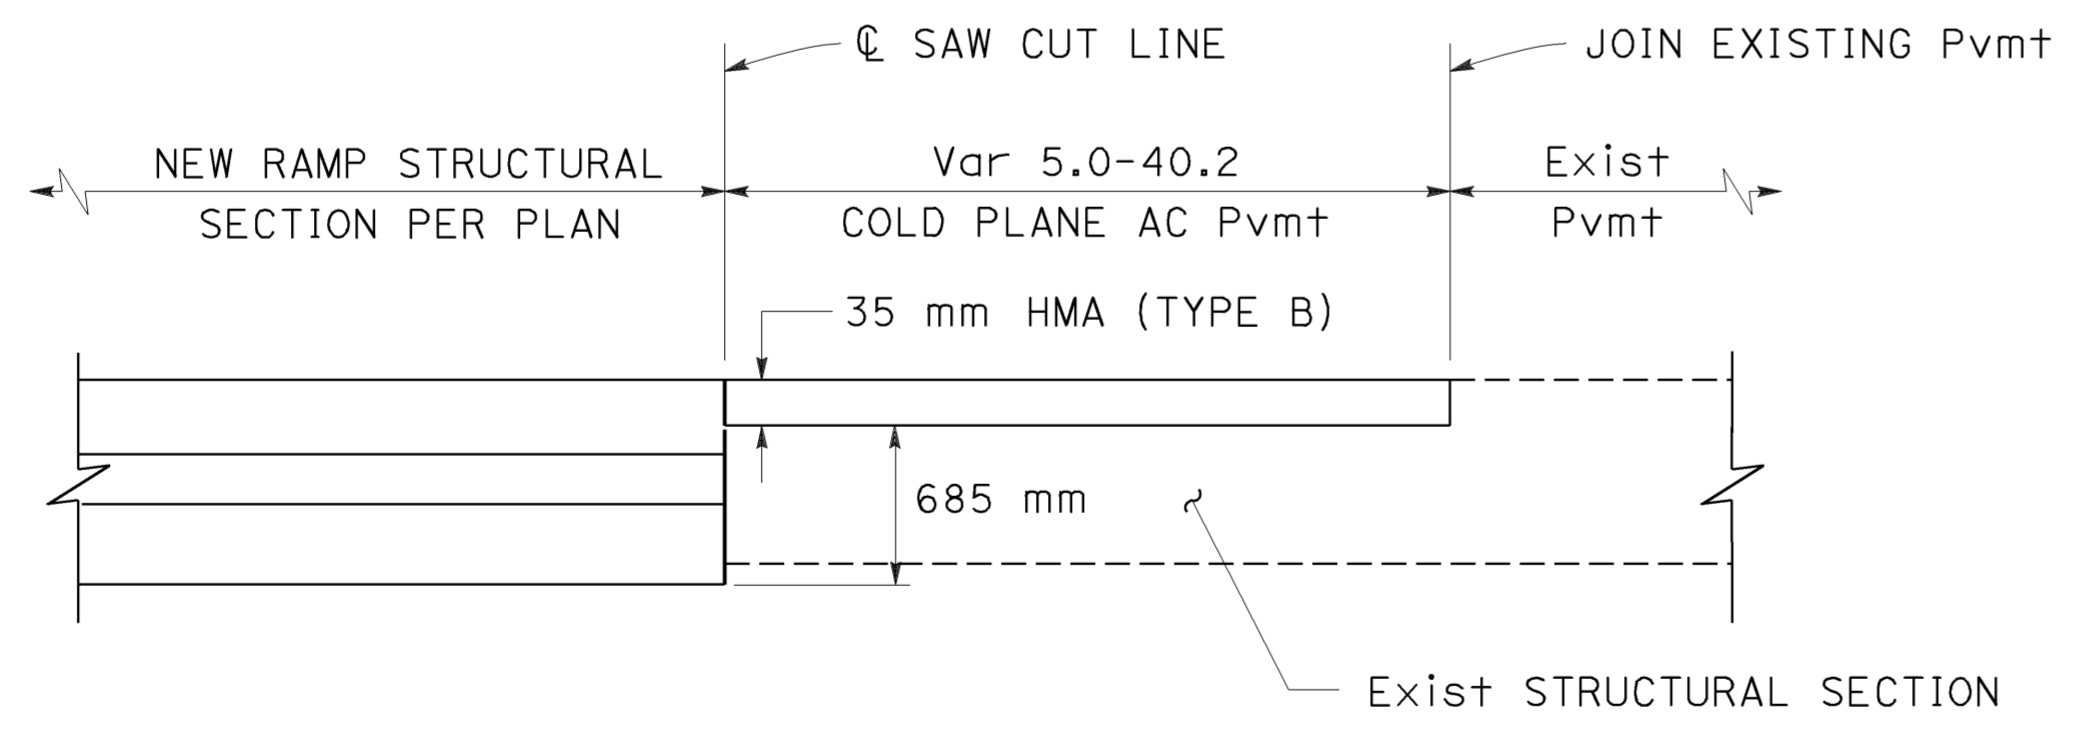

**TYPICAL RAMP DETAIL
 (COLD PLANE)**

LONGITUDINAL RAMP COLD PLANE DETAIL

ALL DIMENSIONS ARE IN METERS
 UNLESS OTHERWISE SHOWN

CONSTRUCTION DETAILS

NO SCALE

C-6

STATE OF CALIFORNIA - DEPARTMENT OF TRANSPORTATION
Caltrans OFFICE OF DESIGN D

REVISOR
 REVISION
 DATE

CUONG T. TRAN
 MUNSHI MOHSIN

CALCULATED-DESIGNED BY
 CHECKED BY

FUNCTIONAL SUPERVISOR
 CELINA AVILES




DIST	COUNTY	ROUTE	KILOMETER TOTAL PROJECT	POST TOTAL PROJECT	SHEET No.	TOTAL SHEETS
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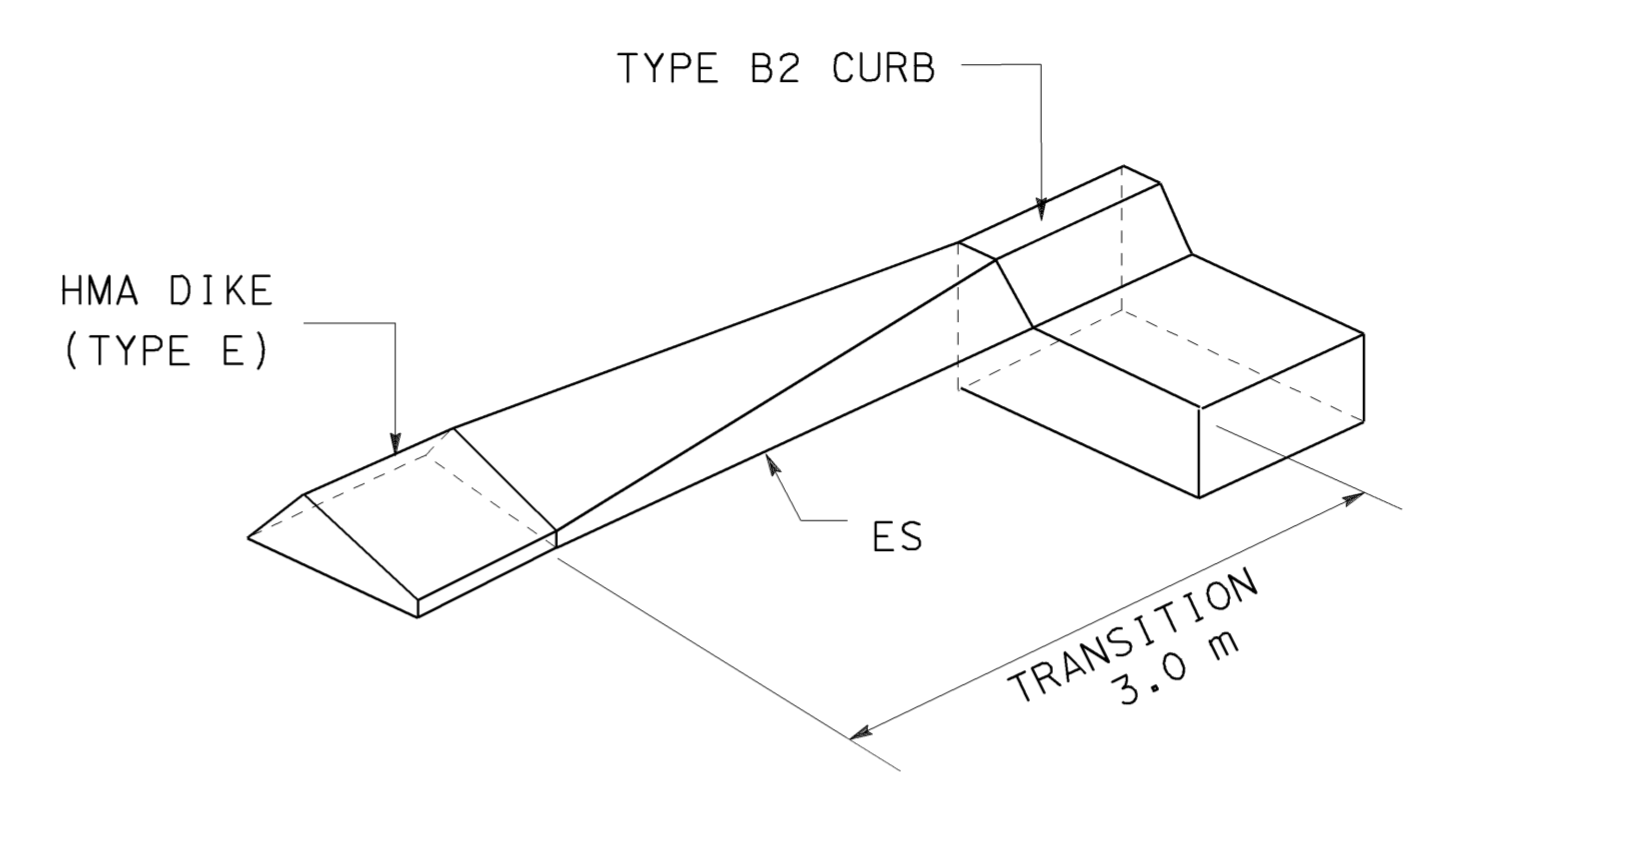
REGISTERED CIVIL ENGINEER
 DATE 2-24-09
 PLANS APPROVAL DATE 6-8-09

REGISTERED PROFESSIONAL ENGINEER
 MUNSHI MOHSIN
 No. 61916
 Exp. 9/30/09
 CIVIL
 STATE OF CALIFORNIA


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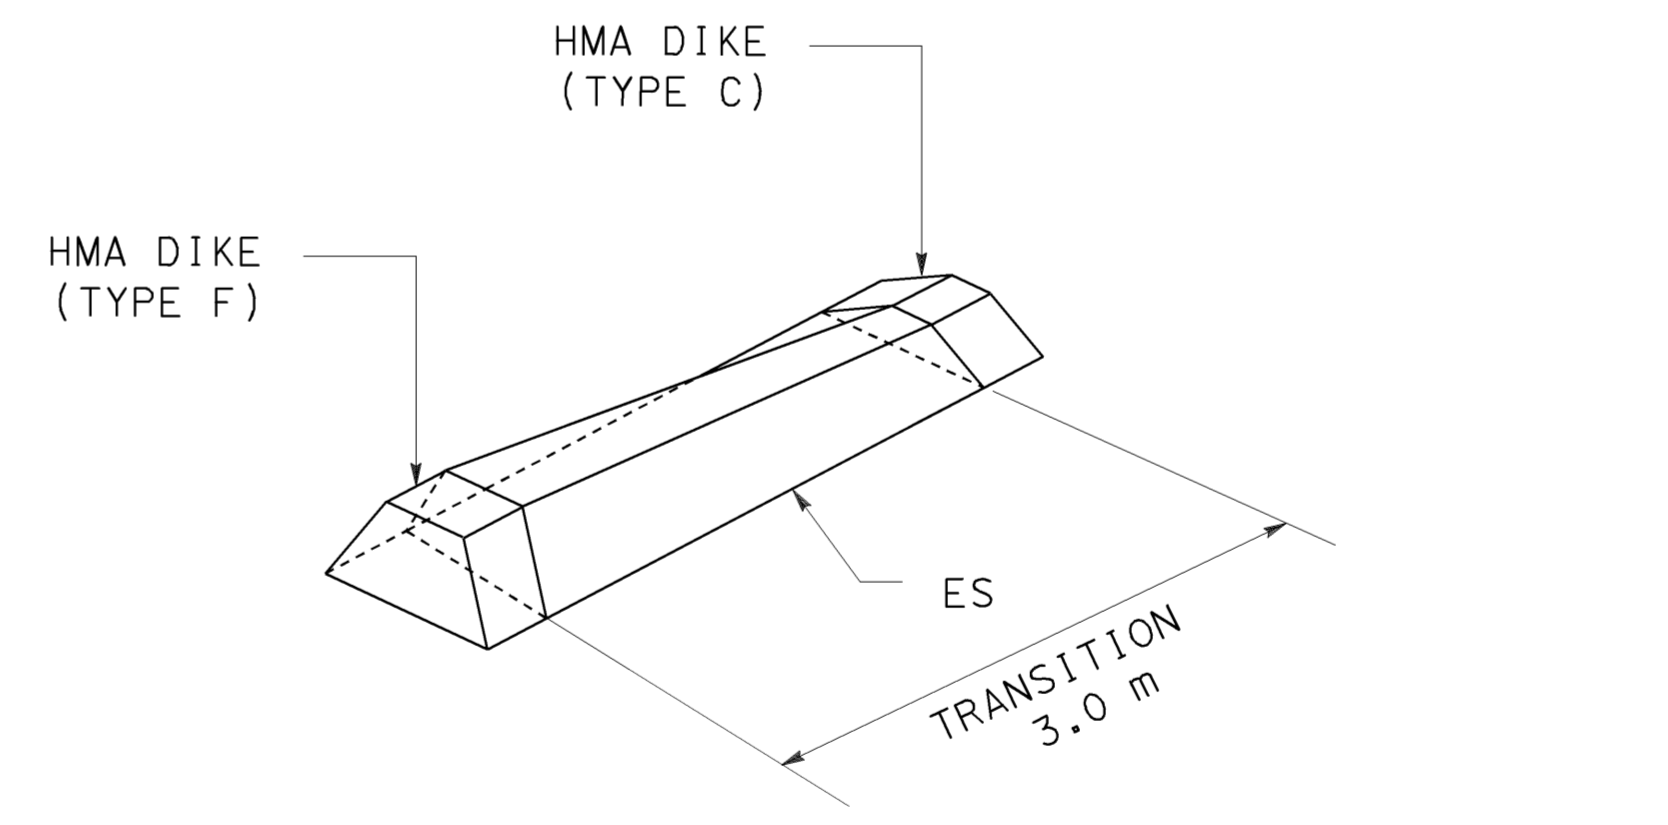
HMA DIKE (TYPE E) TO TYPE E CURB

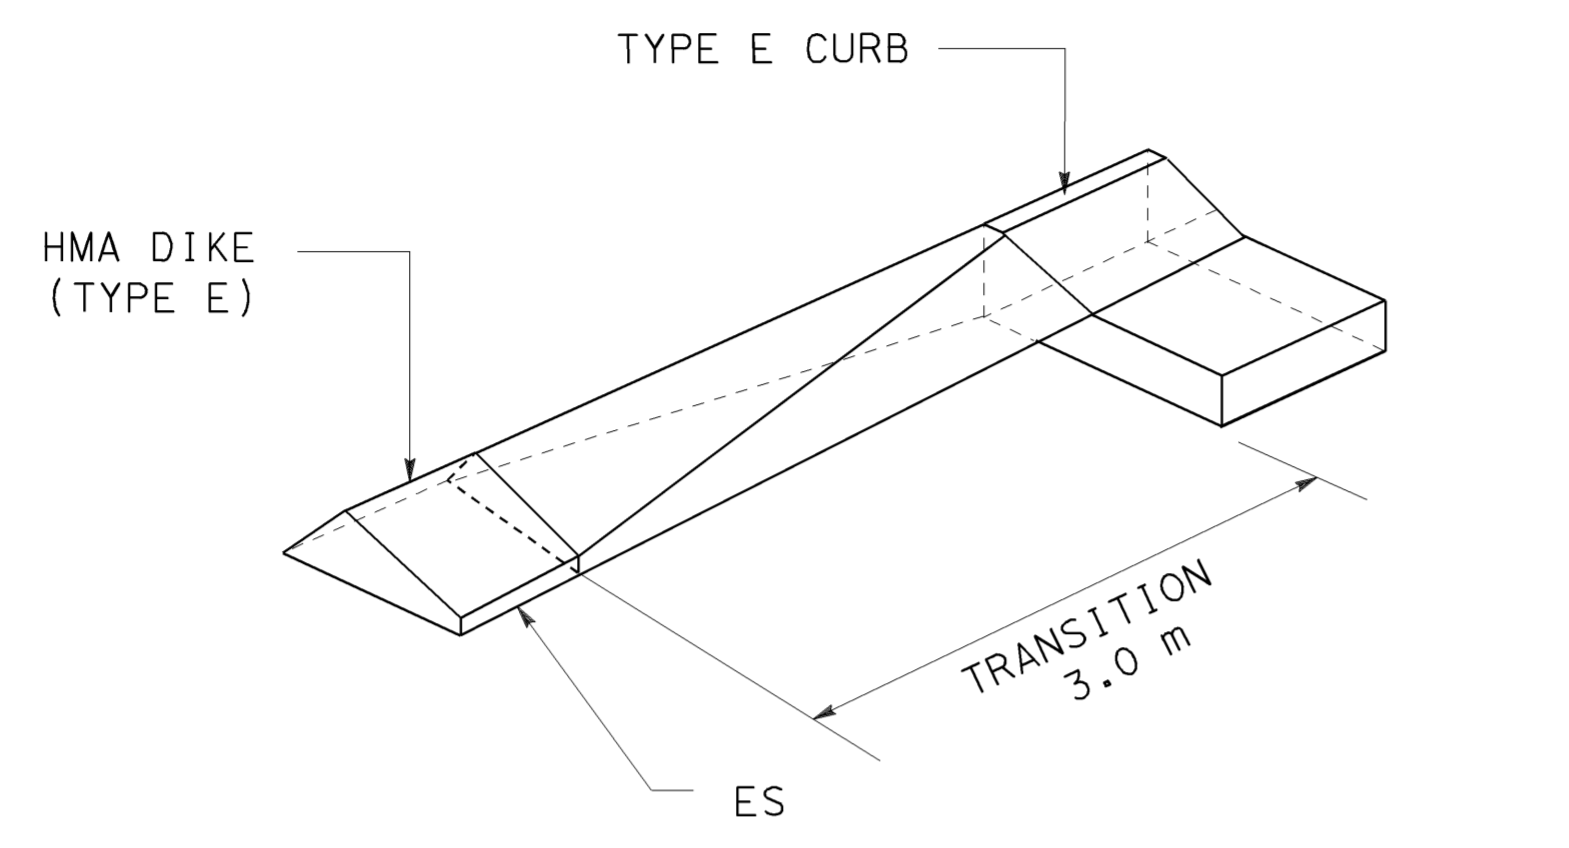

HMA DIKE (TYPE E) TO TYPE B2 CURB



HMA DIKE (TYPE E) TO HMA DIKE (TYPE C)

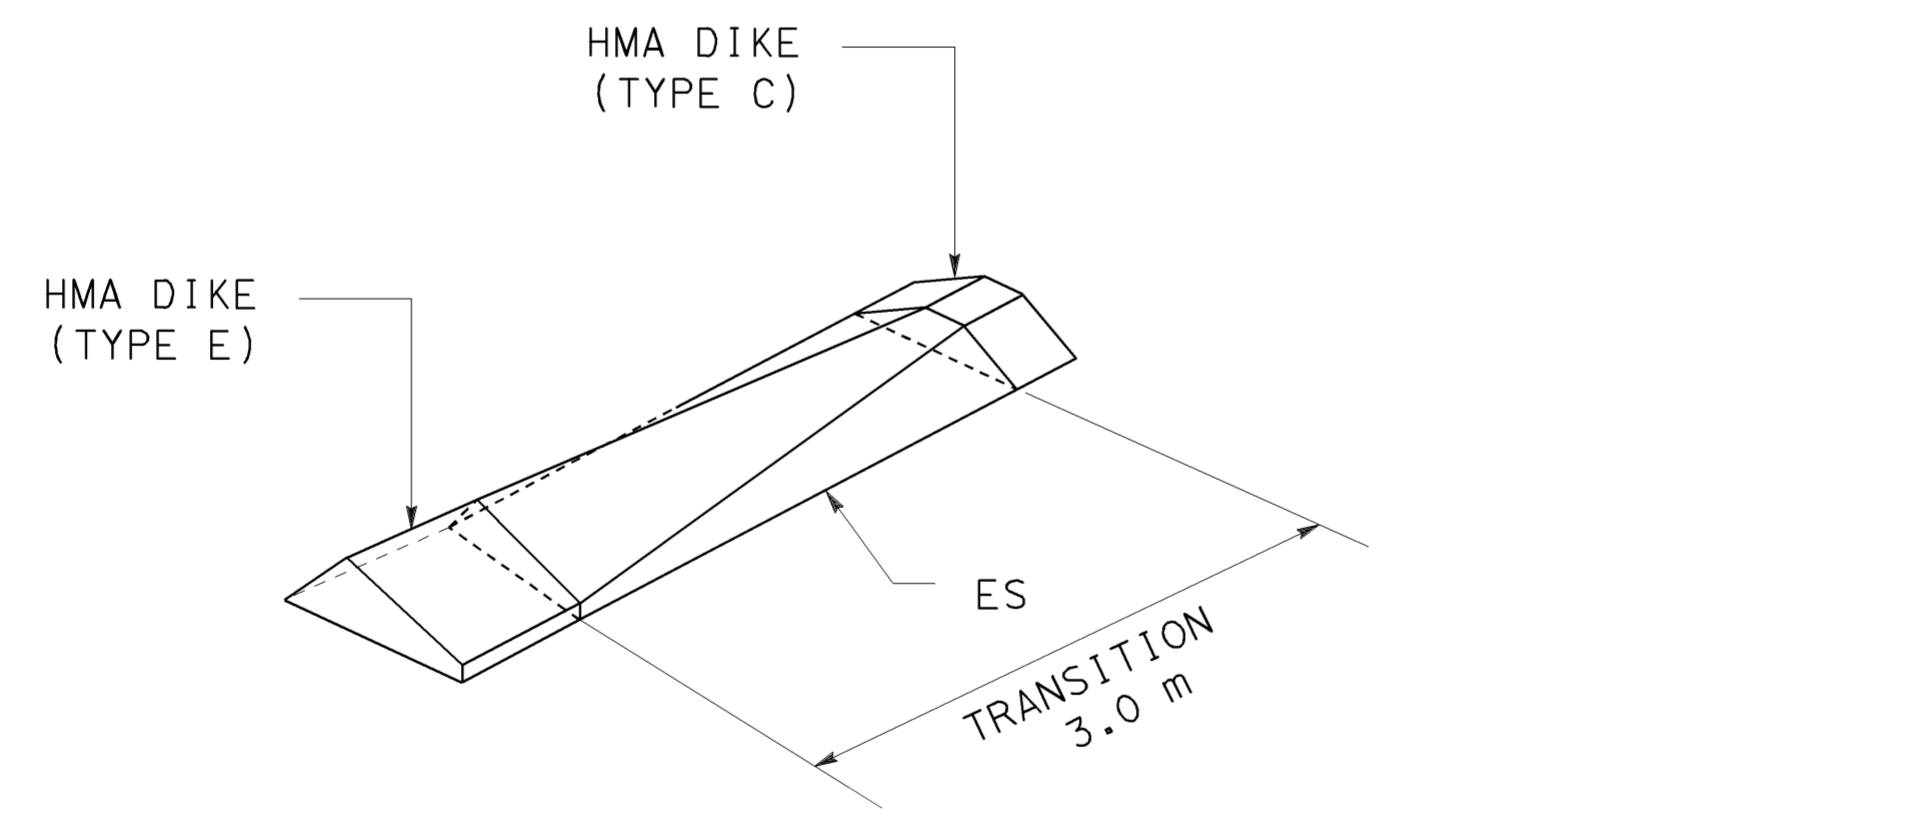

HMA DIKE (TYPE F) TO HMA DIKE (TYPE C)

ALL DIMENSIONS ARE IN METERS
 UNLESS OTHERWISE SHOWN

CONSTRUCTION DETAILS
 NO SCALE
C-7




Dist	COUNTY	ROUTE	KILOMETER POST TOTAL PROJECT	SHEET No.	TOTAL SHEETS
07	LA	5	42.8/47.3	49	1073

2-24-09
 REGISTERED CIVIL ENGINEER DATE
 6-8-09
 PLANS APPROVAL DATE

REGISTERED PROFESSIONAL ENGINEER
 MUNSHI MOHSIN
 No. 61916
 Exp. 9/30/09
 CIVIL
 STATE OF CALIFORNIA

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**GORE DETAIL
 NORTHBOUND WESTERN OFF RAMP**

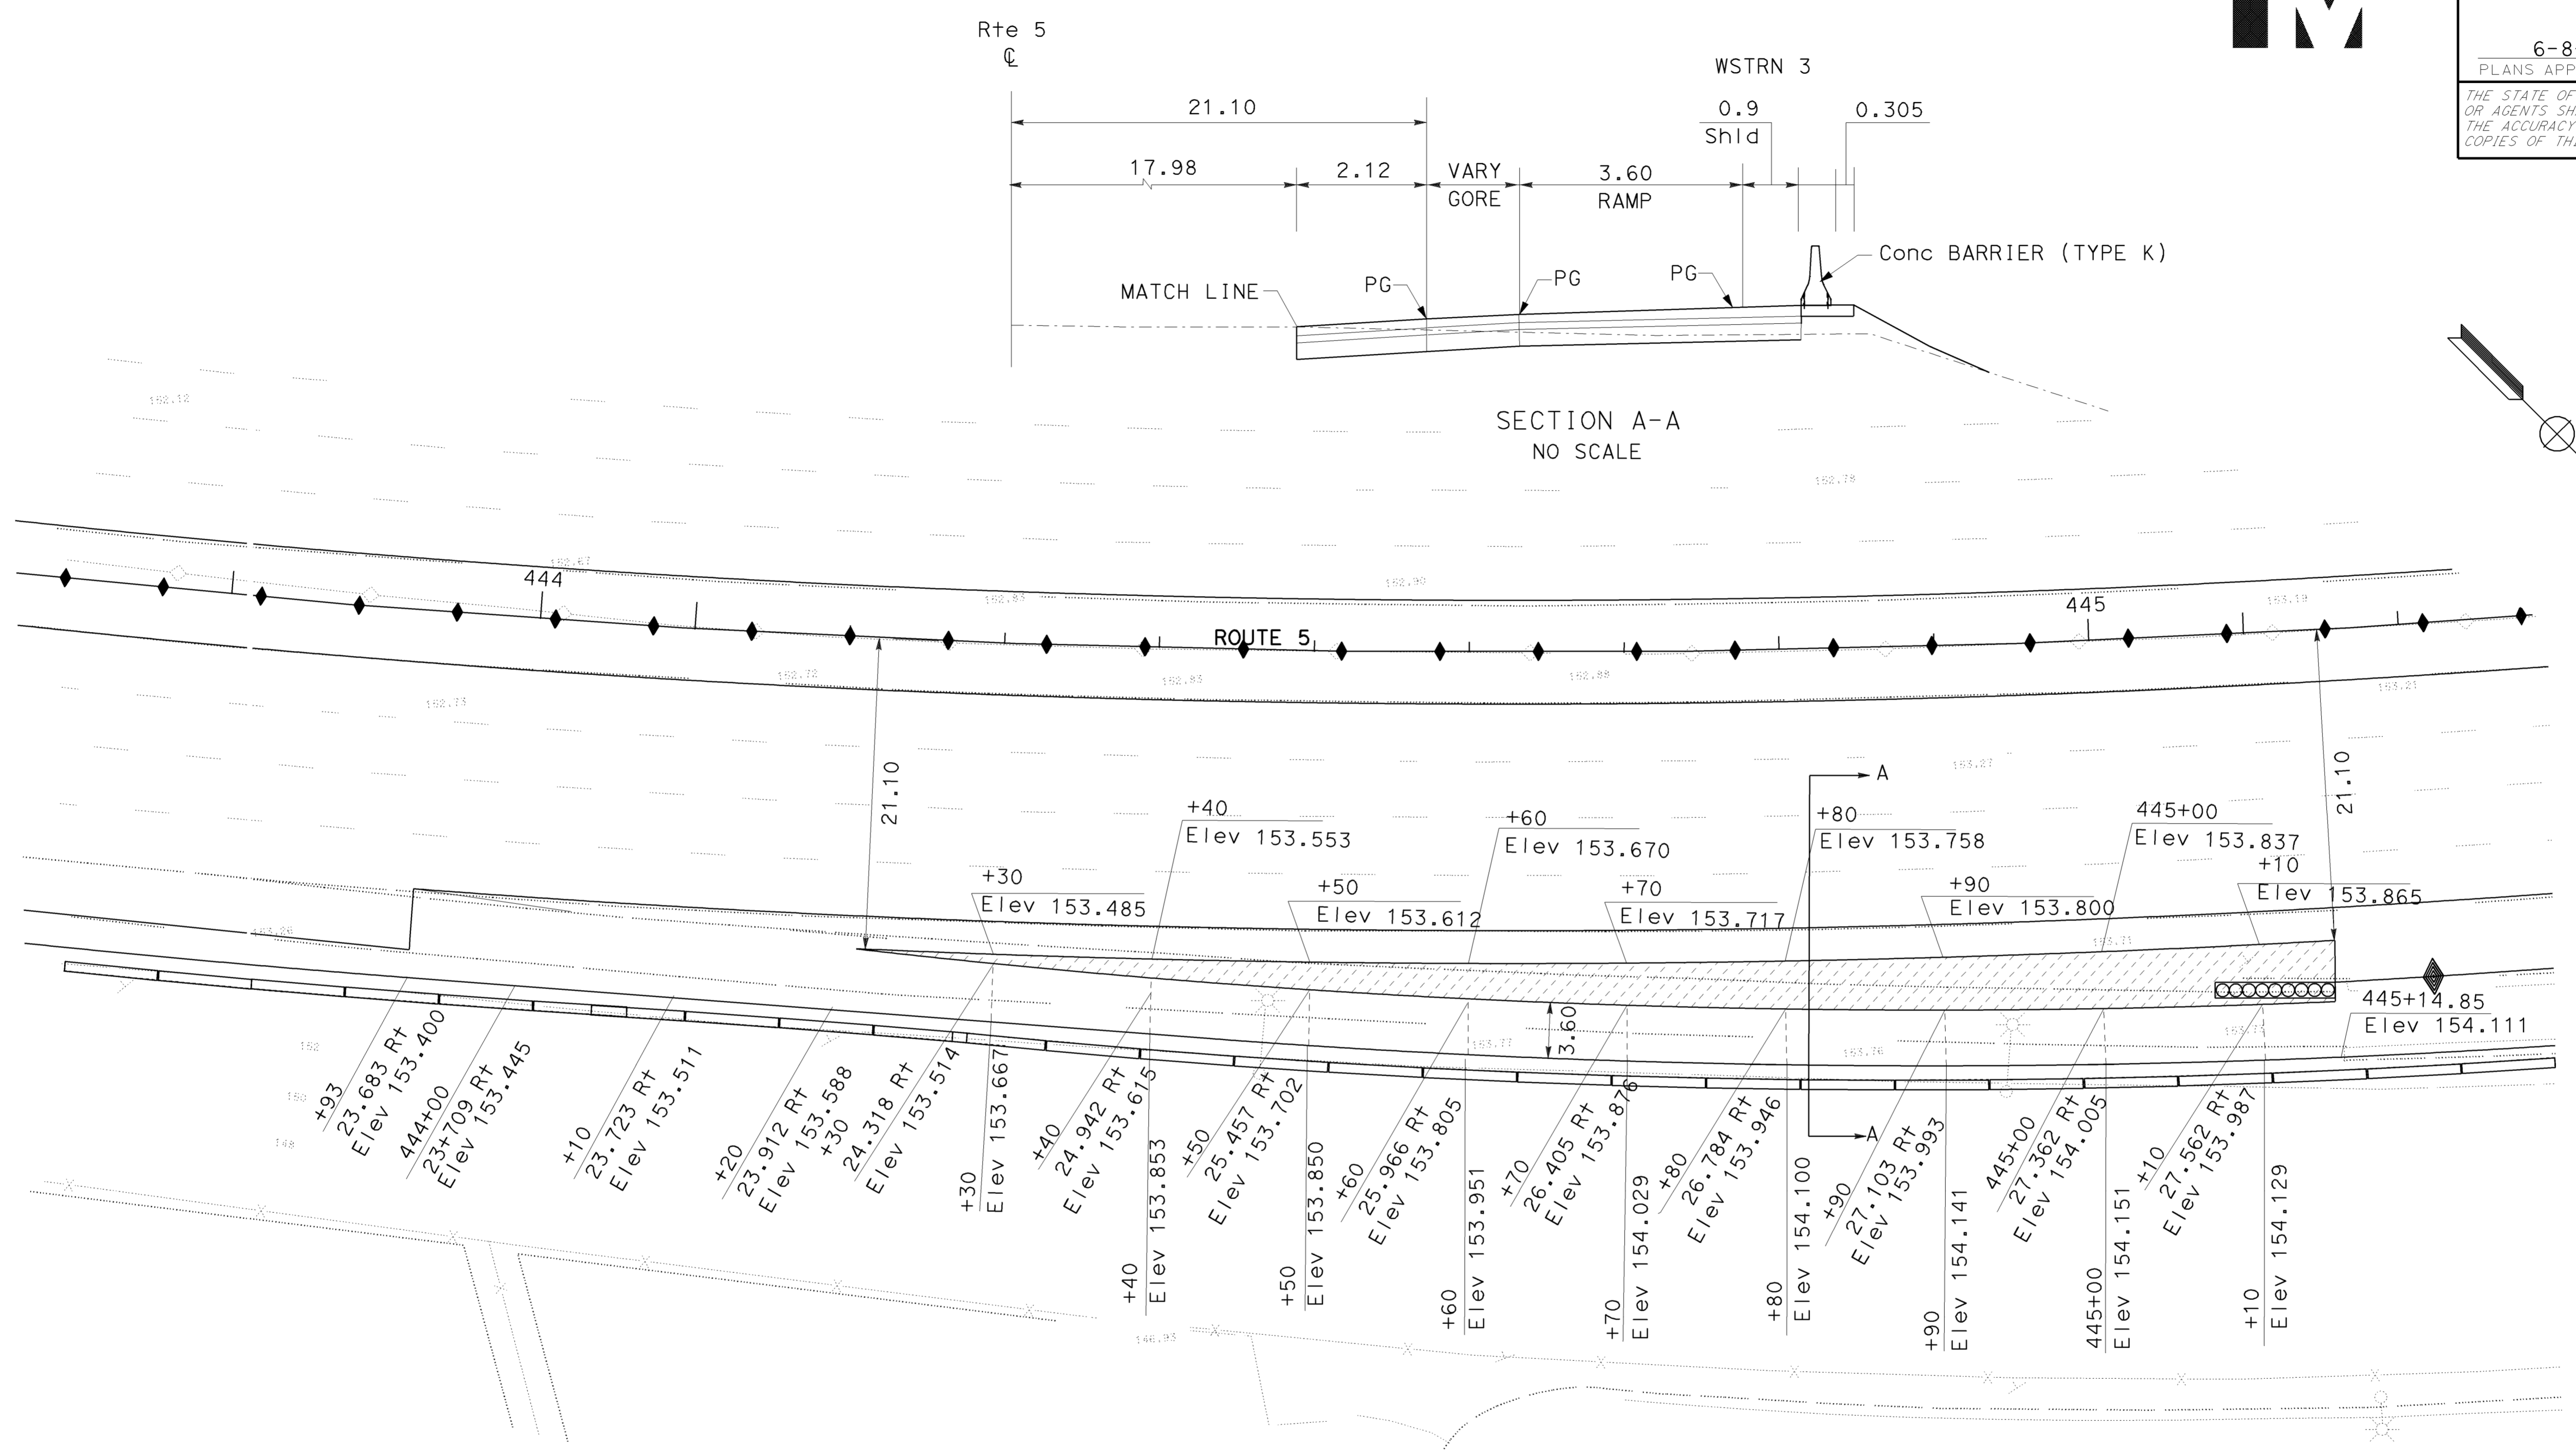LEGEND:
 GORE

ALL DIMENSIONS ARE IN METERS
 UNLESS OTHERWISE SHOWN
CONSTRUCTION DETAILS
 SCALE 1:250
C-8

THIS PLAN IS ACCURATE FOR GORE AREA ONLY.



USERNAME => trpierce
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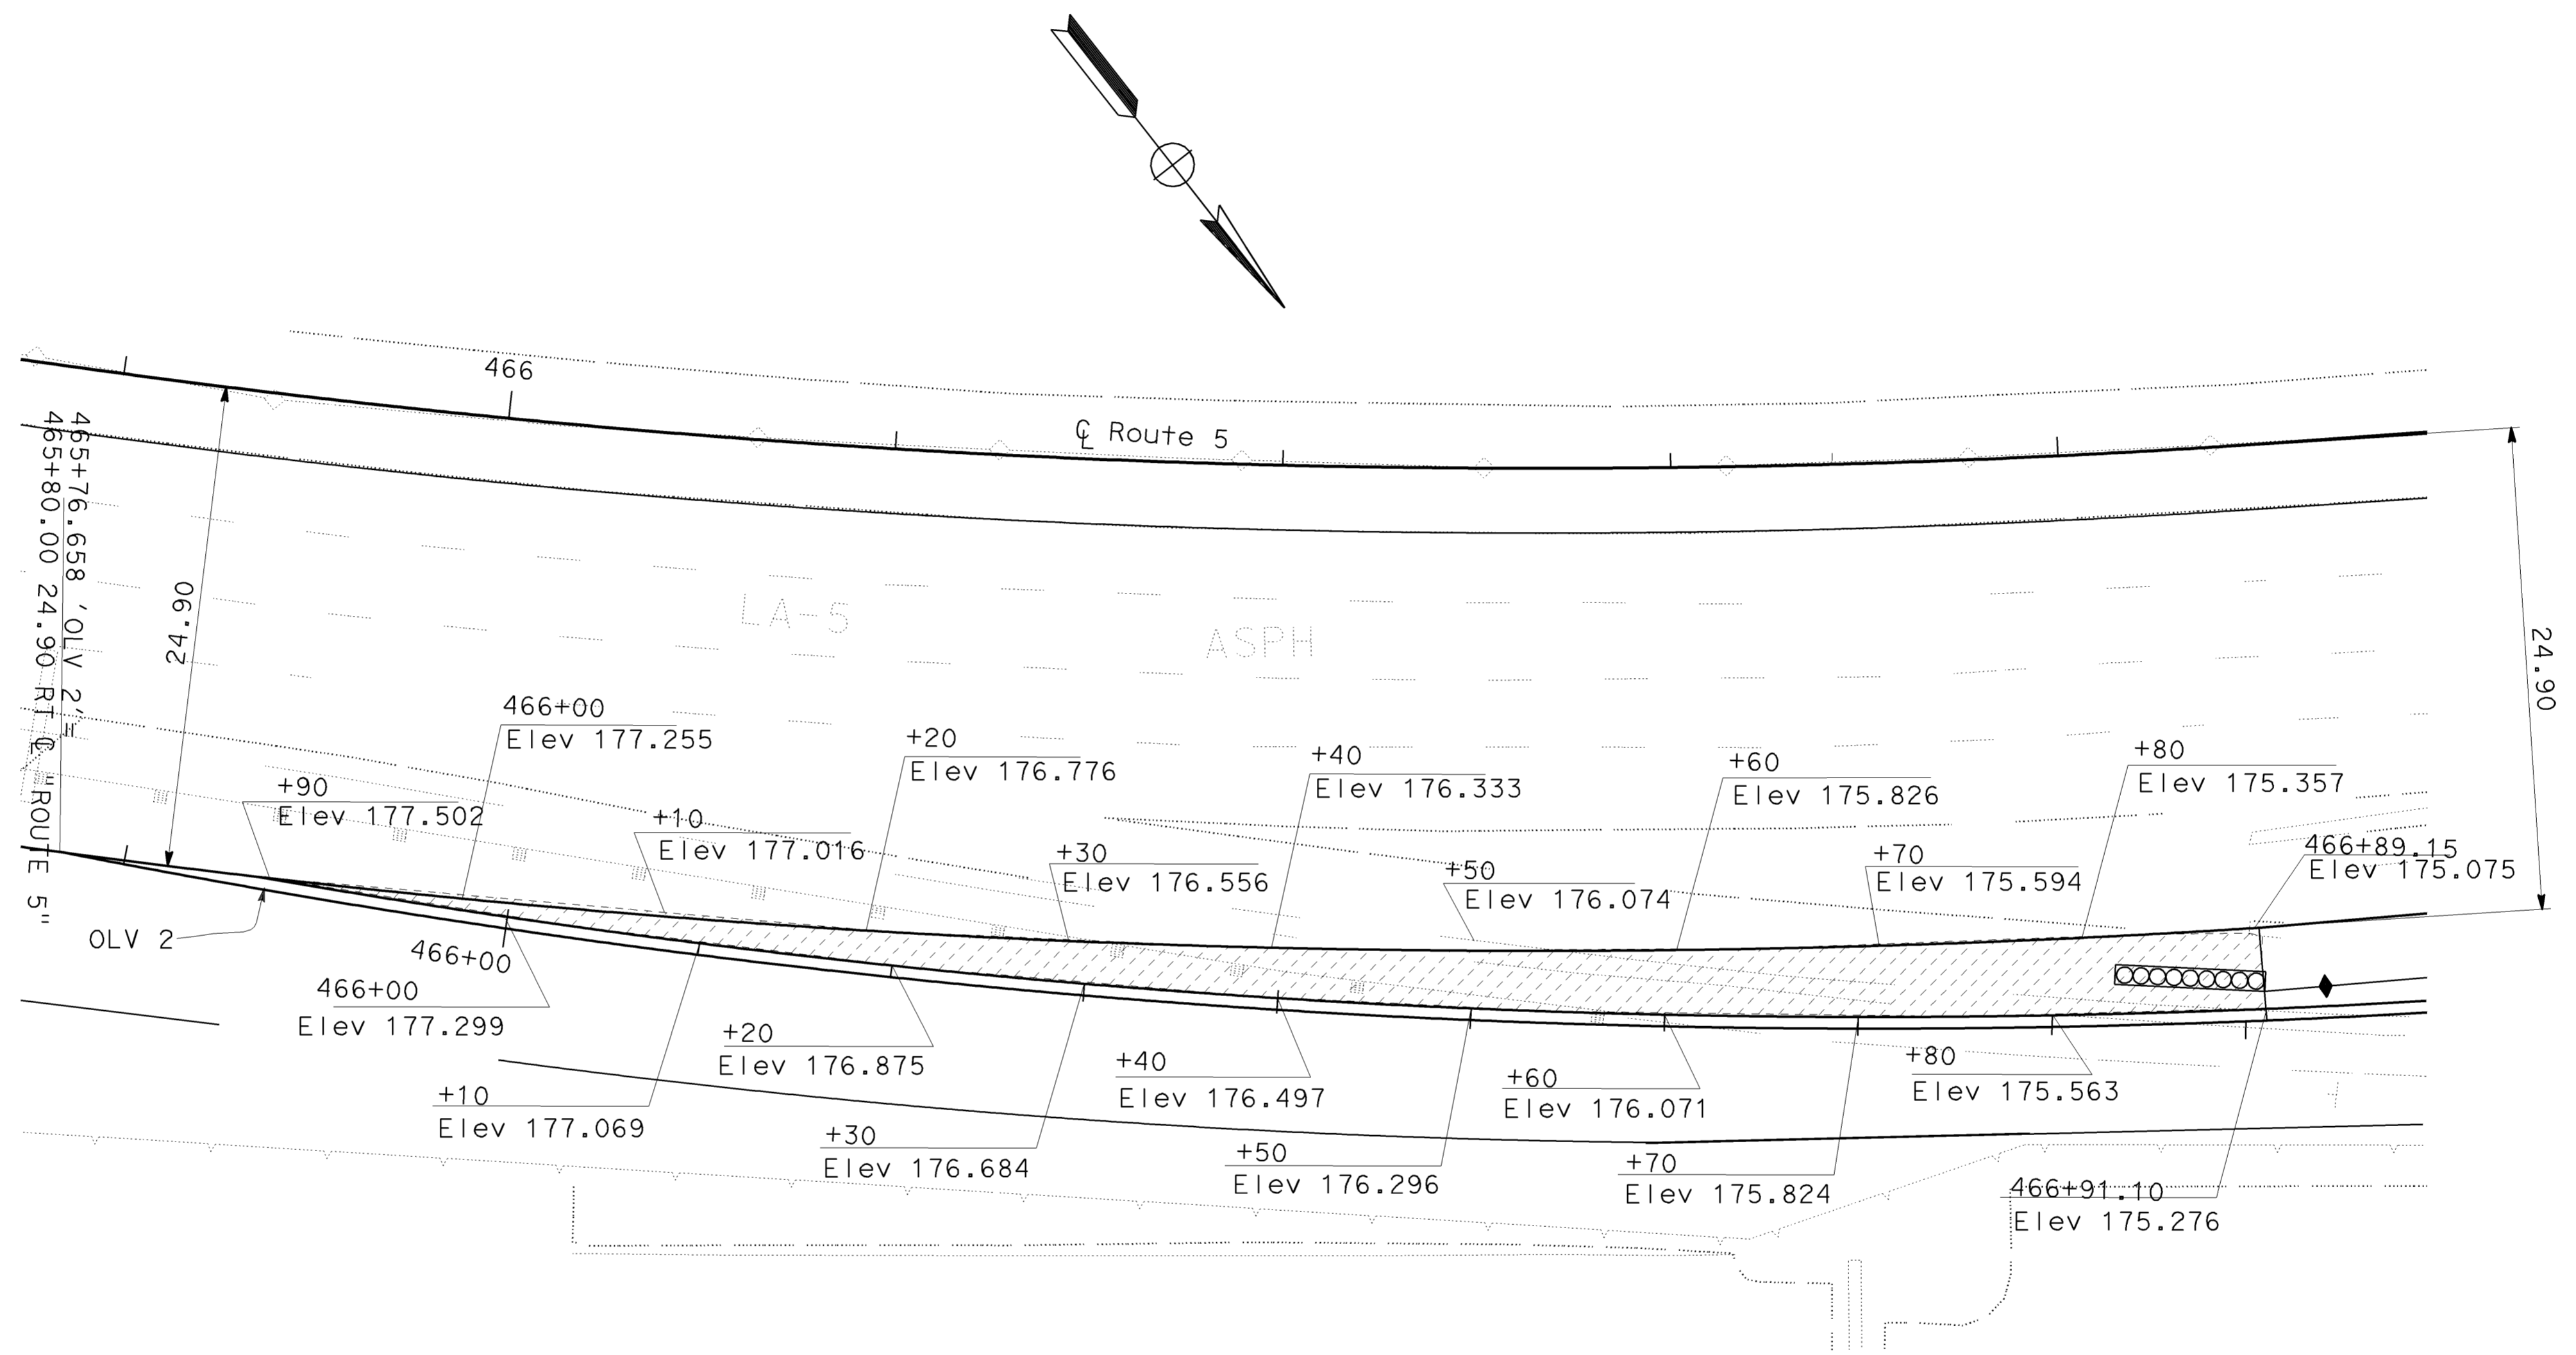
CU 07276 EA 121841

STATE OF CALIFORNIA - DEPARTMENT OF TRANSPORTATION
Caltrans OFFICE OF DESIGN D
 FUNCTIONAL SUPERVISOR
 CELINA AVILES
 CALCULATED-DESIGNED BY
 CHECKED BY
 DAWIT WORKU
 MUNSHI MOHSIN
 REVISOR BY
 DATE REVISED
 DW
 10/2008
 CTT
 02/05/09



Dist	COUNTY	ROUTE	KILOMETER POST TOTAL PROJECT	SHEET No.	TOTAL SHEETS
07	LA	5	42.8/47.3	50	1073

REGISTERED CIVIL ENGINEER DATE 2-24-09
 PLANS APPROVAL DATE 6-8-09
 REGISTERED PROFESSIONAL ENGINEER
 MUNSHI MOHSIN
 No. 61916
 Exp. 9/30/09
 CIVIL
 STATE OF CALIFORNIA
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**GORE DETAIL
 NORTHBOUND OLIVE OFF RAMP**

THIS PLAN IS ACCURATE FOR GORE AREA ONLY.

ALL DIMENSIONS ARE IN METERS
 UNLESS OTHERWISE SHOWN
CONSTRUCTION DETAILS


SCALE 1:250
C-9

STATE OF CALIFORNIA - DEPARTMENT OF TRANSPORTATION
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 CELINA AVILES
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 CHECKED BY
 DAWIT WURKU
 MUNSHI MOHSIN
 REVISOR BY
 DATE REVISED
 DW
 11/2008
 CTT
 02/05/09




Dist	COUNTY	ROUTE	KILOMETER POST TOTAL PROJECT	SHEET No.	TOTAL SHEETS
07	LA	5	42.8/47.3	51	1073


REGISTERED CIVIL ENGINEER DATE 2-24-09
 PLANS APPROVAL DATE 6-8-09
 REGISTERED PROFESSIONAL ENGINEER
 MUNSHI MOHSIN
 No. 61916
 Exp. 9/30/09
 CIVIL
 STATE OF CALIFORNIA
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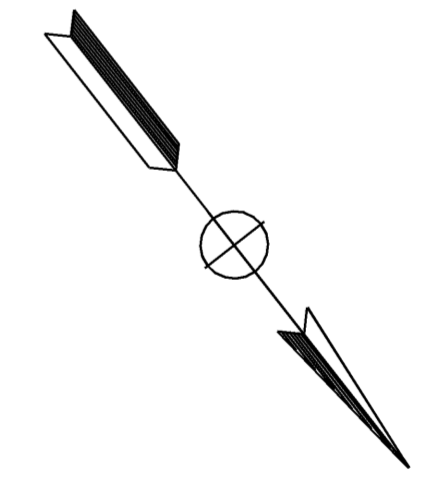
**GORE DETAIL
 SOUTHBOUND VERDUGO ON RAMP**

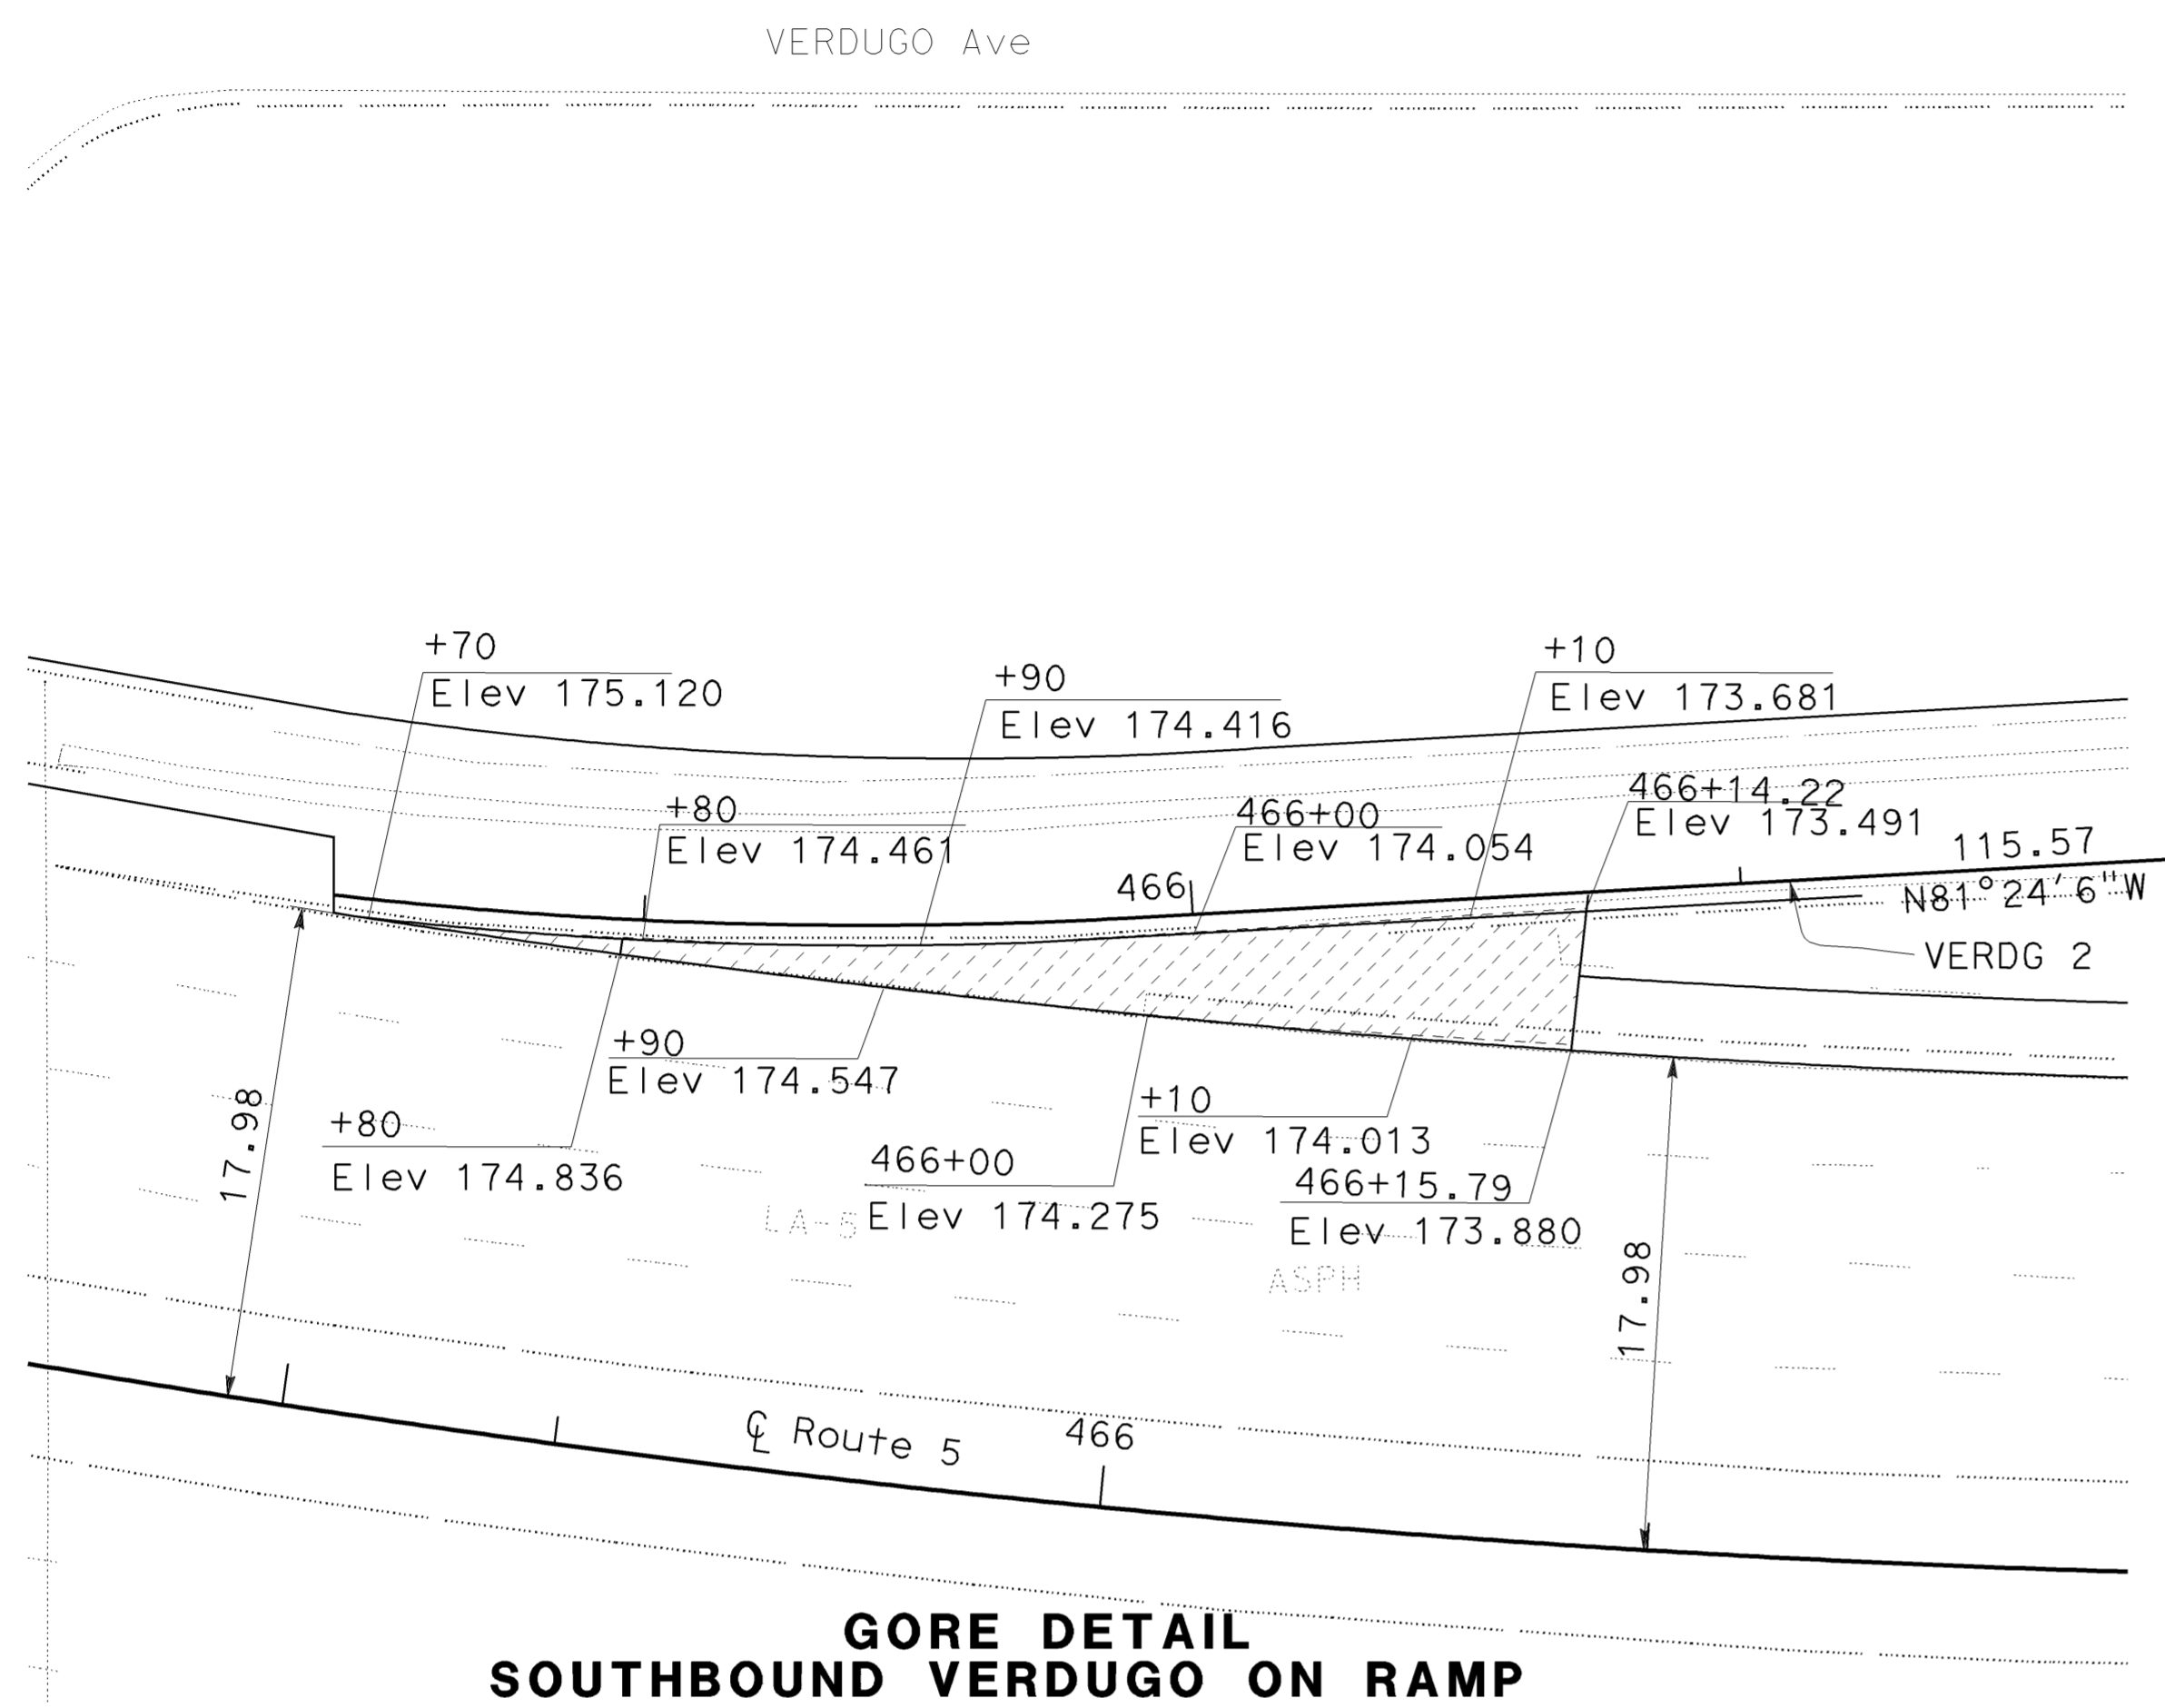

**GORE DETAIL
 SOUTHBOUND VERDUGO OFF RAMP**

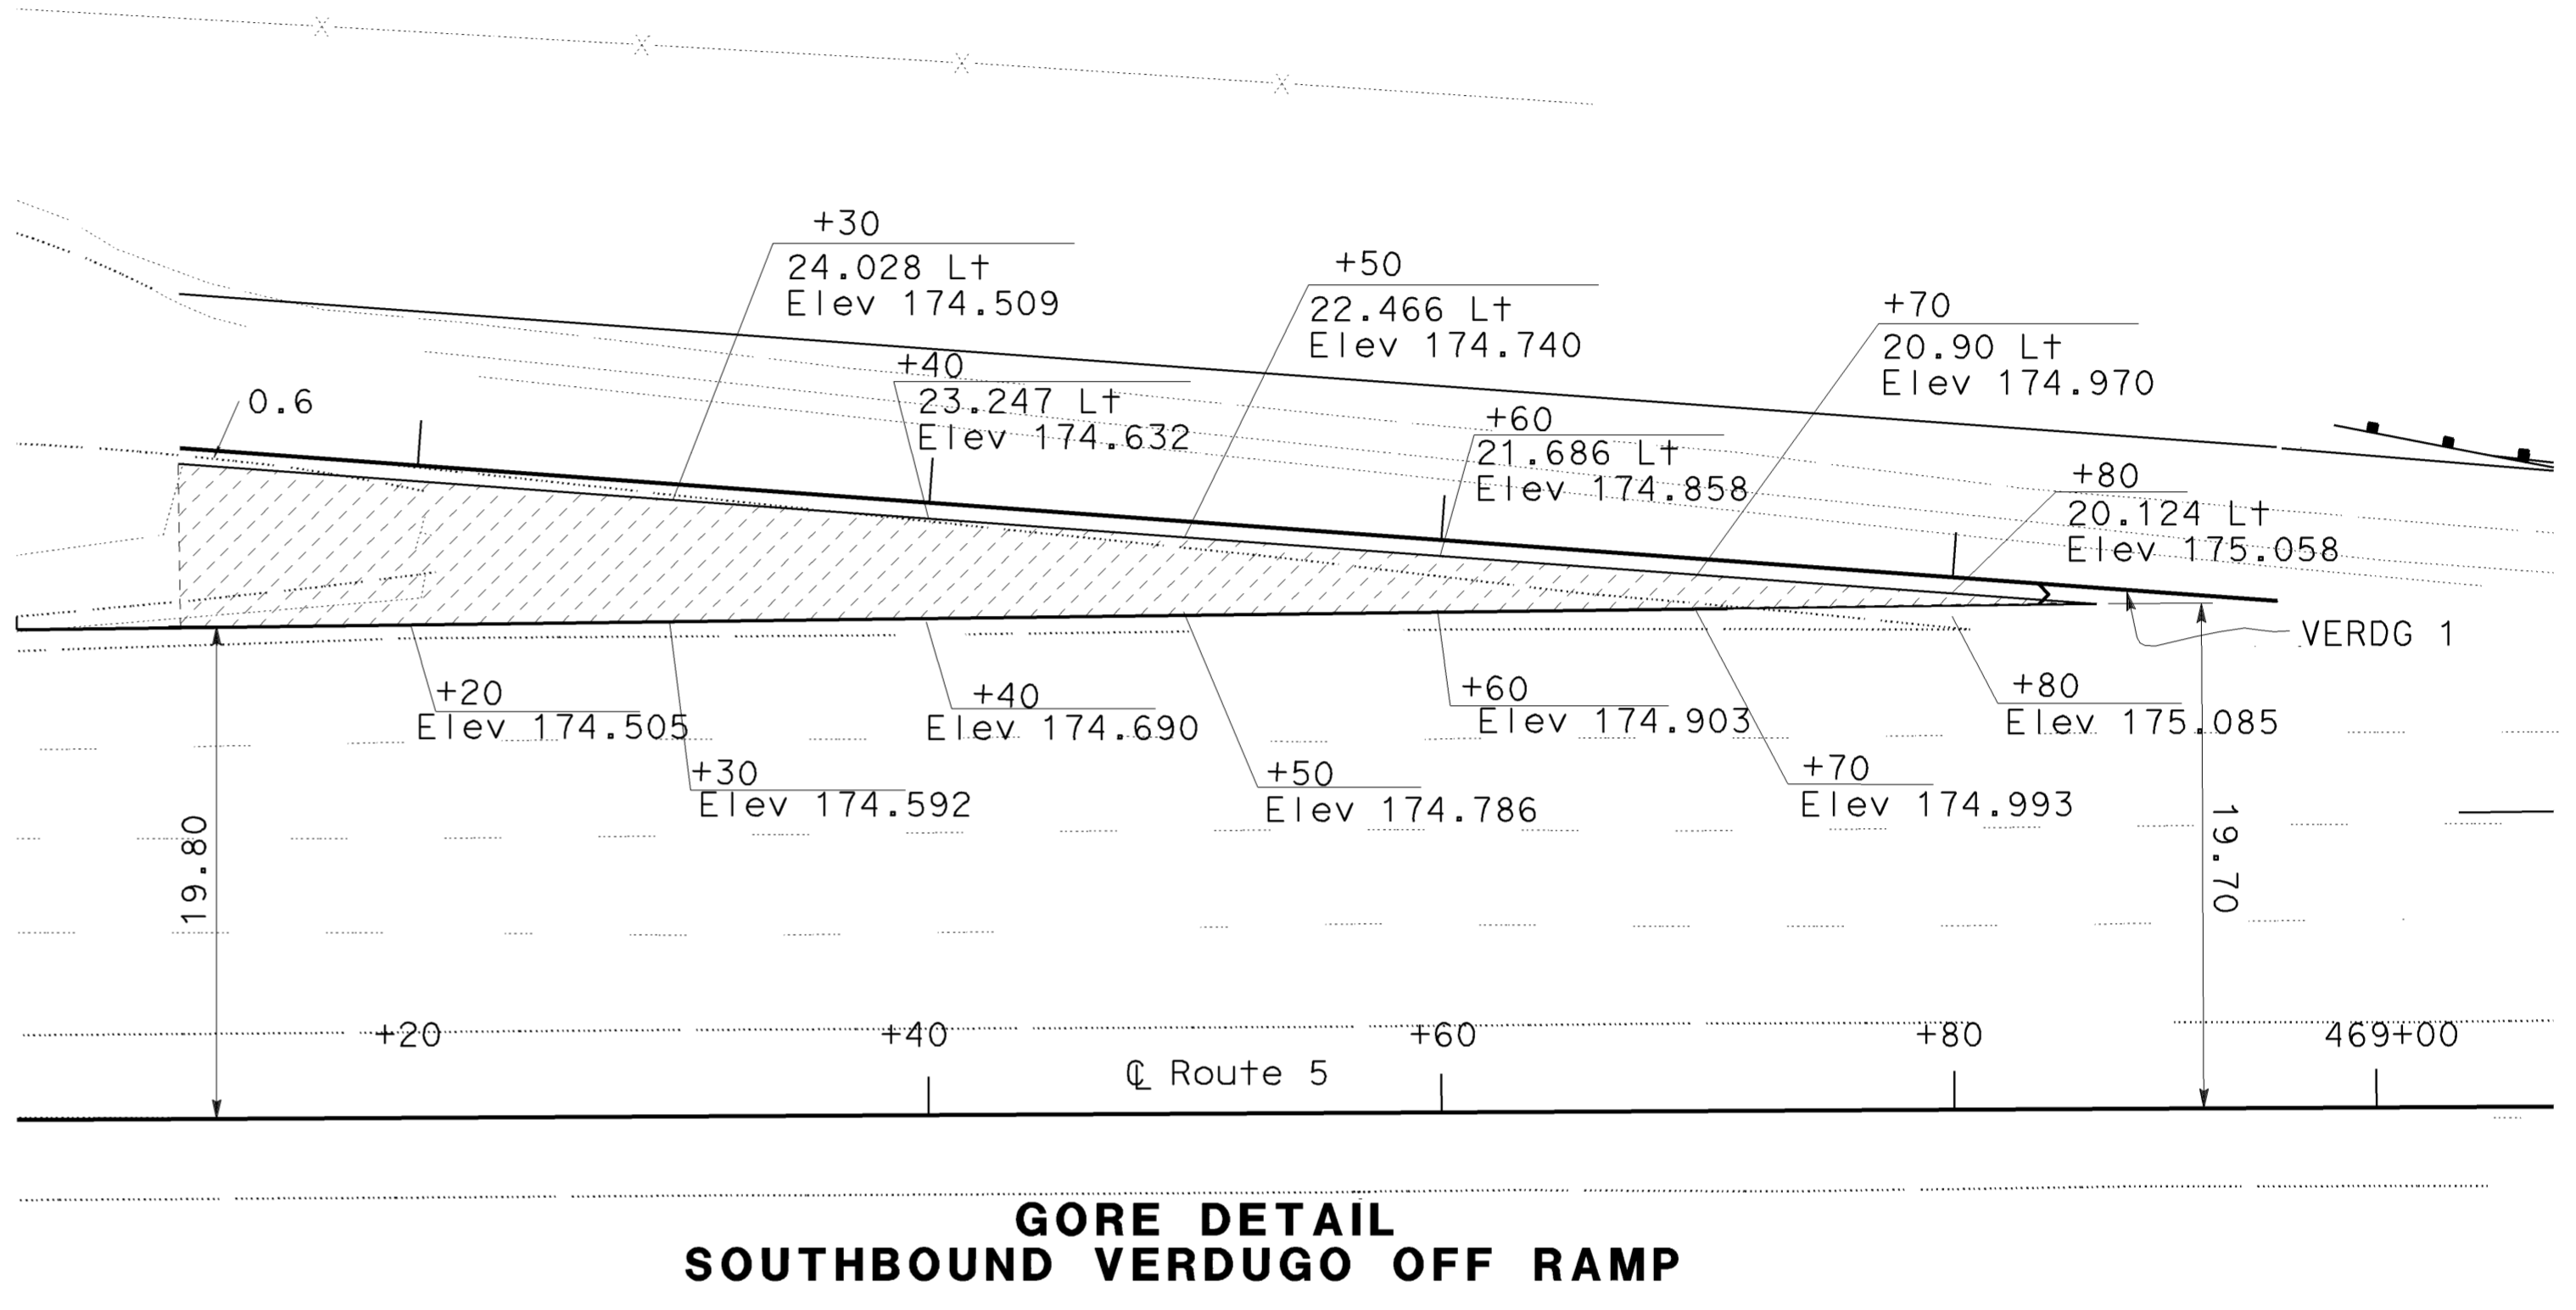

**GORE DETAIL
 NORTHBOUND ORANGE GROVE ON RAMP**

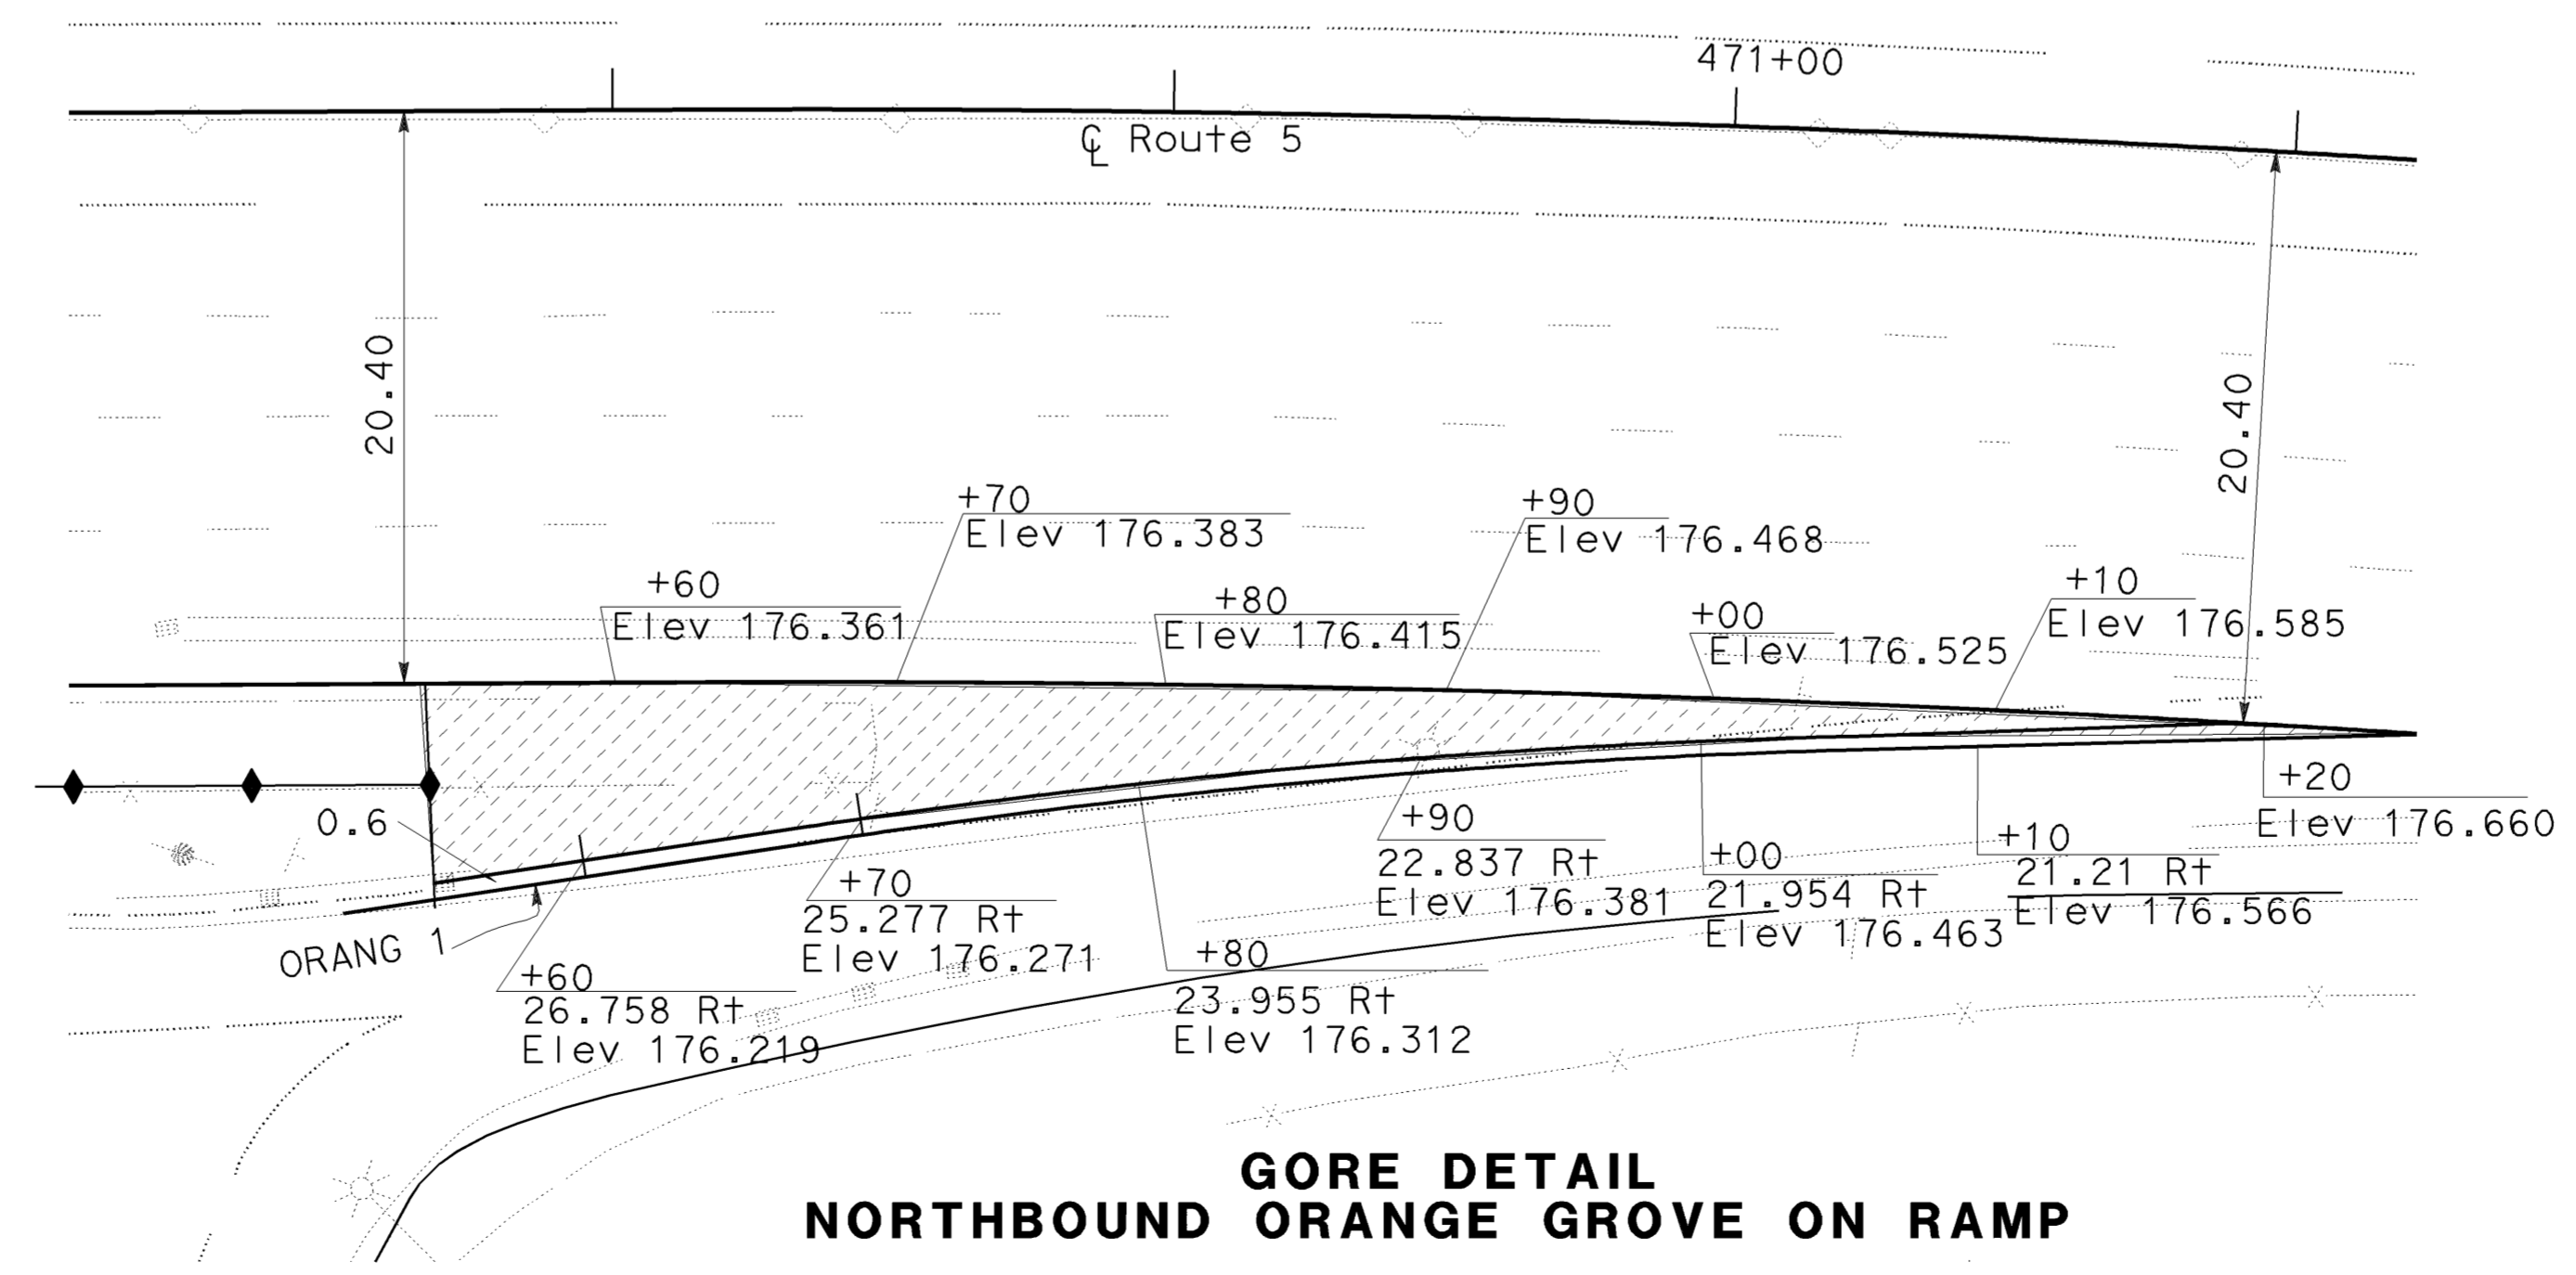


ALL DIMENSIONS ARE IN METERS
 UNLESS OTHERWISE SHOWN
CONSTRUCTION DETAILS

SCALE 1:250

C-10

THIS PLAN IS ACCURATE FOR GORE AREA ONLY.


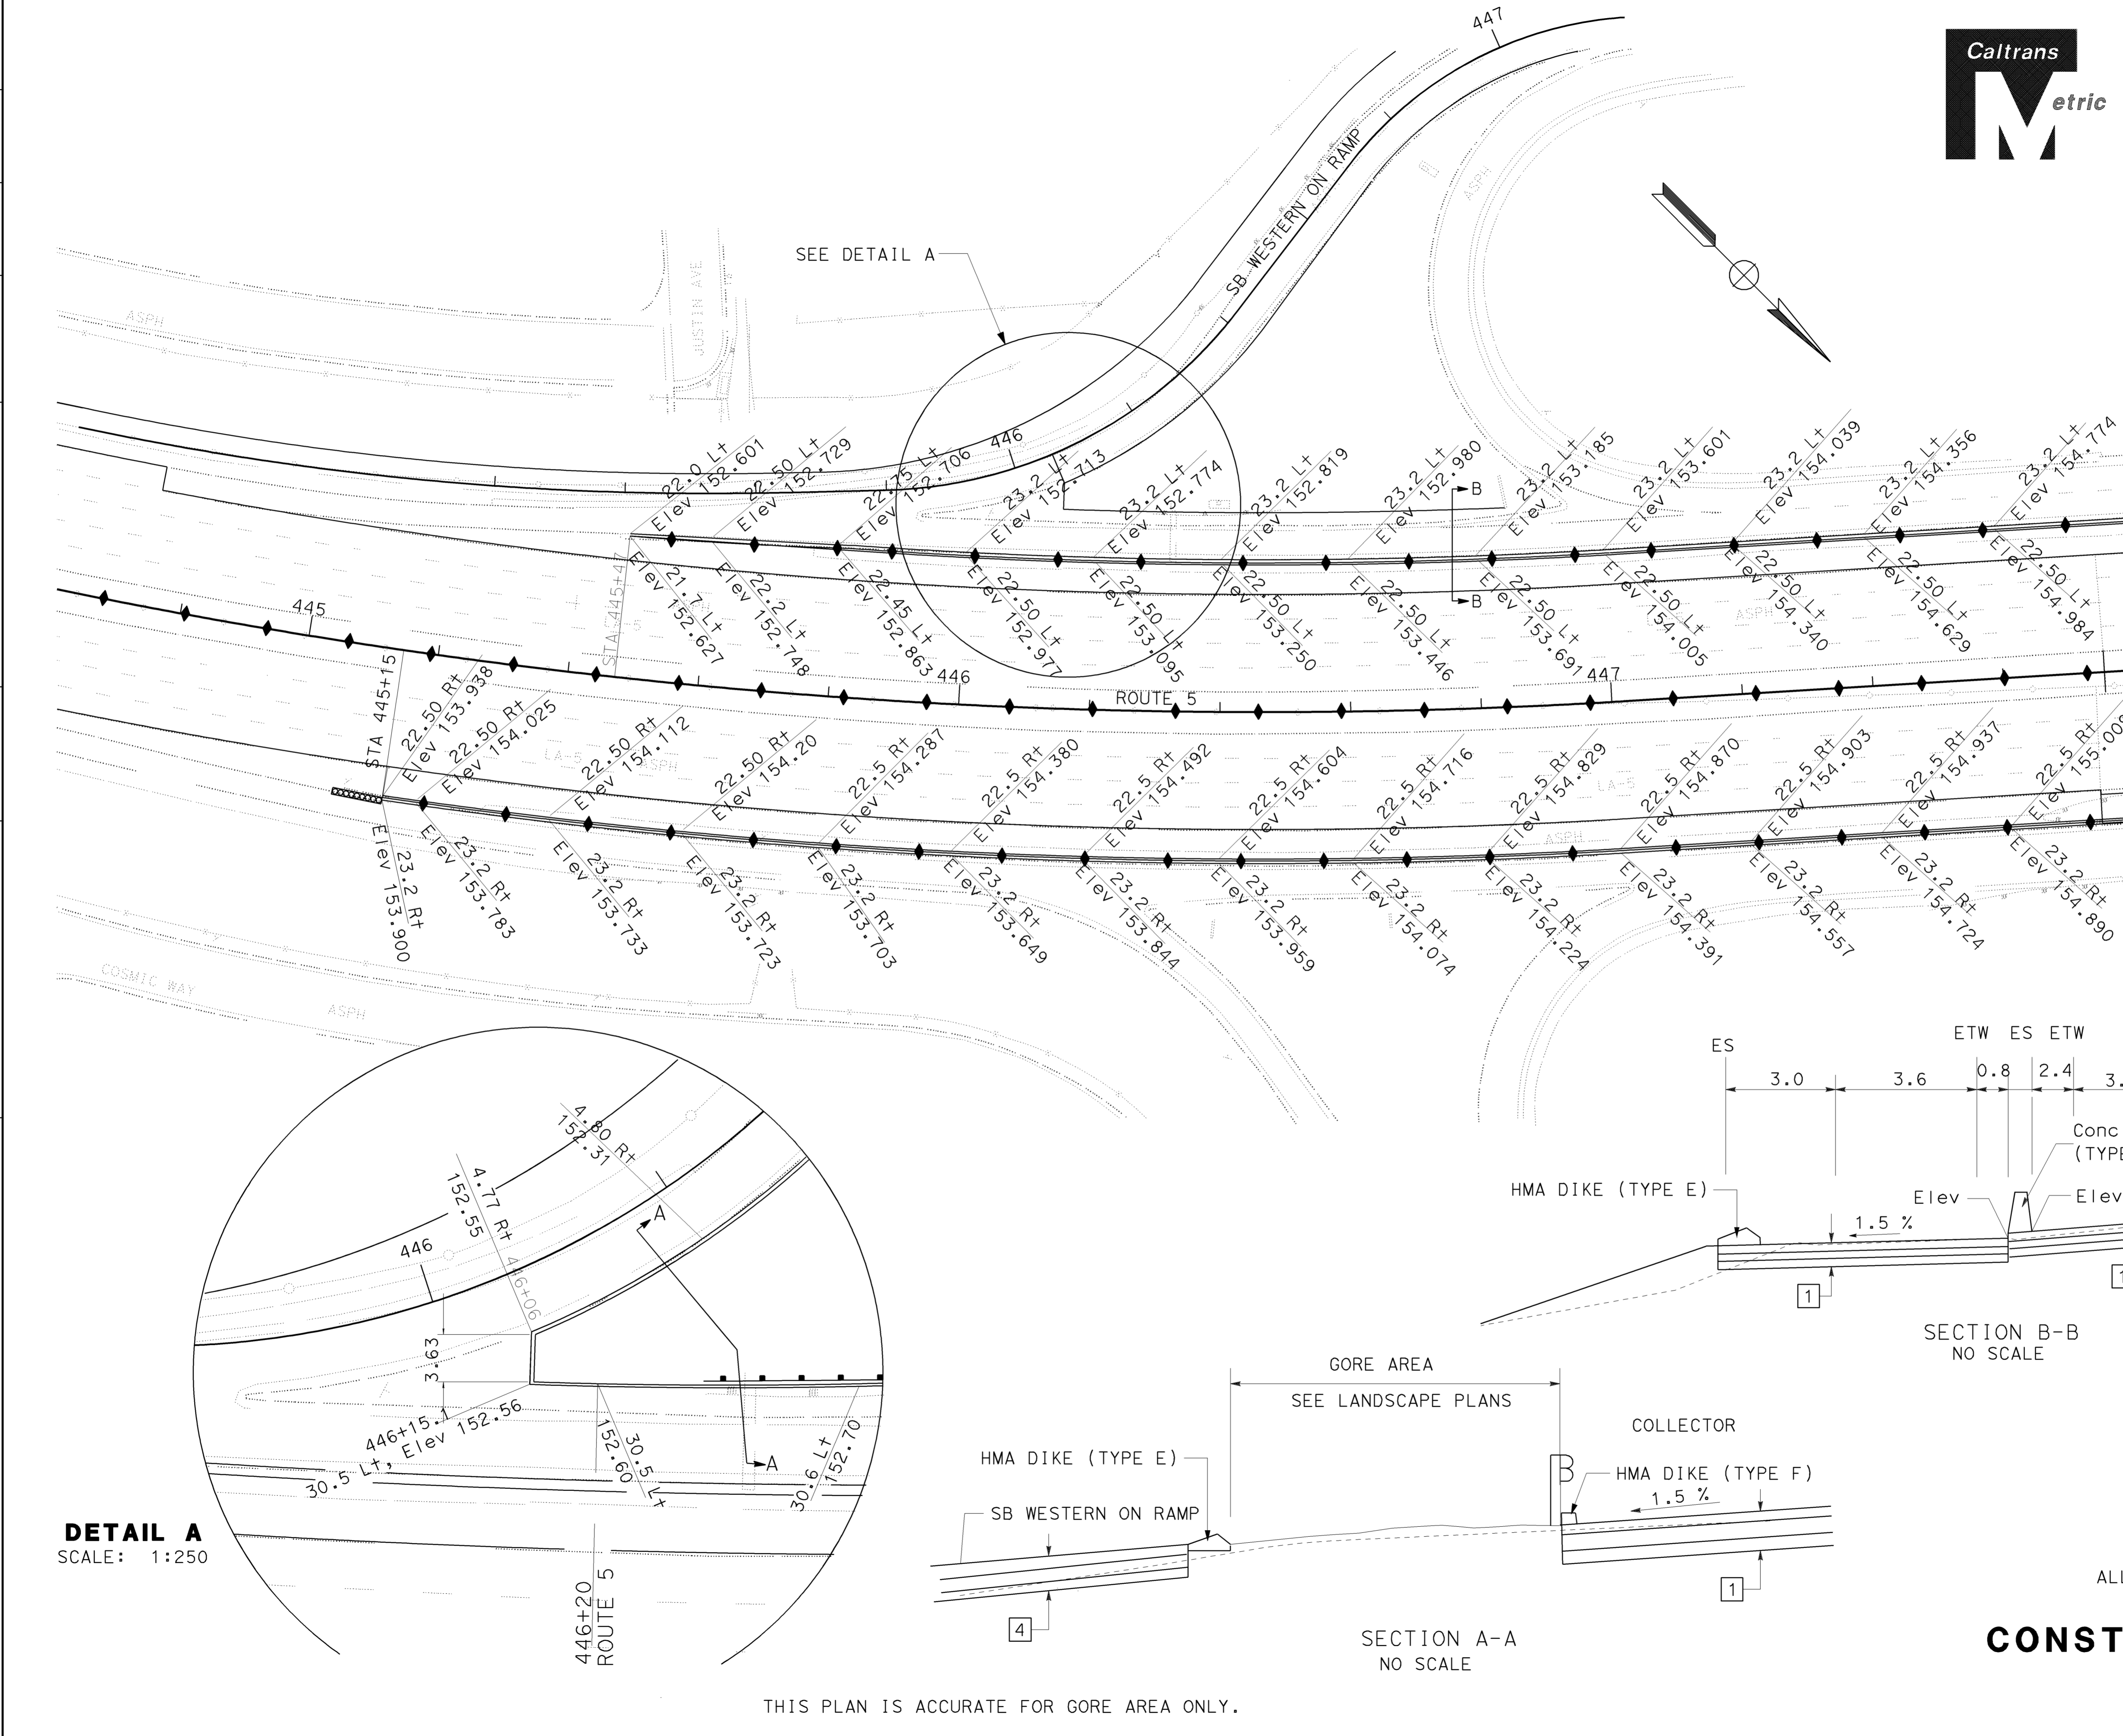


Dist	COUNTY	ROUTE	KILOMETER POST TOTAL PROJECT	SHEET No.	TOTAL SHEETS
07	LA	5	42.8/47.3	52	1073

2-24-09
 REGISTERED CIVIL ENGINEER DATE
 6-8-09
 PLANS APPROVAL DATE

REGISTERED PROFESSIONAL ENGINEER
MUNSHI MOHSIN
 No. 61916
 Exp. 9/30/09
 CIVIL
 STATE OF CALIFORNIA

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CONSTRUCTION DETAILS
 SCALE 1:500
C-11


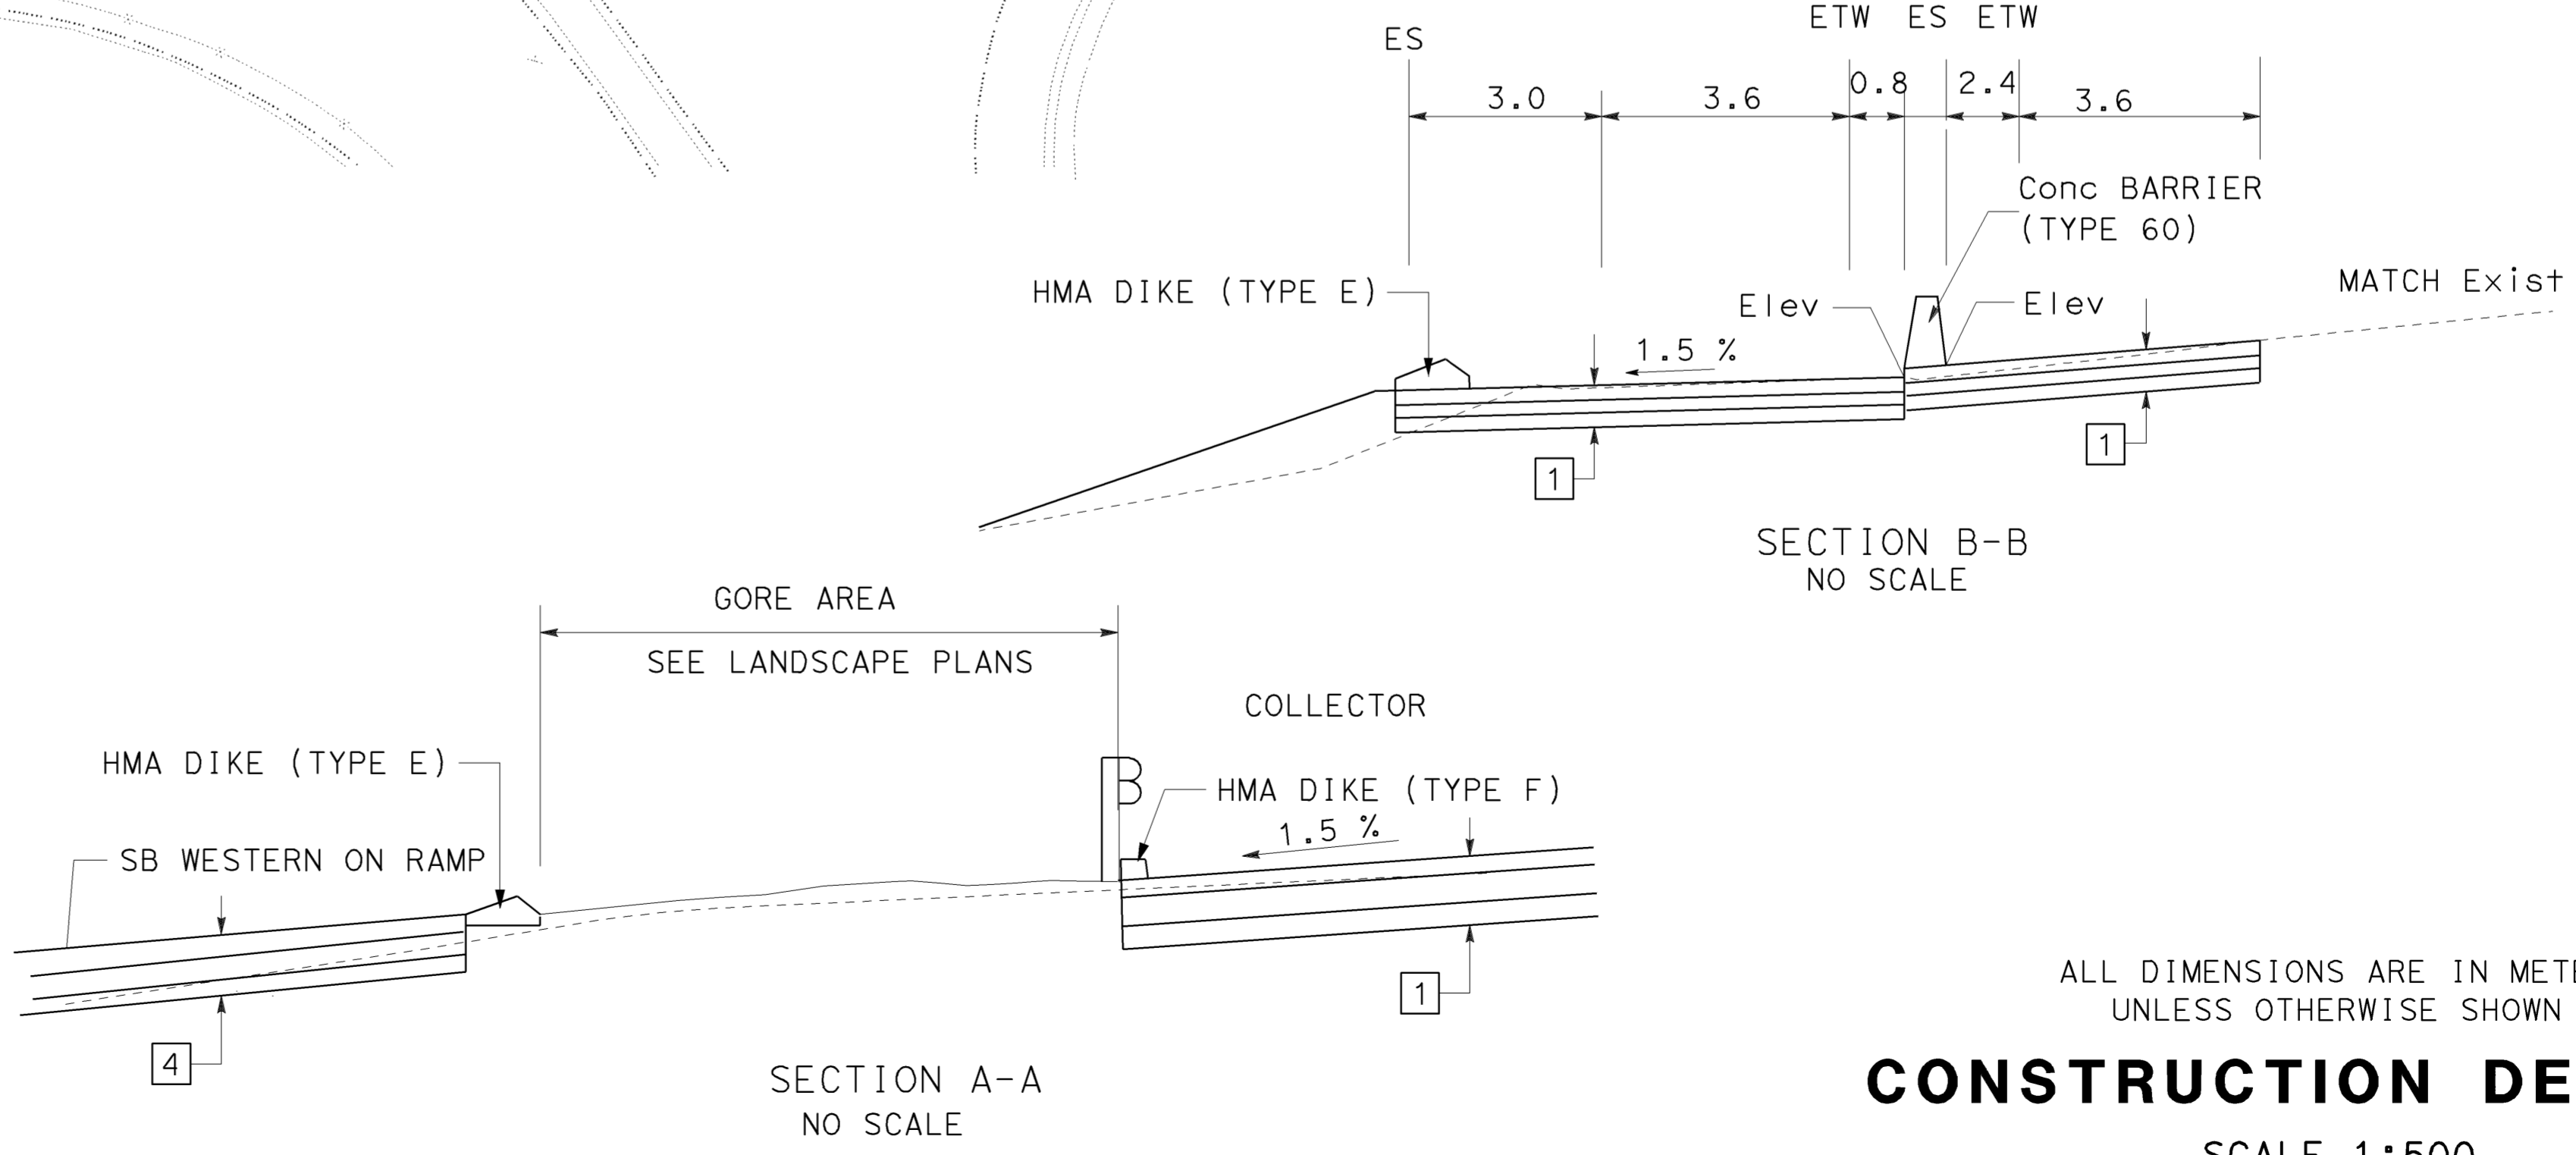
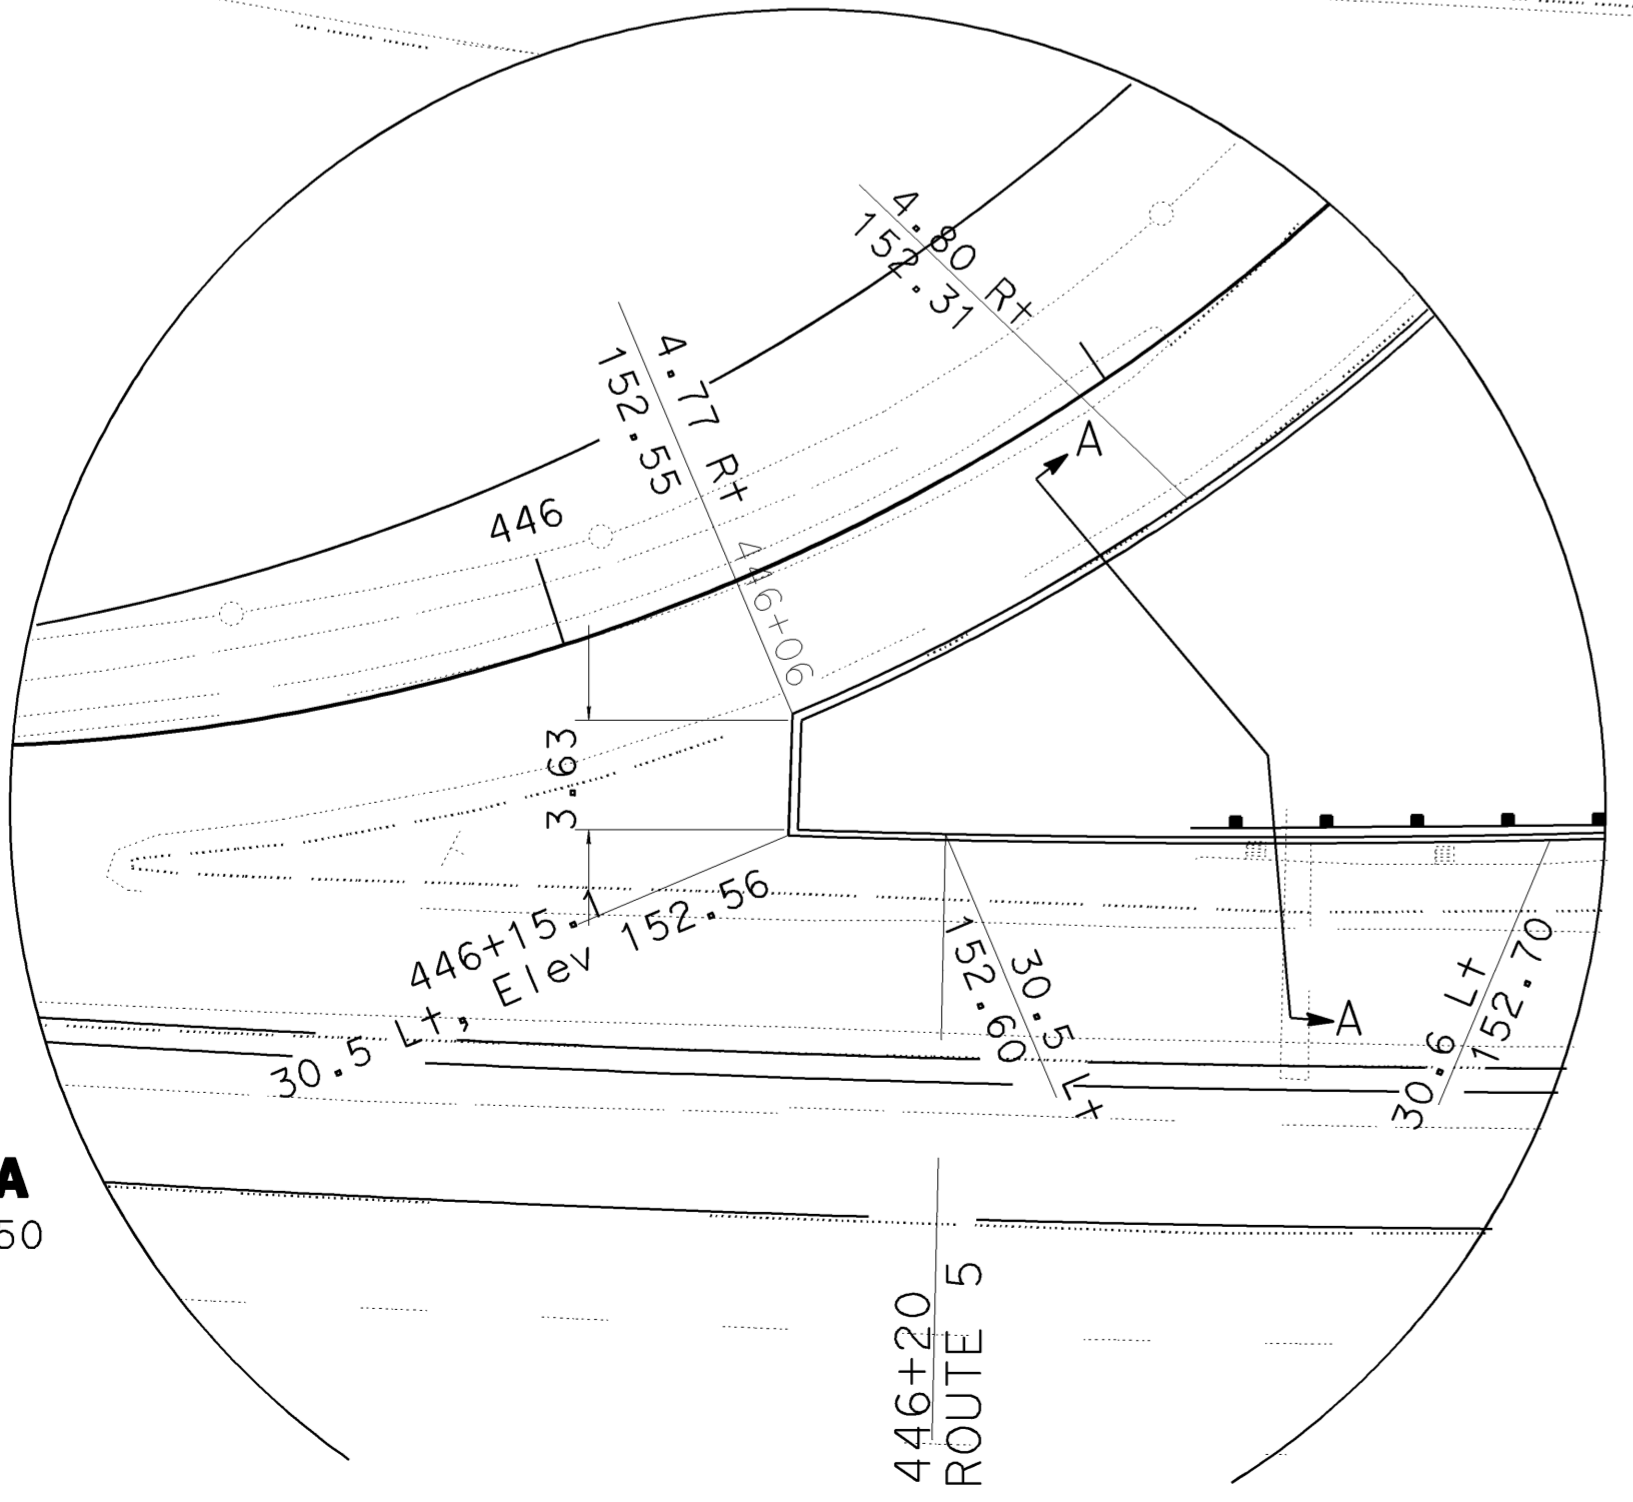
THIS PLAN IS ACCURATE FOR GORE AREA ONLY.

DIST	COUNTY	ROUTE	KILOMETER POST TOTAL PROJECT	SHEET No.	TOTAL SHEETS
07	LA	5	42.8/47.3	53	1073

REGISTERED CIVIL ENGINEER: *Munshi Mohsin* No. 61916
 DATE: 2-24-09
 PLANS APPROVAL DATE: 6-8-09


REGISTERED PROFESSIONAL ENGINEER: **MUNSHI MOHSIN** No. 61916
 Exp. 9/30/09
 CIVIL
 STATE OF CALIFORNIA

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CONSTRUCTION DETAILS
 SCALE 1:500
C-12

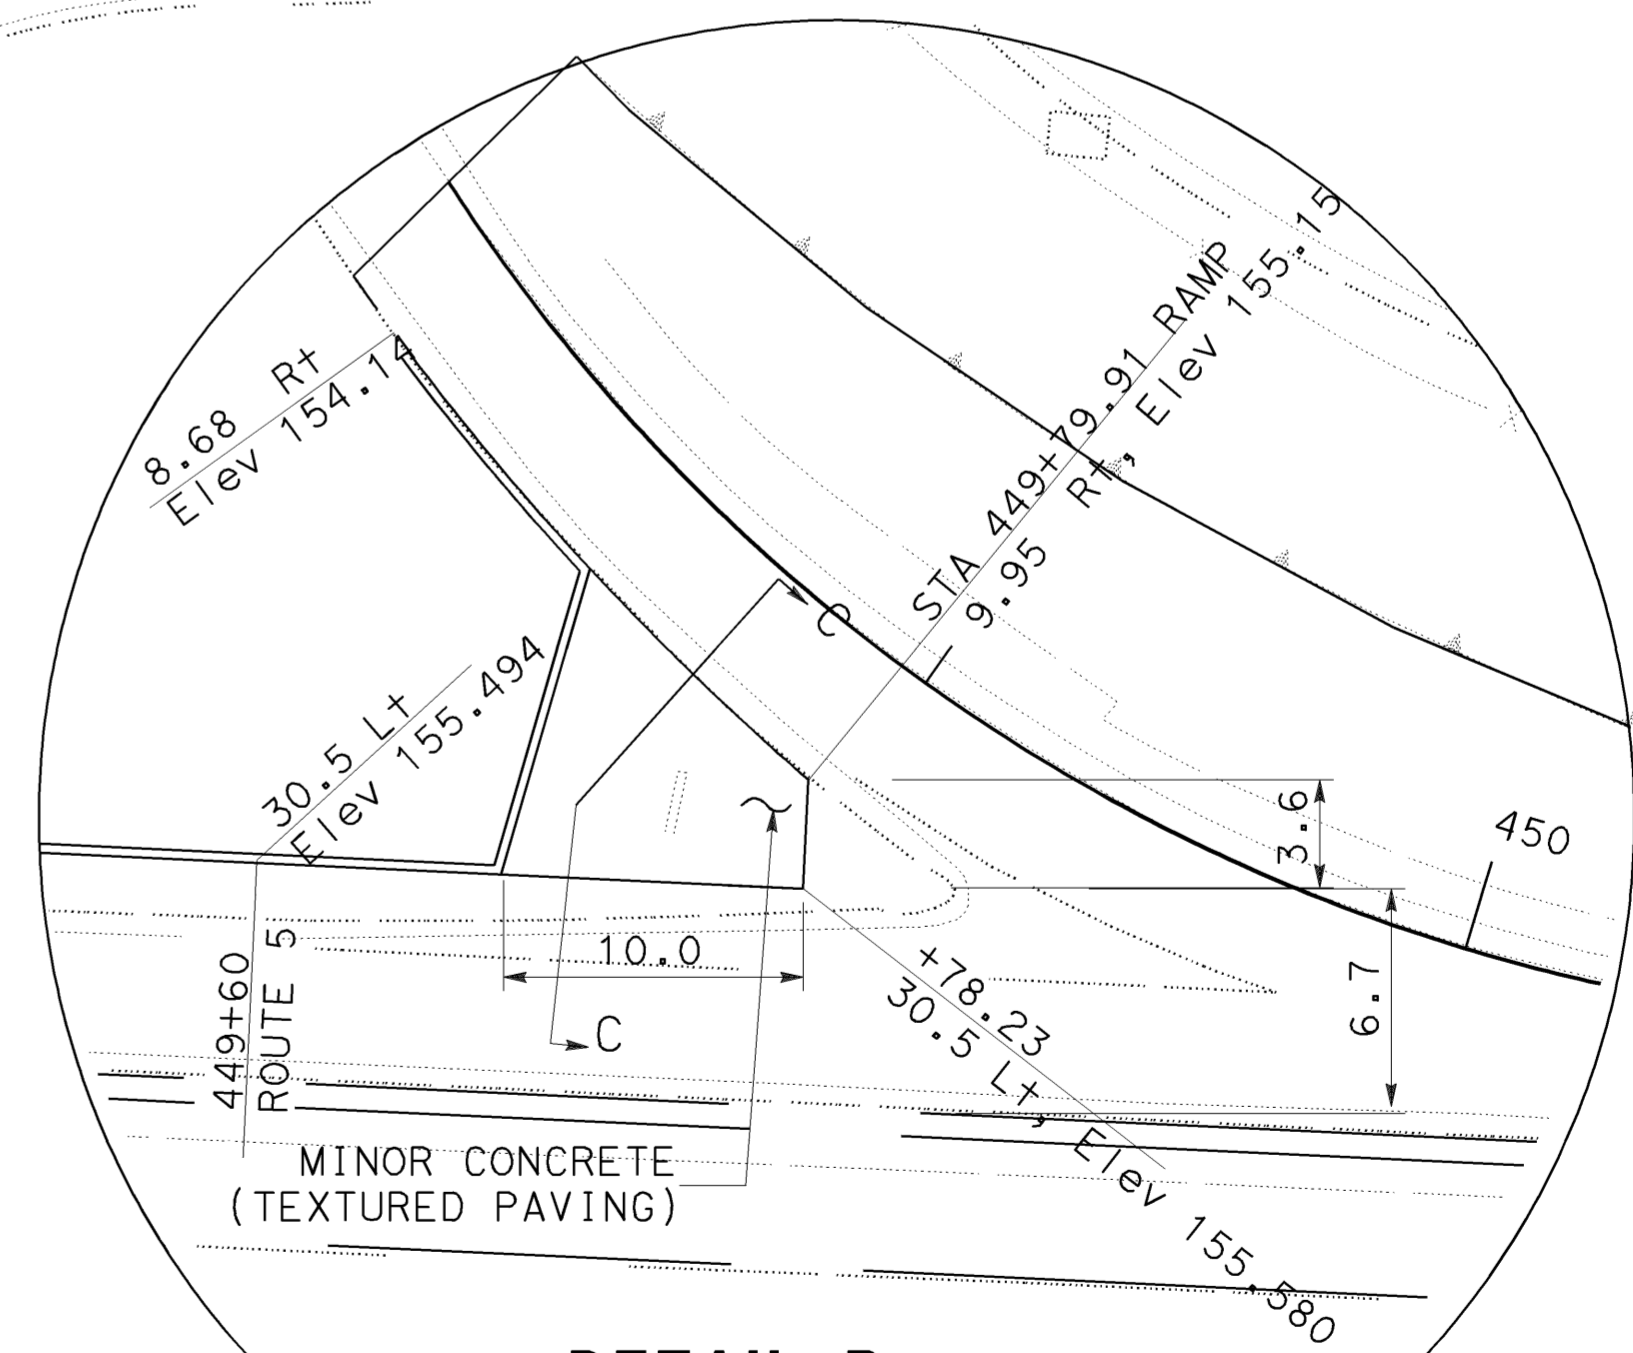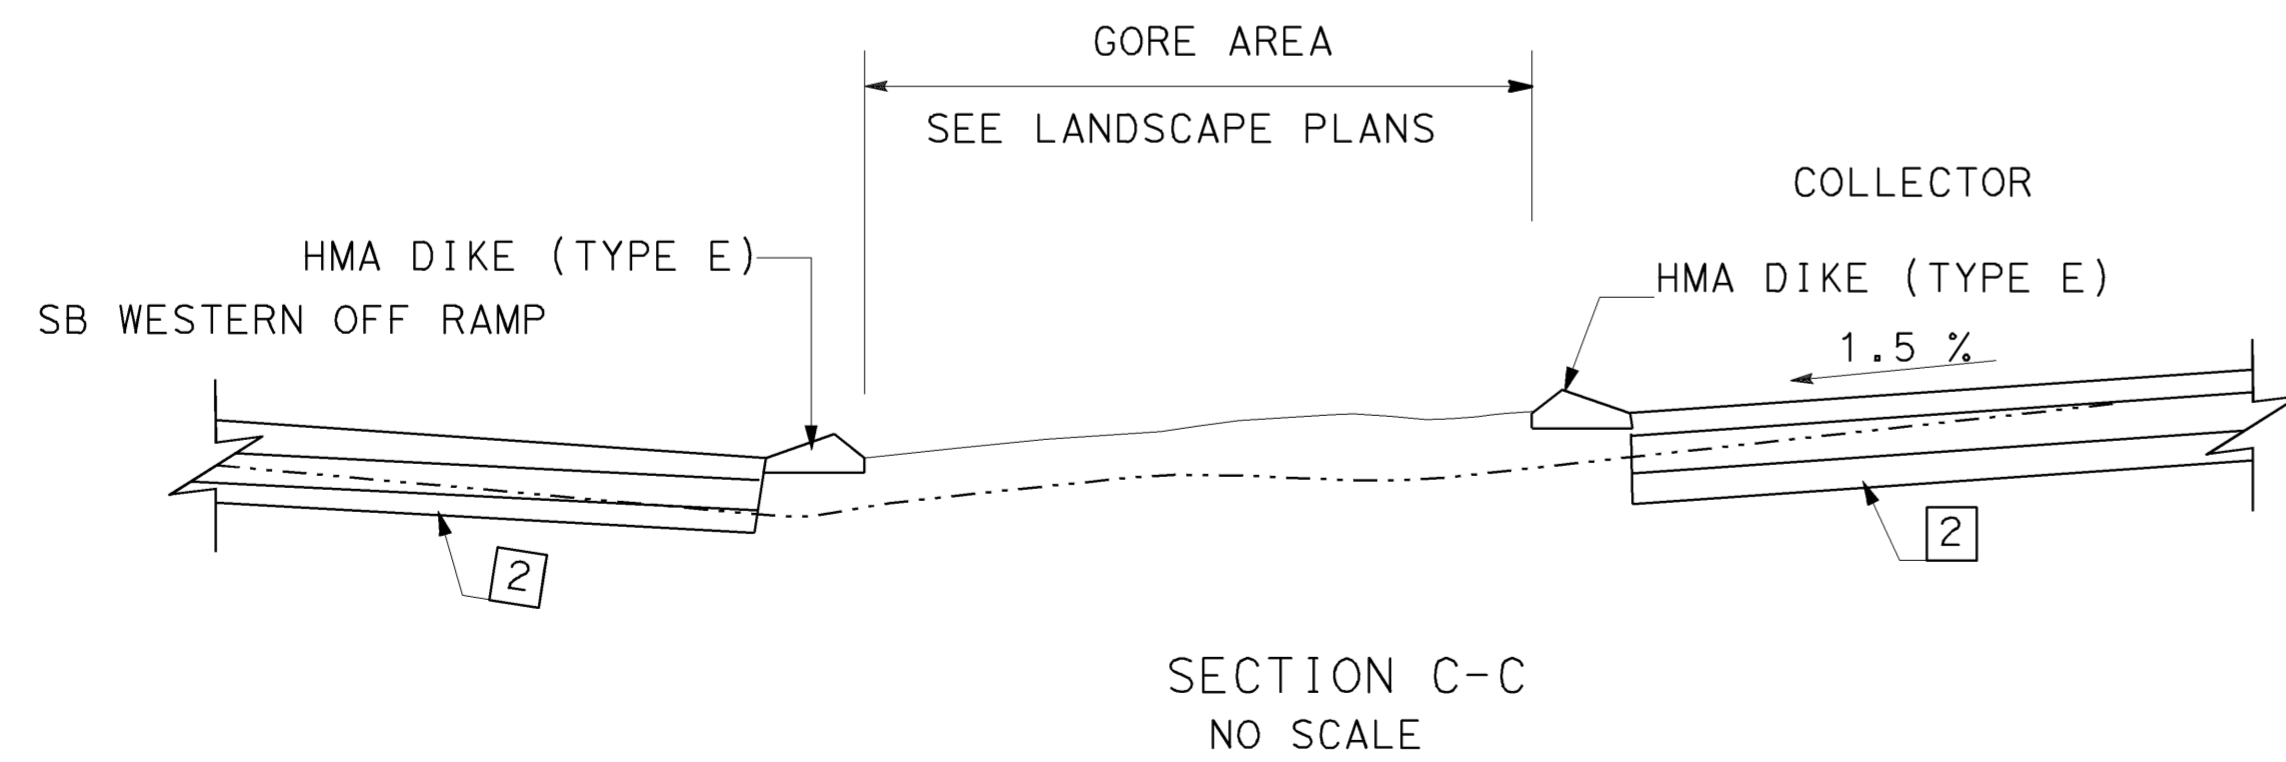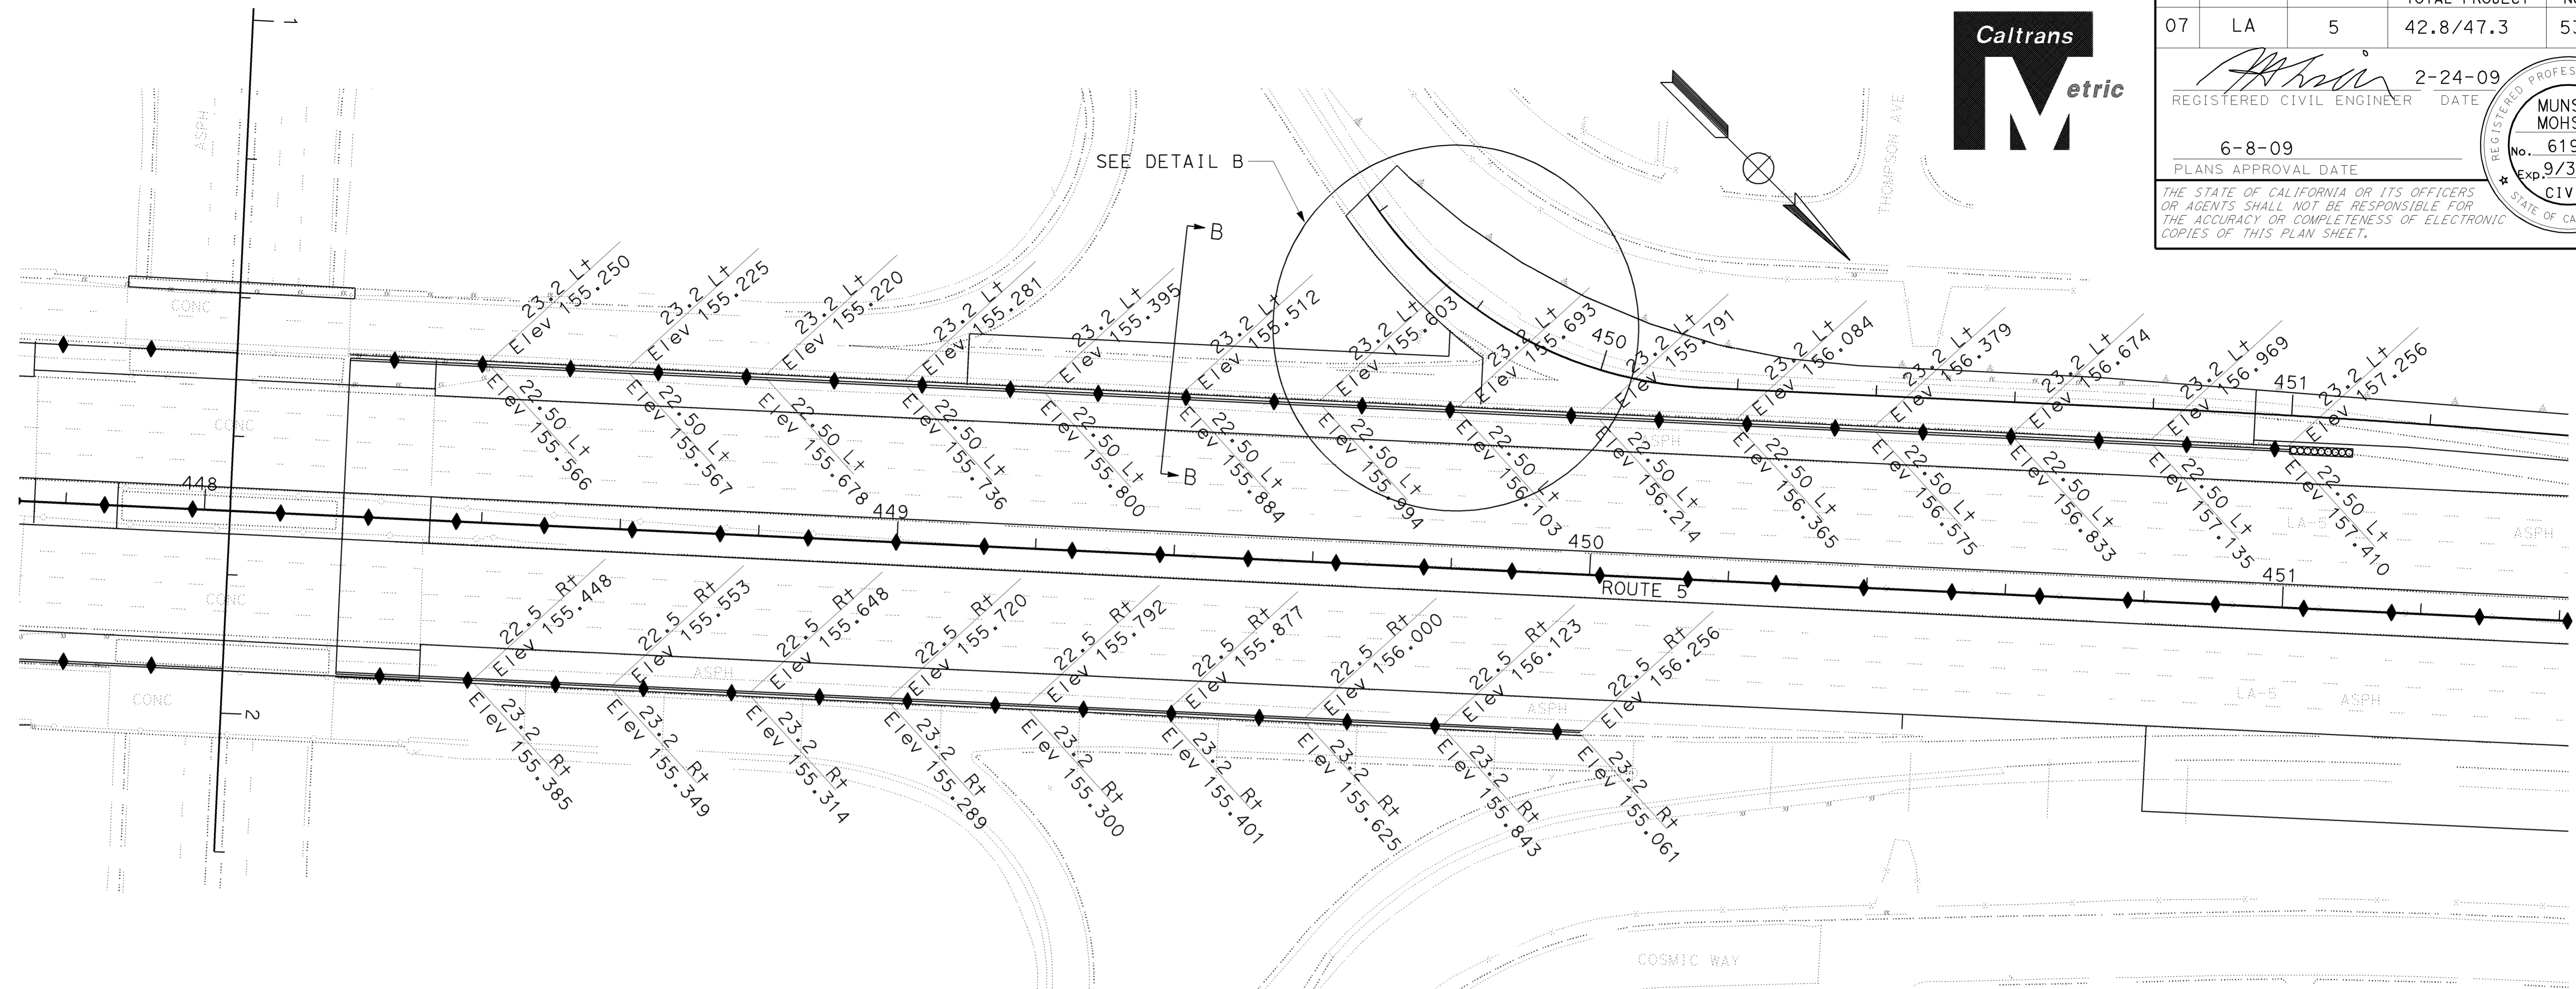THIS PLAN IS ACCURATE FOR GORE AREA ONLY.







Dist	COUNTY	ROUTE	KILOMETER POST TOTAL PROJECT	SHEET No.	TOTAL SHEETS
07	LA	5	42.8/47.3	54	1073

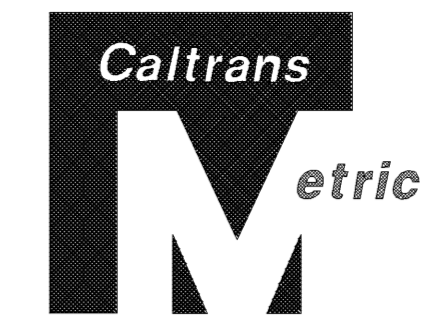2-24-09
 REGISTERED CIVIL ENGINEER DATE
 6-8-09
 PLANS APPROVAL DATE

REGISTERED PROFESSIONAL ENGINEER
 MUNSHI MOHSIN
 No. 61916
 Exp. 9/30/09
 CIVIL
 STATE OF CALIFORNIA

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NOTE:
 FOR SECTION B-B SEE SHEET C-11

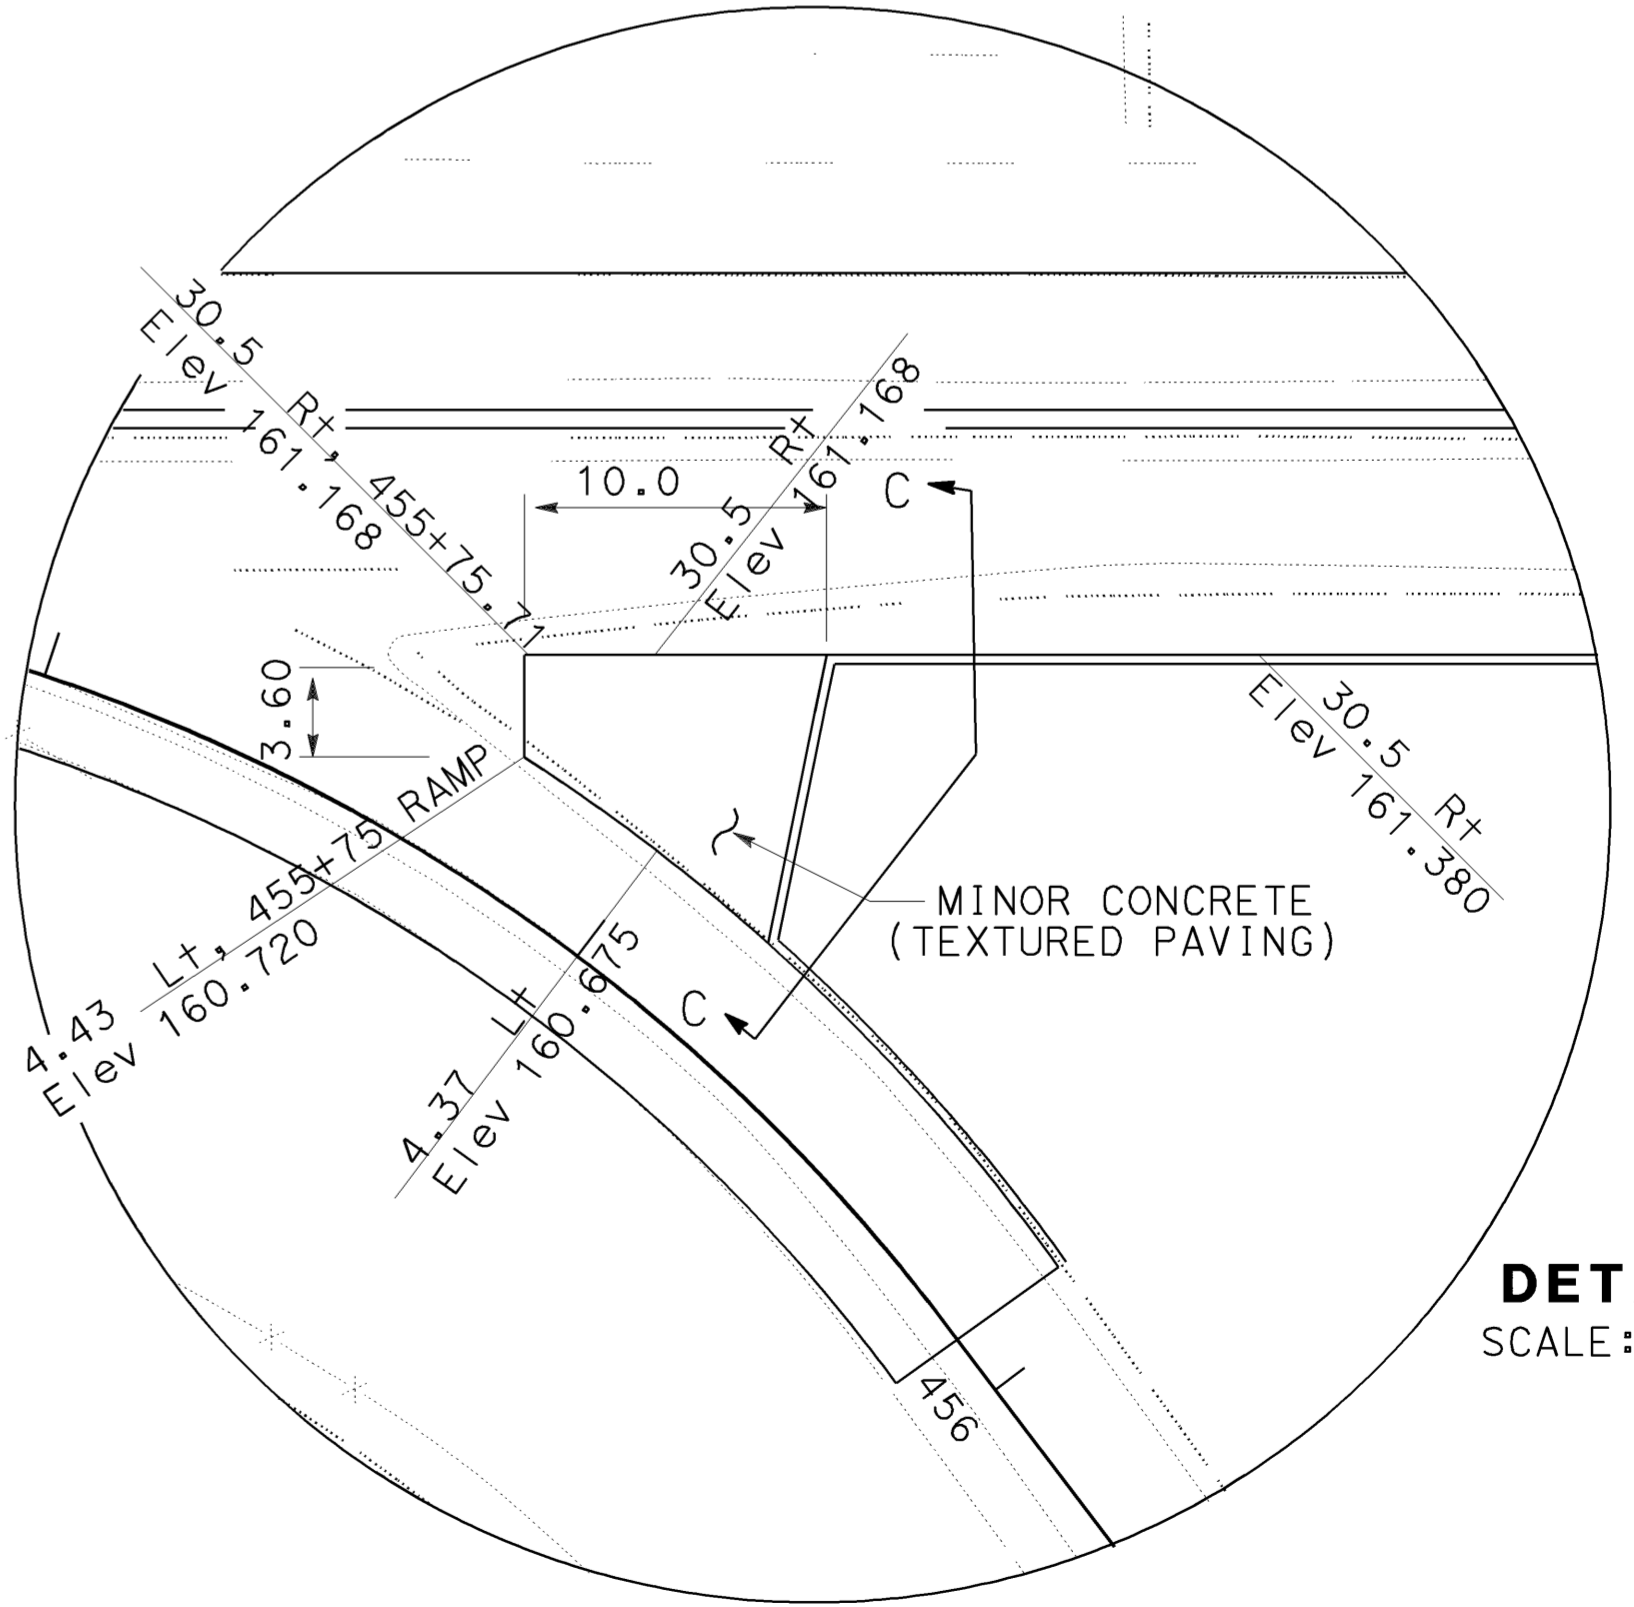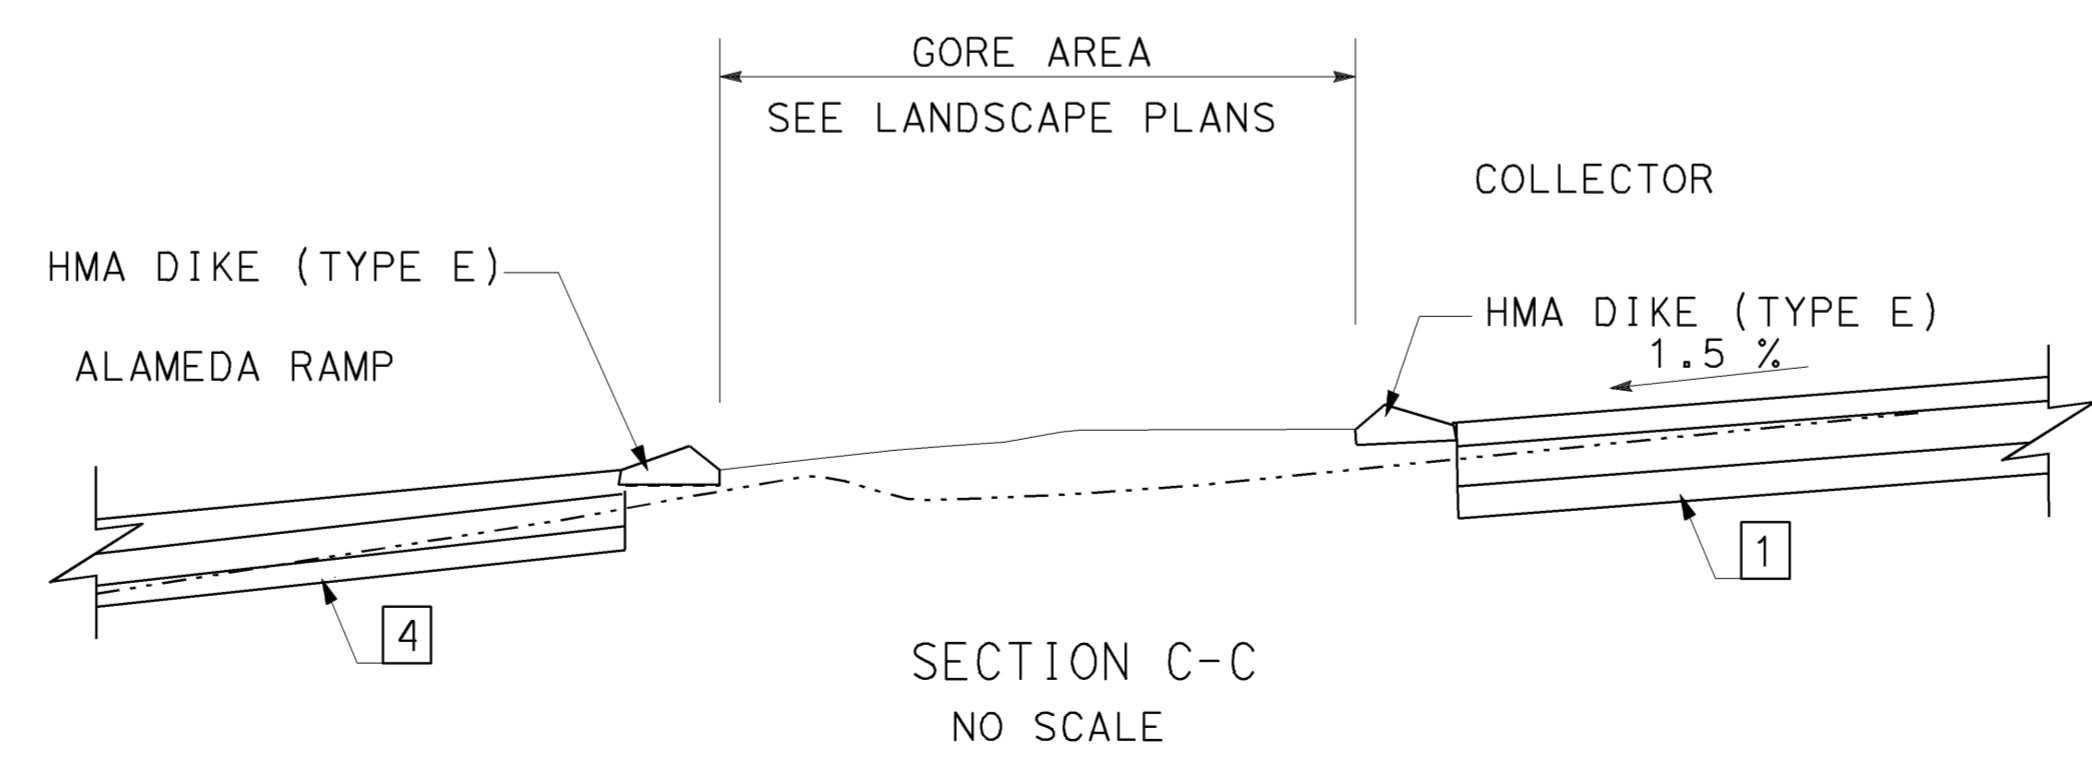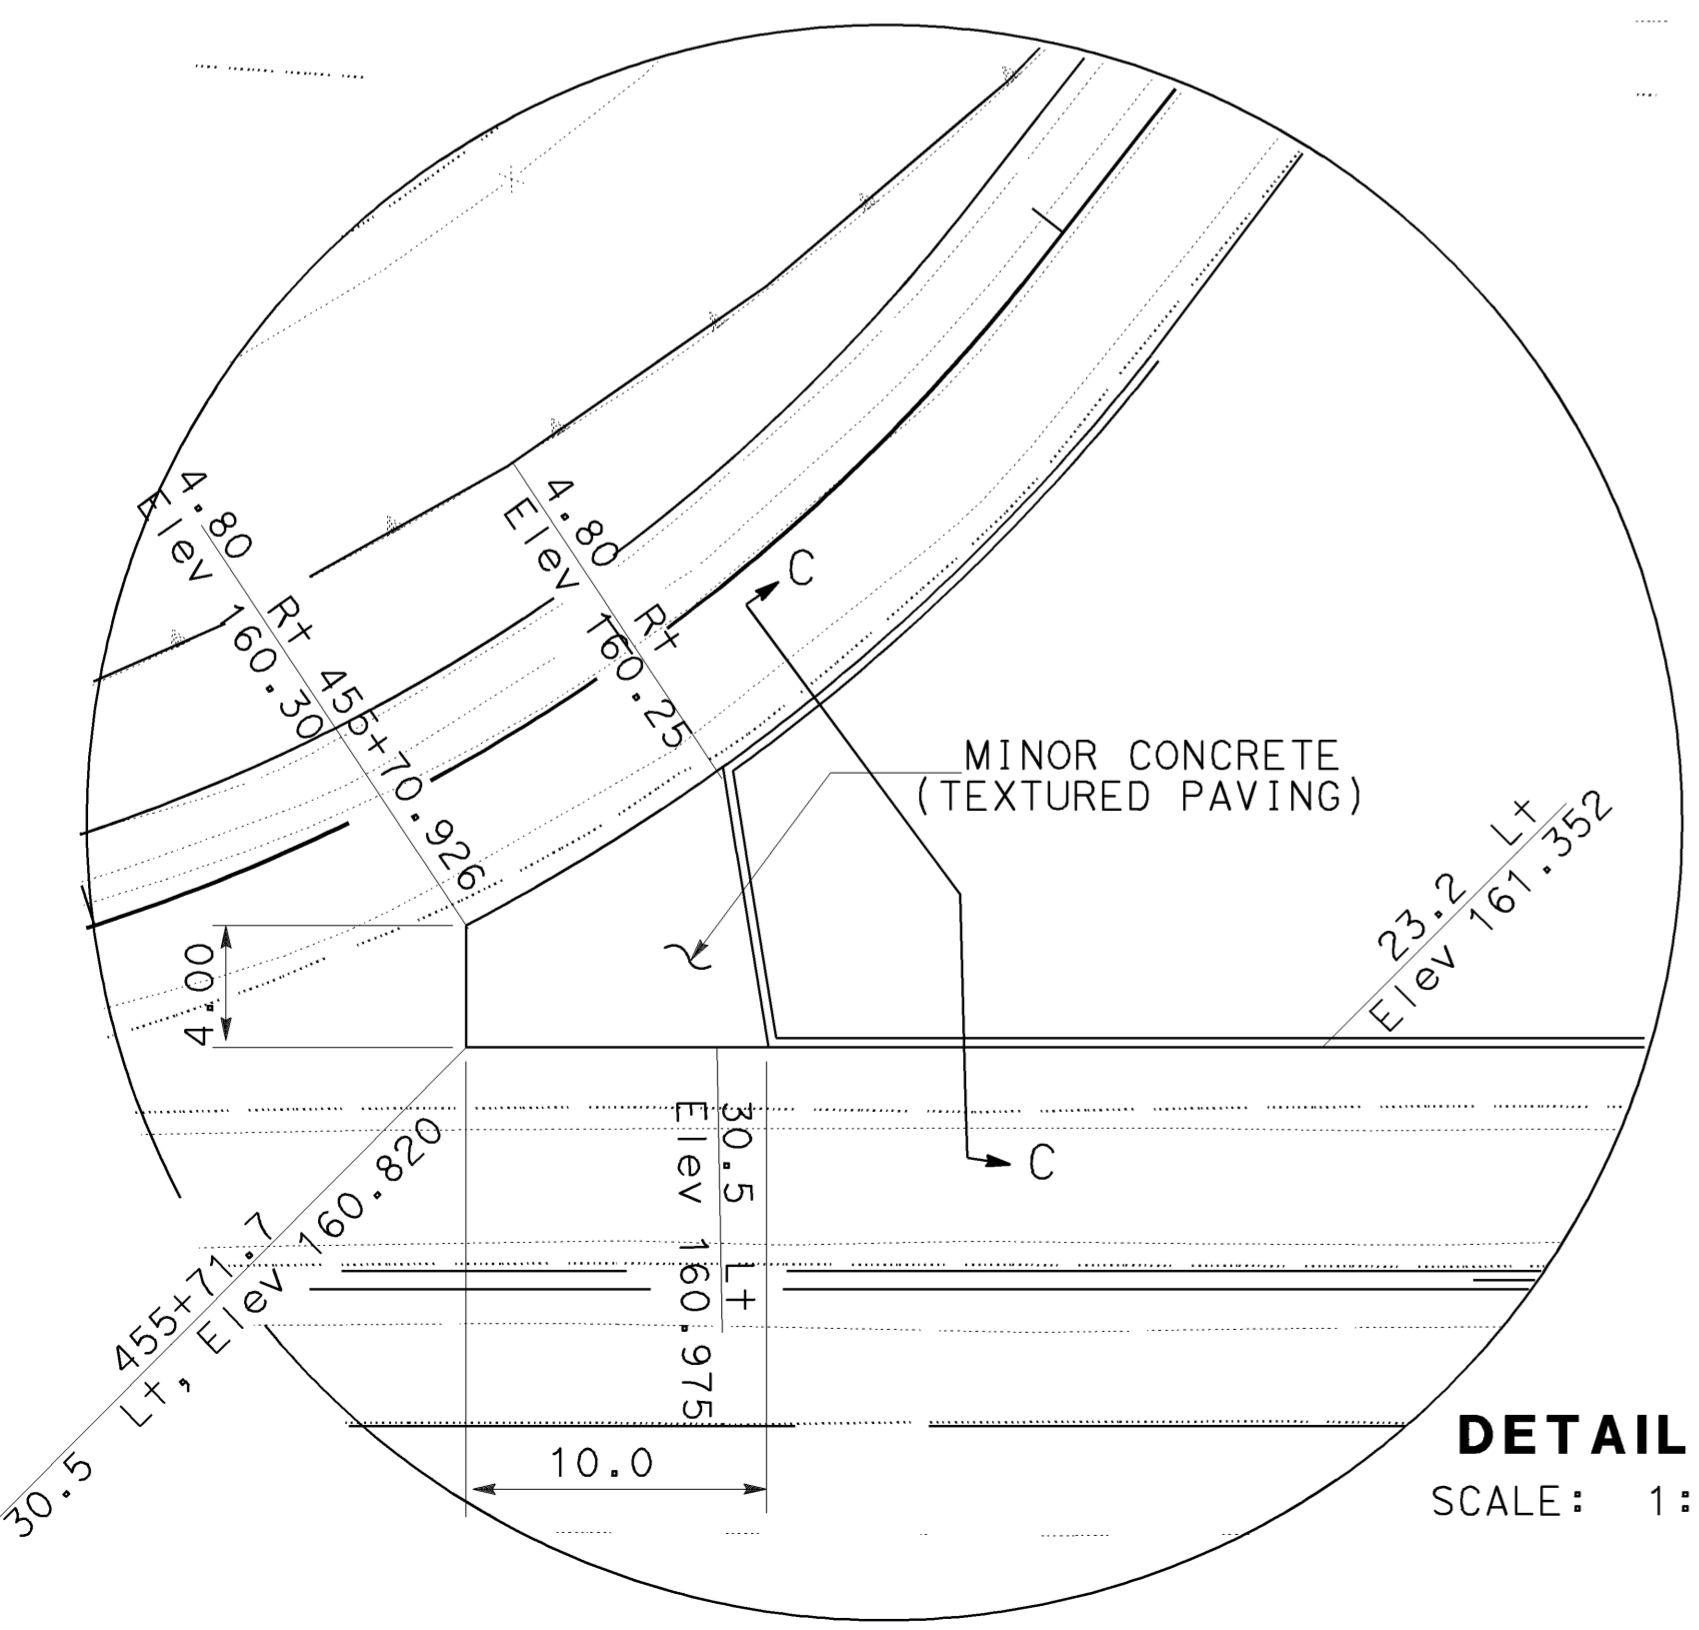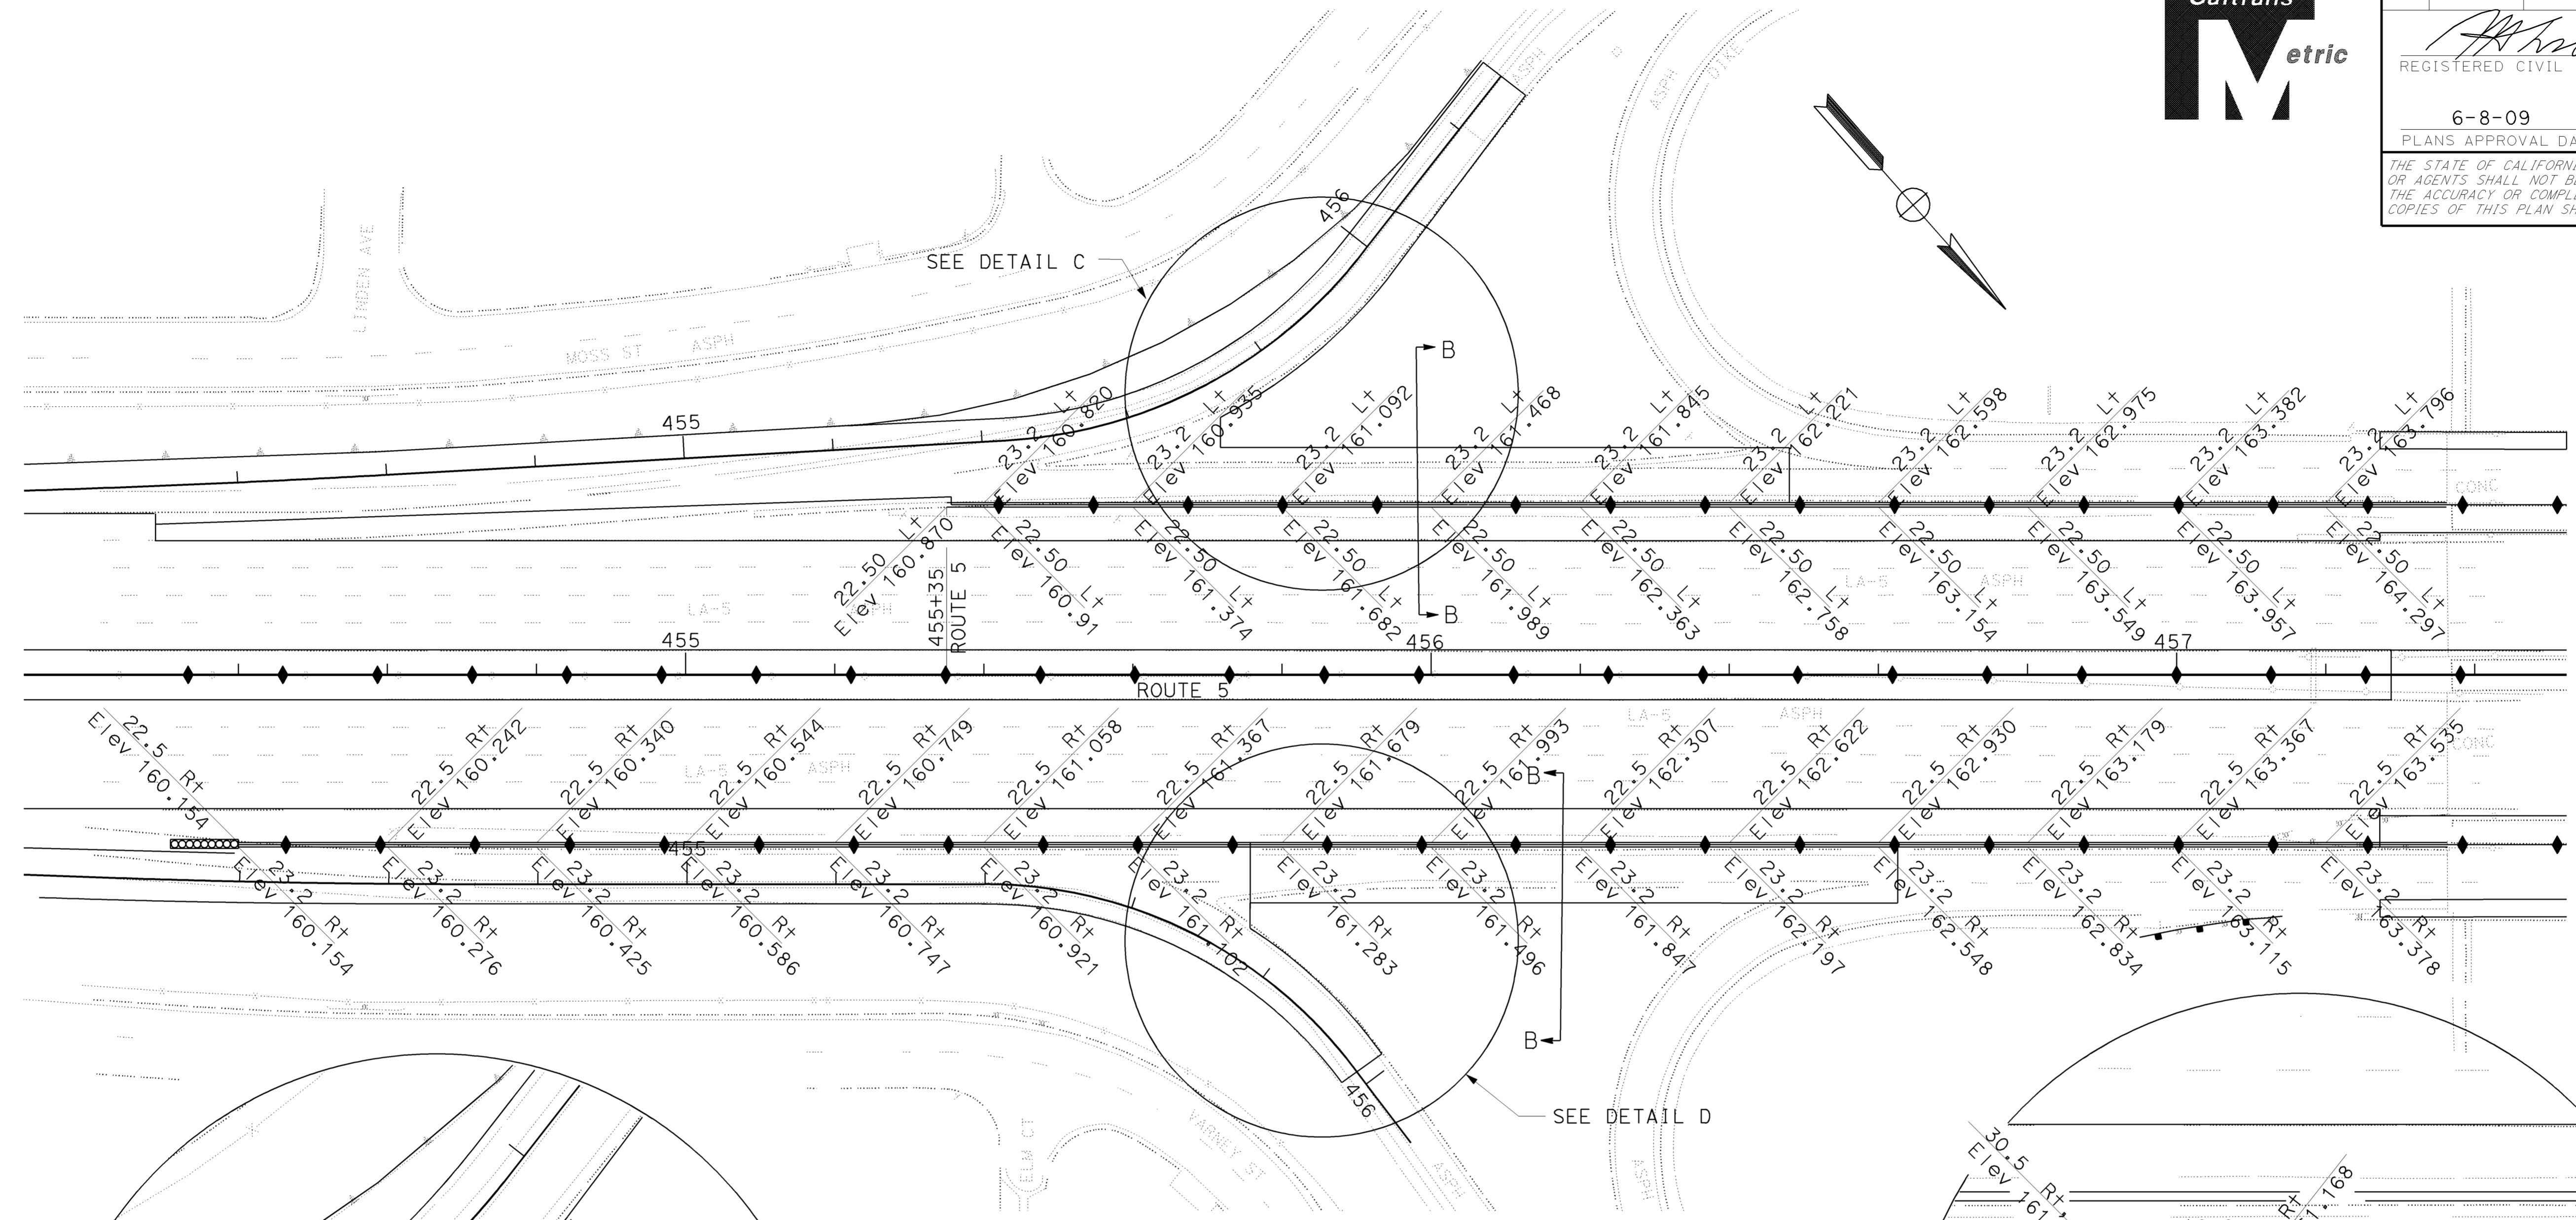CONSTRUCTION DETAILS

ALL DIMENSIONS ARE IN METERS
 UNLESS OTHERWISE SHOWN

SCALE 1:500




STATE OF CALIFORNIA - DEPARTMENT OF TRANSPORTATION
Caltrans OFFICE OF DESIGN D
 FUNCTIONAL SUPERVISOR
 CELINA AVILES
 CHECKED BY
 DAWIT WOKU
 MUNSHI MOHSIN
 REVISIONS BY
 MM
 DATE REVISIONS
 11/2008 02-05-09
 CTT
 02-05-09



Dist	COUNTY	ROUTE	KILOMETER POST TOTAL PROJECT	SHEET No.	TOTAL SHEETS
07	LA	5	42.8/47.3	55	1073

REGISTERED CIVIL ENGINEER
 DATE 2-24-09
 PLANS APPROVAL DATE 6-8-09
 REGISTERED PROFESSIONAL ENGINEER
 MUNSHI MOHSIN
 No. 61916
 Exp. 9/30/09
 CIVIL
 STATE OF CALIFORNIA

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ALL DIMENSIONS ARE IN METERS
 UNLESS OTHERWISE SHOWN

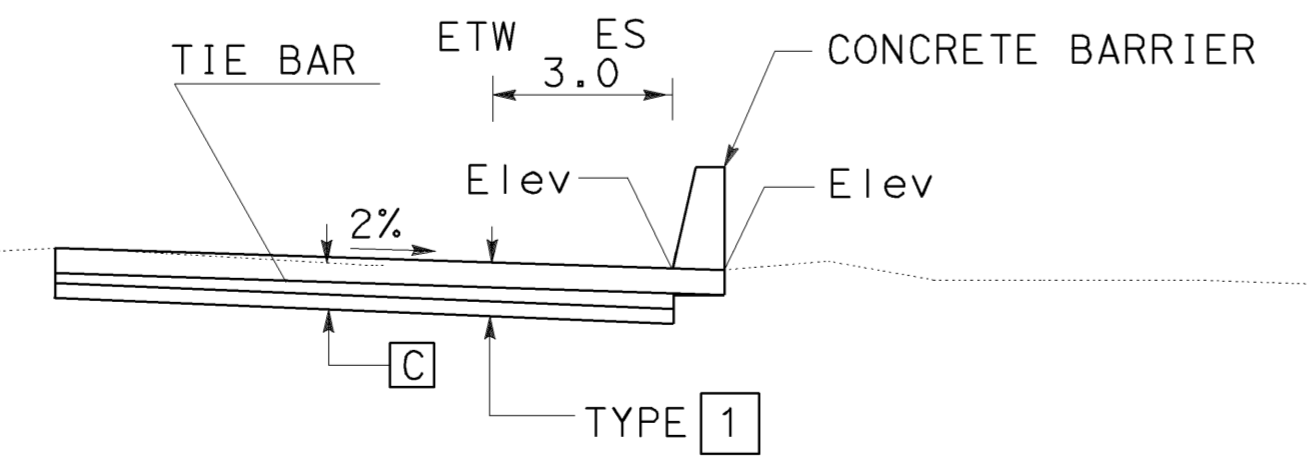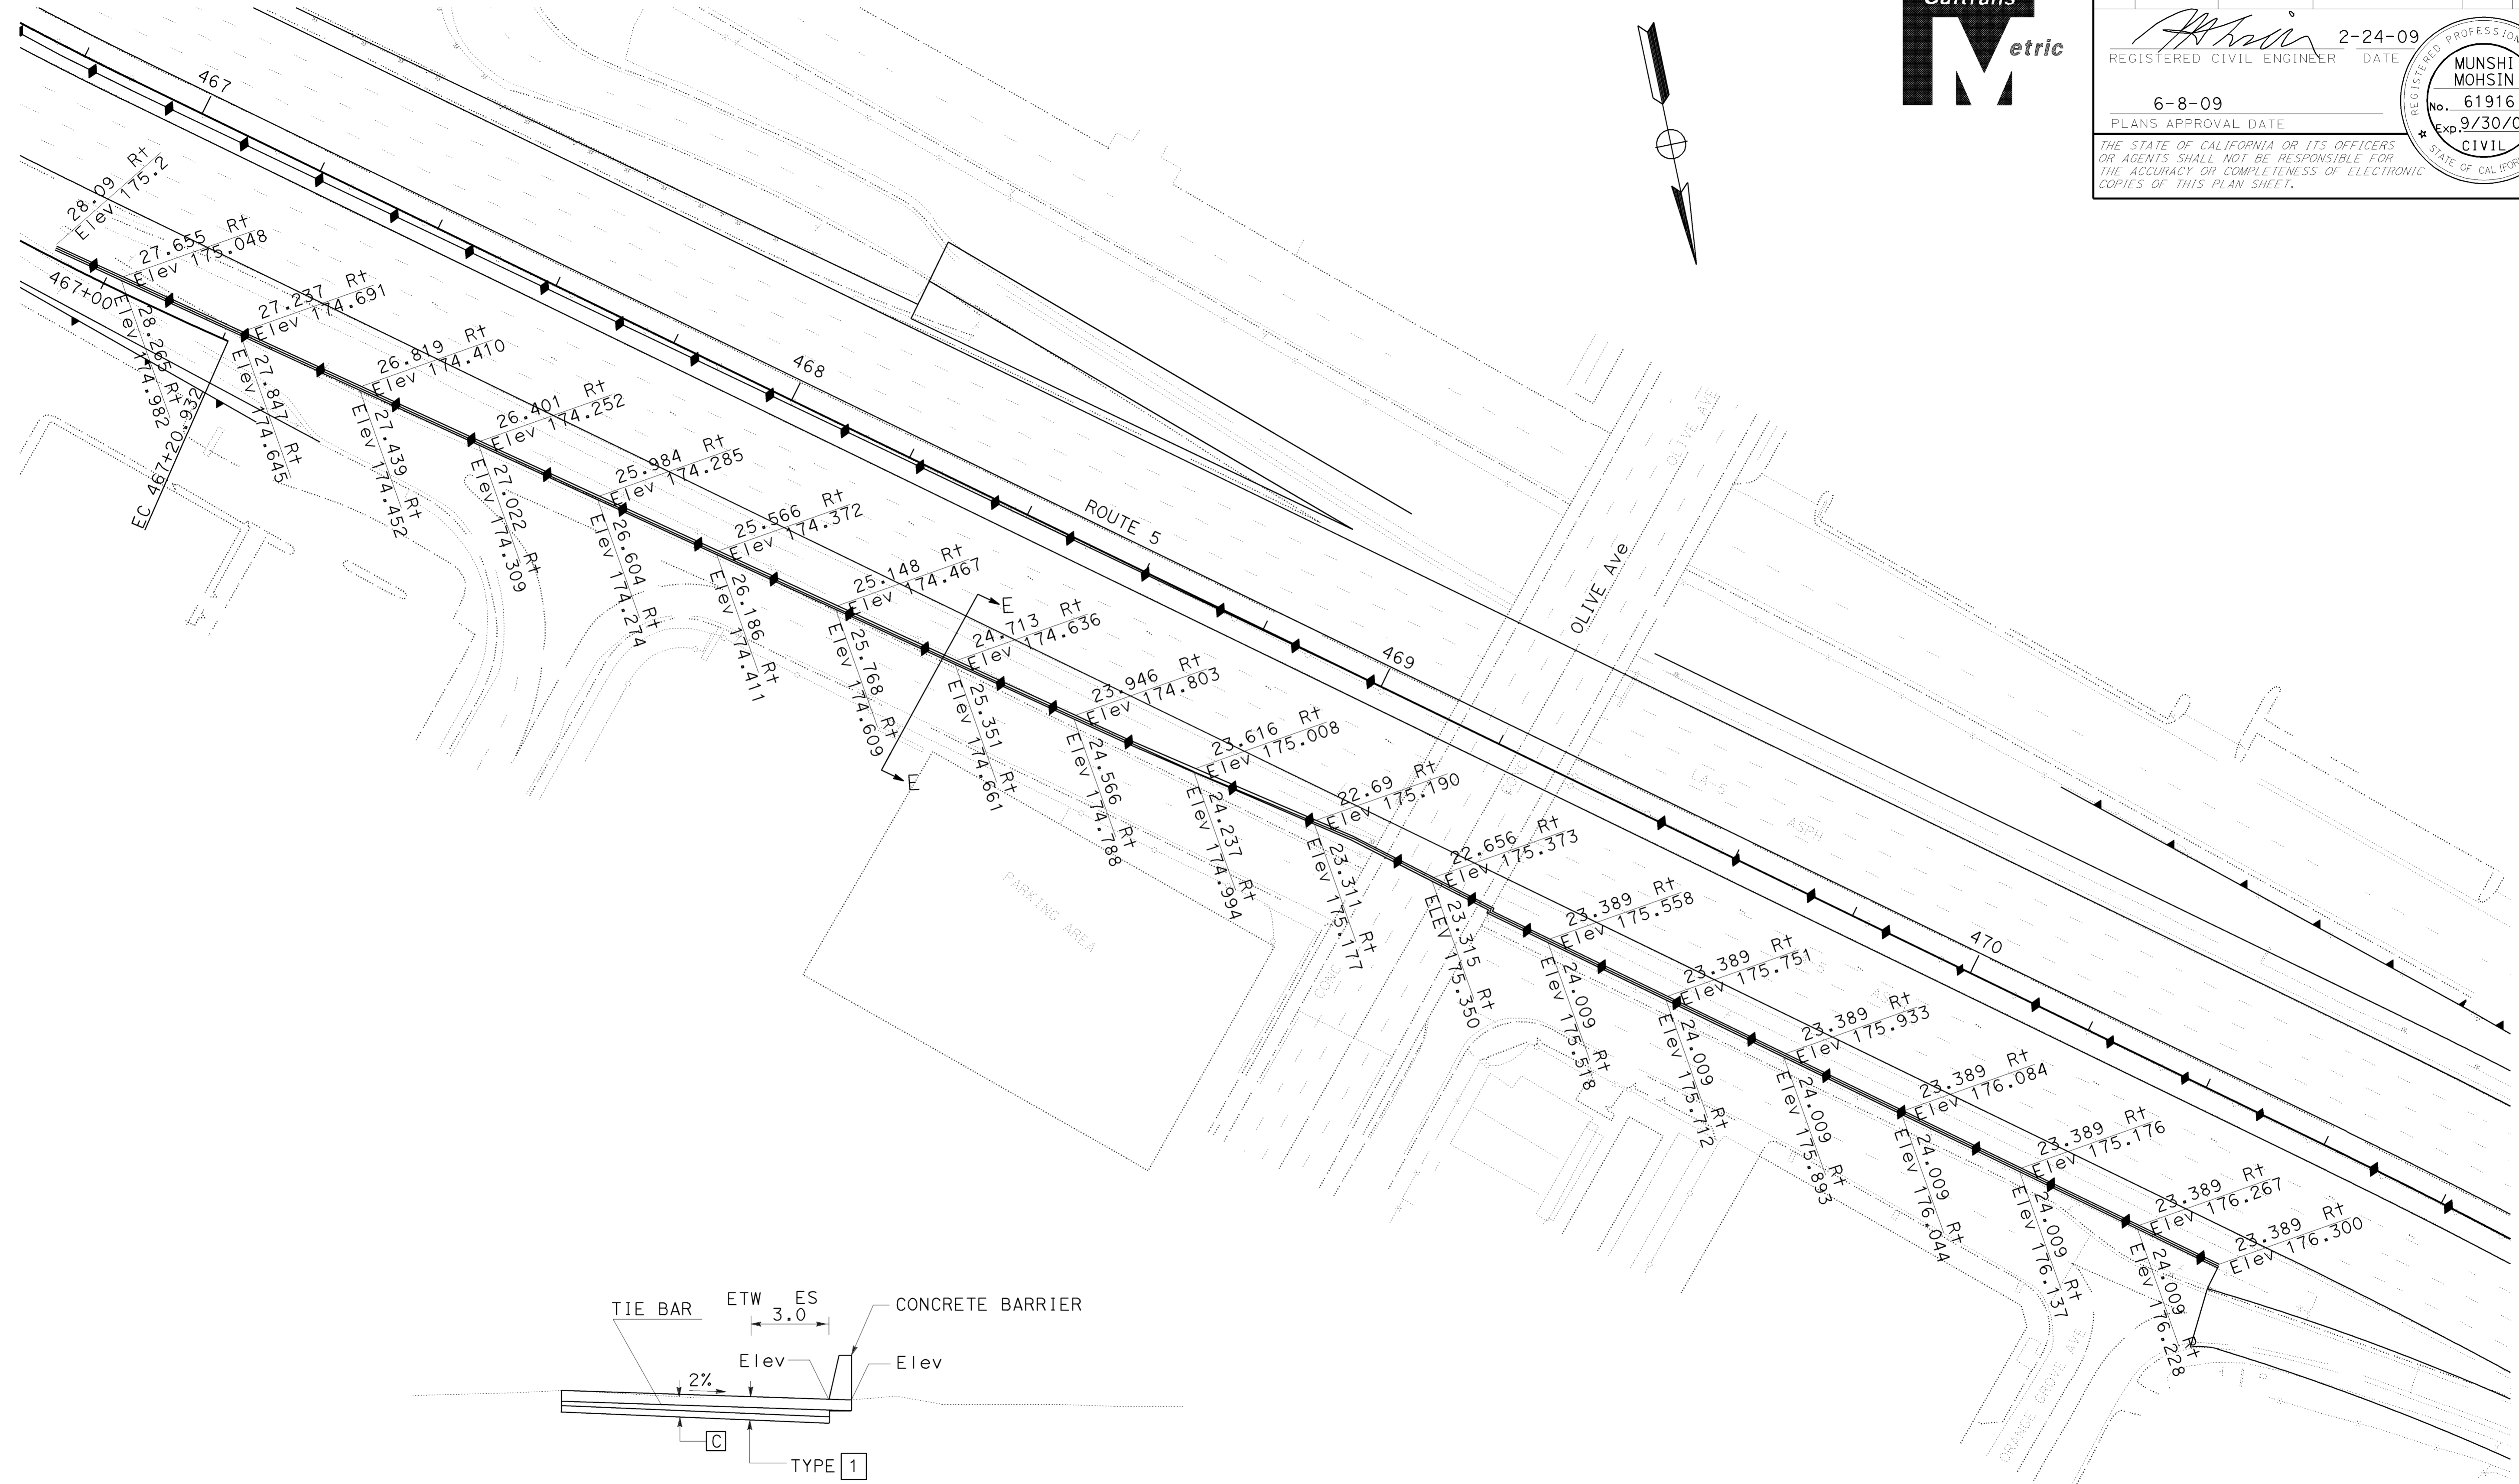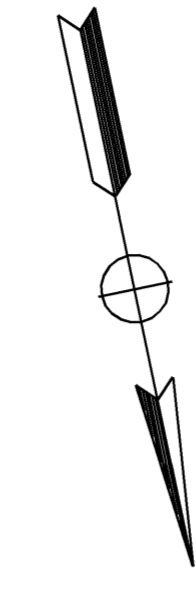CONSTRUCTION DETAILS

SCALE 1:500

C-14



STATE OF CALIFORNIA - DEPARTMENT OF TRANSPORTATION
Caltrans OFFICE OF DESIGN D
 FUNCTIONAL SUPERVISOR
 CELINA AVILES
 CHECKED BY
 DAWIT WORKU
 MUNSHI MOHSIN
 REVISOR BY
 DATE REVISED
 DW
 10/2008
 DP
 11/2008
 CTT
 02-05-09




Dist	COUNTY	ROUTE	KILOMETER POST TOTAL PROJECT	SHEET No.	TOTAL SHEETS
07	LA	5	42.8/47.3	56	1073

REGISTERED CIVIL ENGINEER
 DATE 2-24-09
 PLANS APPROVAL DATE 6-8-09
 THE STATE OF CALIFORNIA OR ITS OFFICERS OR AGENTS SHALL NOT BE RESPONSIBLE FOR THE ACCURACY OR COMPLETENESS OF ELECTRONIC COPIES OF THIS PLAN SHEET.


REGISTERED PROFESSIONAL ENGINEER
 MUNSHI MOHSIN
 No. 61916
 Exp. 9/30/09
 CIVIL
 STATE OF CALIFORNIA

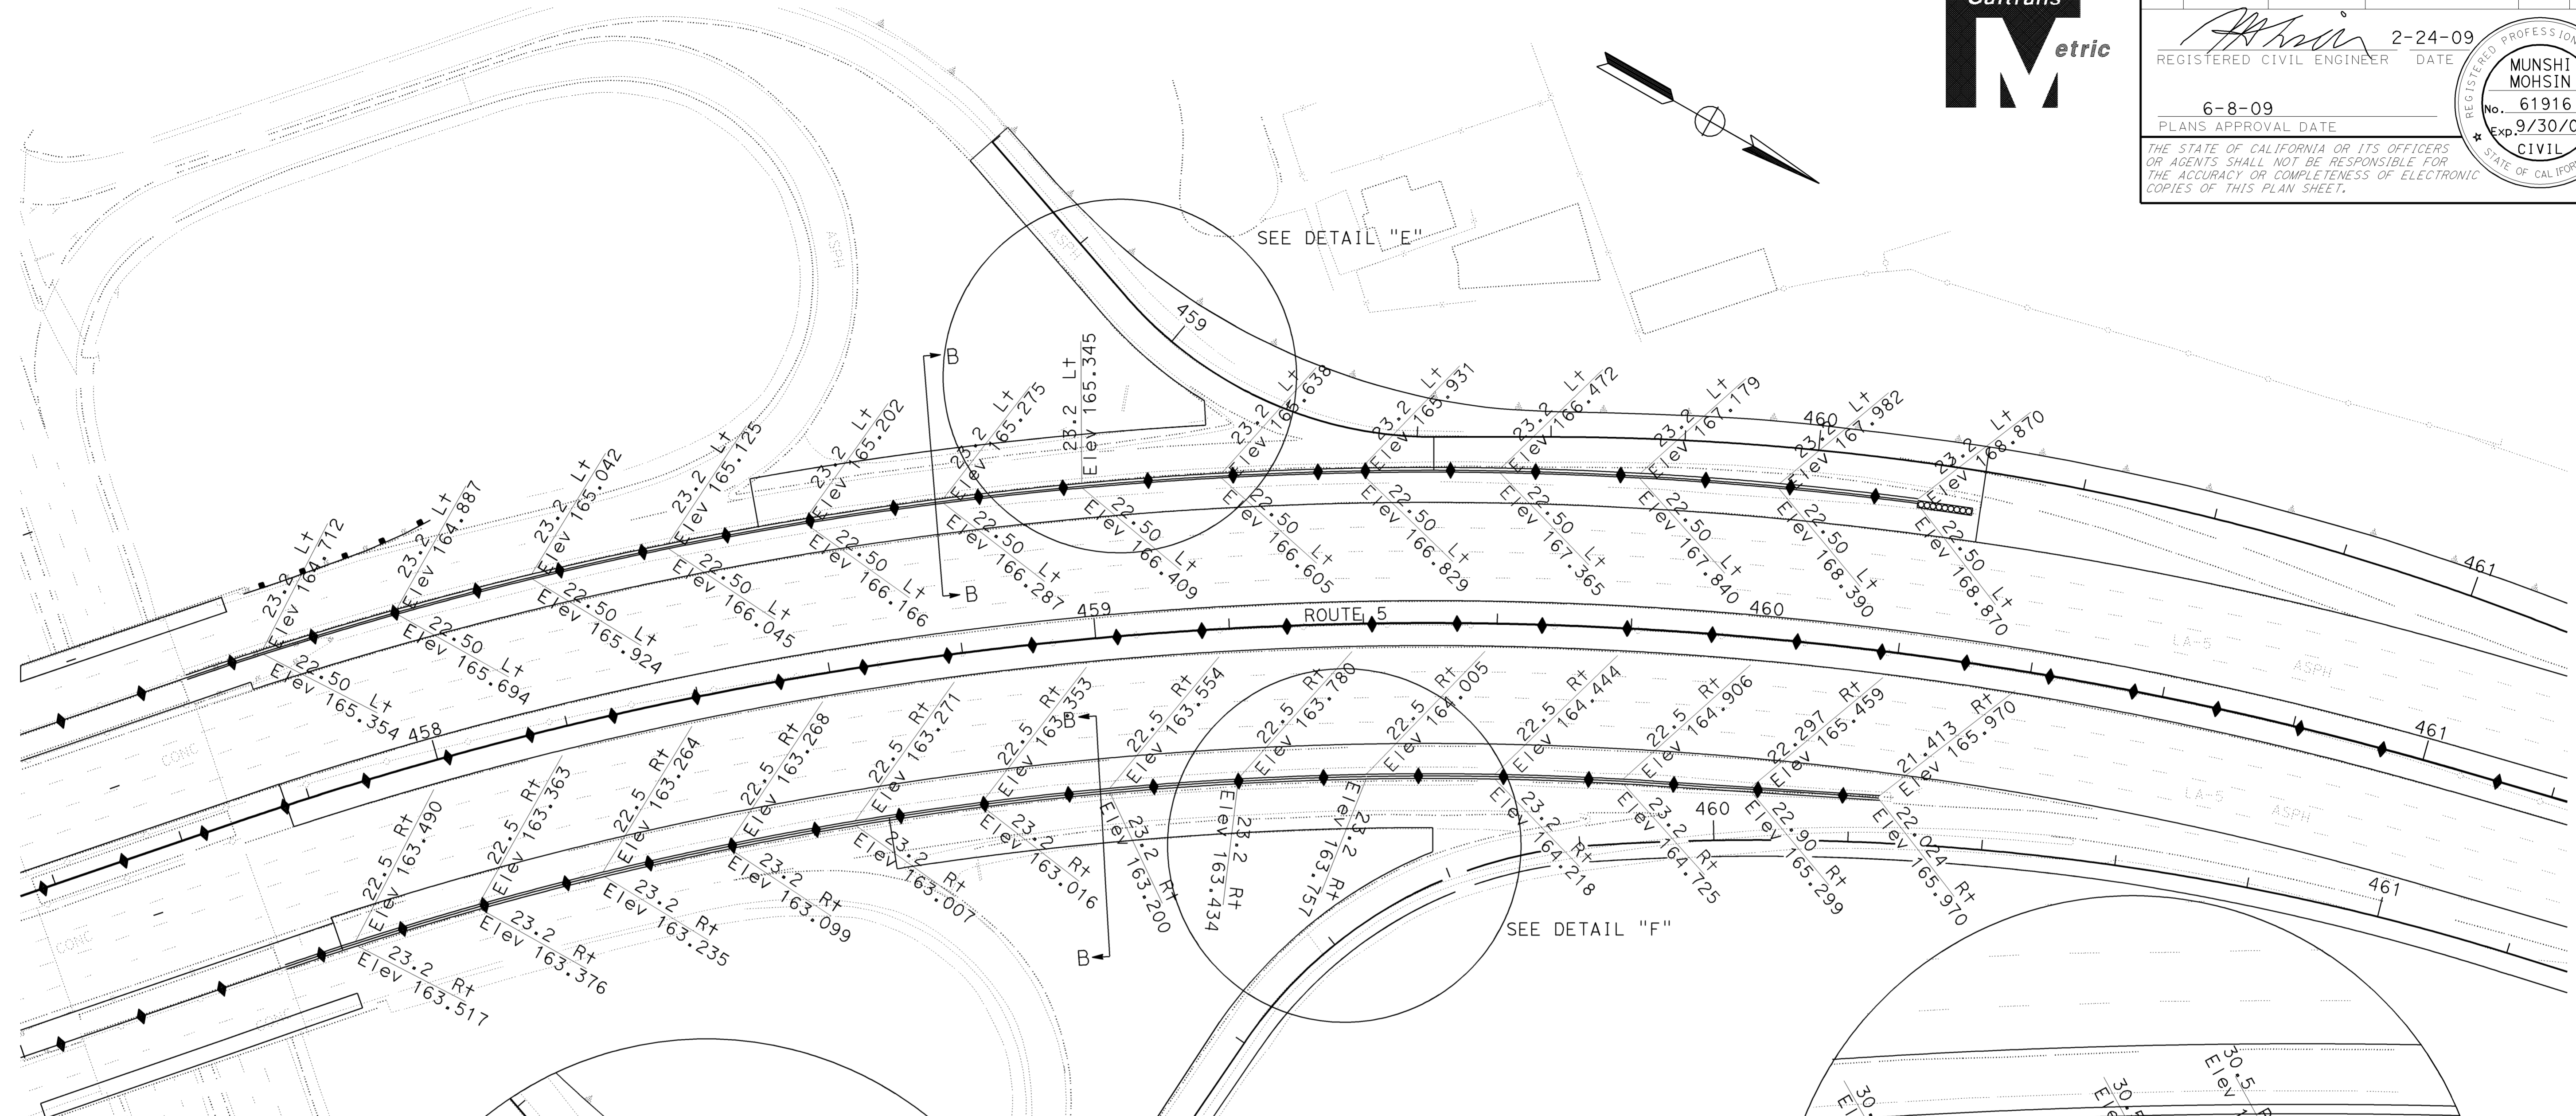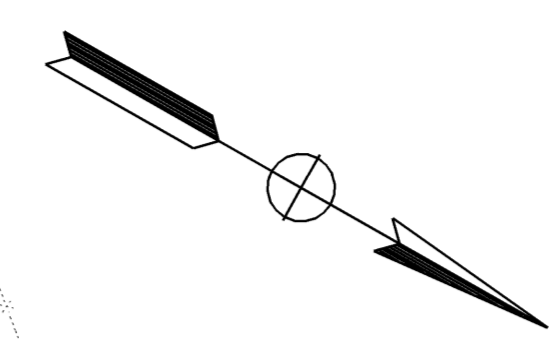

DETAIL E
SCALE: 1:250

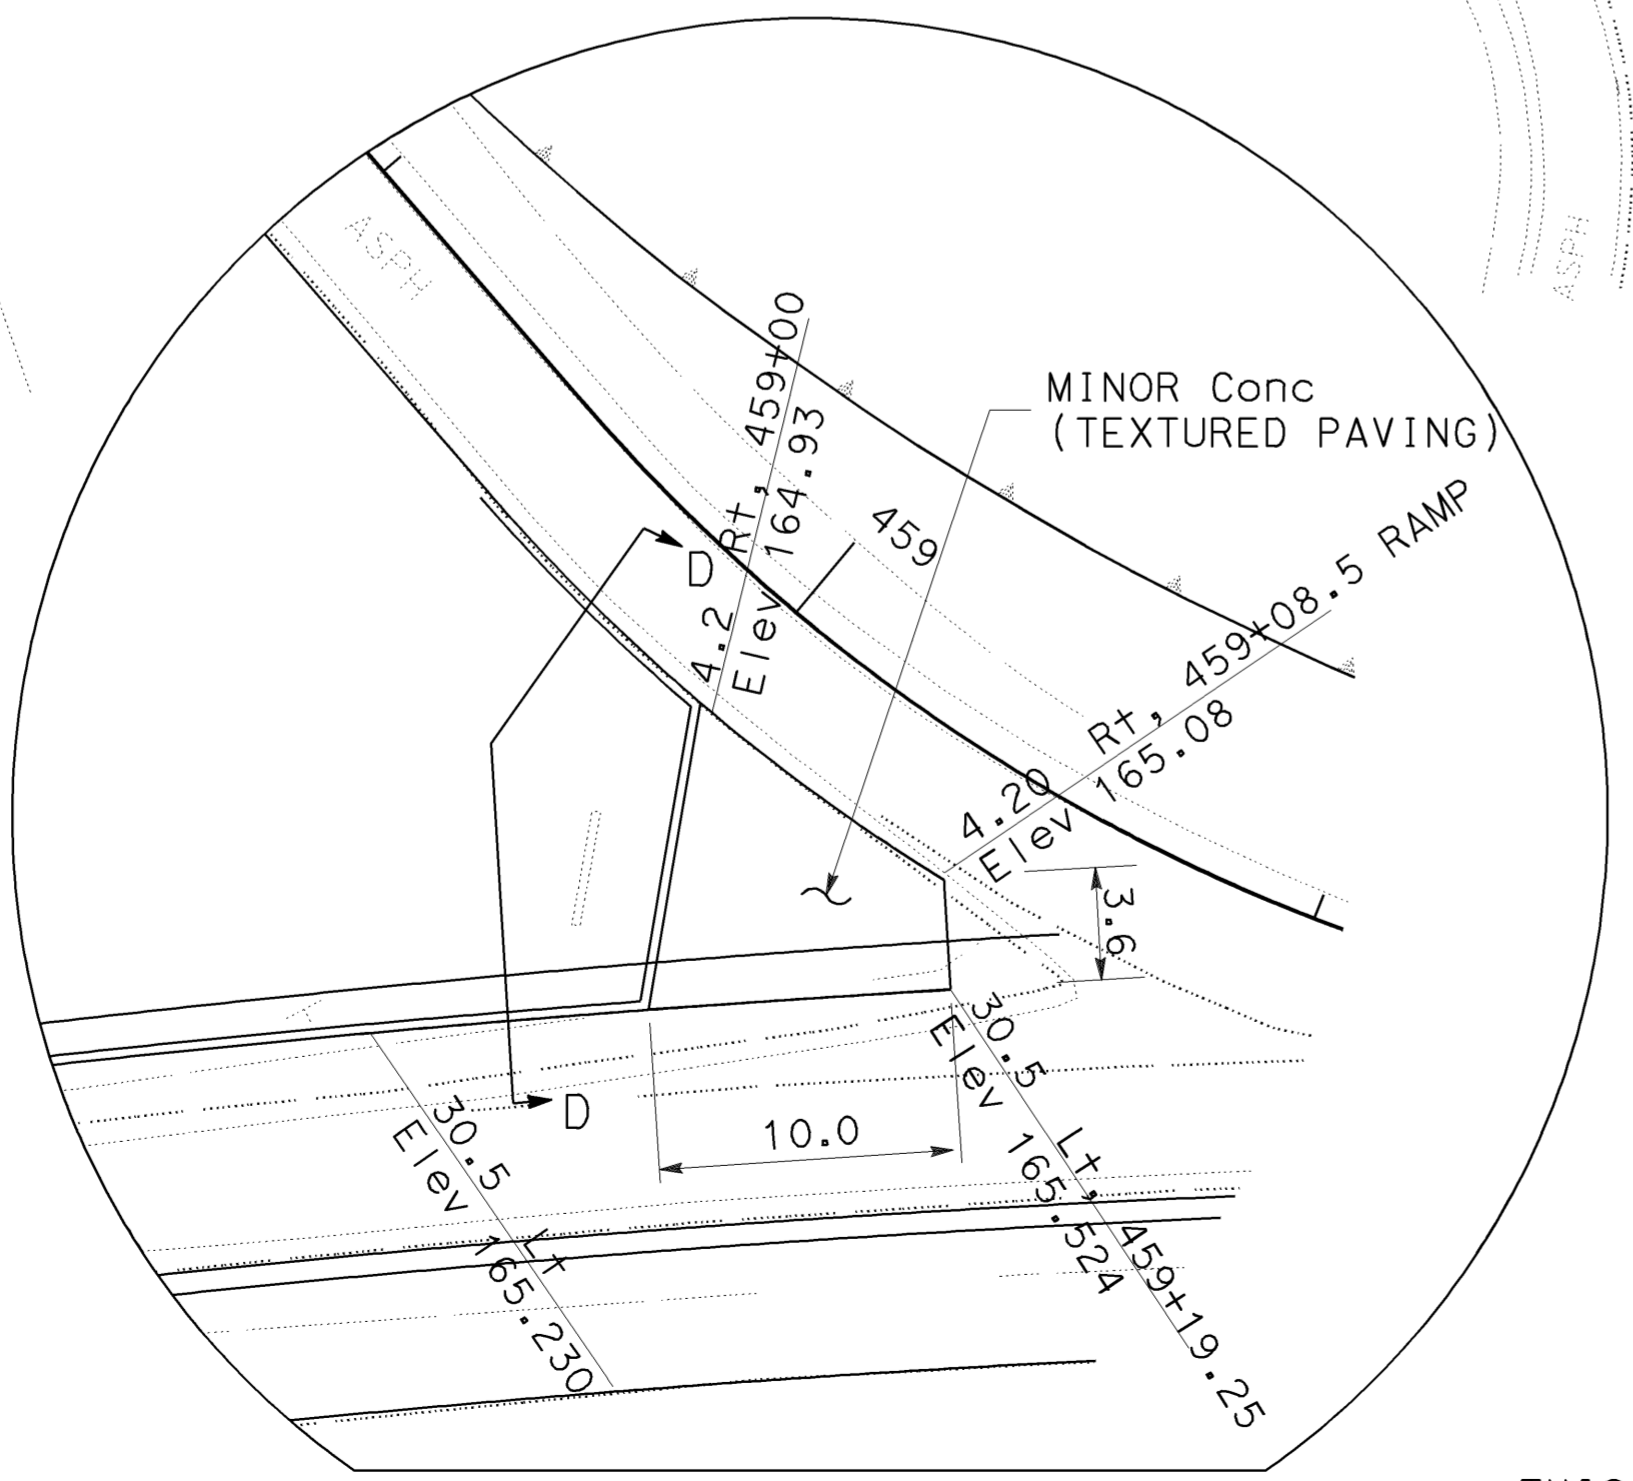


SECTION D-D
NO SCALE

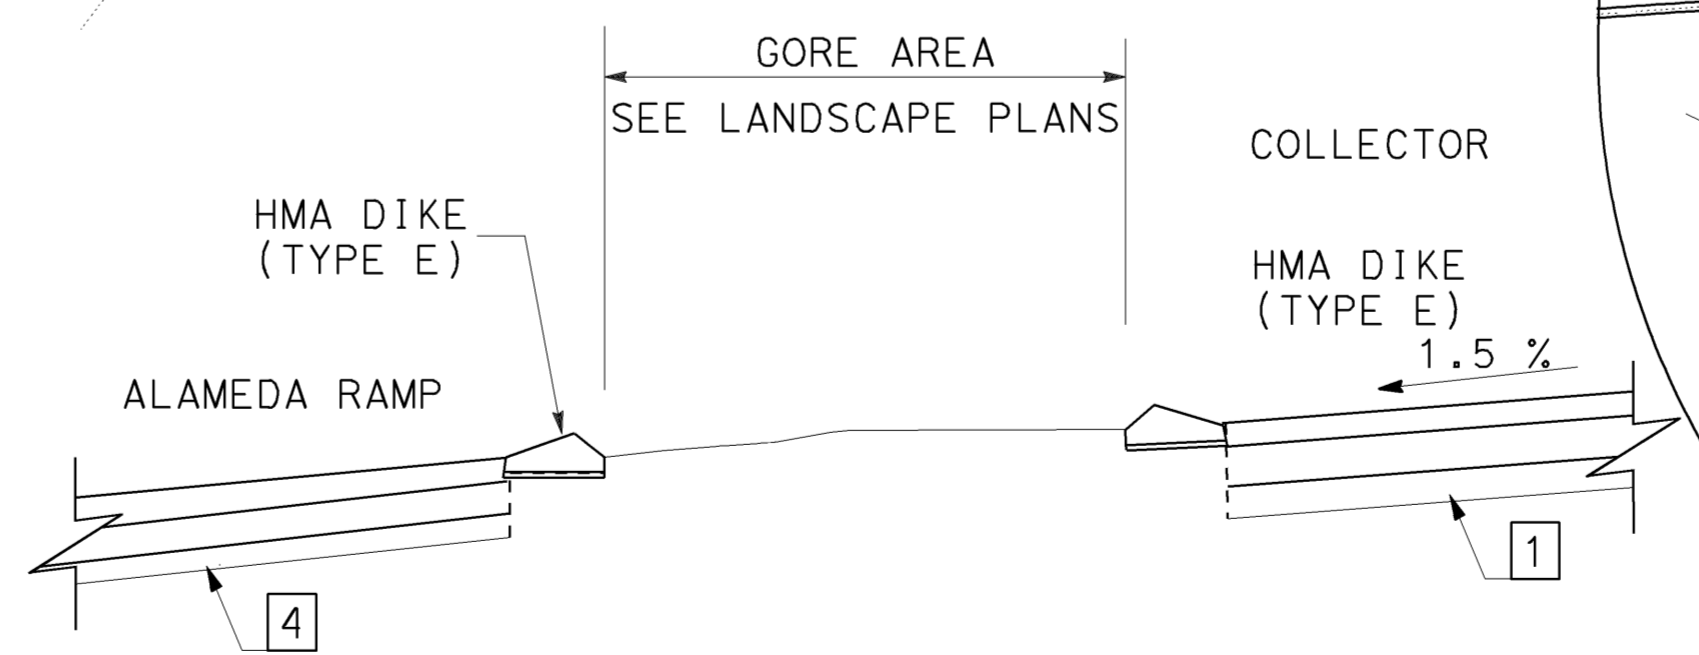

NOTE:
FOR SECTION B-B SEE SHEET C-11

THIS PLAN IS ACCURATE FOR GORE AREA ONLY.

DETAIL F
SCALE: 1:250

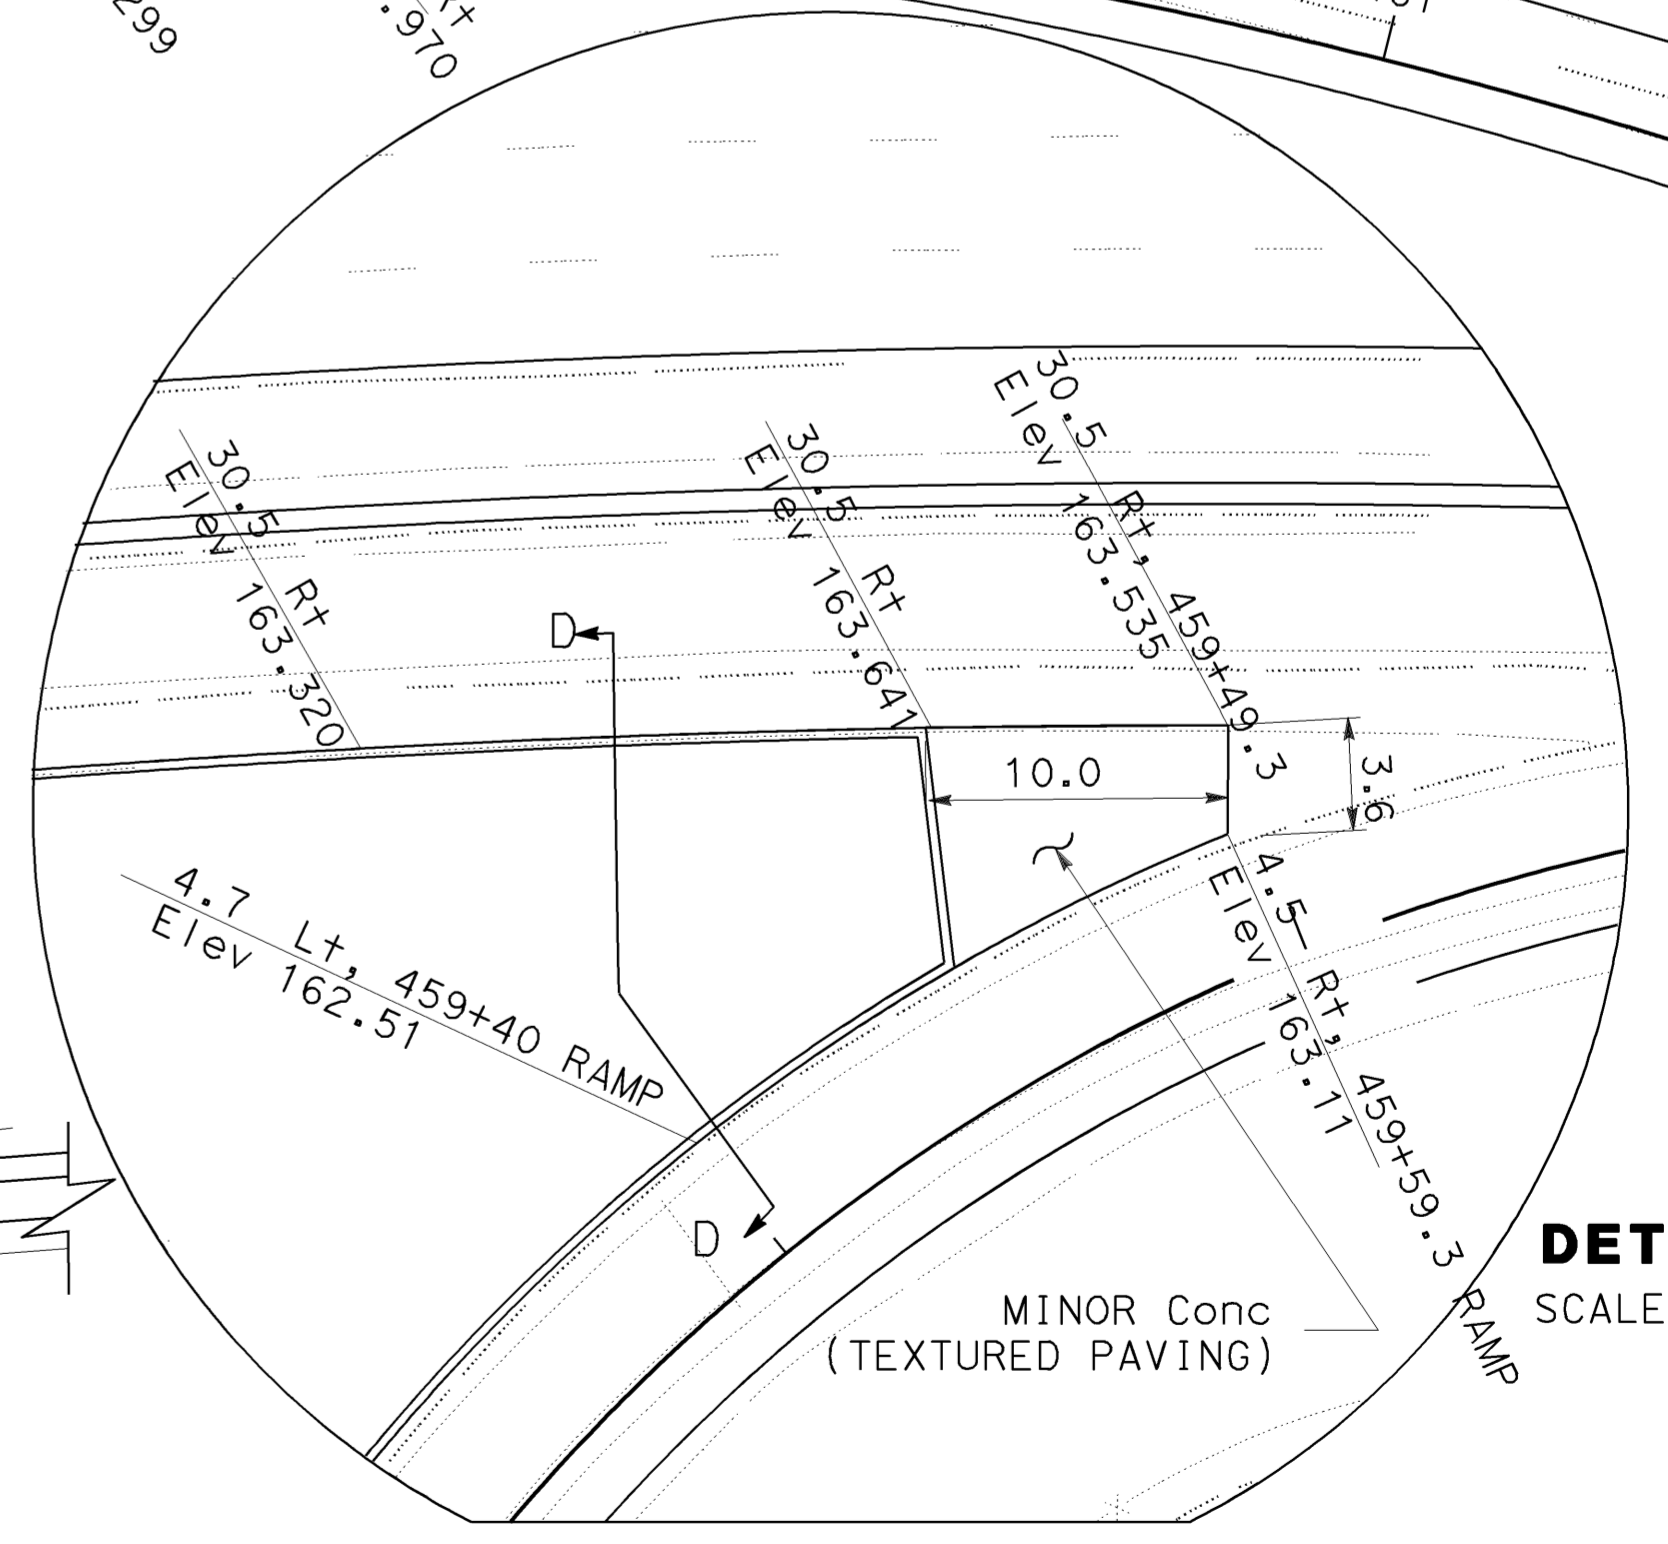

CONSTRUCTION DETAILS

SCALE 1:500

C-15

REVISOR
 CUONG T. TRAN

CHECKED BY
 MUNSHI MOHSIN

DESIGNED BY
 CELINA AVILES

FUNCTIONAL SUPERVISOR
 CELINA AVILES


DATE
 03-15-09

Dist	COUNTY	ROUTE	KILOMETER POST TOTAL PROJECT	SHEET No.	TOTAL SHEETS
07	LA	5	42.8/47.3	57	1073


2-24-09
 REGISTERED CIVIL ENGINEER DATE
 6-8-09
 PLANS APPROVAL DATE

MUNSHI MOHSIN
 No. 61916
 Exp. 9/30/09
 CIVIL
 STATE OF CALIFORNIA


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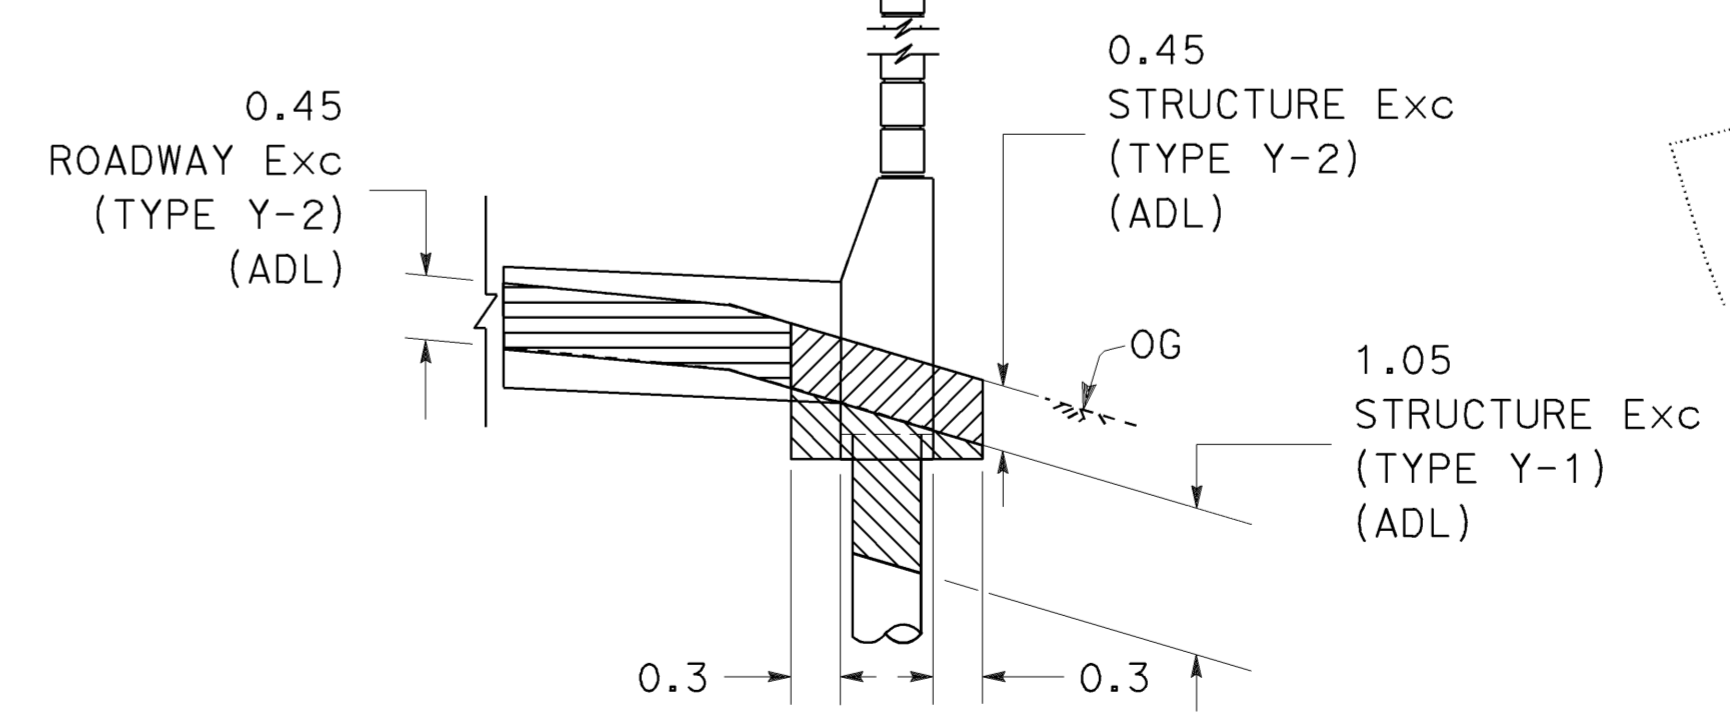
NOTE:
 1. FOR COMPLETE RIGHT OF WAY AND ACCURATE ACCESS DATA, SEE RIGHT OF WAY RECORD MAPS AT DISTRICT OFFICE.

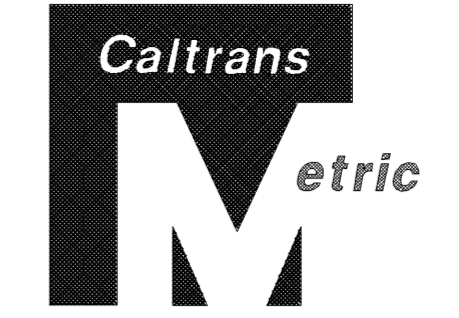

TYPICAL SECTION A-A
 NO SCALE
 SW STA 437+81.370 TO 440+53.723
 SW STA 442+17.742 TO 446+63.921
 SW STA 447+62.245 TO 447+96.139

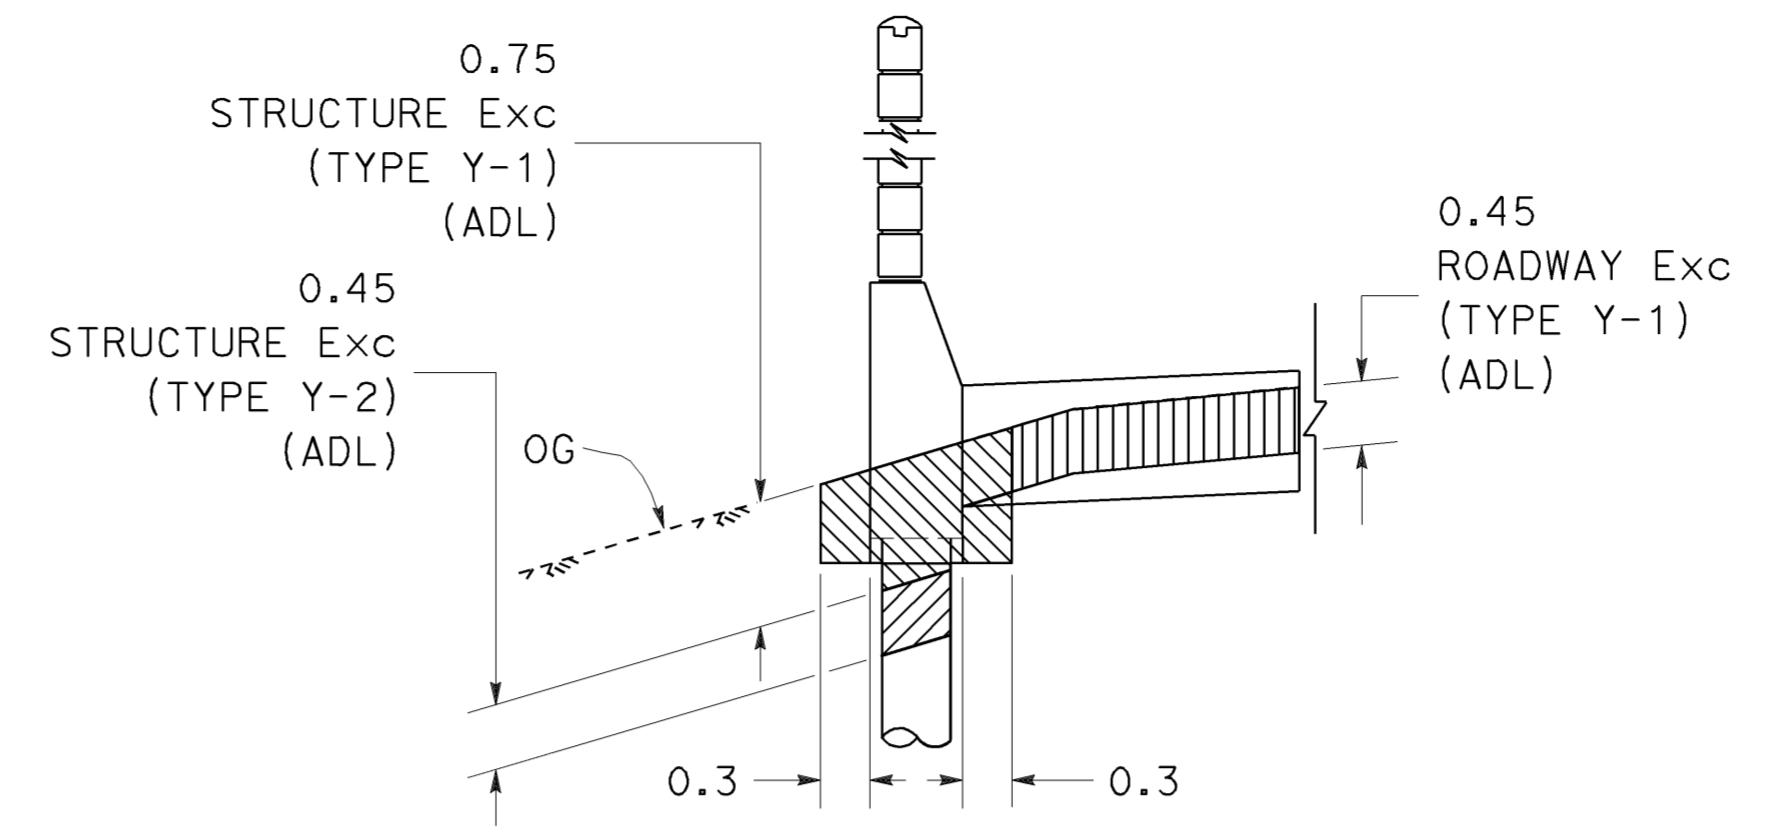

- LEGEND:**
- STRUCTURE Exc (TYPE Y-1) (AERIALY DEPOSITED LEAD) SHALL BE USED AS ROADWAY EMBANKMENT
 - STRUCTURE Exc (TYPE Y-2) (AERIALY DEPOSITED LEAD) SHALL BE USED AS ROADWAY EMBANKMENT
 - STRUCTURE Exc (TYPE Z-3) (AERIALY DEPOSITED LEAD)
 - ROADWAY Exc (TYPE Y-1) (AERIALY DEPOSITED LEAD)
 - ROADWAY Exc (TYPE Y-2) (AERIALY DEPOSITED LEAD)
 - ROADWAY Exc (TYPE Z-3) (AERIALY DEPOSITED LEAD)
 - ROADWAY EMBANKMENT (TYPE Y-1) (AERIALY DEPOSITED LEAD) AREA AVAILABLE FOR BACKFILLING MATERIAL WITH AERIALY DEPOSITED LEAD
 - ROADWAY EMBANKMENT (TYPE Y-2) (AERIALY DEPOSITED LEAD) AREA AVAILABLE FOR BACKFILLING MATERIAL WITH AERIALY DEPOSITED LEAD
- ABBREVIATION:**
 ADL - AERIALY DEPOSITED LEAD

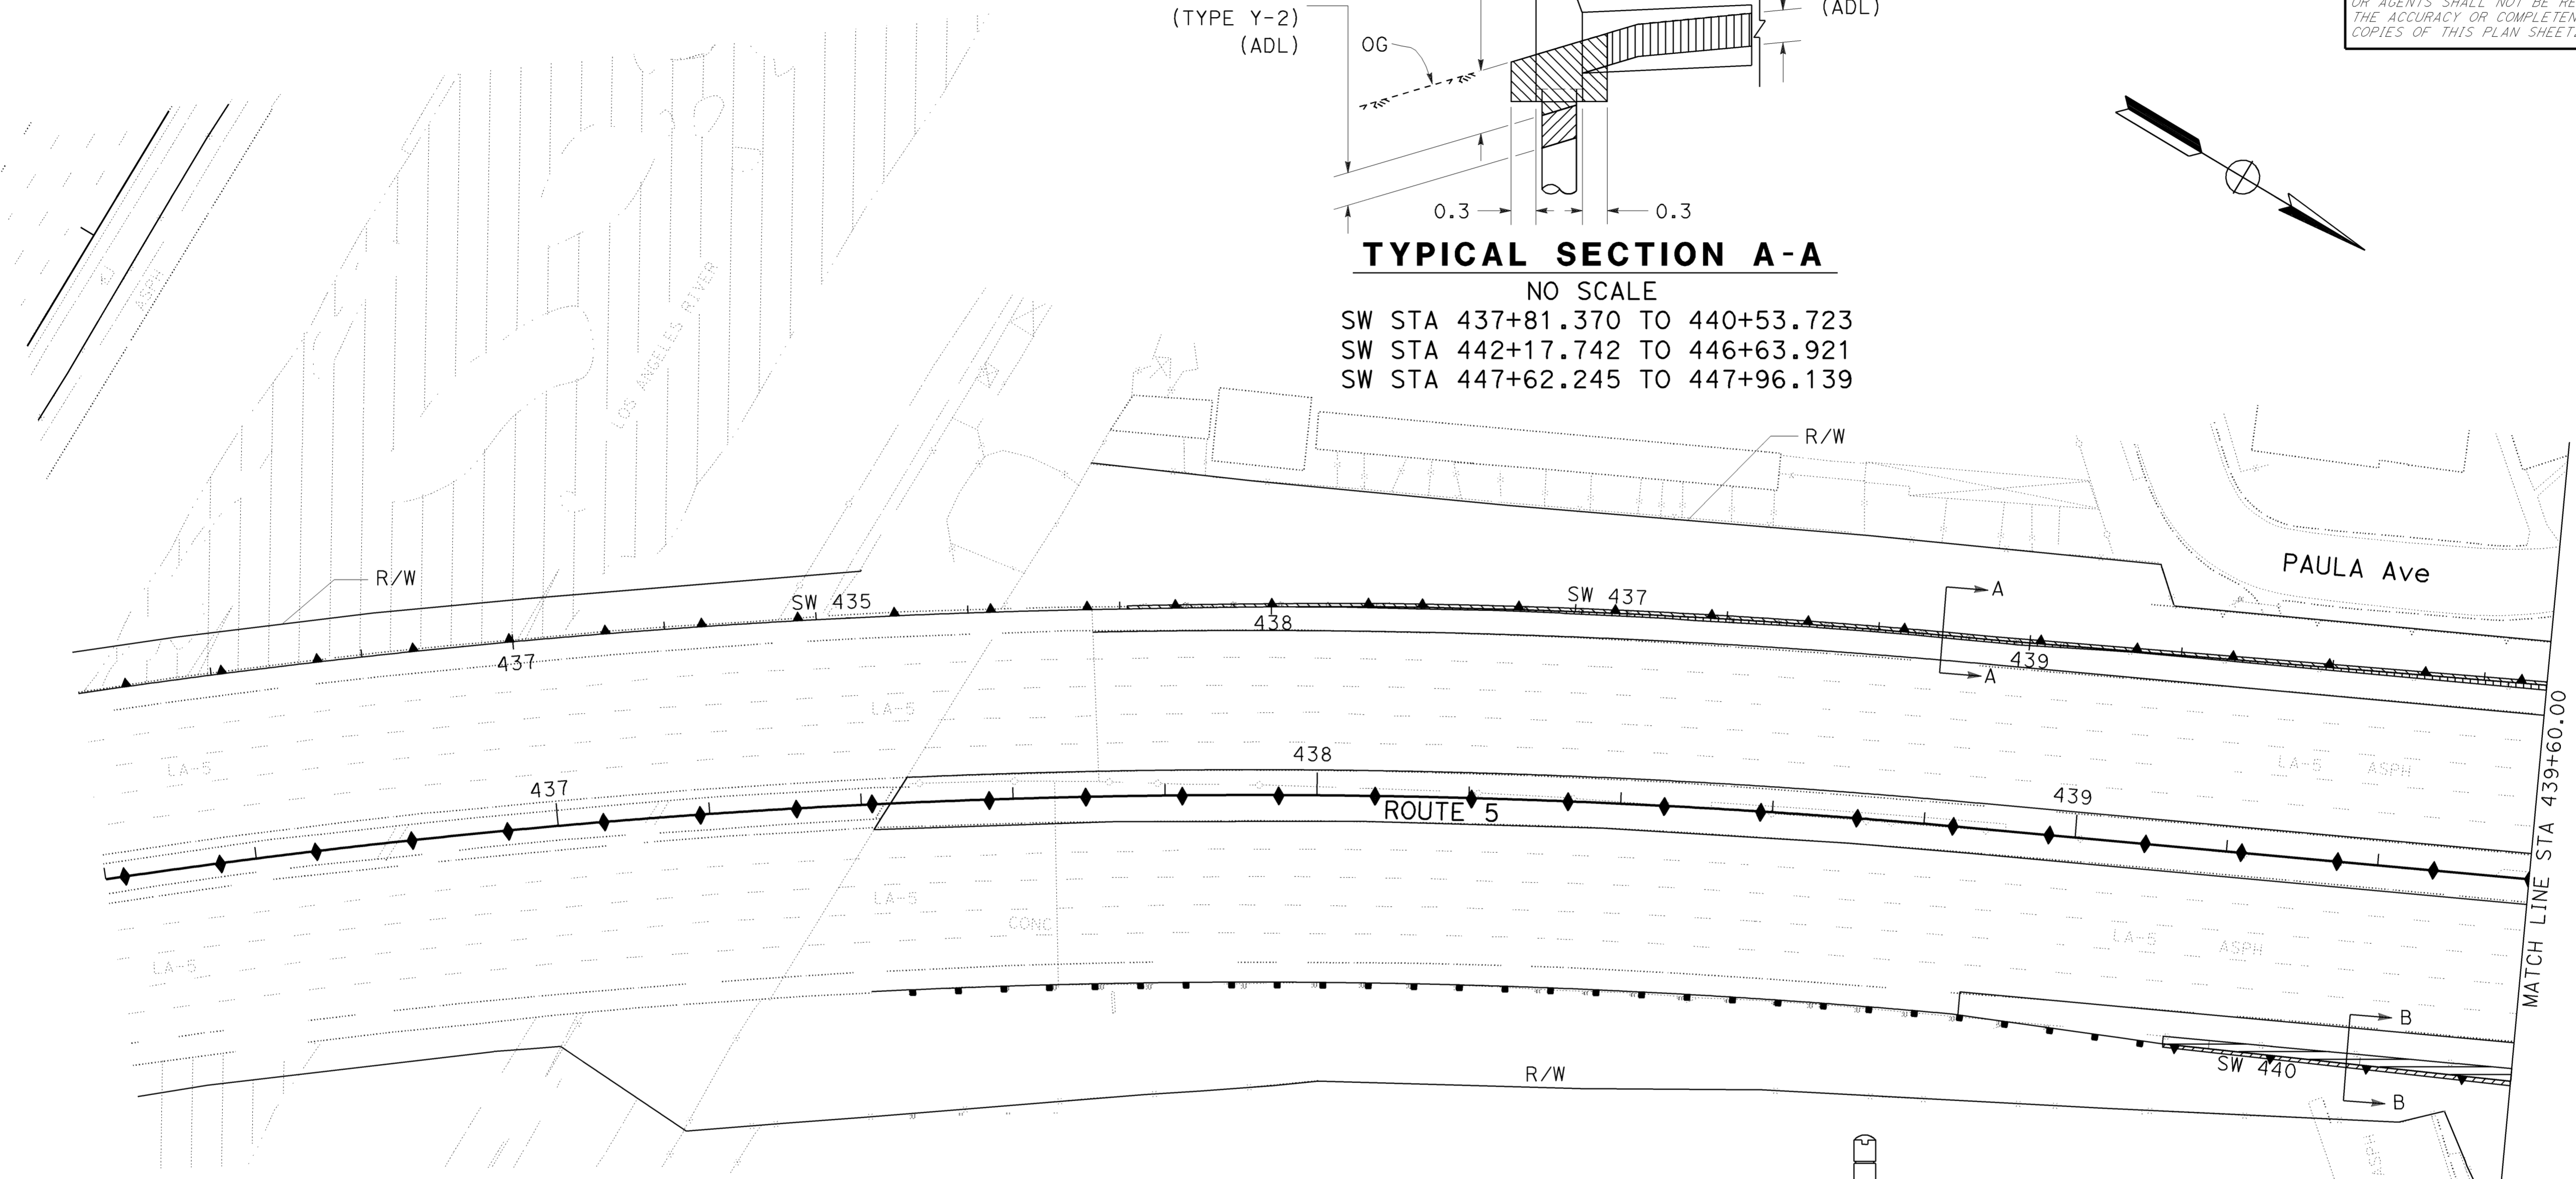

TYPICAL SECTION B-B
 NO SCALE
 SW STA 439+13.995 TO 440+00.504
 SW STA 441+21.980 TO 443+04.008

ALL DIMENSIONS ARE IN METERS UNLESS OTHERWISE SHOWN
CONSTRUCTION DETAILS
LOCATIONS OF EXCAVATION
 SCALE 1:500

THIS PLAN IS ACCURATE FOR AERIALY DEPOSITED LEAD EXCAVATION AND EMBANKMENT WORK ONLY.

STATE OF CALIFORNIA - DEPARTMENT OF TRANSPORTATION
Caltrans OFFICE OF DESIGN D

FUNCTIONAL SUPERVISOR
CELINA AVILES

CALCULATED-DESIGNED BY
 CHECKED BY

CUONG T. TRAN
 MUNSHI MOHSIN

REVISED BY
 DATE REVISED



NOTE:

1. FOR COMPLETE RIGHT OF WAY AND ACCURATE ACCESS DATA,
 SEE RIGHT OF WAY RECORD MAPS AT DISTRICT OFFICE.



Dist	COUNTY	ROUTE	KILOMETER POST TOTAL PROJECT	SHEET No.	TOTAL SHEETS
07	LA	5	42.8/47.3	58	1073

REGISTERED CIVIL ENGINEER DATE 2-24-09
 PLANS APPROVAL DATE 6-8-09
 REGISTERED PROFESSIONAL ENGINEER
 MUNSHI MOHSIN
 No. 61916
 Exp. 9/30/09
 CIVIL
 STATE OF CALIFORNIA
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CONSTRUCTION DETAILS
LOCATIONS OF EXCAVATION

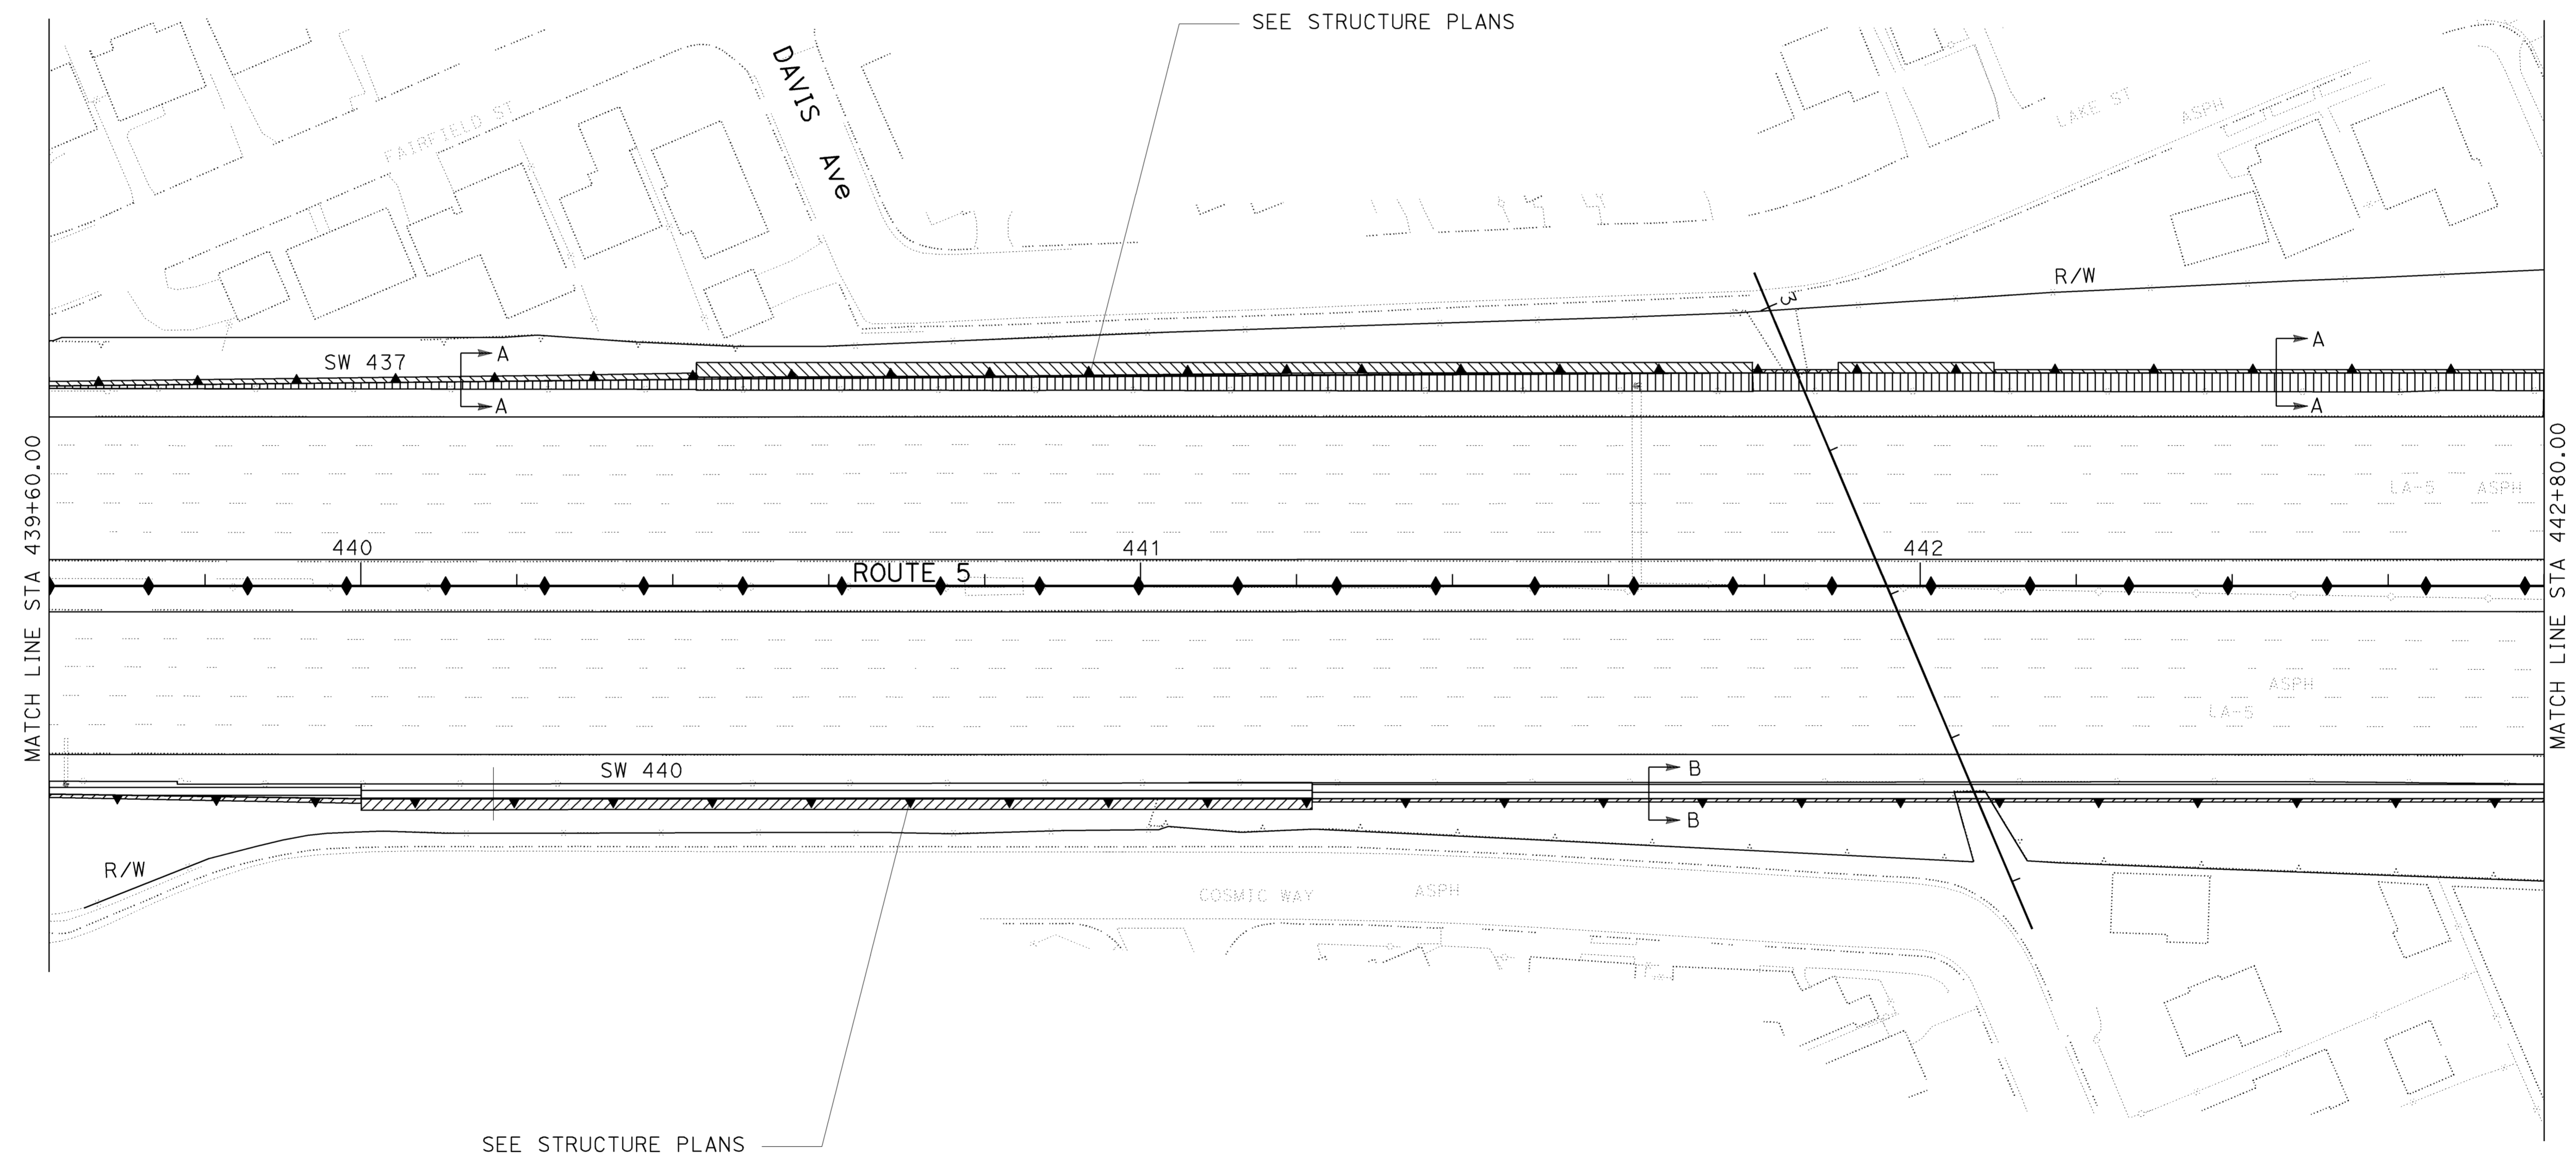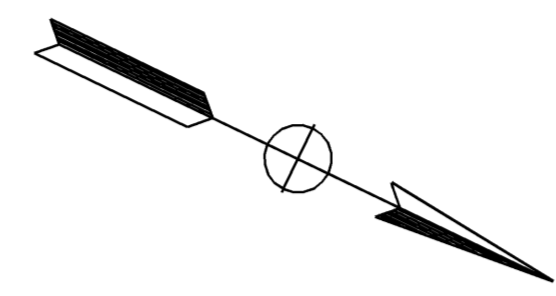SCALE 1:500

C-17

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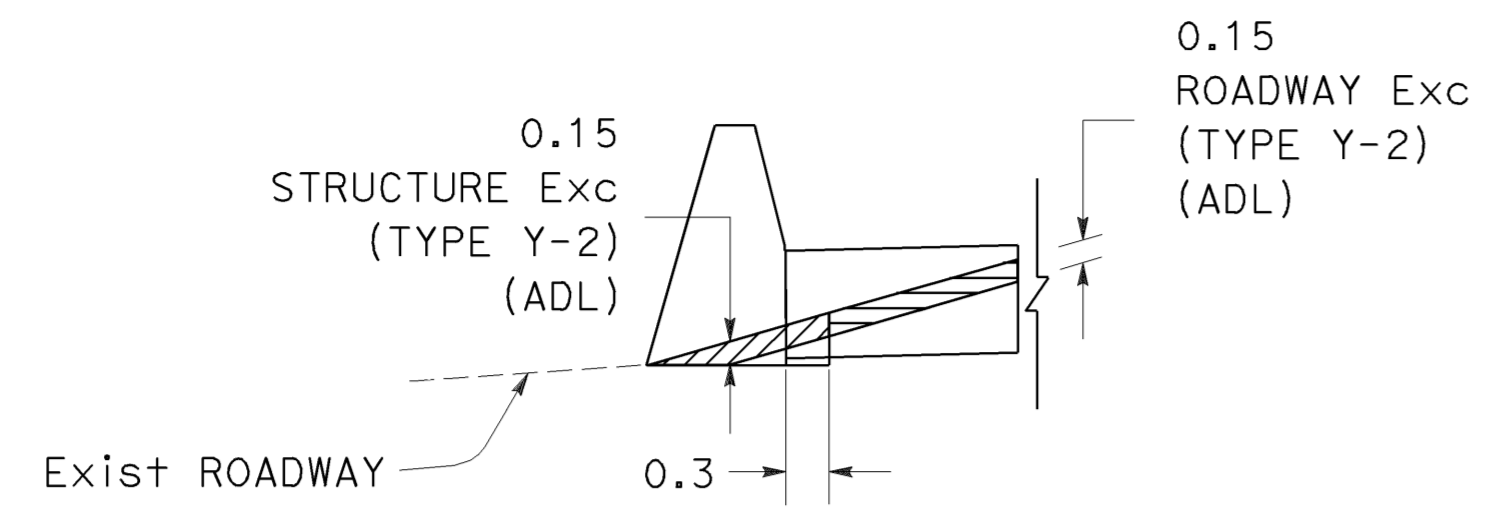


Dist	COUNTY	ROUTE	KILOMETER POST TOTAL PROJECT	SHEET No.	TOTAL SHEETS
07	LA	5	42.8/47.3	59	1073


2-24-09
 REGISTERED CIVIL ENGINEER DATE
 6-8-09
 PLANS APPROVAL DATE

REGISTERED PROFESSIONAL ENGINEER
 MUNSHI MOHSIN
 No. 61916
 Exp. 9/30/09
 CIVIL
 STATE OF CALIFORNIA



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TYPICAL SECTION F-F
 NO SCALE
 STA 445+47.000 TO 447+37.439
 STA 448+57.779 TO 450+94.765



TYPICAL SECTION F1-F1
 NO SCALE
 STA 447+37.439 TO 448+57.779

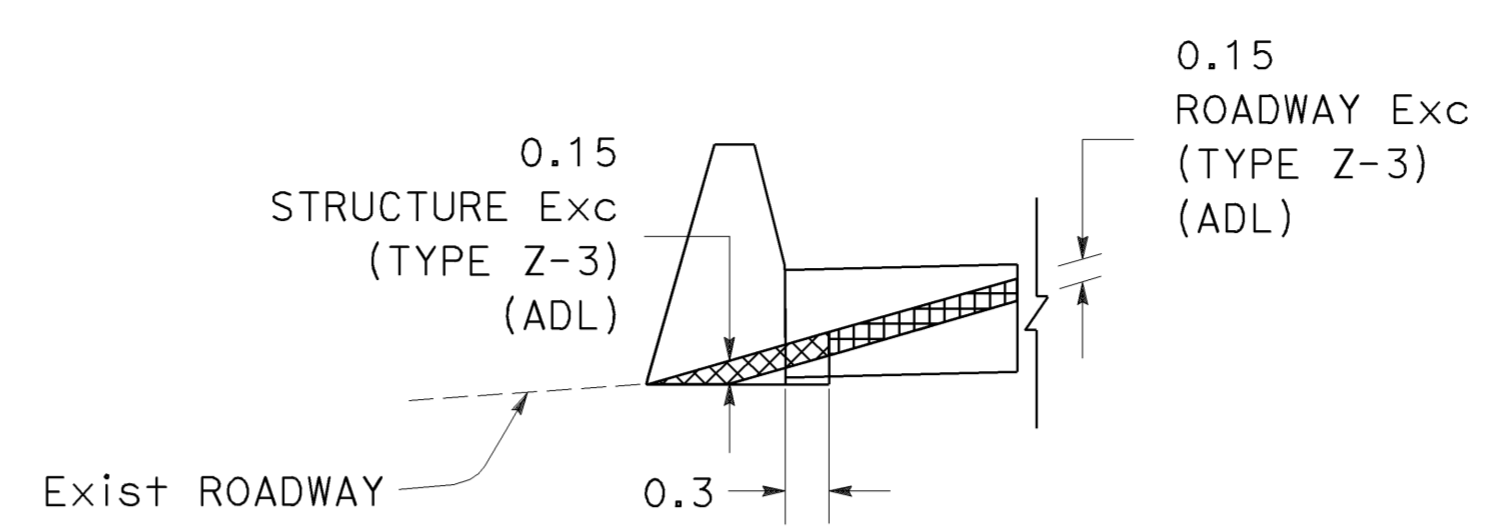

TYPICAL SECTION E-E
 NO SCALE
 STA 445+15.000 TO 447+87.680

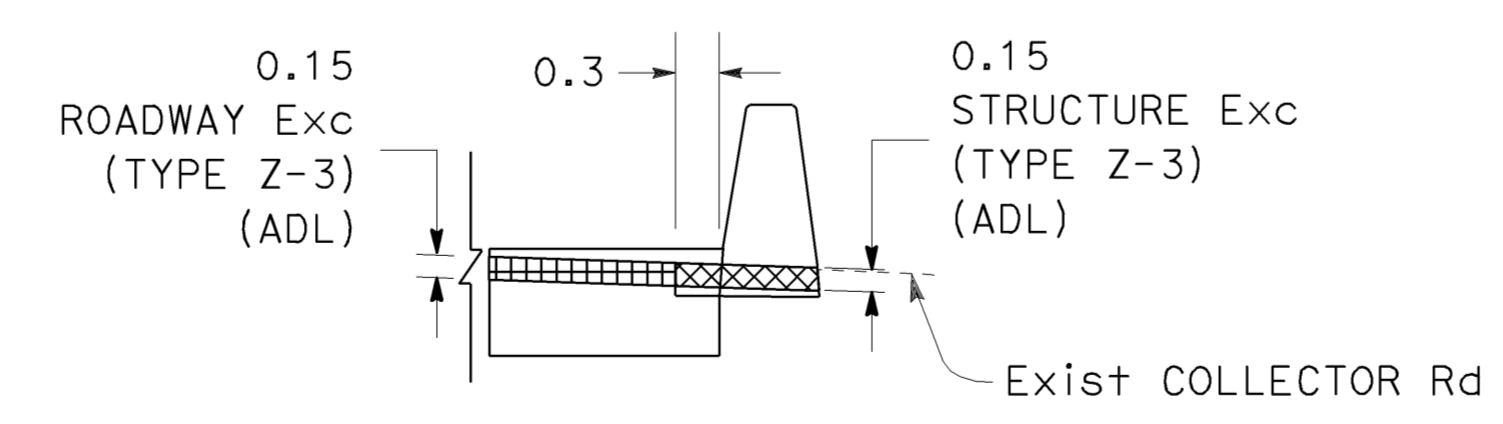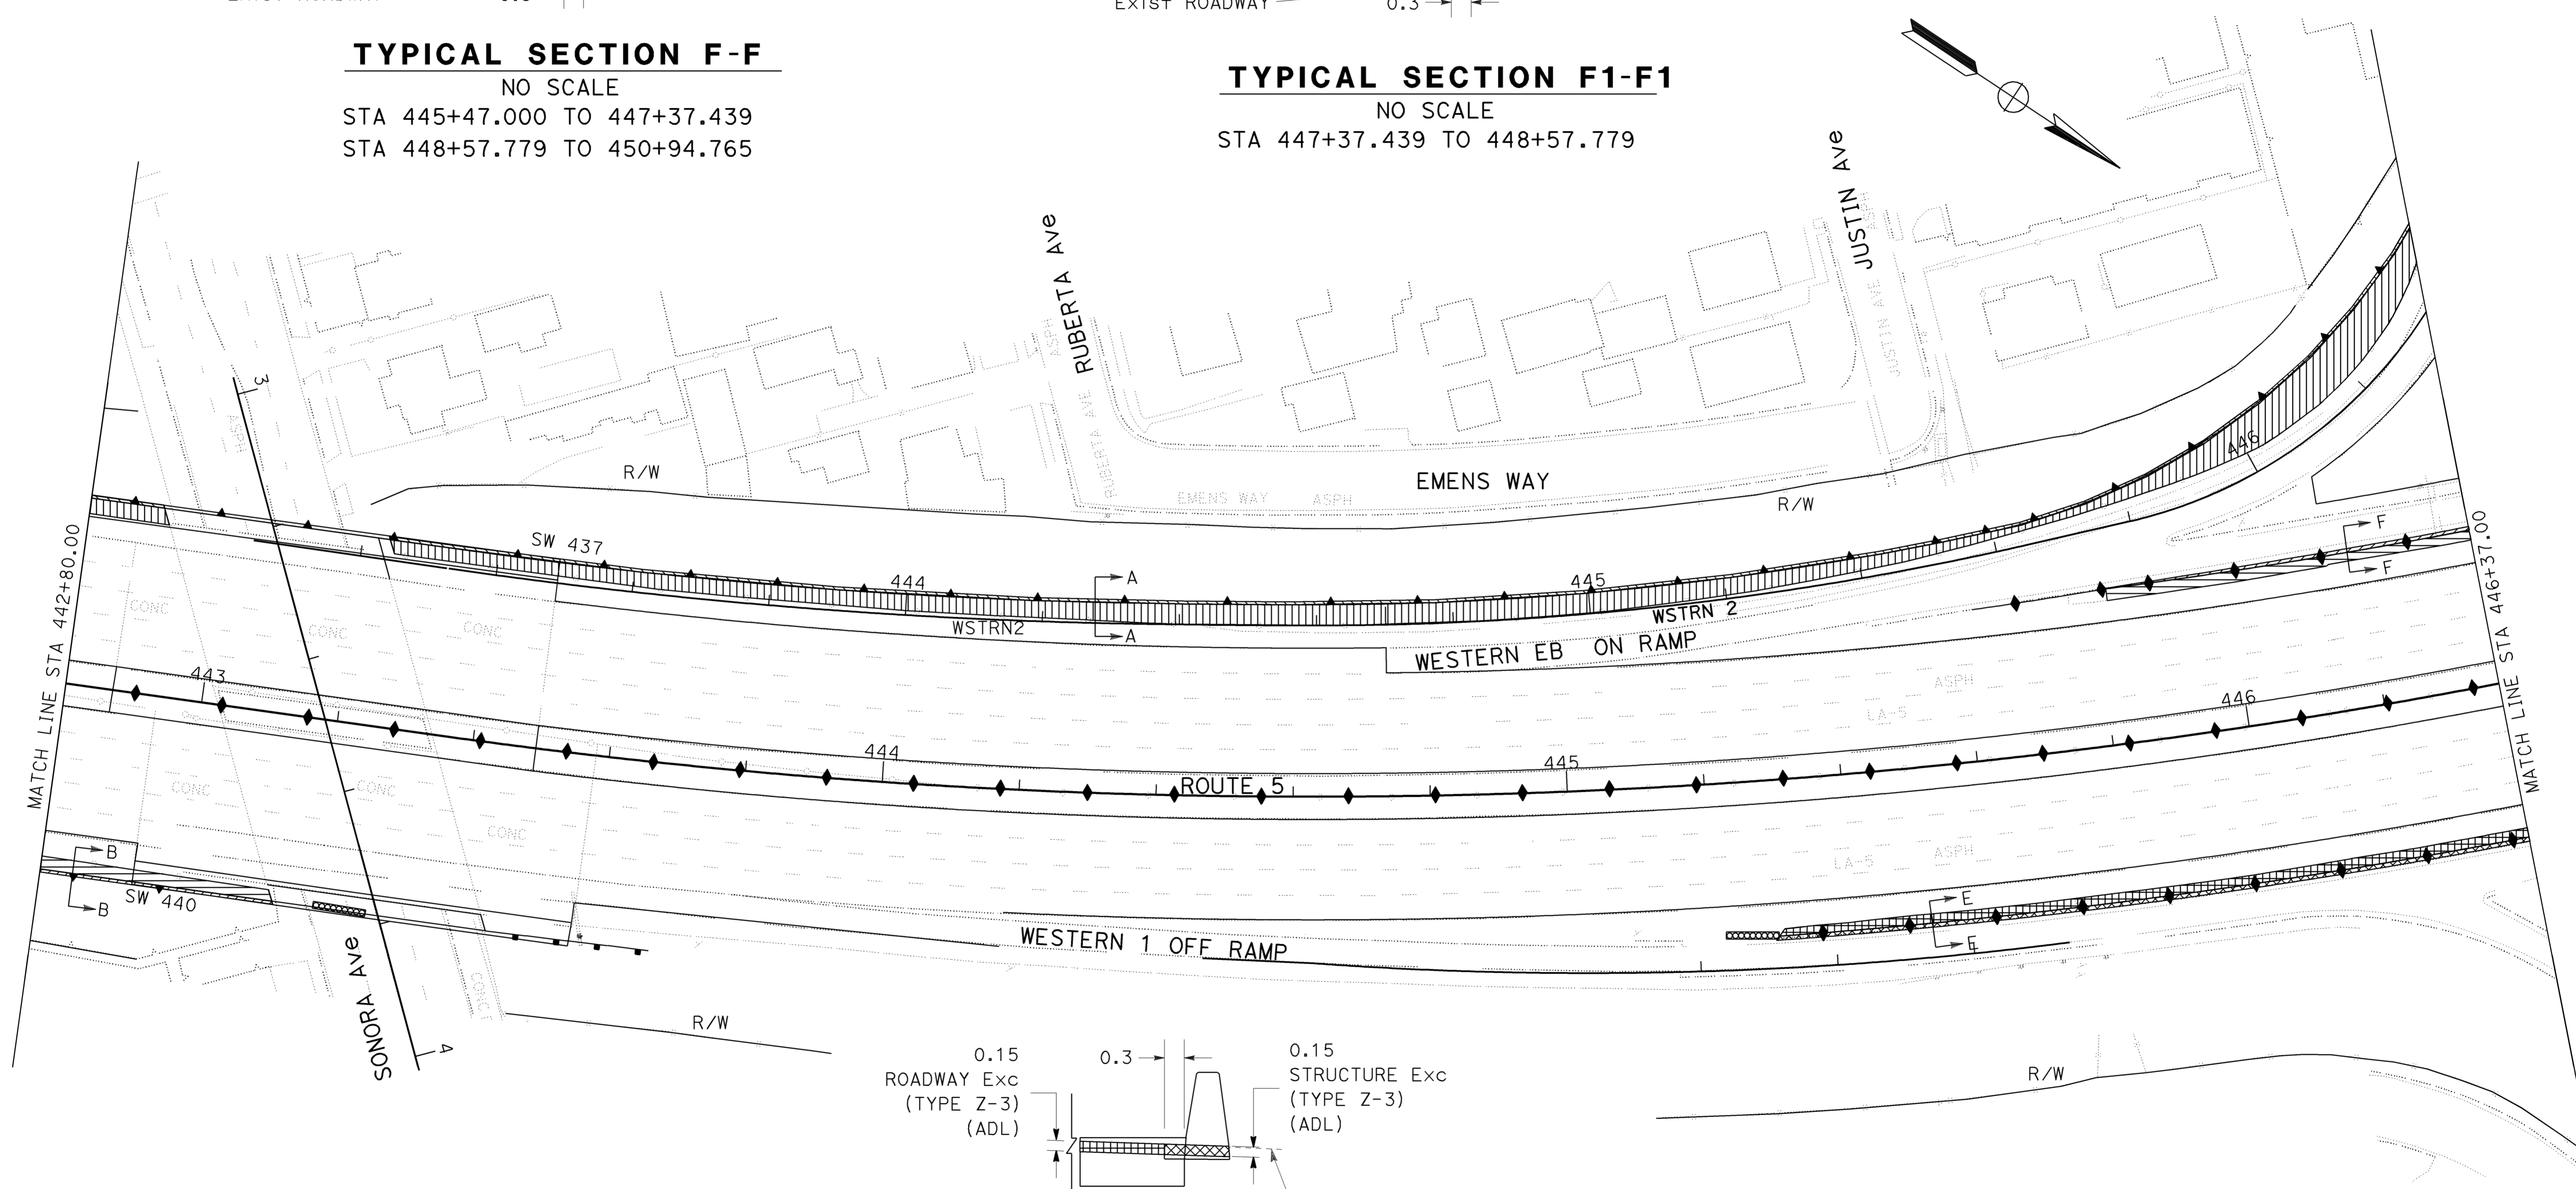NOTE:
 1. FOR COMPLETE RIGHT OF WAY AND ACCURATE ACCESS DATA, SEE RIGHT OF WAY RECORD MAPS AT DISTRICT OFFICE.

ALL DIMENSIONS ARE IN METERS UNLESS OTHERWISE SHOWN
CONSTRUCTION DETAILS
LOCATIONS OF EXCAVATION

SCALE 1:500

C-18

THIS PLAN IS ACCURATE FOR AERIALY DEPOSITED LEAD EXCAVATION AND EMBANKMENT WORK ONLY.


FUNCTIONAL SUPERVISOR
 CELINA AVILES

CALCULATED-DESIGNED BY
 CHECKED BY

CUONG T. TRAN
 MUNSHI MOHSIN

REVISED BY
 DATE REVISED

SEE STRUCTURE PLANS

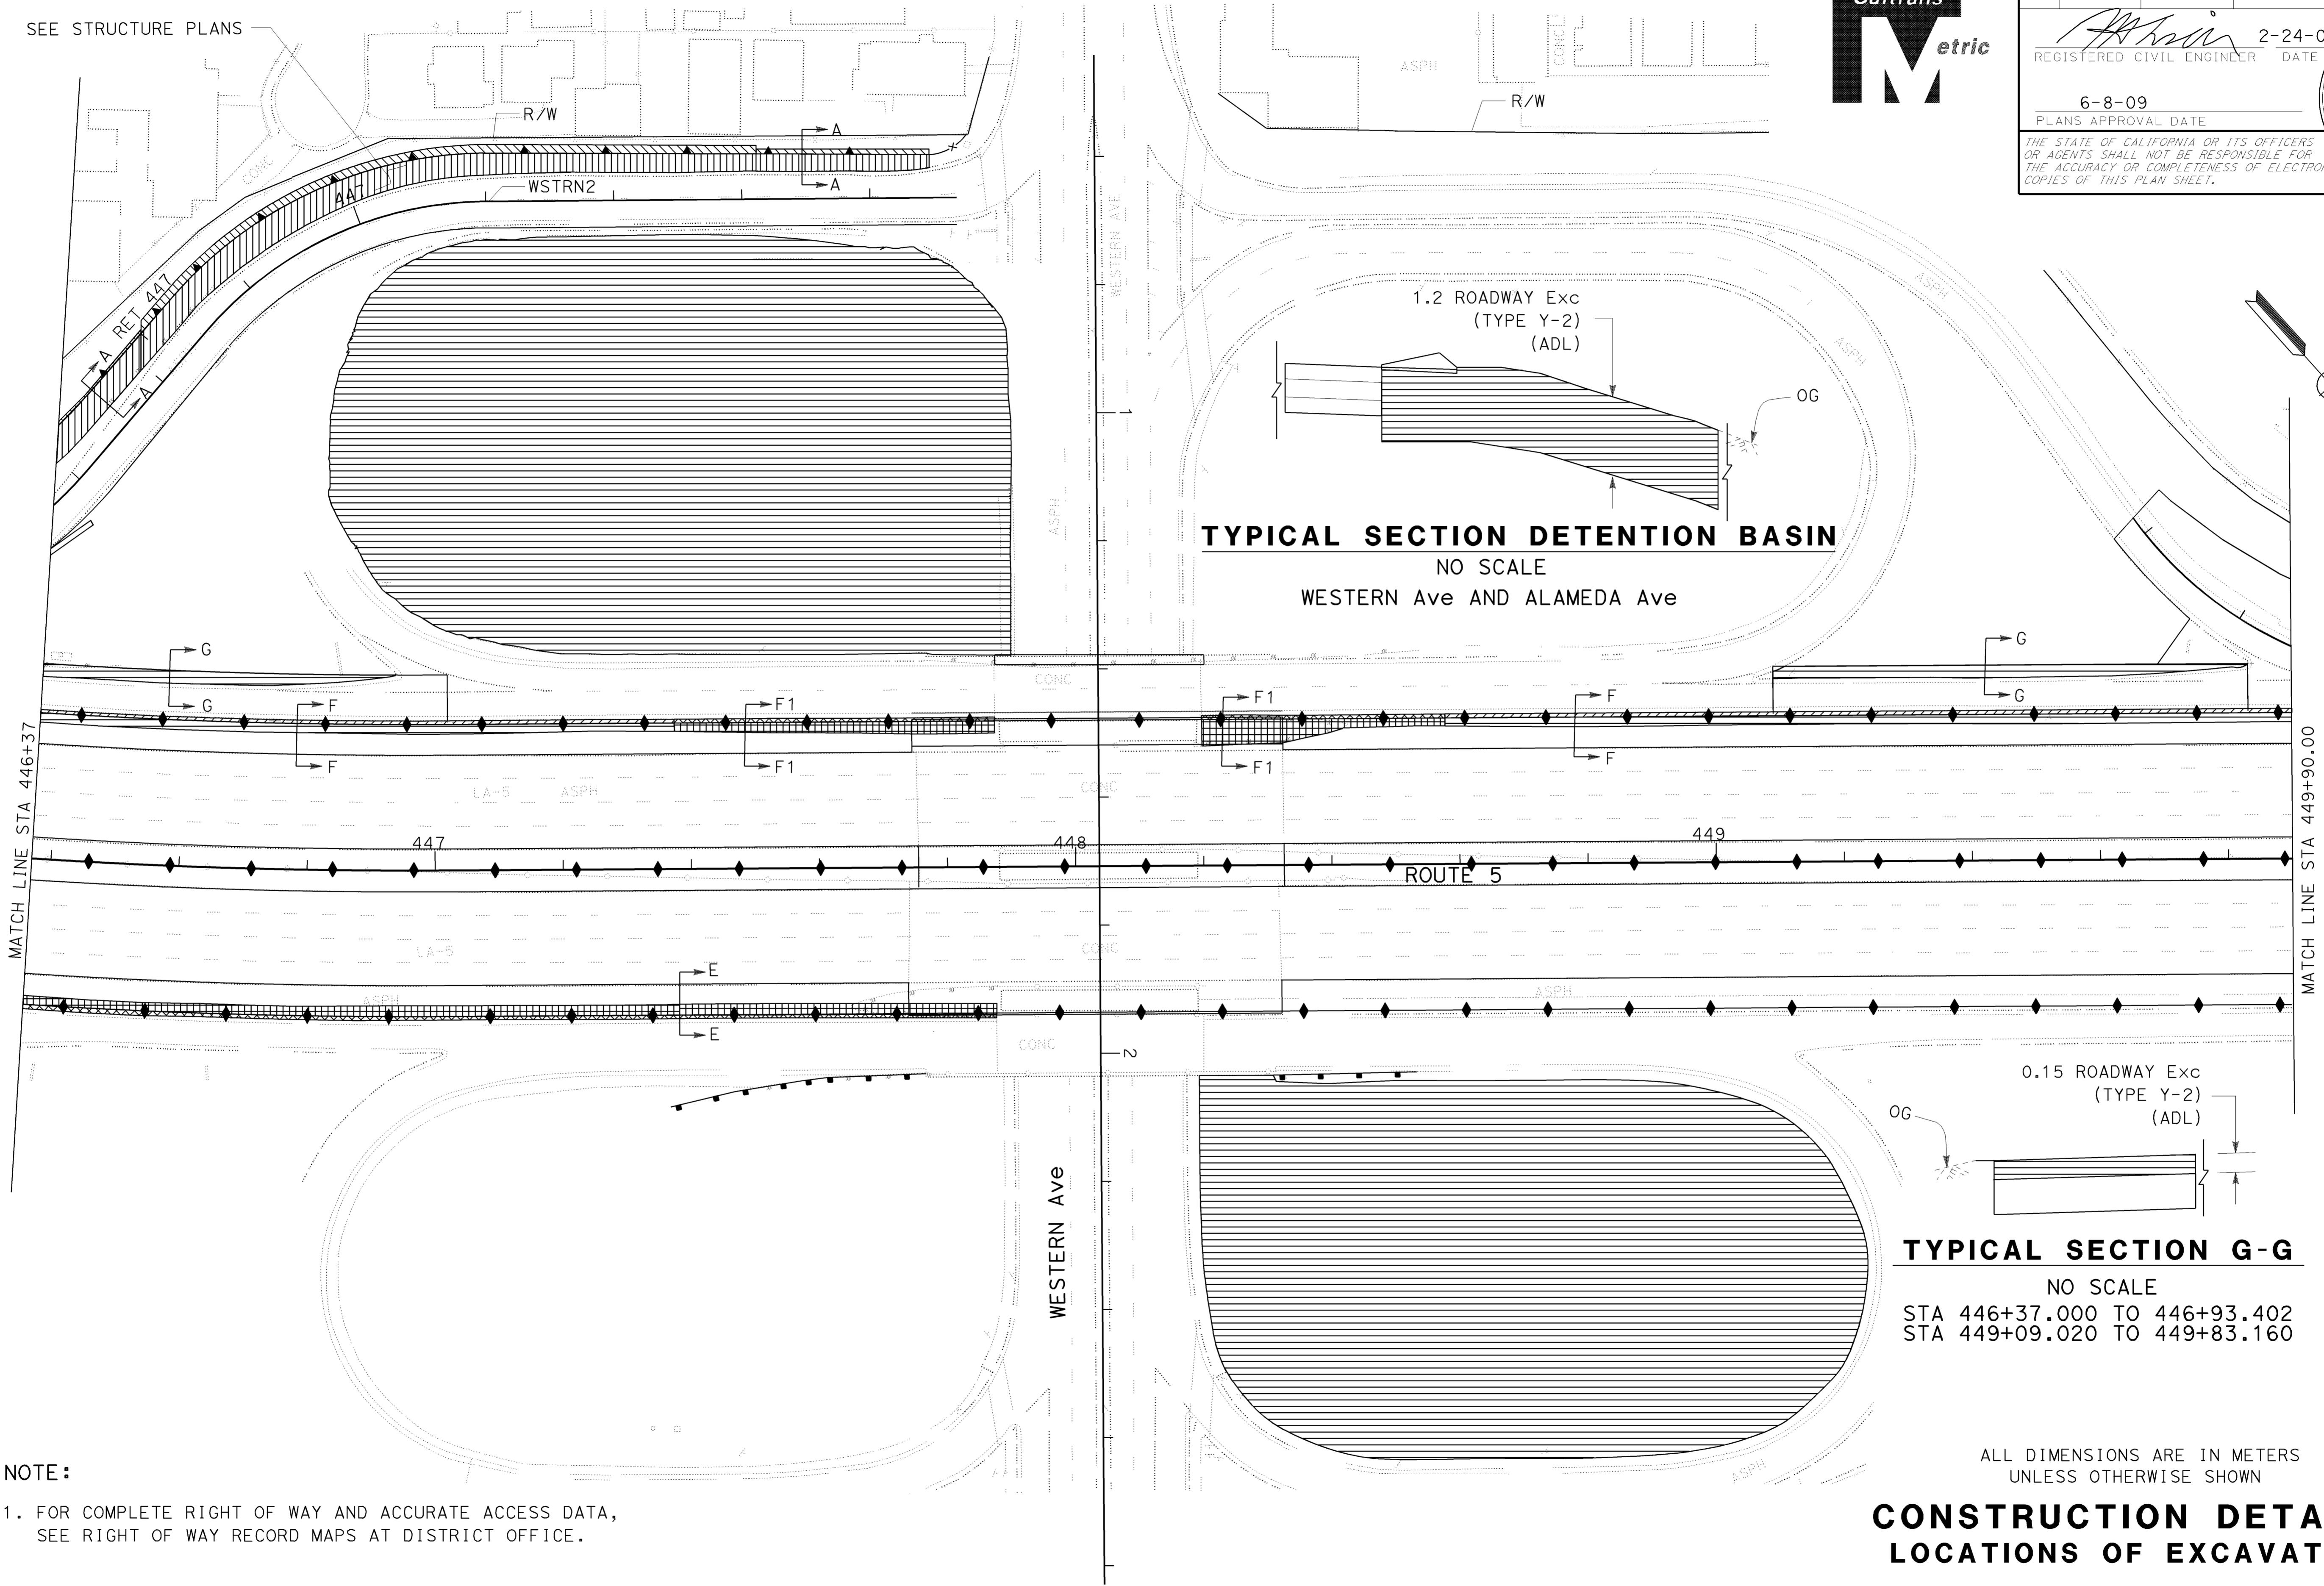

TYPICAL SECTION DETENTION BASIN
 NO SCALE
 WESTERN Ave AND ALAMEDA Ave

TYPICAL SECTION G-G
 NO SCALE
 STA 446+37.000 TO 446+93.402
 STA 449+09.020 TO 449+83.160

NOTE:
 1. FOR COMPLETE RIGHT OF WAY AND ACCURATE ACCESS DATA,
 SEE RIGHT OF WAY RECORD MAPS AT DISTRICT OFFICE.

ALL DIMENSIONS ARE IN METERS
 UNLESS OTHERWISE SHOWN
CONSTRUCTION DETAILS
LOCATIONS OF EXCAVATION

SCALE 1:500

C-19

THIS PLAN IS ACCURATE FOR AERIALY DEPOSITED LEAD EXCAVATION AND EMBANKMENT WORK ONLY.



Dist	COUNTY	ROUTE	KILOMETER POST TOTAL PROJECT	SHEET No.	TOTAL SHEETS
07	LA	5	42.8/47.3	60	1073

2-24-09
 REGISTERED CIVIL ENGINEER DATE
 6-8-09
 PLANS APPROVAL DATE

MUNSHI MOHSIN
 No. 61916
 Exp. 9/30/09
 CIVIL
 STATE OF CALIFORNIA

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FUNCTIONAL SUPERVISOR
 CELINA AVILES

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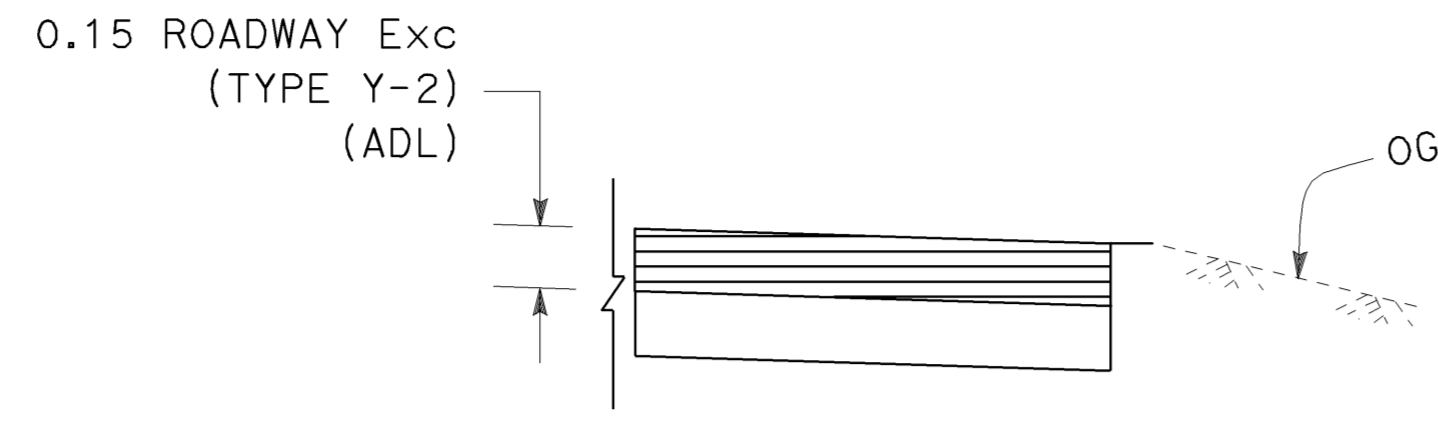
CUONG T TRAN
 MUNSHI MOHSIN

REVISED BY
 DATE REVISED





Dist	COUNTY	ROUTE	KILOMETER POST TOTAL PROJECT	SHEET No.	TOTAL SHEETS
07	LA	5	42.8/47.3	61	1073

REGISTERED CIVIL ENGINEER DATE 2-24-09
 PLANS APPROVAL DATE 6-8-09
 REGISTERED PROFESSIONAL ENGINEER
 MUNSHI MOHSIN
 No. 61916
 Exp. 9/30/09
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 STATE OF CALIFORNIA
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TYPICAL SECTION H-H
 NO SCALE
 STA 450+81.300 TO 452+15.499



NOTE:
 1. FOR COMPLETE RIGHT OF WAY AND ACCURATE ACCESS DATA, SEE RIGHT OF WAY RECORD MAPS AT DISTRICT OFFICE.

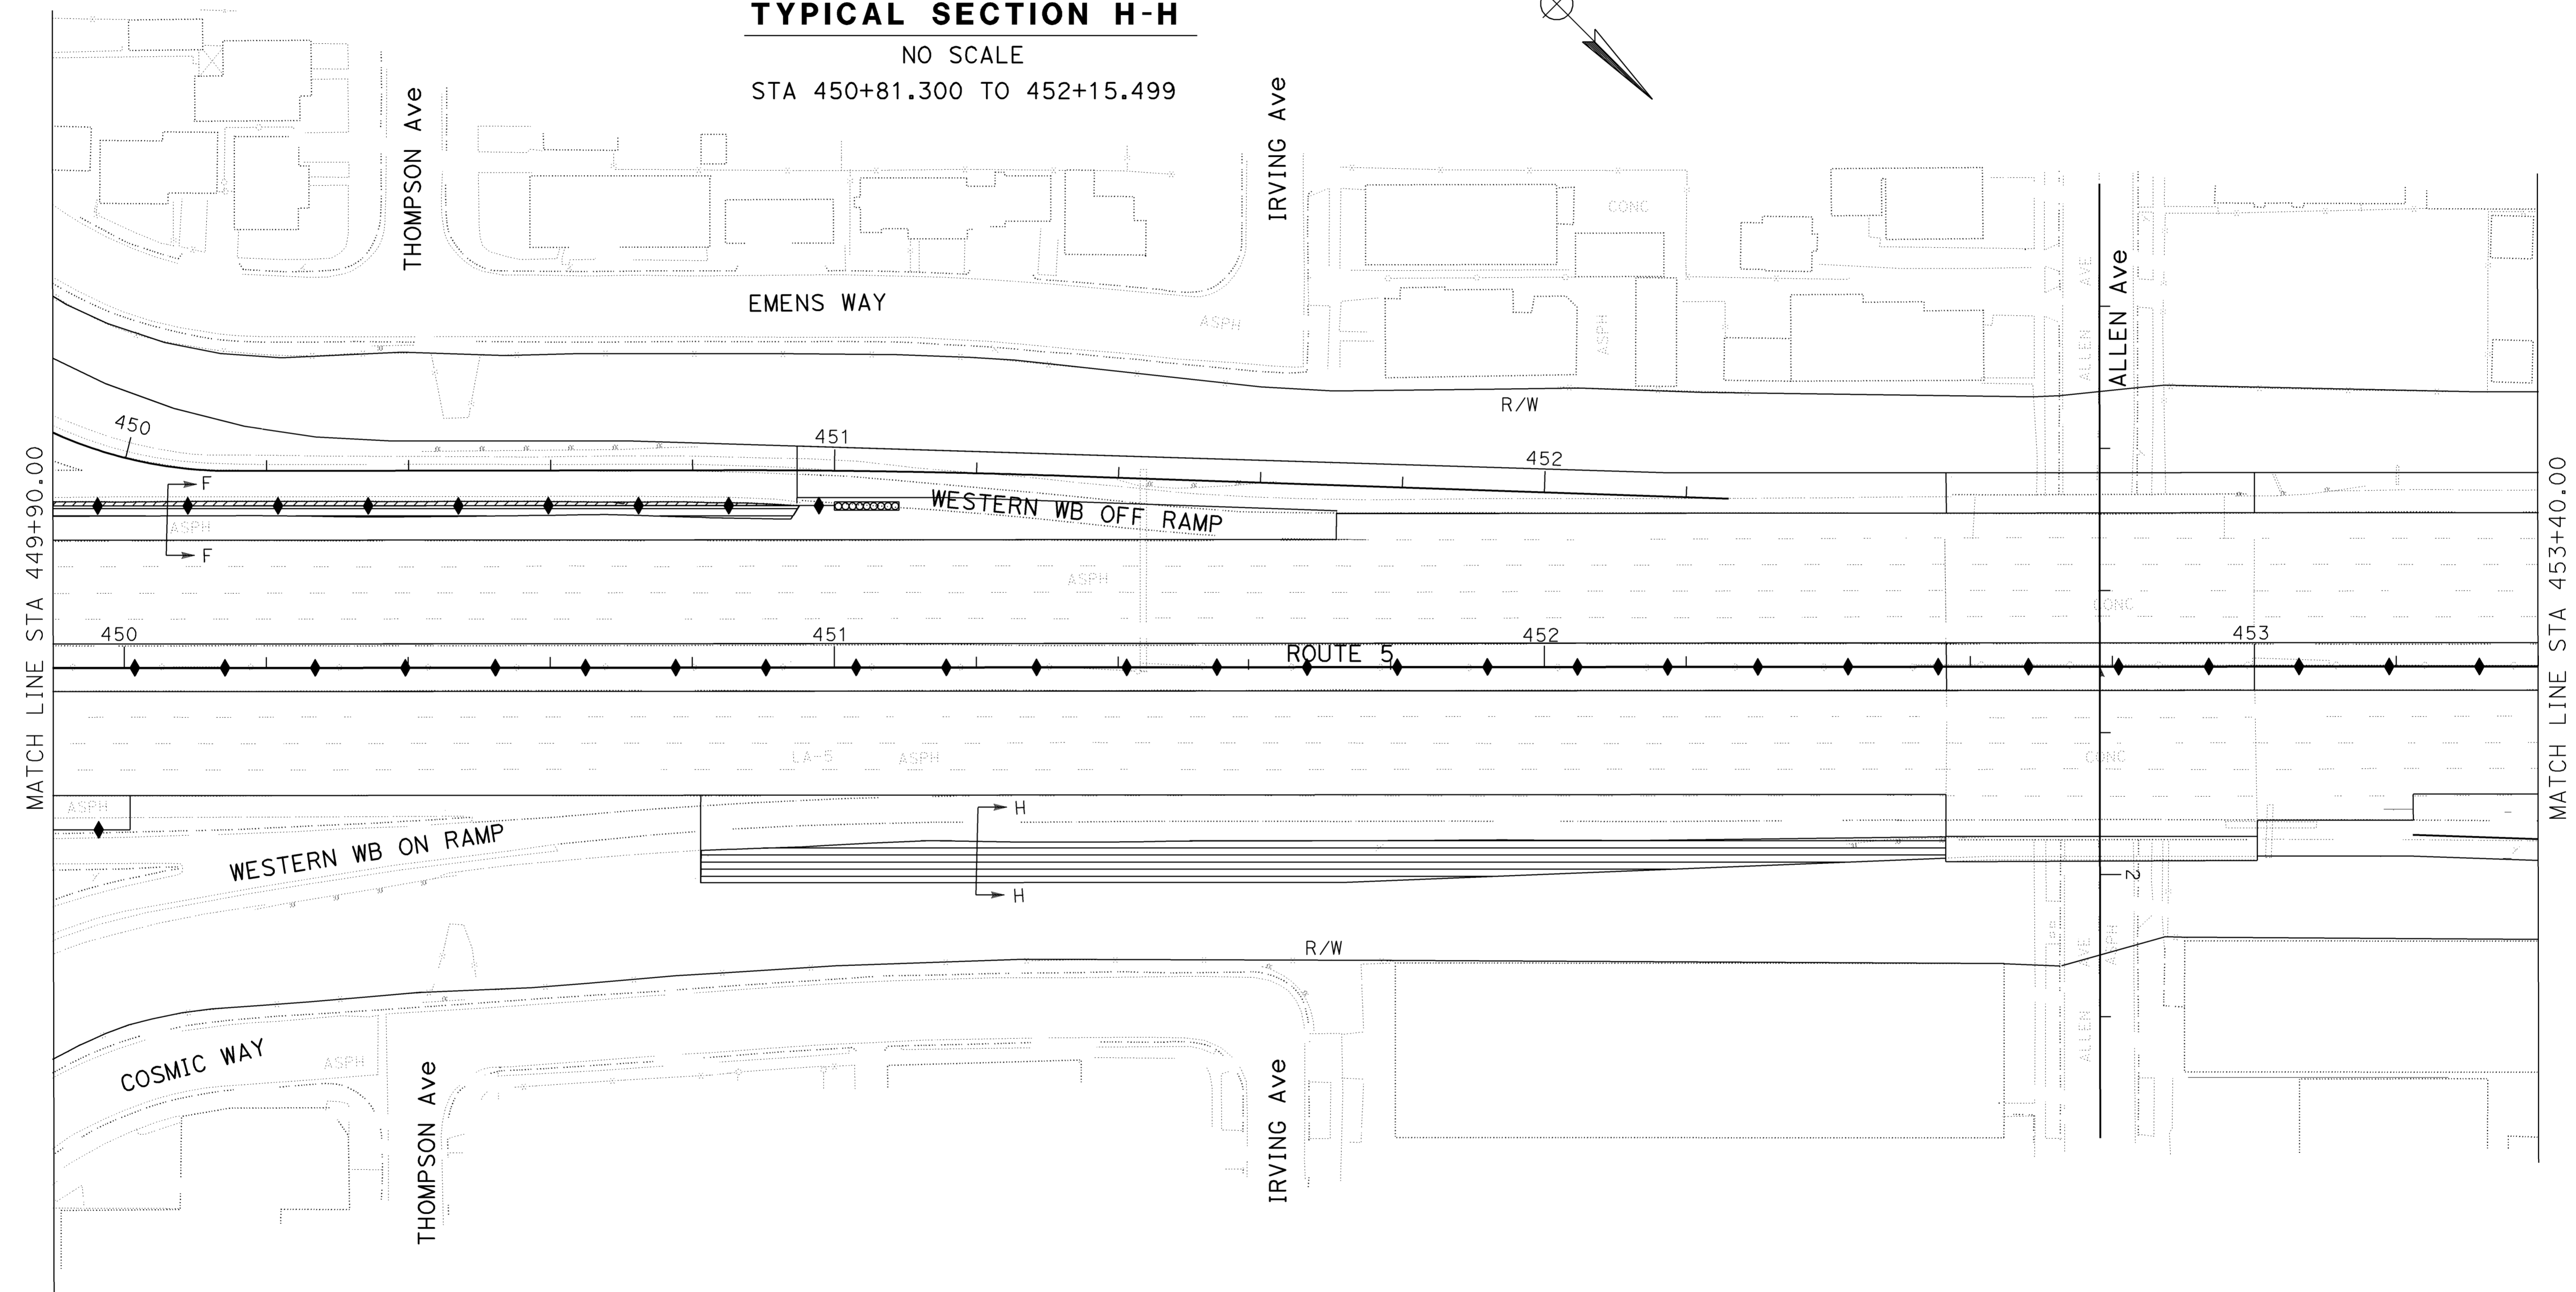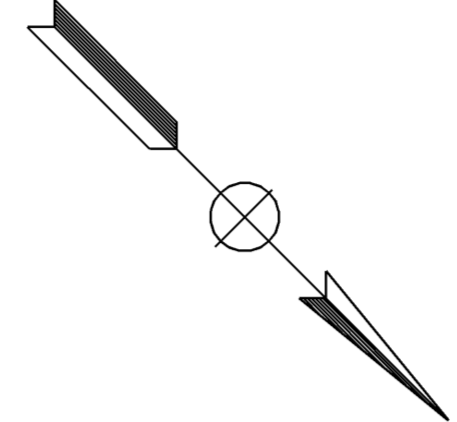ALL DIMENSIONS ARE IN METERS
 UNLESS OTHERWISE SHOWN

CONSTRUCTION DETAILS
LOCATIONS OF EXCAVATION

SCALE 1:500

C-20

THIS PLAN IS ACCURATE FOR AERIALY DEPOSITED LEAD EXCAVATION AND EMBANKMENT WORK ONLY.

STATE OF CALIFORNIA - DEPARTMENT OF TRANSPORTATION
Caltrans OFFICE OF DESIGN D

FUNCTIONAL SUPERVISOR
 CELINA AVILES

CALCULATED-DESIGNED BY
 CHECKED BY

CUONG T. TRAN
 MUNSHI MOHSIN

REVISED BY
 DATE REVISED




Dist	COUNTY	ROUTE	KILOMETER POST TOTAL PROJECT	SHEET No.	TOTAL SHEETS
07	LA	5	42.8/47.3	62	1073

2-24-09
 REGISTERED CIVIL ENGINEER DATE


6-8-09
 PLANS APPROVAL DATE

REGISTERED PROFESSIONAL ENGINEER
 MUNSHI MOHSIN
 No. 61916
 Exp. 9/30/09
 CIVIL
 STATE OF CALIFORNIA



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TYPICAL SECTION J-J
 NO SCALE
 STA 455+71.693 TO 456+48.055

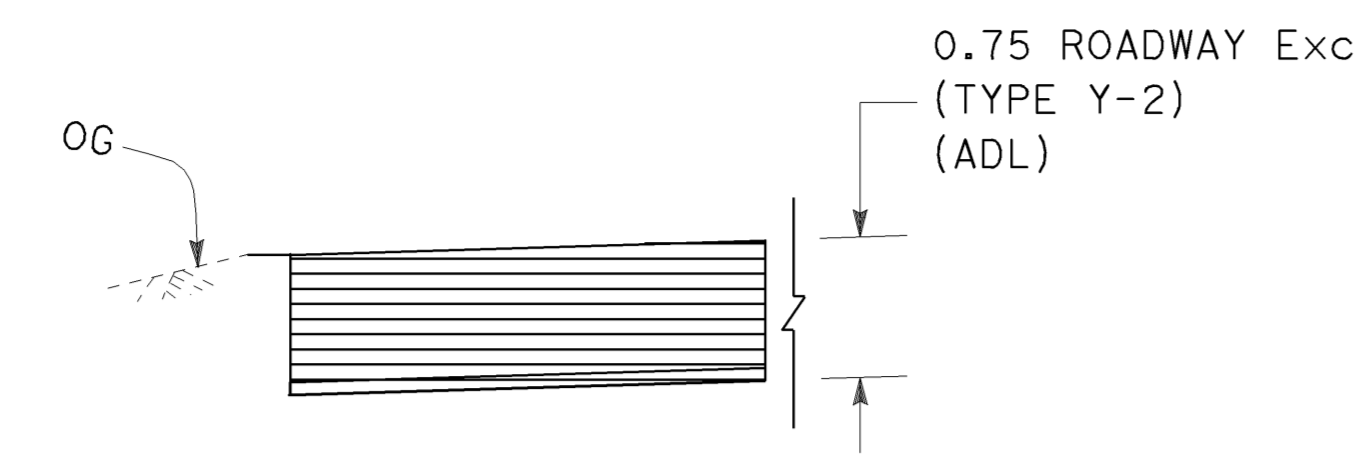

TYPICAL SECTION K-K
 NO SCALE
 STA 455+72.086 TO 456+14.996

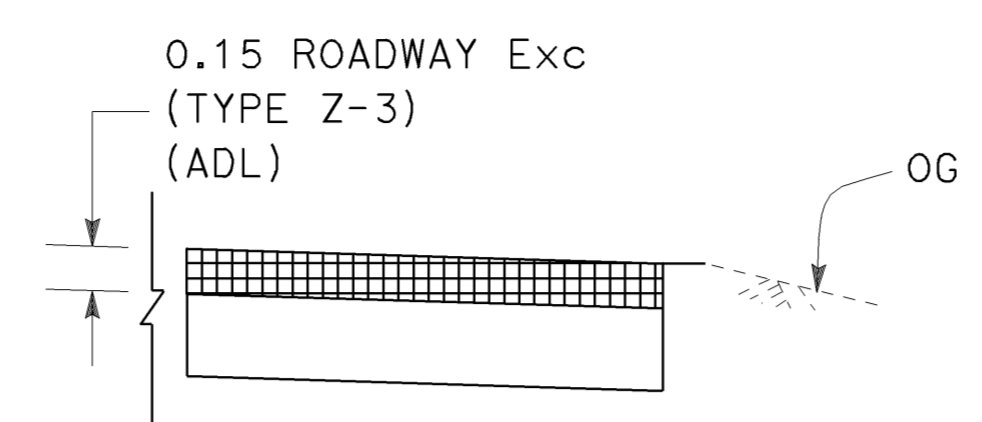

TYPICAL SECTION I-I
 NO SCALE
 STA 453+40.000 TO 454+62.506

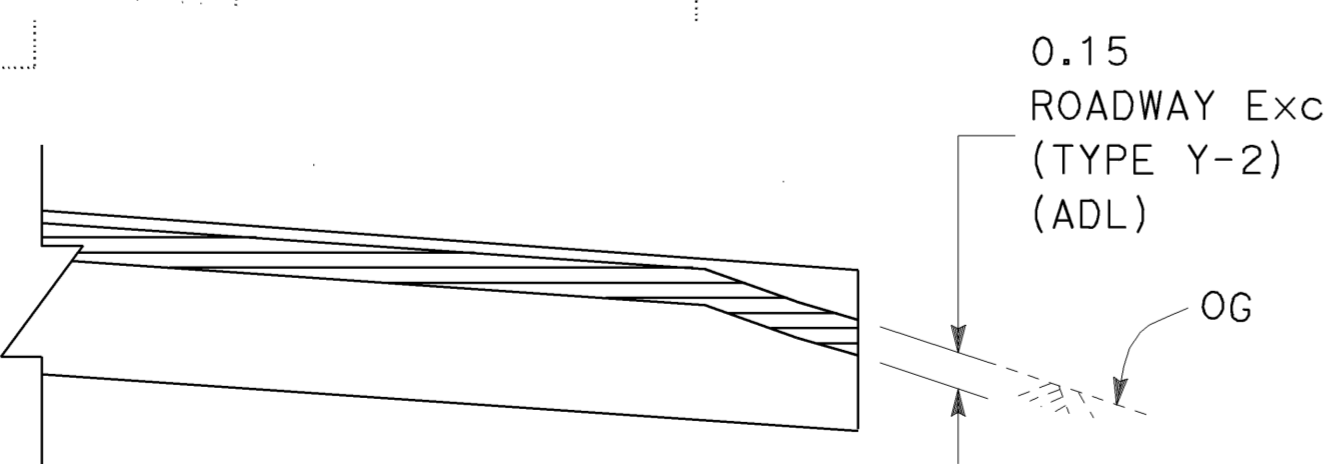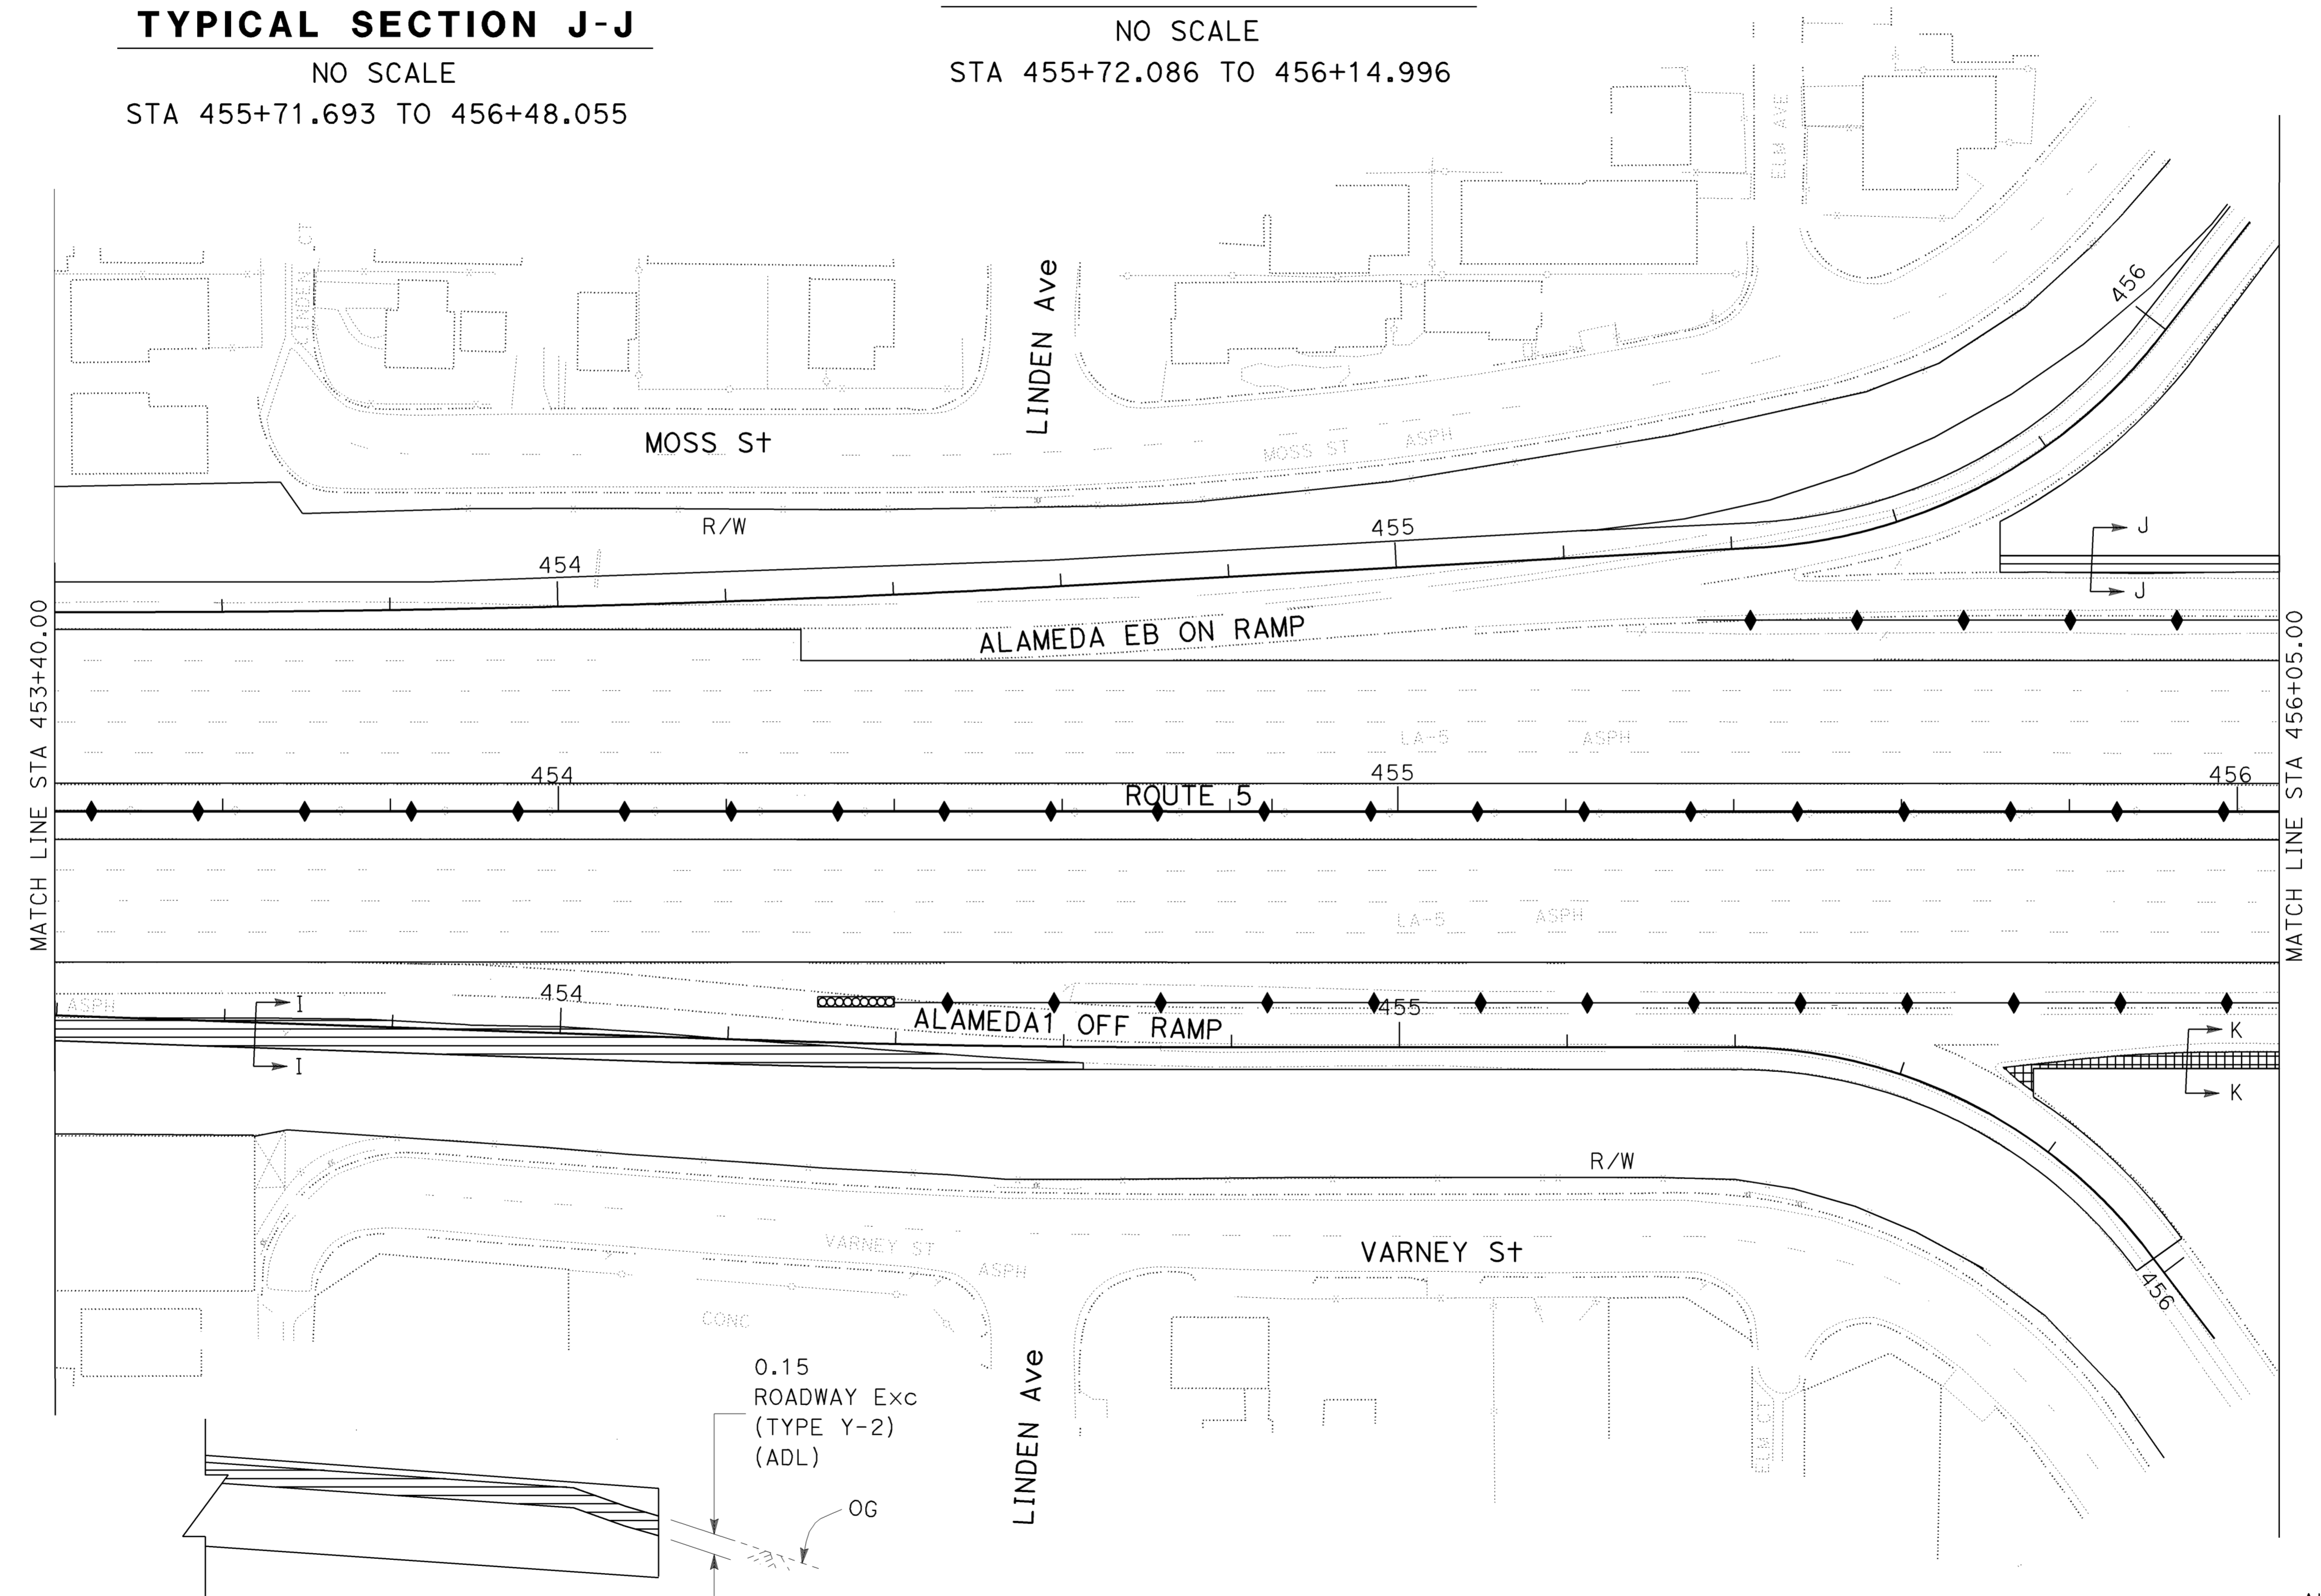NOTE:
 1. FOR COMPLETE RIGHT OF WAY AND ACCURATE ACCESS DATA, SEE RIGHT OF WAY RECORD MAPS AT DISTRICT OFFICE.

ALL DIMENSIONS ARE IN METERS UNLESS OTHERWISE SHOWN

**CONSTRUCTION DETAILS
 LOCATIONS OF EXCAVATION**

SCALE 1:500

C-21

THIS PLAN IS ACCURATE FOR AERIALY DEPOSITED LEAD EXCAVATION AND EMBANKMENT WORK ONLY.

FUNCTIONAL SUPERVISOR
 CELINA AVILES

CALCULATED-DESIGNED BY
 CHECKED BY

CUONG T TRAN
 MUNSHI MOHSIN

REVISED BY
 DATE REVISED

NOTE:

1. FOR COMPLETE RIGHT OF WAY AND ACCURATE ACCESS DATA, SEE RIGHT OF WAY RECORD MAPS AT DISTRICT OFFICE.





Dist	COUNTY	ROUTE	KILOMETER POST TOTAL PROJECT	SHEET No.	TOTAL SHEETS
07	LA	5	42.8/47.3	63	1073

2-24-09
 REGISTERED CIVIL ENGINEER DATE

6-8-09
 PLANS APPROVAL DATE

MUNSHI MOHSIN
 No. 61916
 Exp. 9/30/09
 CIVIL
 STATE OF CALIFORNIA

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CONSTRUCTION DETAILS
LOCATIONS OF EXCAVATION

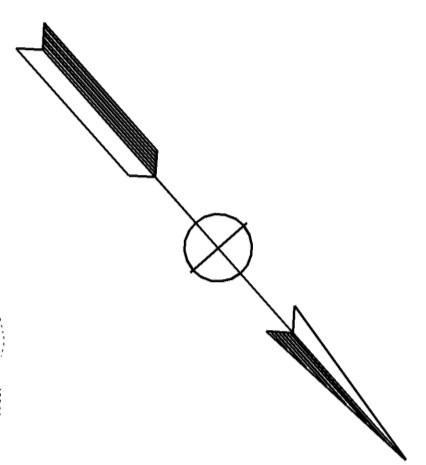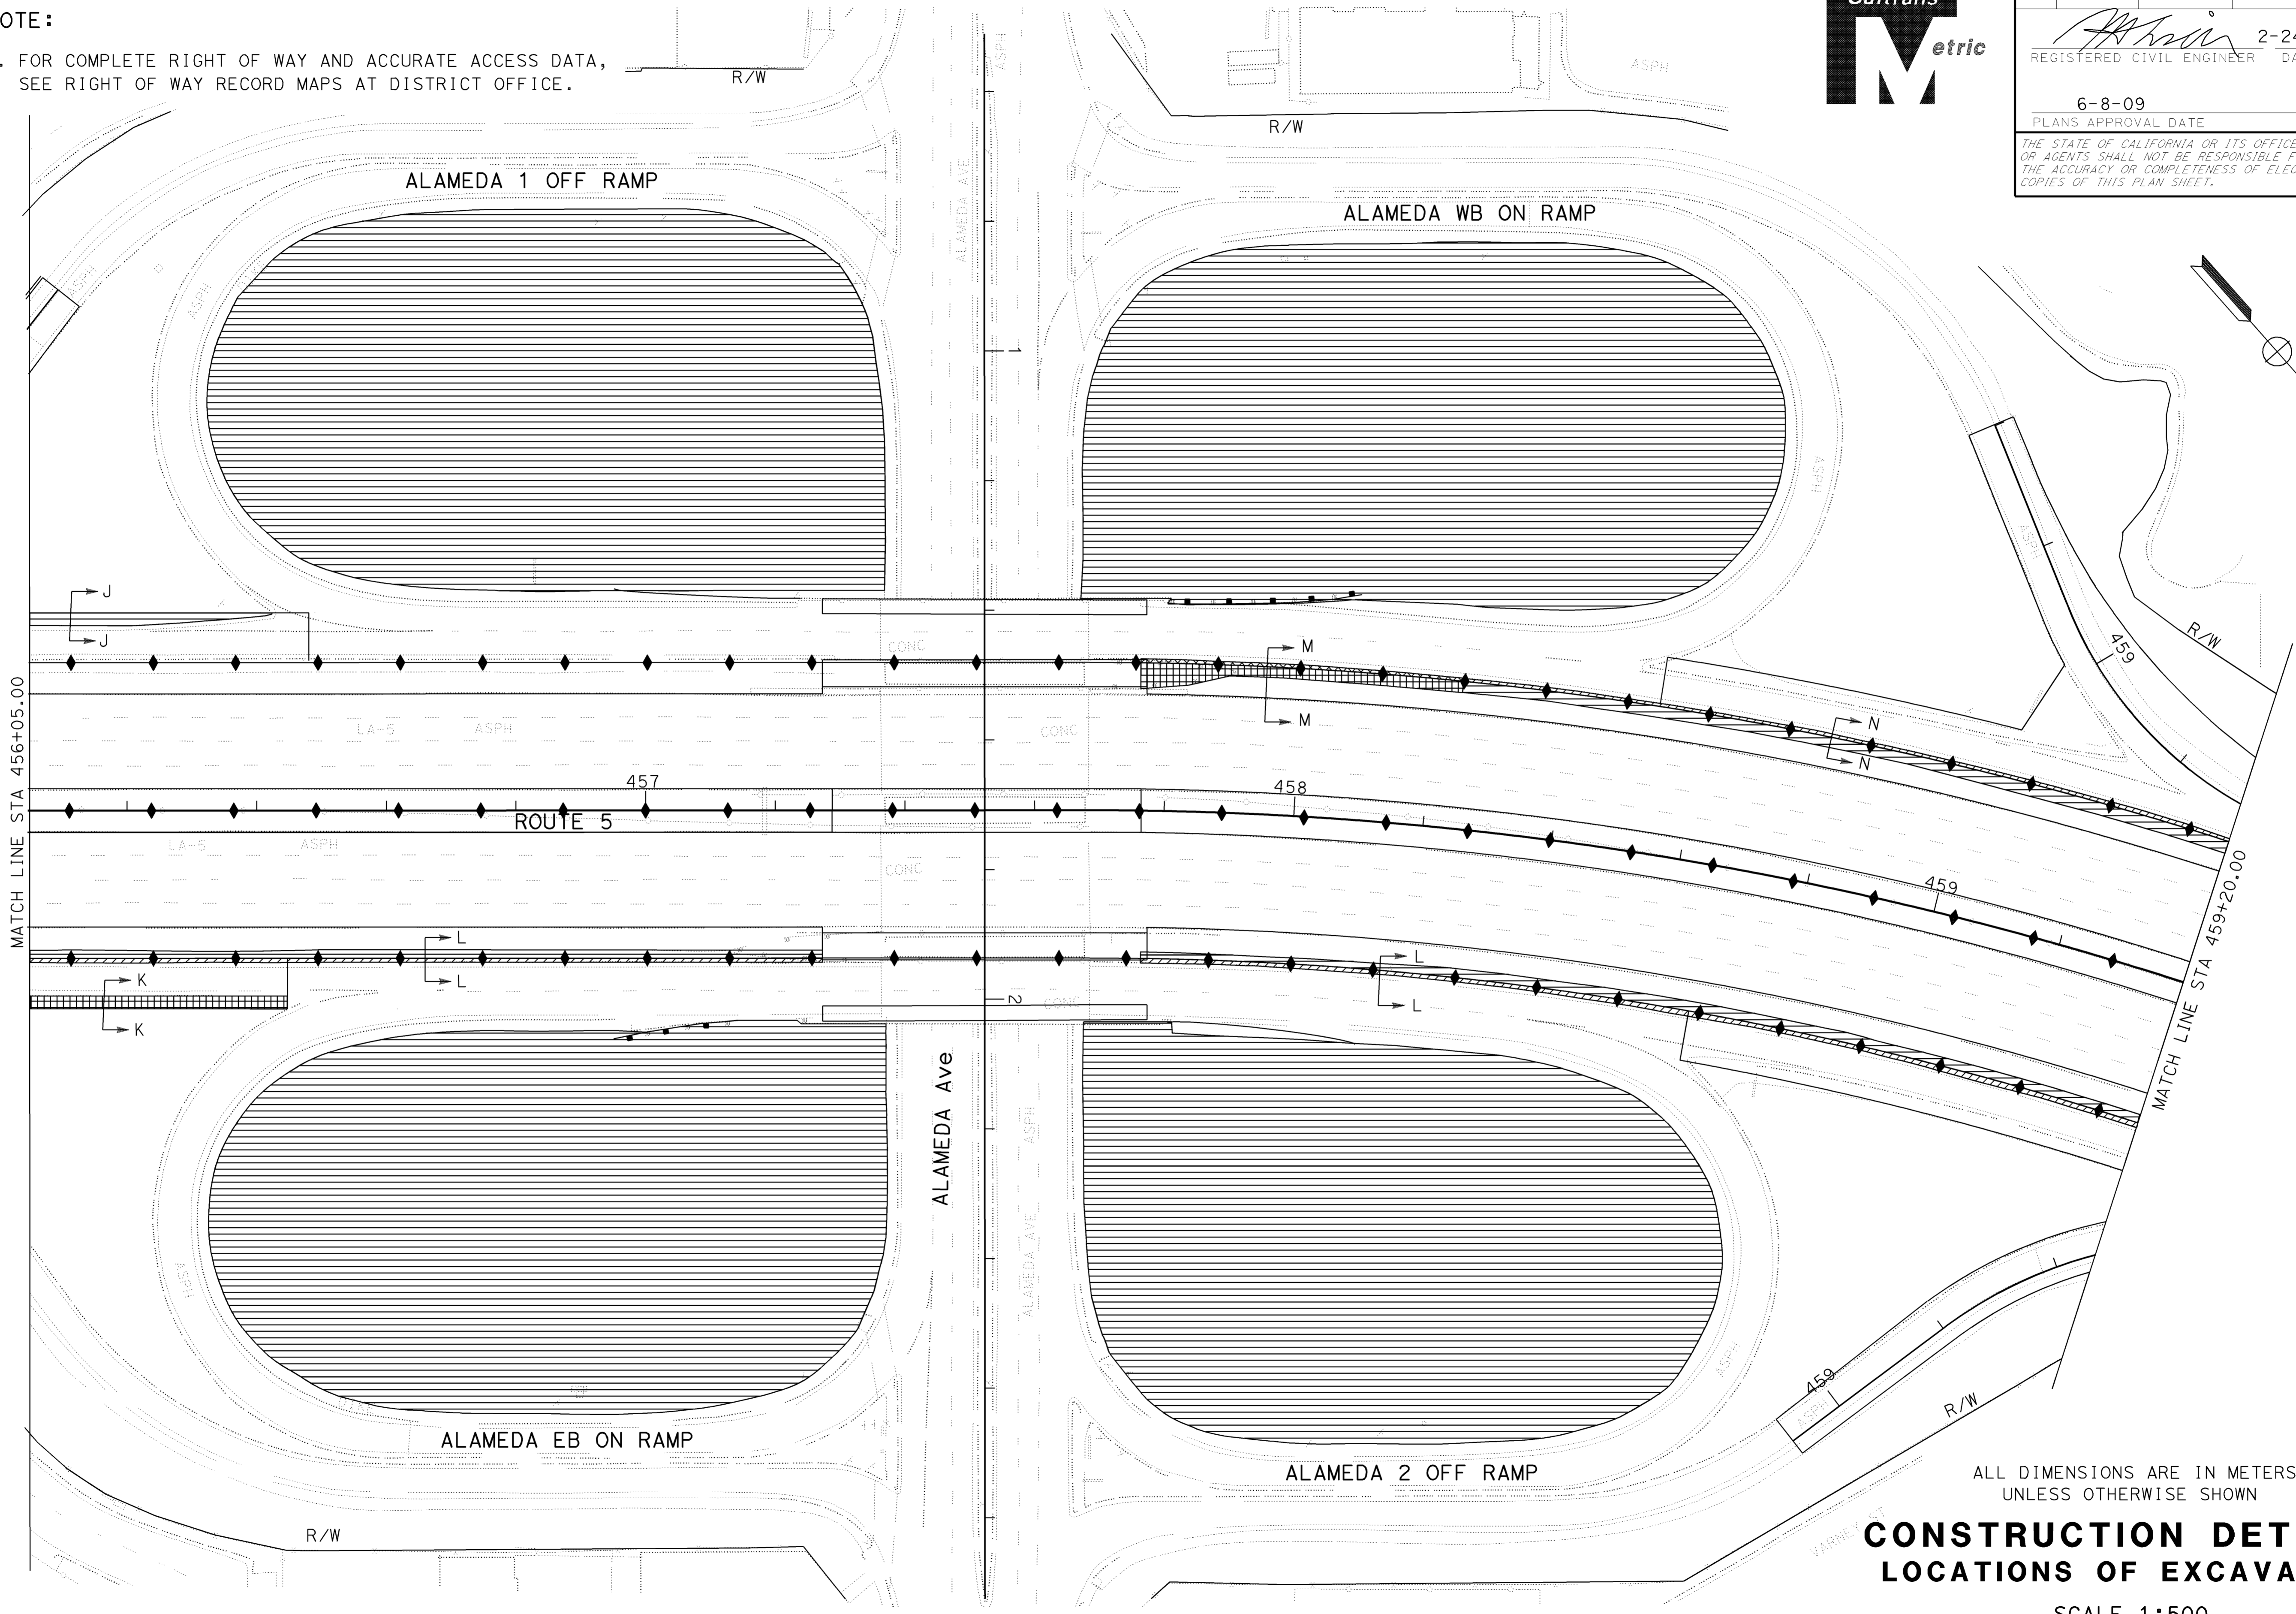SCALE 1:500

C-22

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STATE OF CALIFORNIA - DEPARTMENT OF TRANSPORTATION
Caltrans OFFICE OF DESIGN D

FUNCTIONAL SUPERVISOR
 CELINA AVILES

CALCULATED-DESIGNED BY
 CHECKED BY

CUONG T TRAN
 MUNSHI MOHSIN

REVISED BY
 DATE REVISED




Dist	COUNTY	ROUTE	KILOMETER POST TOTAL PROJECT	SHEET No.	TOTAL SHEETS
07	LA	5	42.8/47.3	64	1073


REGISTERED CIVIL ENGINEER DATE 2-24-09
 6-8-09
 PLANS APPROVAL DATE

REGISTERED PROFESSIONAL ENGINEER
 MUNSHI MOHSIN
 No. 61916
 Exp. 9/30/09
 CIVIL
 STATE OF CALIFORNIA


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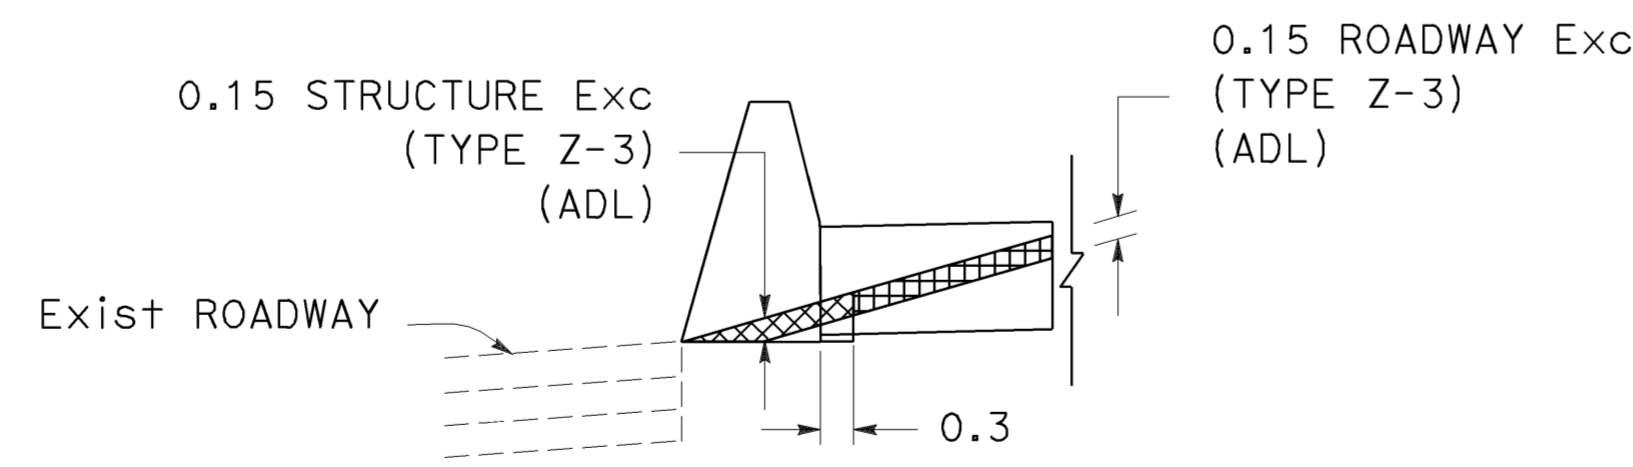
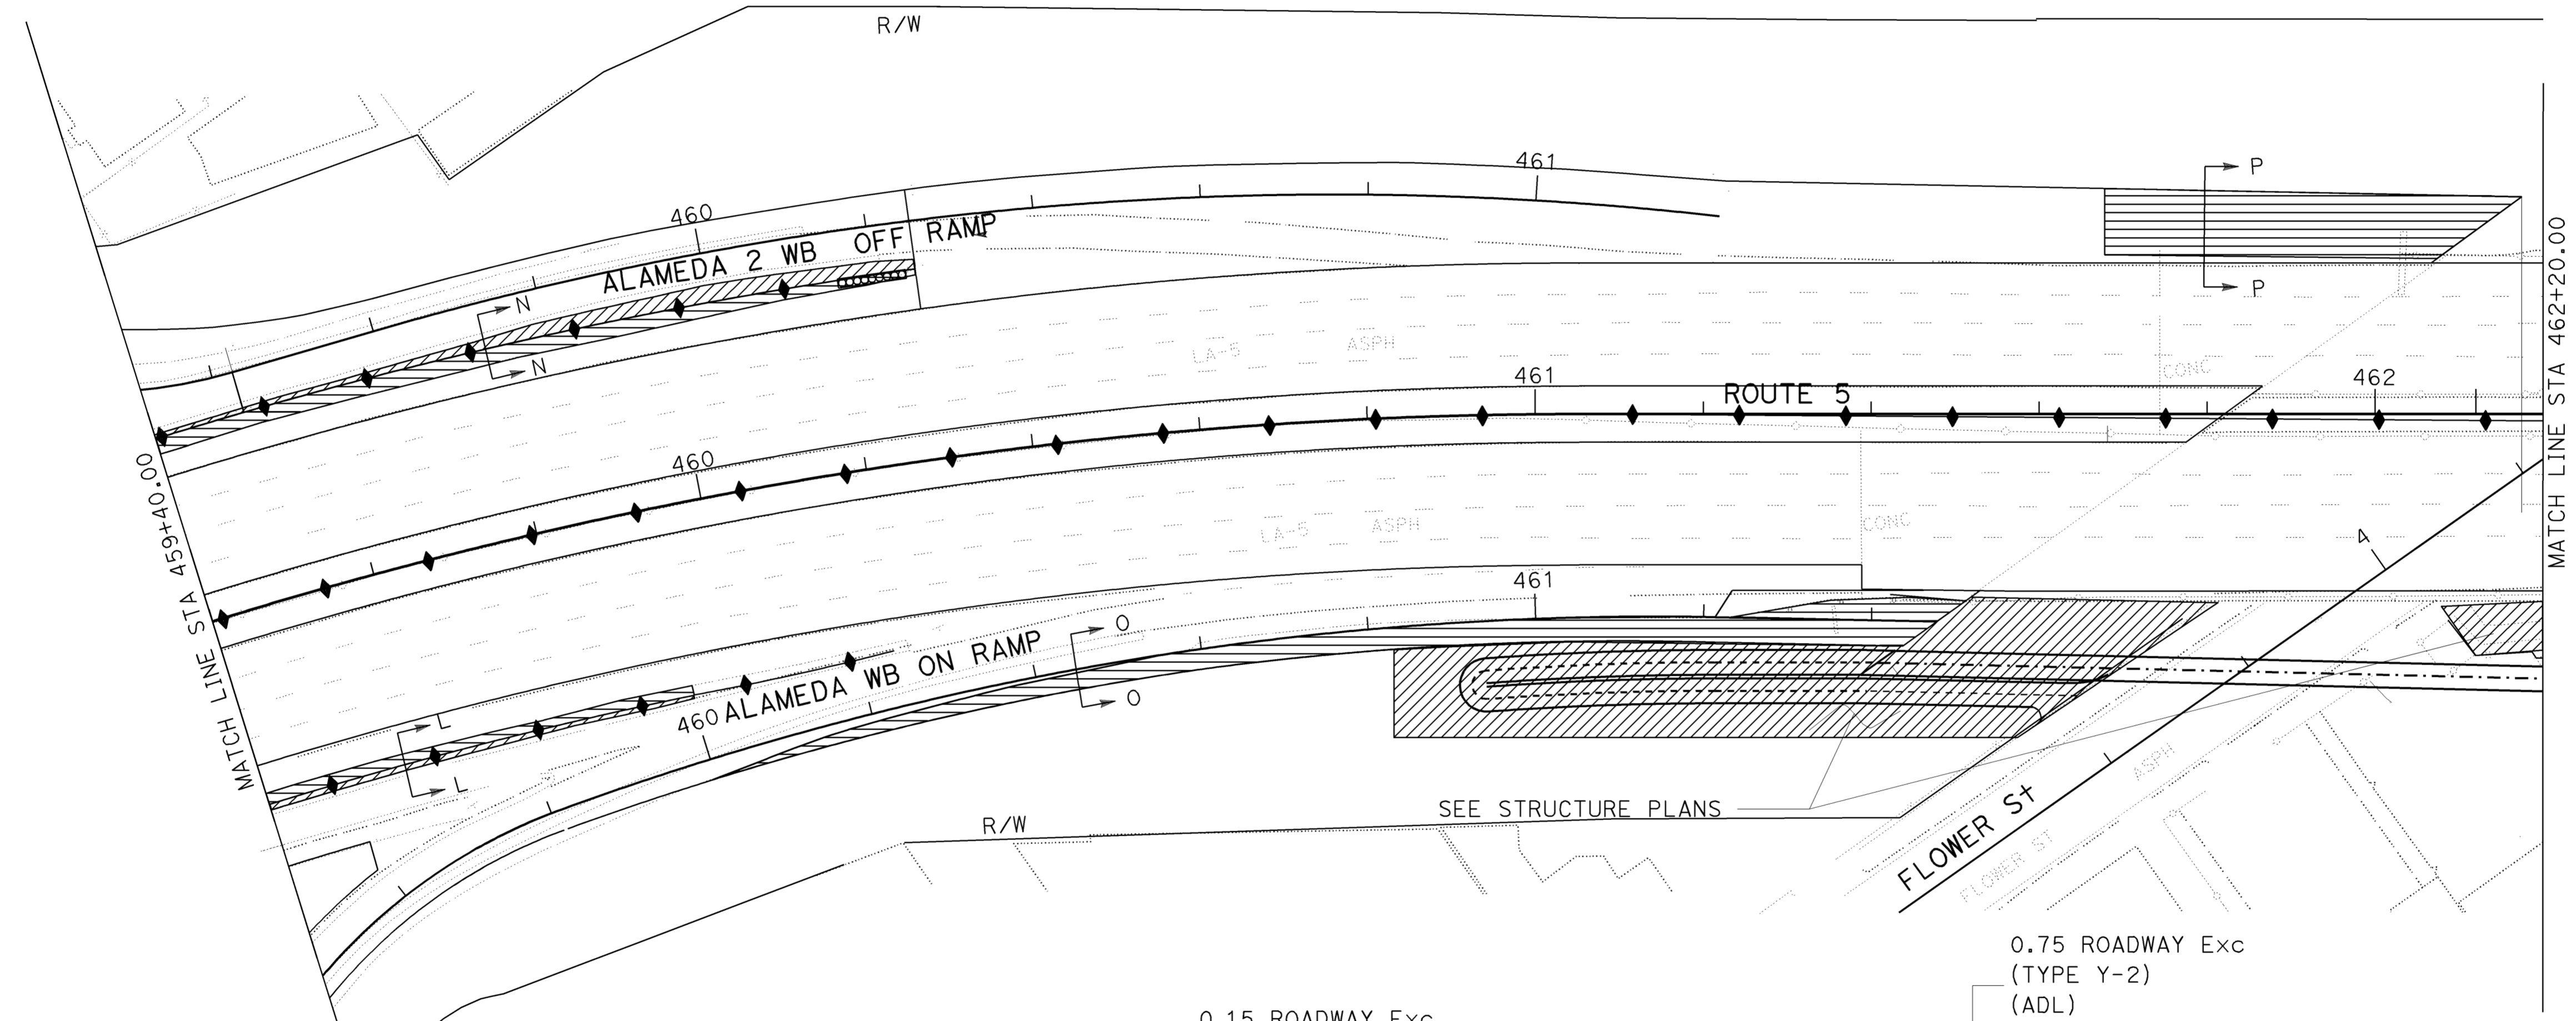
TYPICAL SECTION L-L
 NO SCALE
 STA 456+05.000 TO 457+24.201
 STA 457+76.600 TO 460+00.000

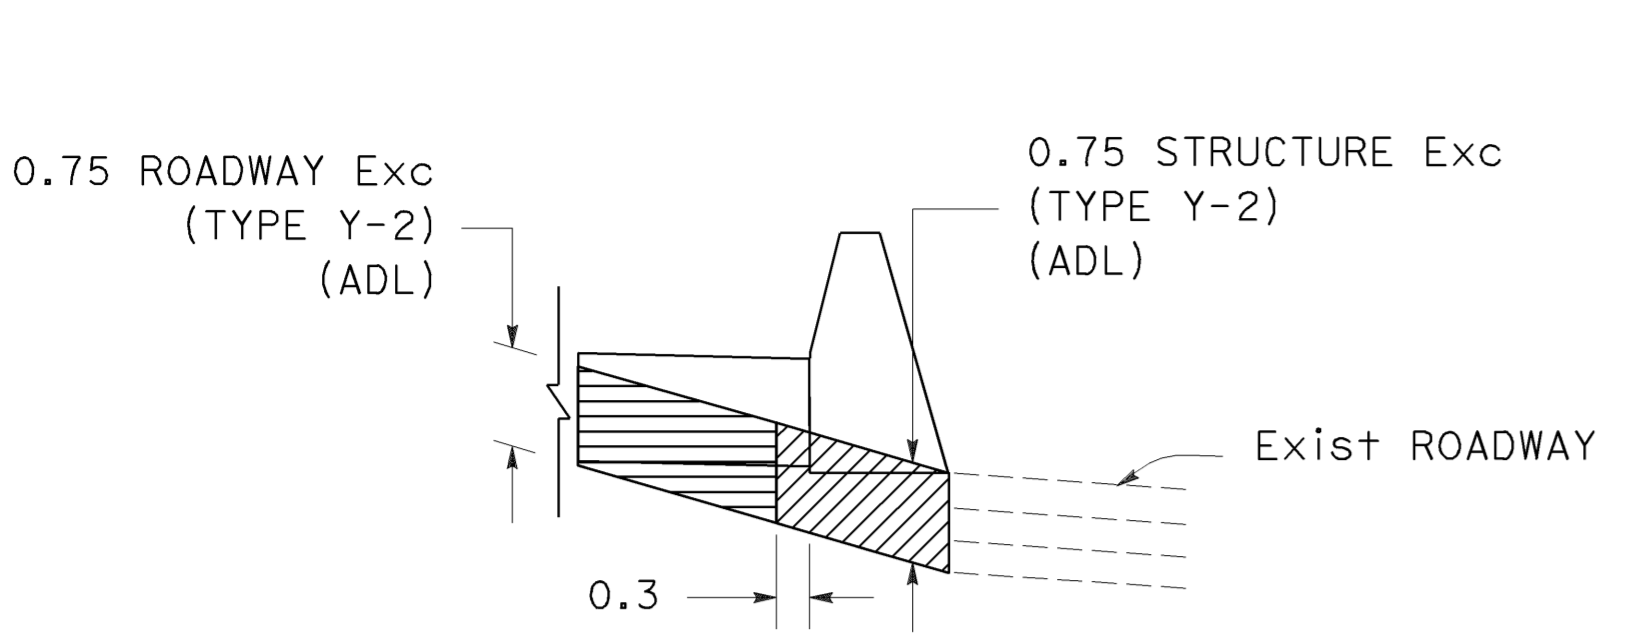


TYPICAL SECTION N-N
 NO SCALE
 STA 458+23.965 TO 460+29.059

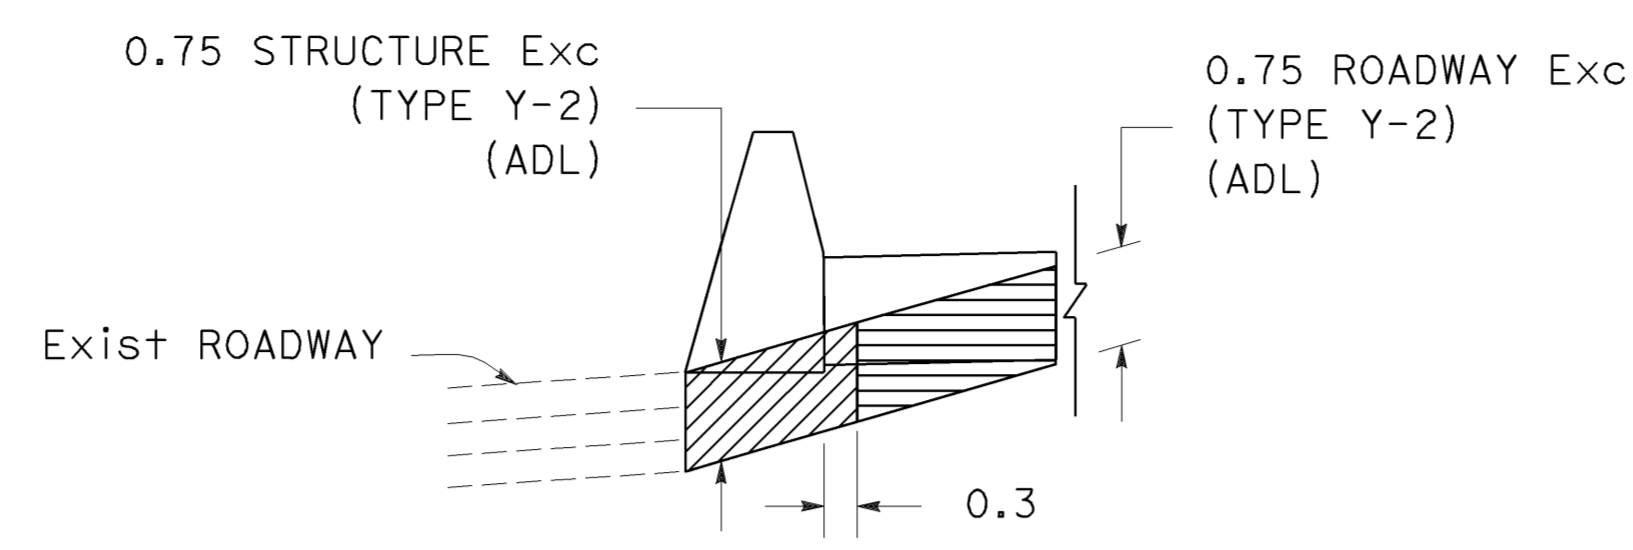

TYPICAL SECTION P-P
 NO SCALE
 STA 461+67.780 TO 462+17.462

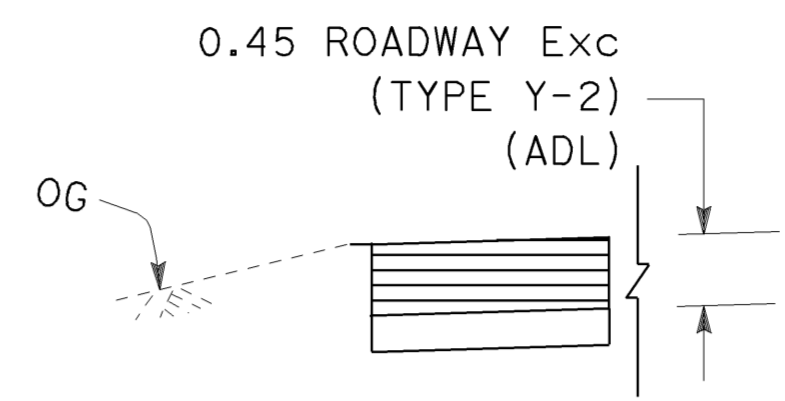

TYPICAL SECTION M-M
 NO SCALE
 STA 457+77.305 TO 458+23.965

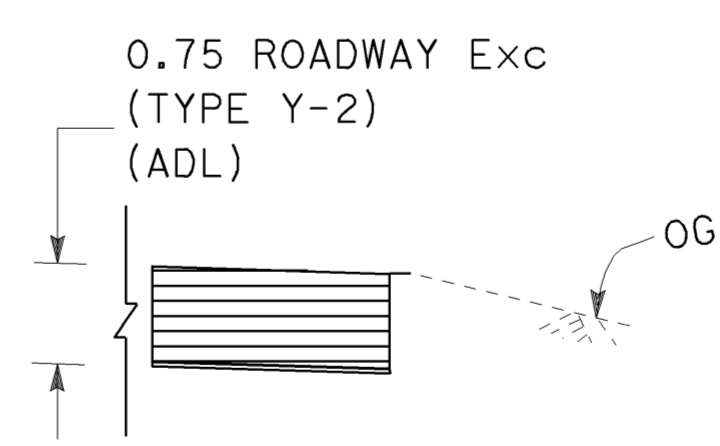

TYPICAL SECTION O-O
 NO SCALE
 STA 460+00.000 TO 461+00.000

NOTE:

- FOR COMPLETE RIGHT OF WAY AND ACCURATE ACCESS DATA, SEE RIGHT OF WAY RECORD MAPS AT DISTRICT OFFICE.

ALL DIMENSIONS ARE IN METERS
 UNLESS OTHERWISE SHOWN

**CONSTRUCTION DETAILS
 LOCATIONS OF EXCAVATION**

SCALE 1:500

C-23




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Caltrans OFFICE OF DESIGN D
 FUNCTIONAL SUPERVISOR
 CELINA AVILES
 CHECKED BY
 MUNSHI MOHSIN
 CALCULATED-DESIGNED BY
 CUONG T TRAN
 REVISIONS
 REVISION NO. DATE REVISION BY DATE REVISION BY



Dist	COUNTY	ROUTE	KILOMETER POST TOTAL PROJECT	SHEET No.	TOTAL SHEETS
07	LA	5	42.8/47.3	65	1073

REGISTERED CIVIL ENGINEER DATE 2-24-09
 6-8-09
 PLANS APPROVAL DATE
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NOTE:
 1. FOR COMPLETE RIGHT OF WAY AND ACCURATE ACCESS DATA, SEE RIGHT OF WAY RECORD MAPS AT DISTRICT OFFICE.

ALL DIMENSIONS ARE IN METERS UNLESS OTHERWISE SHOWN
CONSTRUCTION DETAILS
LOCATIONS OF EXCAVATION
 SCALE 1:500

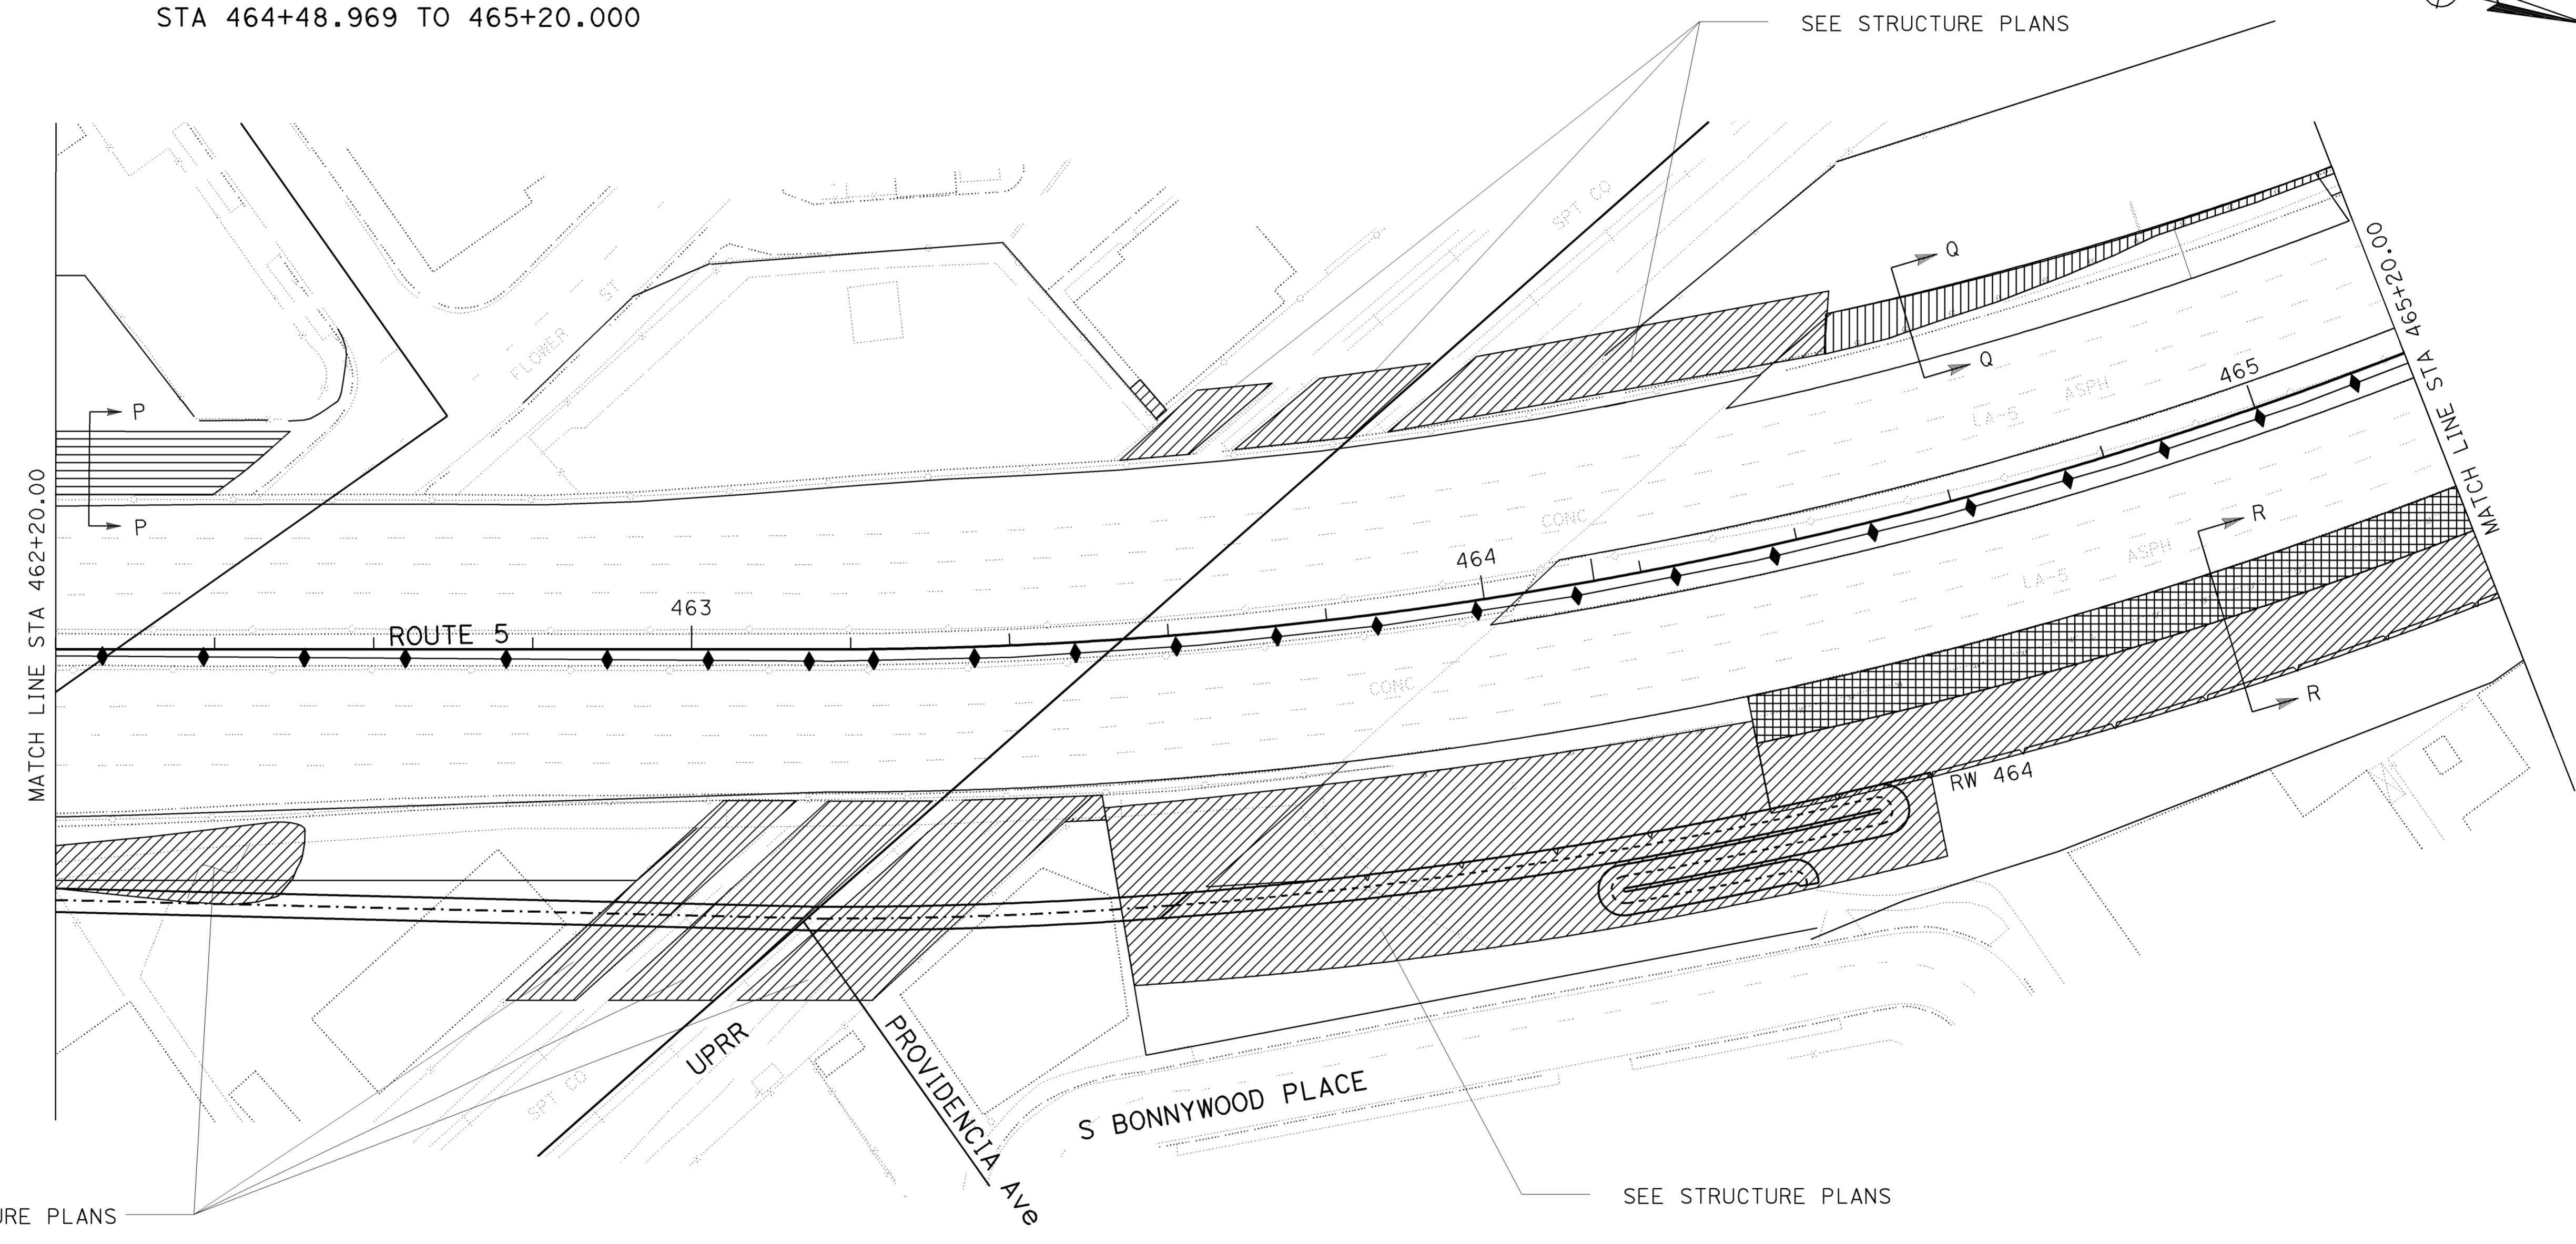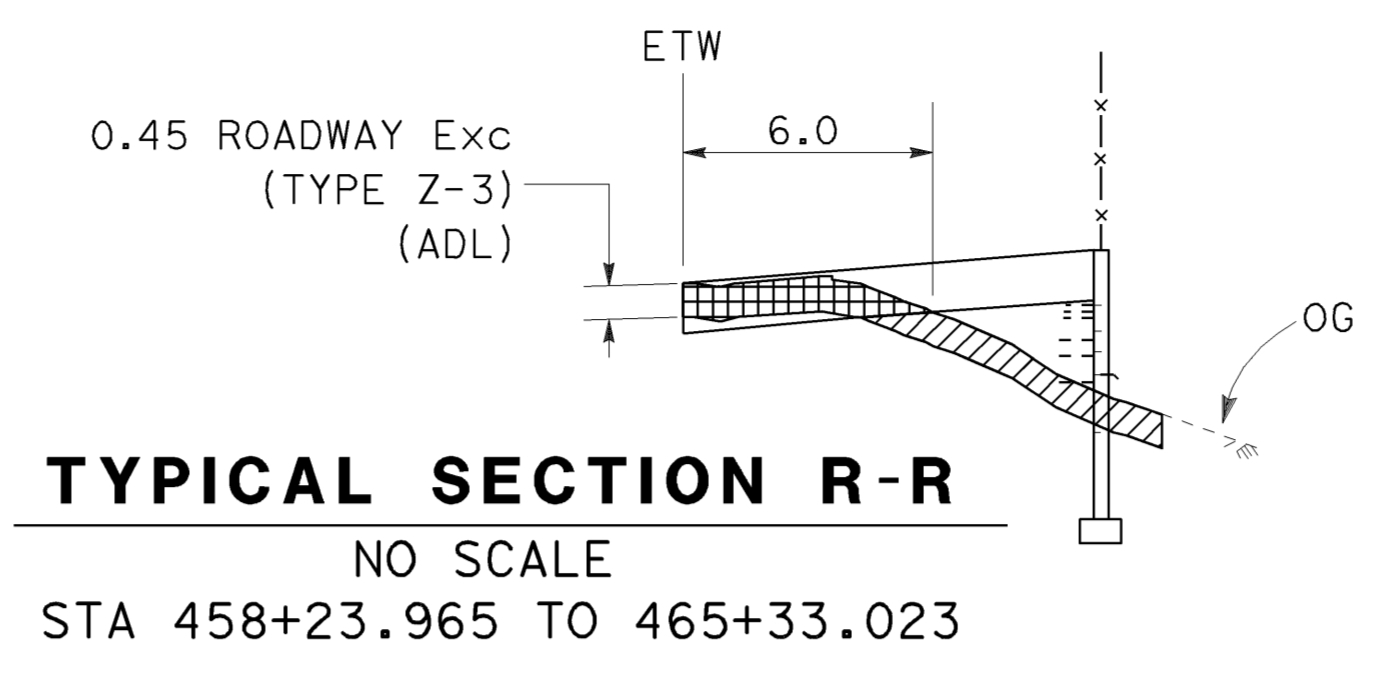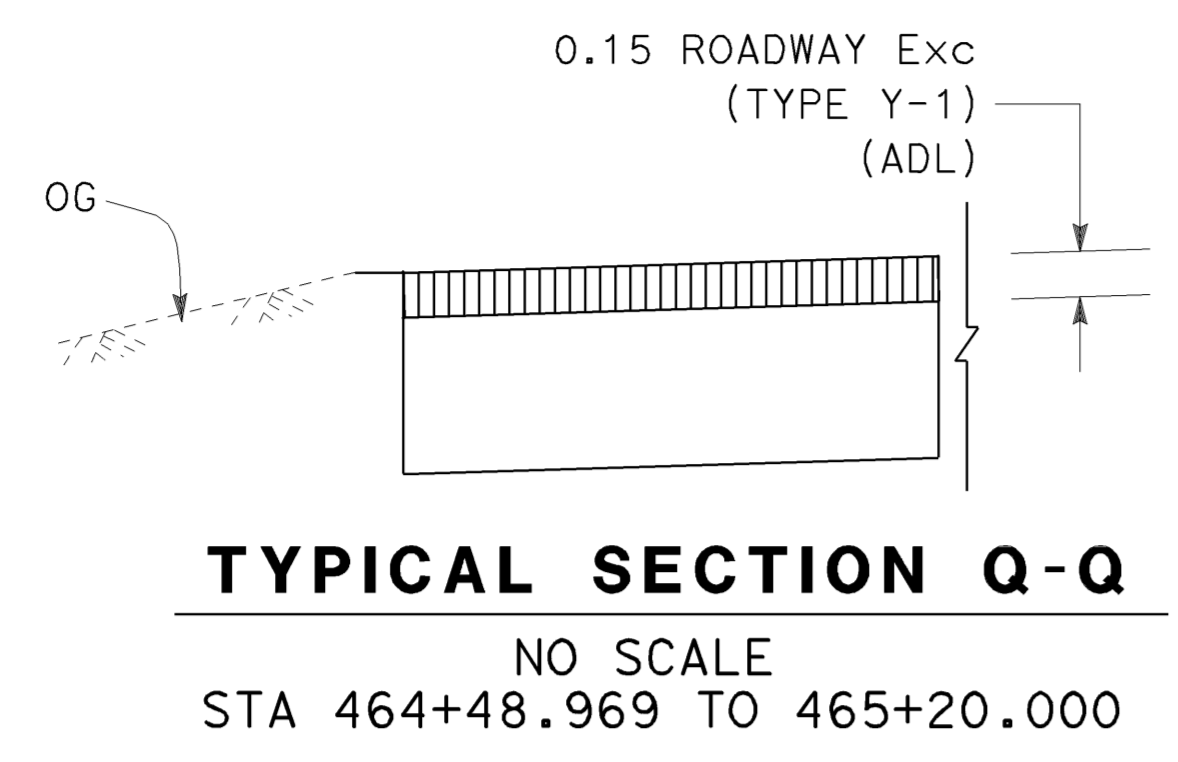C-24

THIS PLAN IS ACCURATE FOR AERIALY DEPOSITED LEAD EXCAVATION AND EMBANKMENT WORK ONLY.



USERNAME => trpierce
 DGN FILE => 712184ga024.dgn

CU 07276

EA 121841

BORDER LAST REVISED 3/1/2007

LAST REVISION DATE PLOTTED => 12-JUN-2009
 02-19-09 TIME PLOTTED => 08:52

STATE OF CALIFORNIA - DEPARTMENT OF TRANSPORTATION
Caltrans OFFICE OF DESIGN D

FUNCTIONAL SUPERVISOR
 CELINA AVILES

CALCULATED-DESIGNED BY
 CHECKED BY


CUONG T TRAN
 MUNSHI MOHSIN

REVISED BY
 DATE REVISED




Dist	COUNTY	ROUTE	KILOMETER POST TOTAL PROJECT	SHEET No.	TOTAL SHEETS
07	LA	5	42.8/47.3	66	1073



REGISTERED CIVIL ENGINEER DATE 2-24-09
 PLANS APPROVAL DATE 6-8-09
 REGISTERED PROFESSIONAL ENGINEER
 MUNSHI MOHSIN
 No. 61916
 Exp. 9/30/09
 CIVIL
 STATE OF CALIFORNIA
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TYPICAL SECTION S1-S1
 NO SCALE
 STA 465+76.658 TO 467+76.380

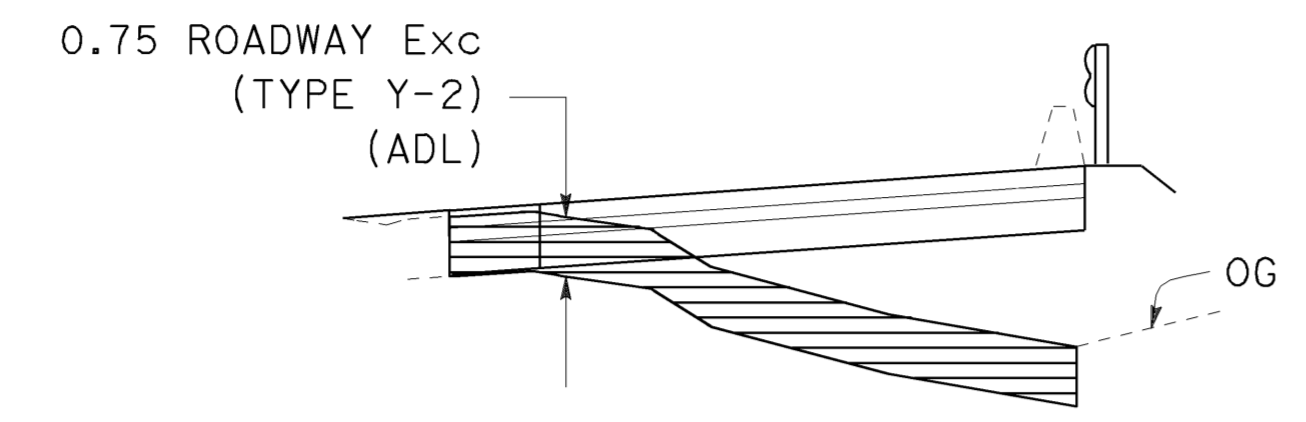

TYPICAL SECTION S2-S2
 NO SCALE
 STA 466+94.256 TO 470+53.470

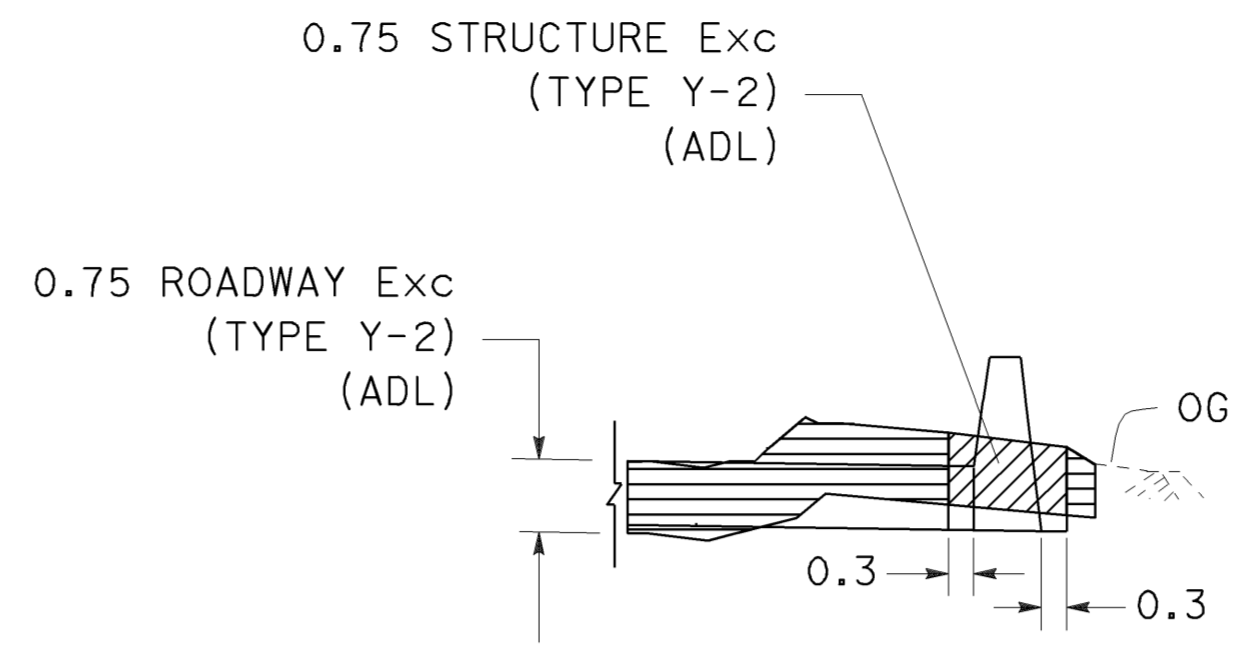

SEE STRUCTURE PLANS

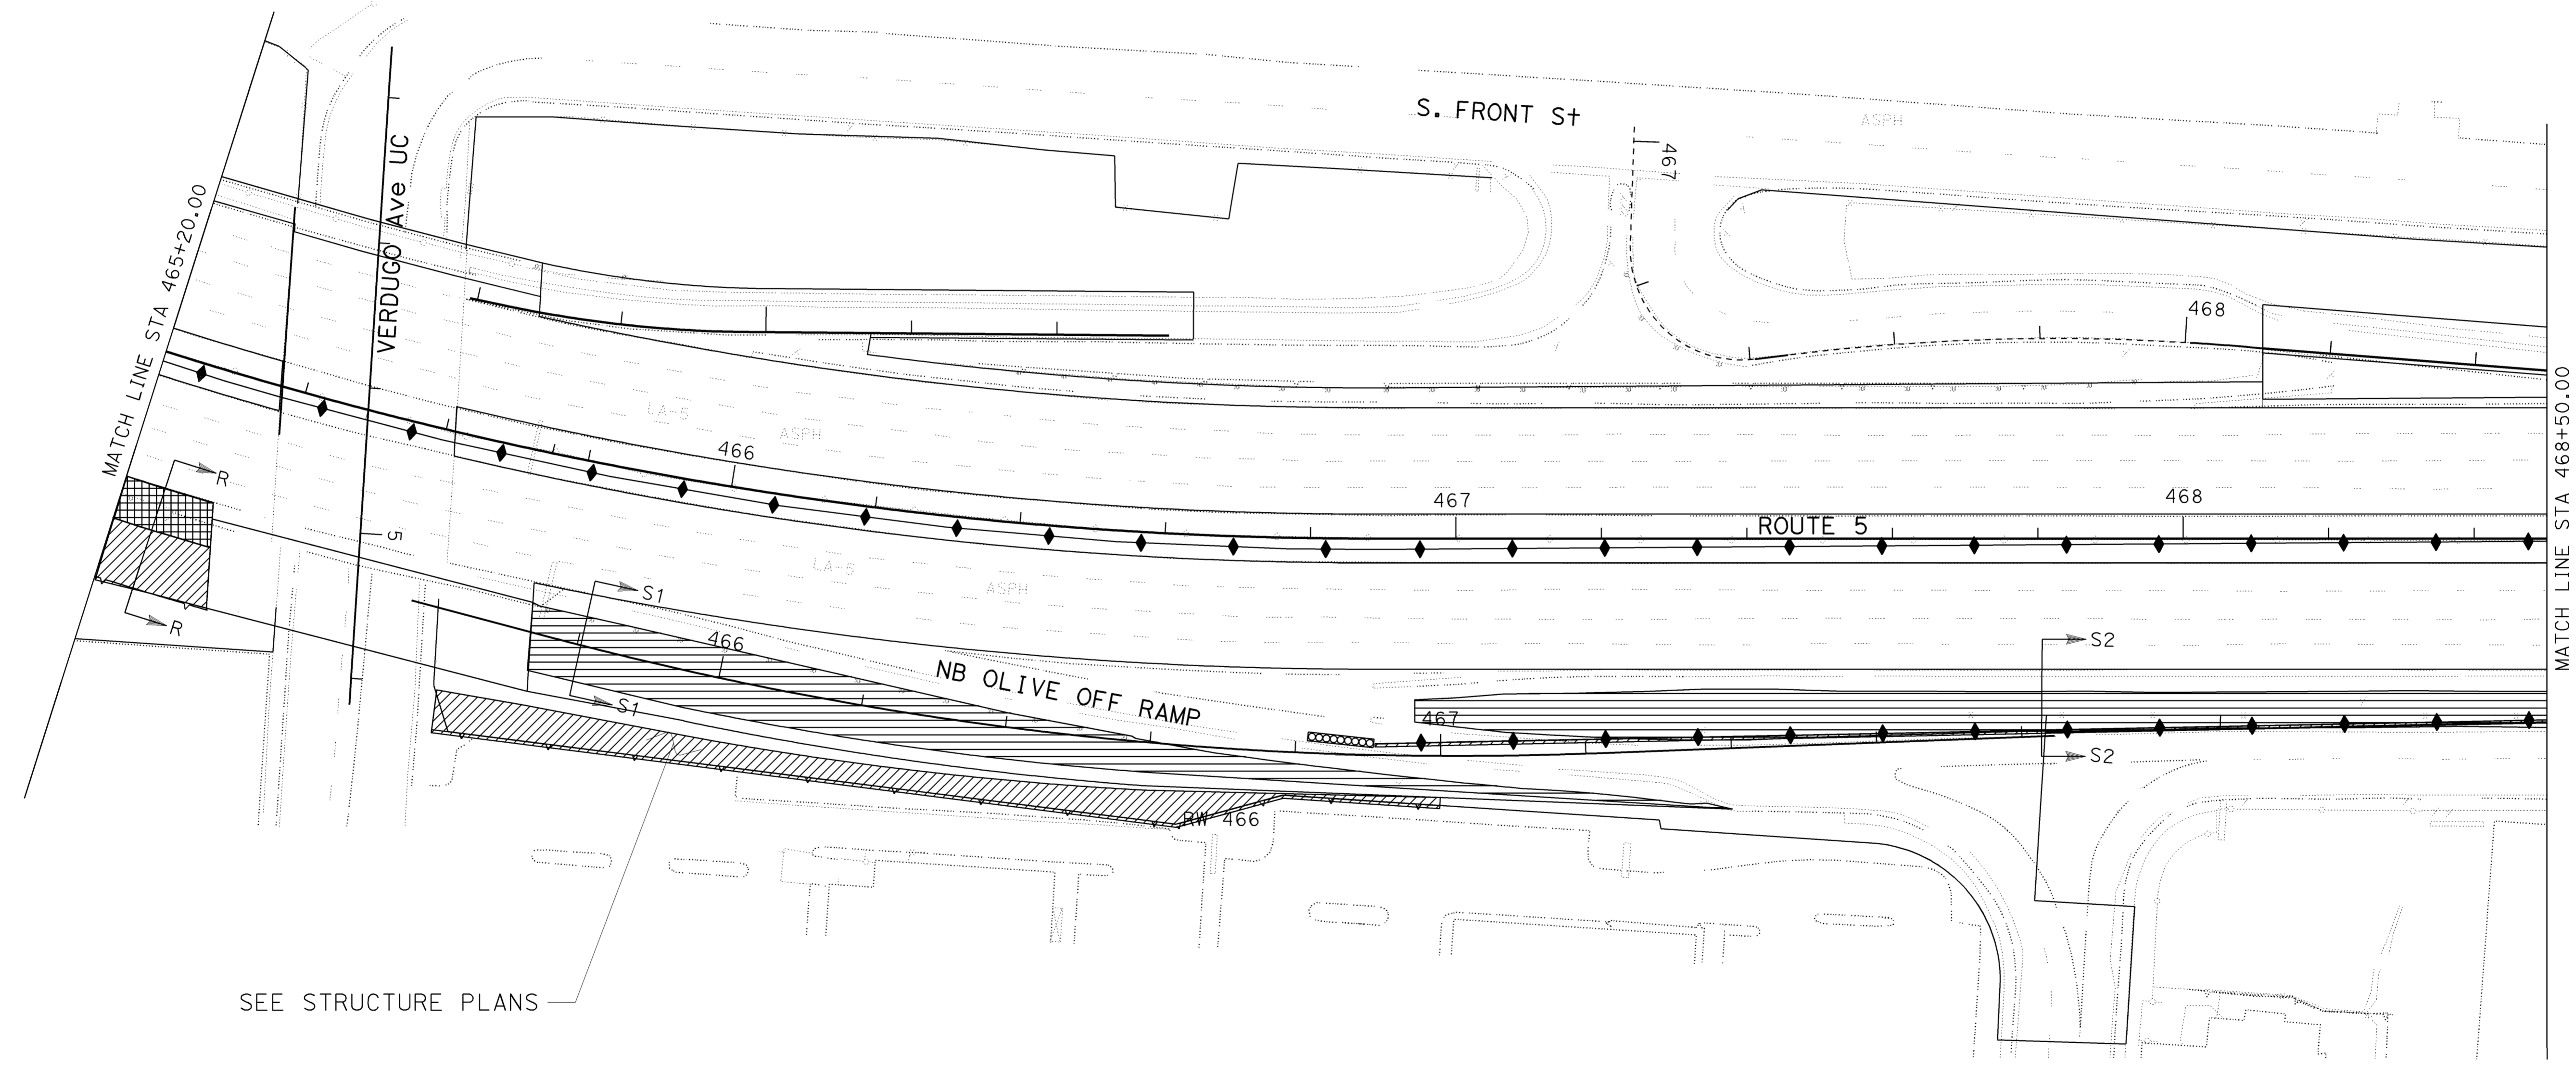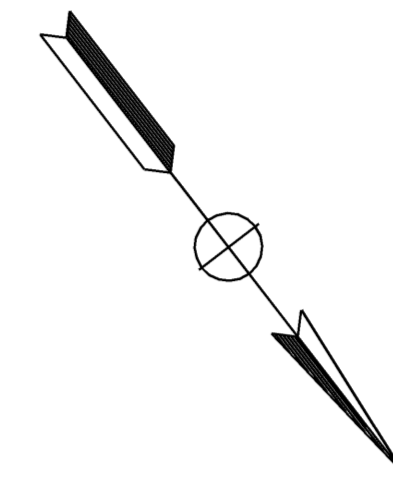NOTE:
 1. FOR COMPLETE RIGHT OF WAY AND ACCURATE ACCESS DATA, SEE RIGHT OF WAY RECORD MAPS AT DISTRICT OFFICE.

ALL DIMENSIONS ARE IN METERS UNLESS OTHERWISE SHOWN

**CONSTRUCTION DETAILS
 LOCATIONS OF EXCAVATION**

SCALE 1:500

C-25

THIS PLAN IS ACCURATE FOR AERIALY DEPOSITED LEAD EXCAVATION AND EMBANKMENT WORK ONLY.

STATE OF CALIFORNIA - DEPARTMENT OF TRANSPORTATION
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 DATE REVISED




Dist	COUNTY	ROUTE	KILOMETER POST TOTAL PROJECT	SHEET No.	TOTAL SHEETS
07	LA	5	42.8/47.3	67	1073

2-24-09
 REGISTERED CIVIL ENGINEER DATE
 6-8-09
 PLANS APPROVAL DATE

MUNSHI MOHSIN
 No. 61916
 Exp. 9/30/09
 CIVIL
 STATE OF CALIFORNIA


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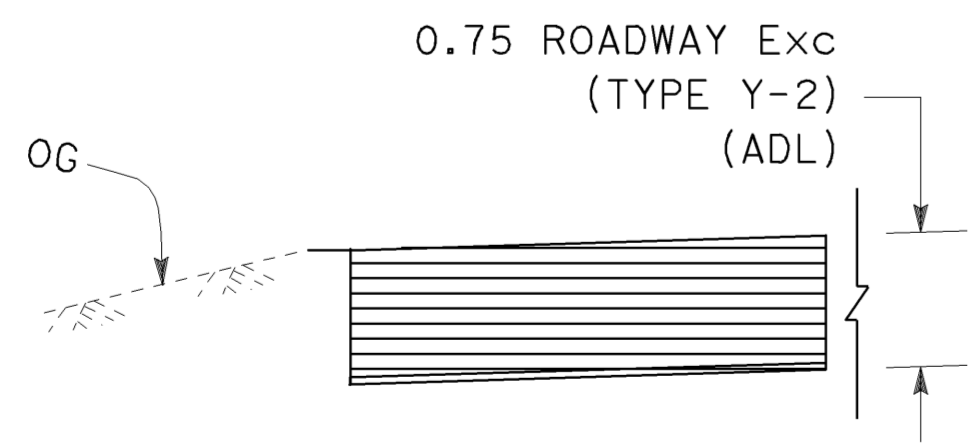
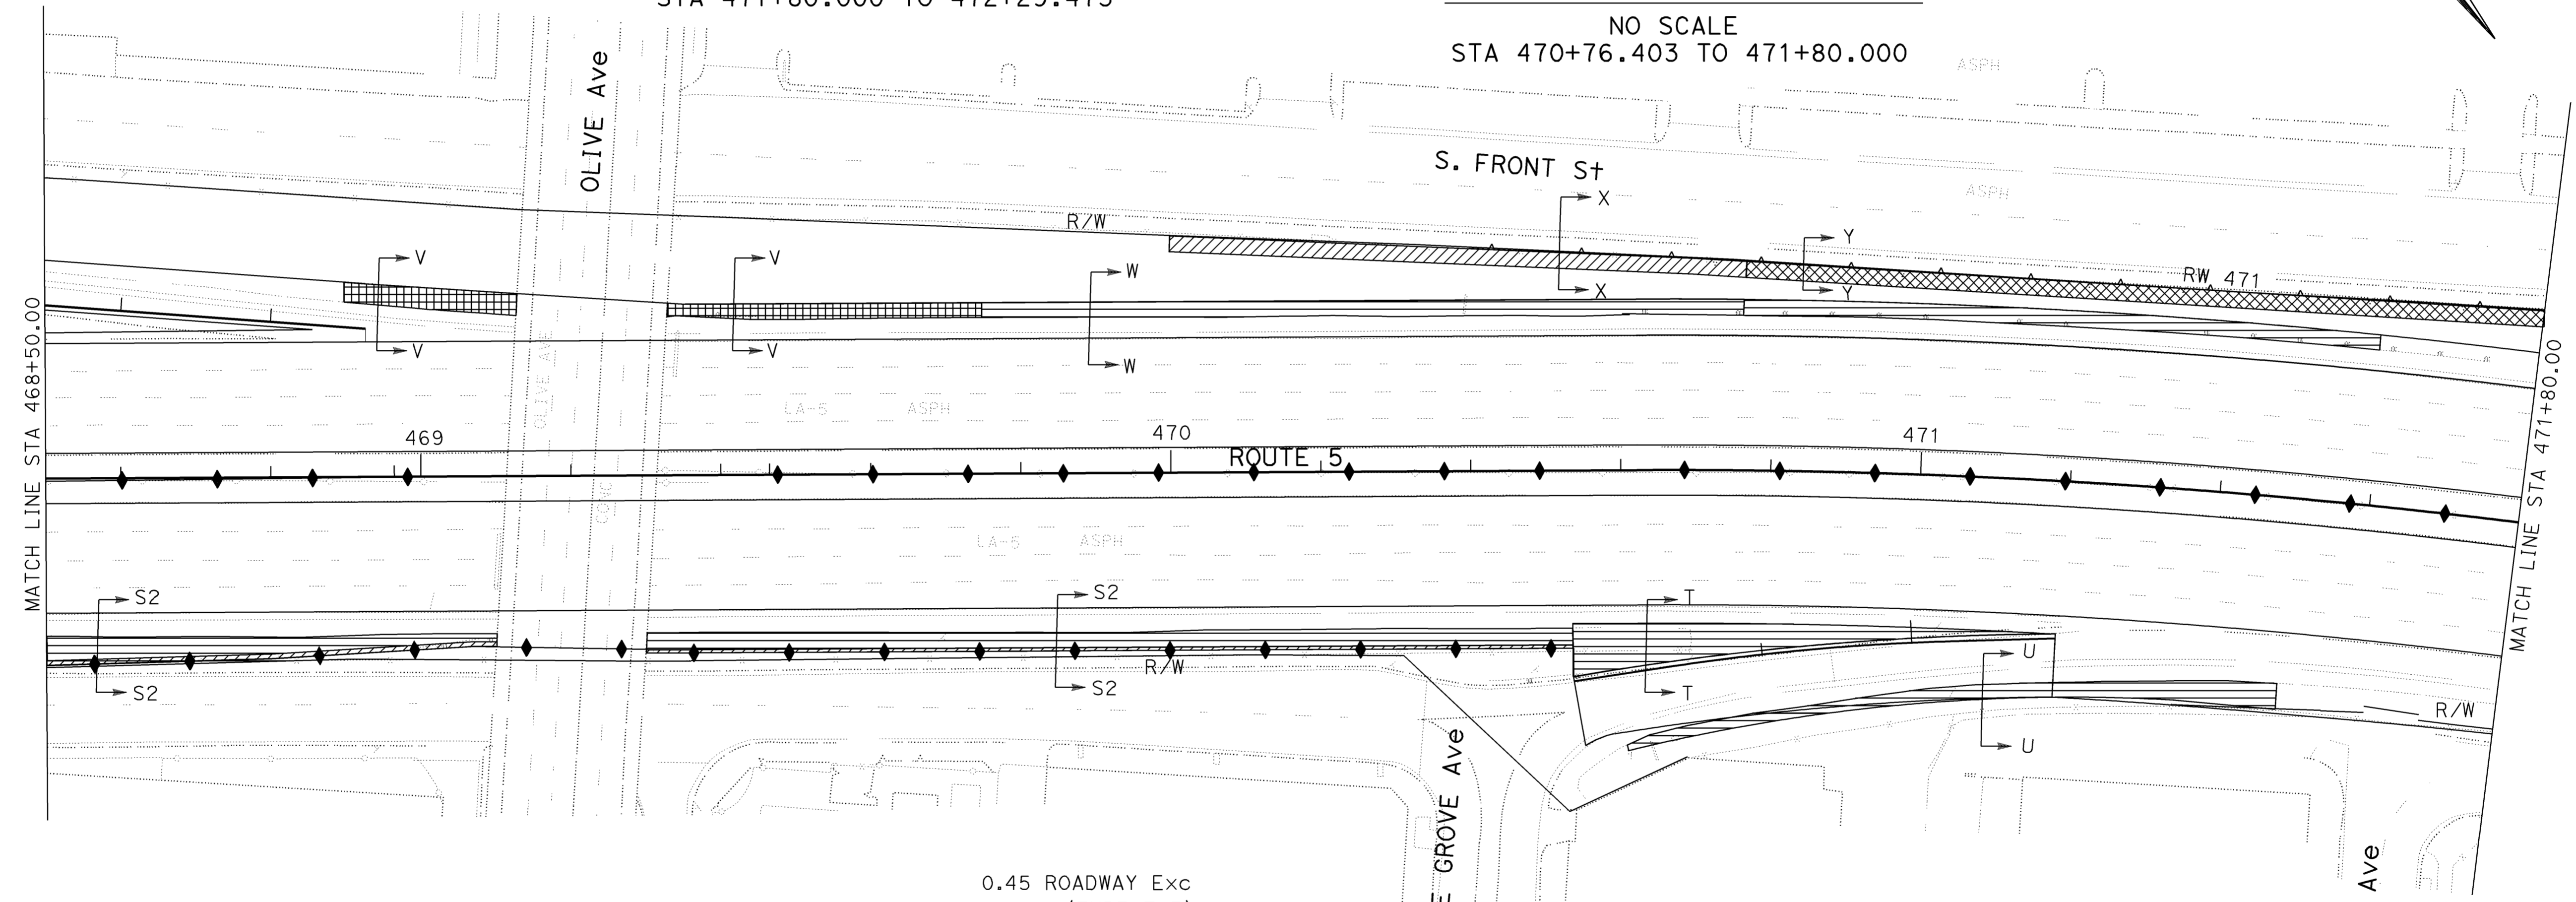
TYPICAL SECTION U-U
 NO SCALE

STA 470+60.782 TO 471+49.837
 STA 471+80.000 TO 472+29.473

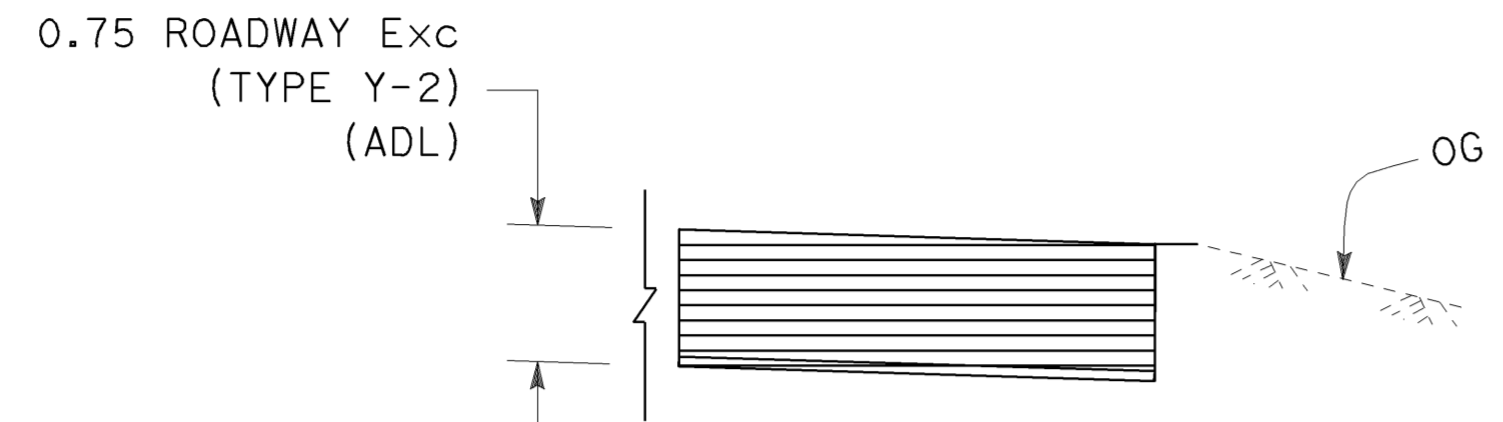


TYPICAL SECTION Y-Y
 NO SCALE

STA 470+76.403 TO 471+80.000

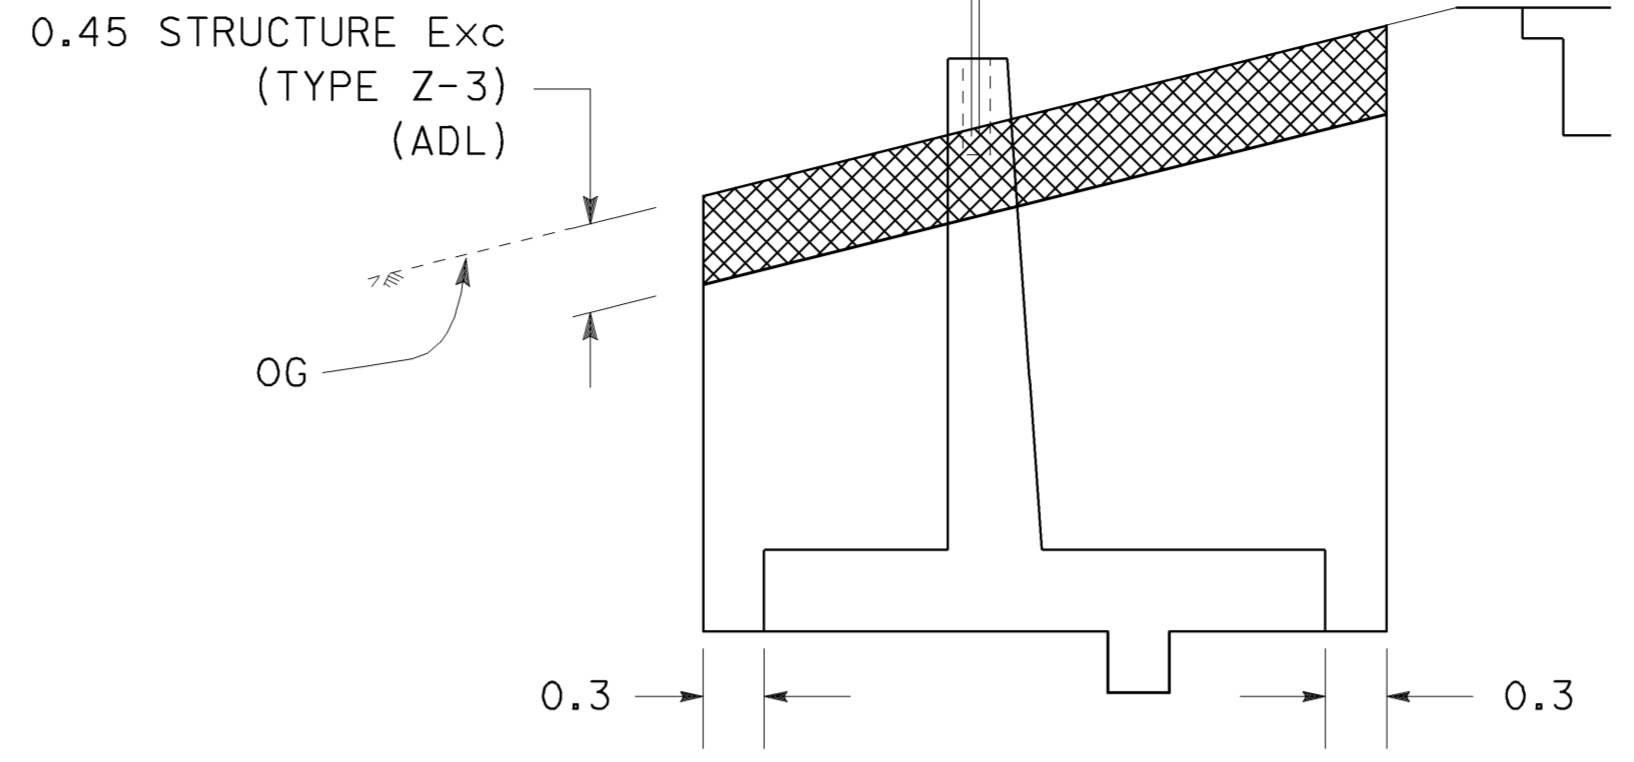


TYPICAL SECTION W-W
 NO SCALE

STA 469+74.868 TO 470+76.124

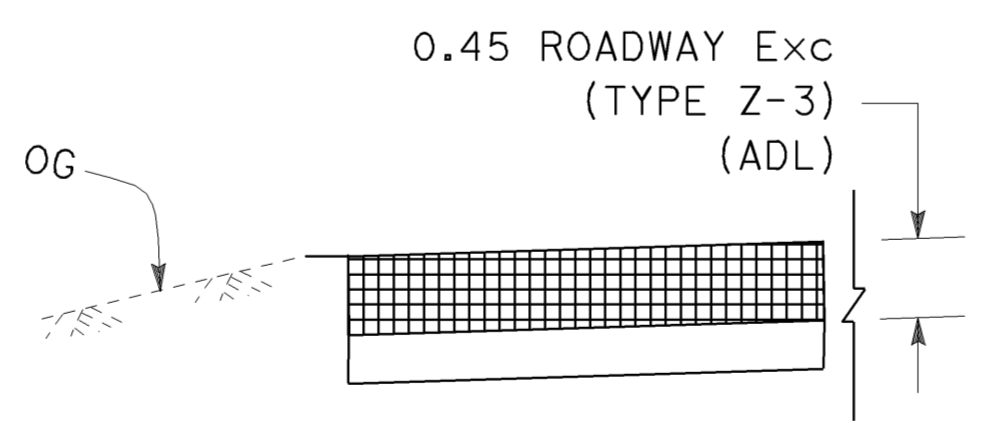


TYPICAL SECTION V-V
 NO SCALE

STA 468+89.868 TO 469+74.868

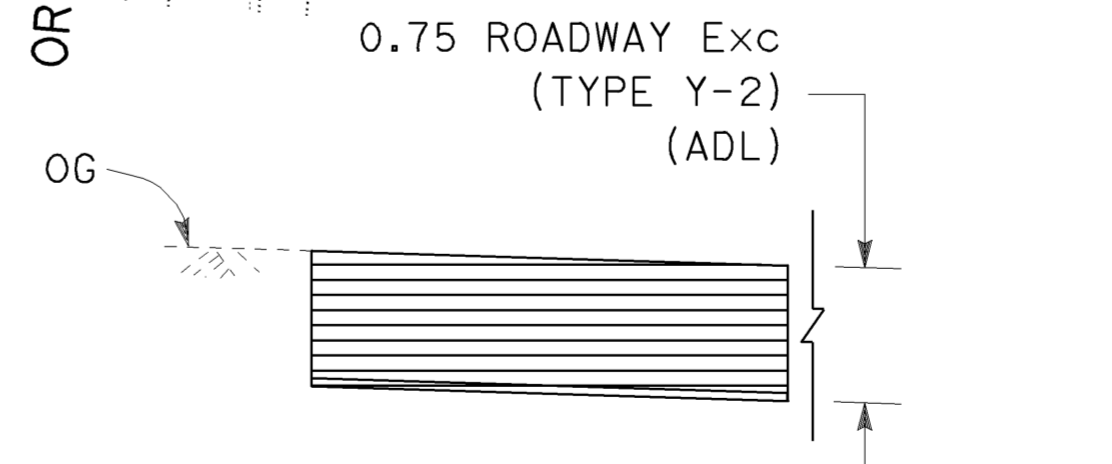

TYPICAL SECTION T-T
 NO SCALE

STA 470+53.470 TO 471+19.112

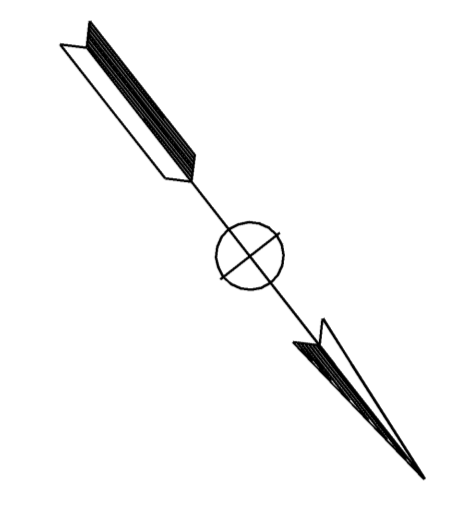

ALL DIMENSIONS ARE IN METERS
 UNLESS OTHERWISE SHOWN

**CONSTRUCTION DETAILS
 LOCATIONS OF EXCAVATION**

SCALE 1:500


C-26

THIS PLAN IS ACCURATE FOR AERIALY DEPOSITED LEAD EXCAVATION AND EMBANKMENT WORK ONLY.






Dist	COUNTY	ROUTE	KILOMETER POST TOTAL PROJECT	SHEET No.	TOTAL SHEETS
07	LA	5	42.8/47.3	68	1073

REGISTERED CIVIL ENGINEER DATE 2-24-09
 PLANS APPROVAL DATE 6-8-09
 REGISTERED PROFESSIONAL ENGINEER
 MUNSHI MOHSIN
 No. 61916
 Exp. 9/30/09
 CIVIL
 STATE OF CALIFORNIA
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TYPICAL SECTION X-X

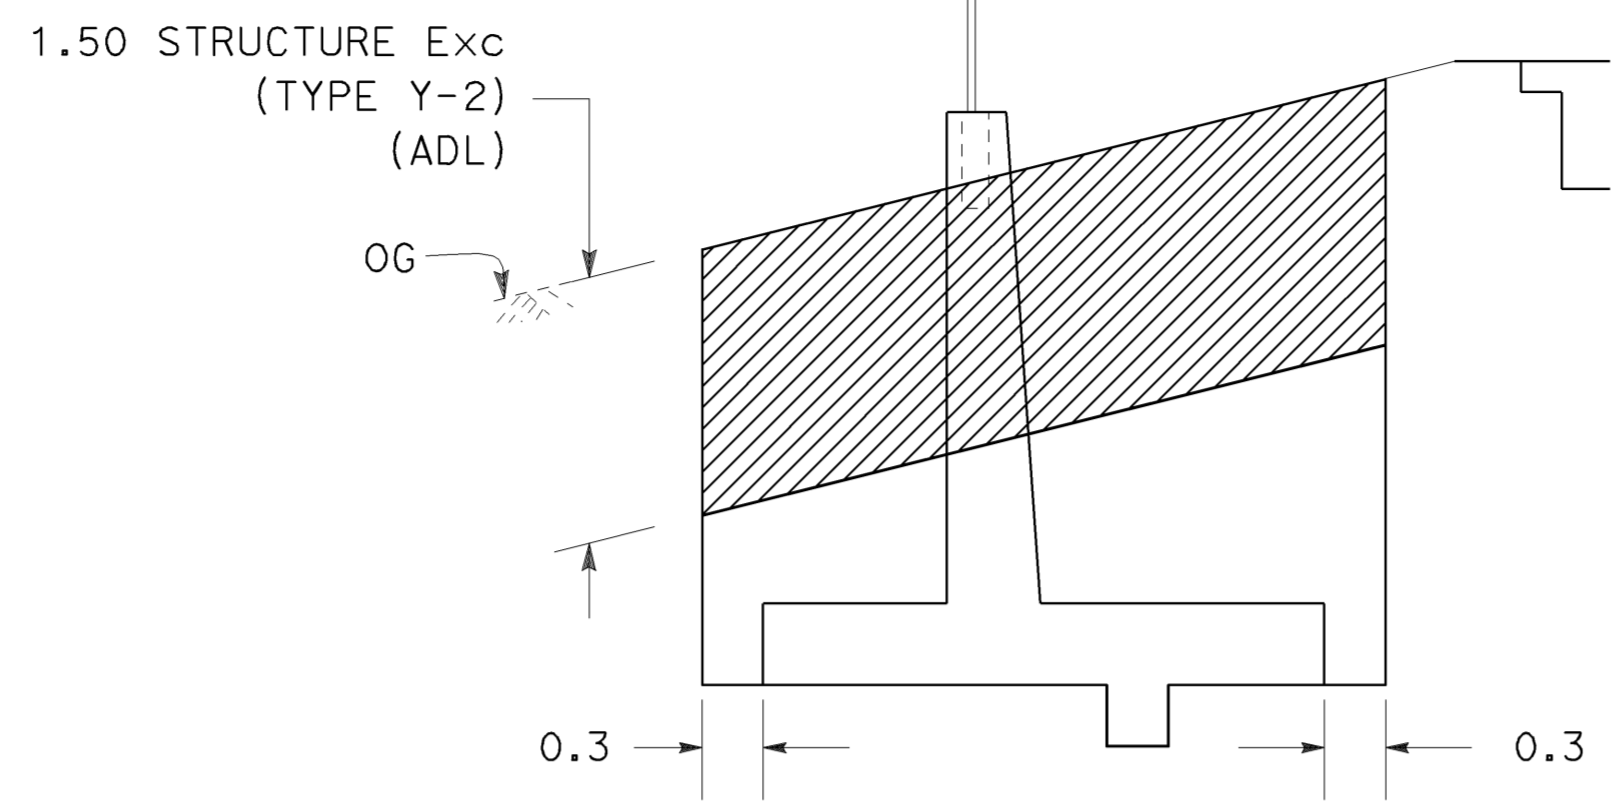NO SCALE
 STA 470+00.000 TO 470+76.403
 STA 471+80.000 TO 472+53.900



TYPICAL SECTION Z-Z

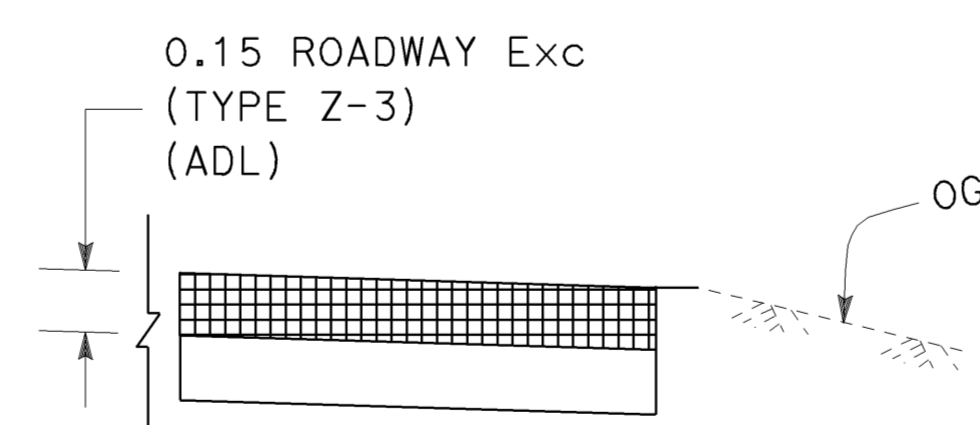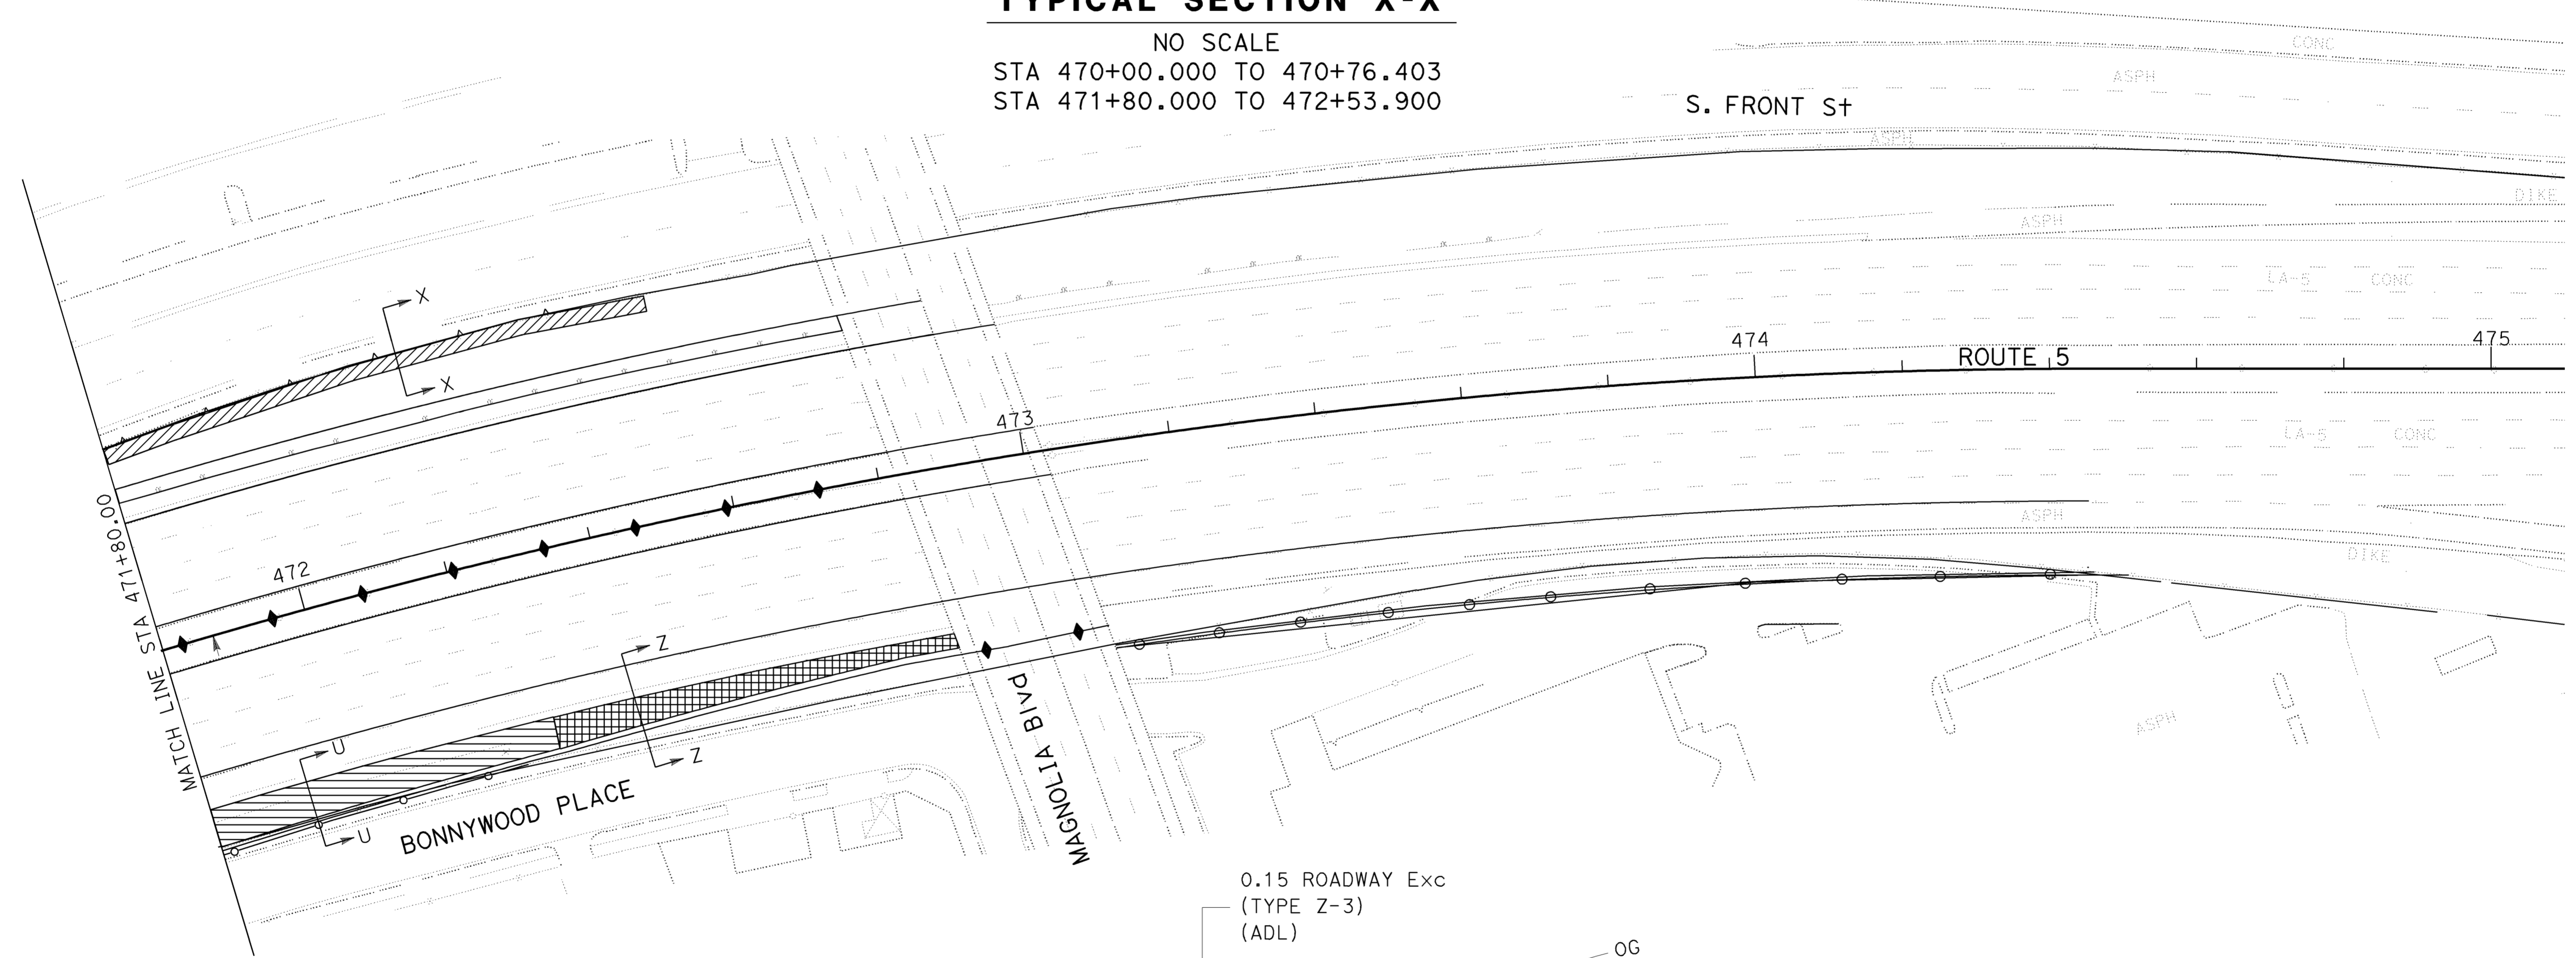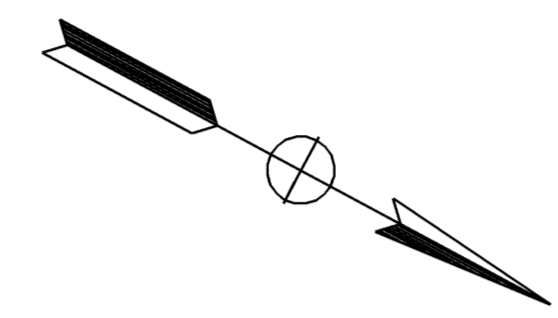NO SCALE
 STA 472+29.473 TO 472+86.894

NOTE:
 1. FOR COMPLETE RIGHT OF WAY AND ACCURATE ACCESS DATA, SEE RIGHT OF WAY RECORD MAPS AT DISTRICT OFFICE.

ALL DIMENSIONS ARE IN METERS
 UNLESS OTHERWISE SHOWN

**CONSTRUCTION DETAILS
 LOCATIONS OF EXCAVATION**

SCALE 1:500

C-27




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 CHECKED BY
 CUONG T TRAN
 MUNSHI MOHSIN
 REVISIONS
 CTT
 03-09



Dist	COUNTY	ROUTE	KILOMETER POST TOTAL PROJECT	SHEET No.	TOTAL SHEETS
07	LA	5	42.8/47.3	69	1073


REGISTERED CIVIL ENGINEER DATE 2-24-09
 PLANS APPROVAL DATE 6-8-09
 REGISTERED PROFESSIONAL ENGINEER
 MUNSHI MOHSIN
 No. 61916
 Exp. 9/30/09
 CIVIL
 STATE OF CALIFORNIA
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MATERIAL WITH AERIALY DEPOSITED LEAD

ALL DIMENSIONS ARE IN METERS
 UNLESS OTHERWISE SHOWN
CONSTRUCTION DETAILS
EMBANKMENT
 NO SCALE
C-28

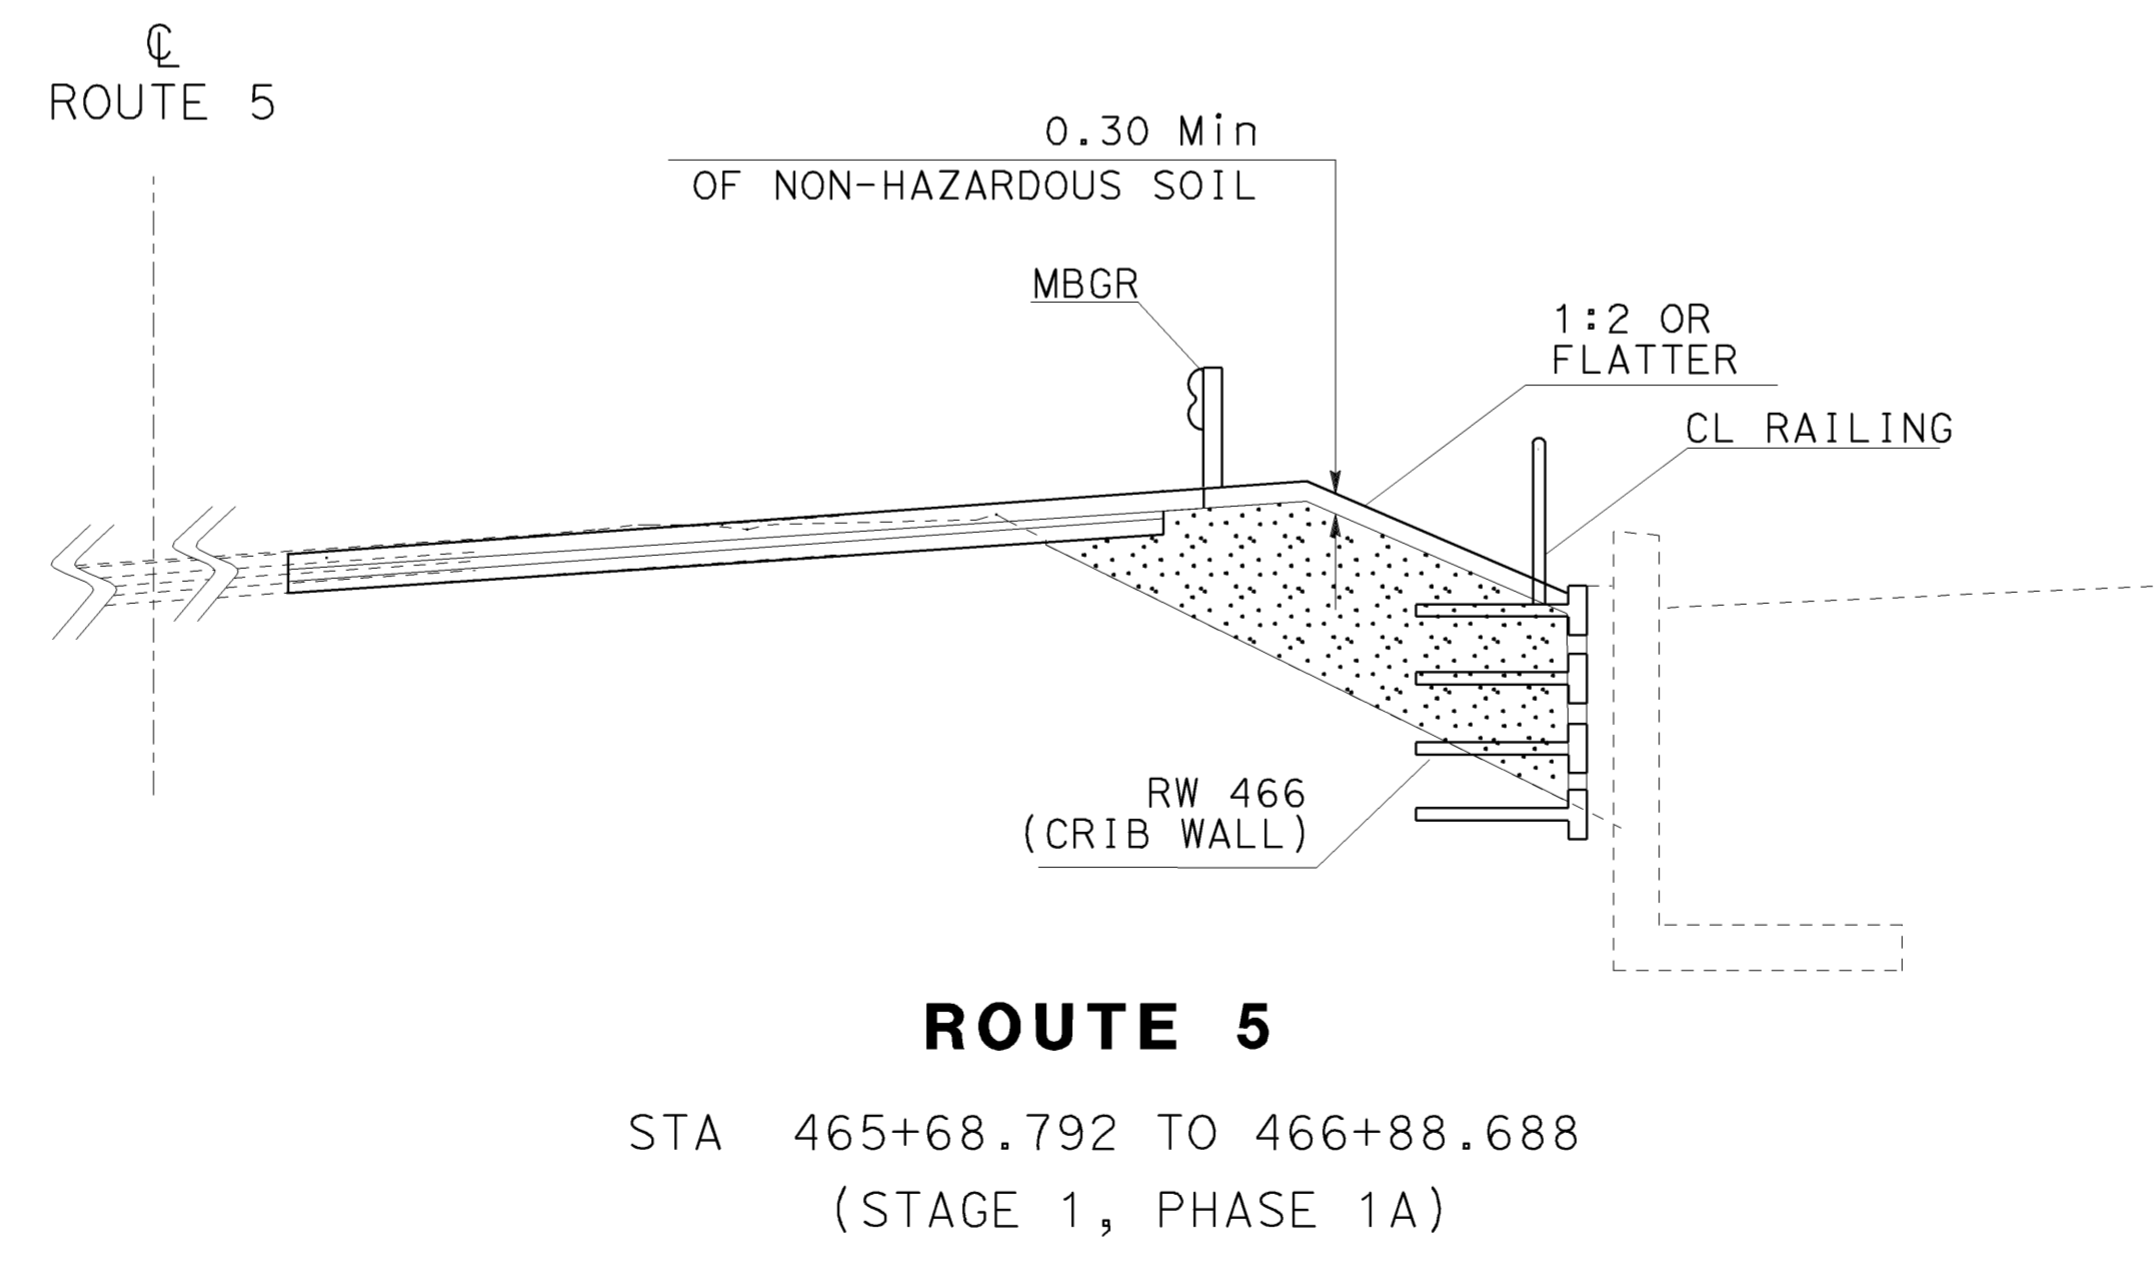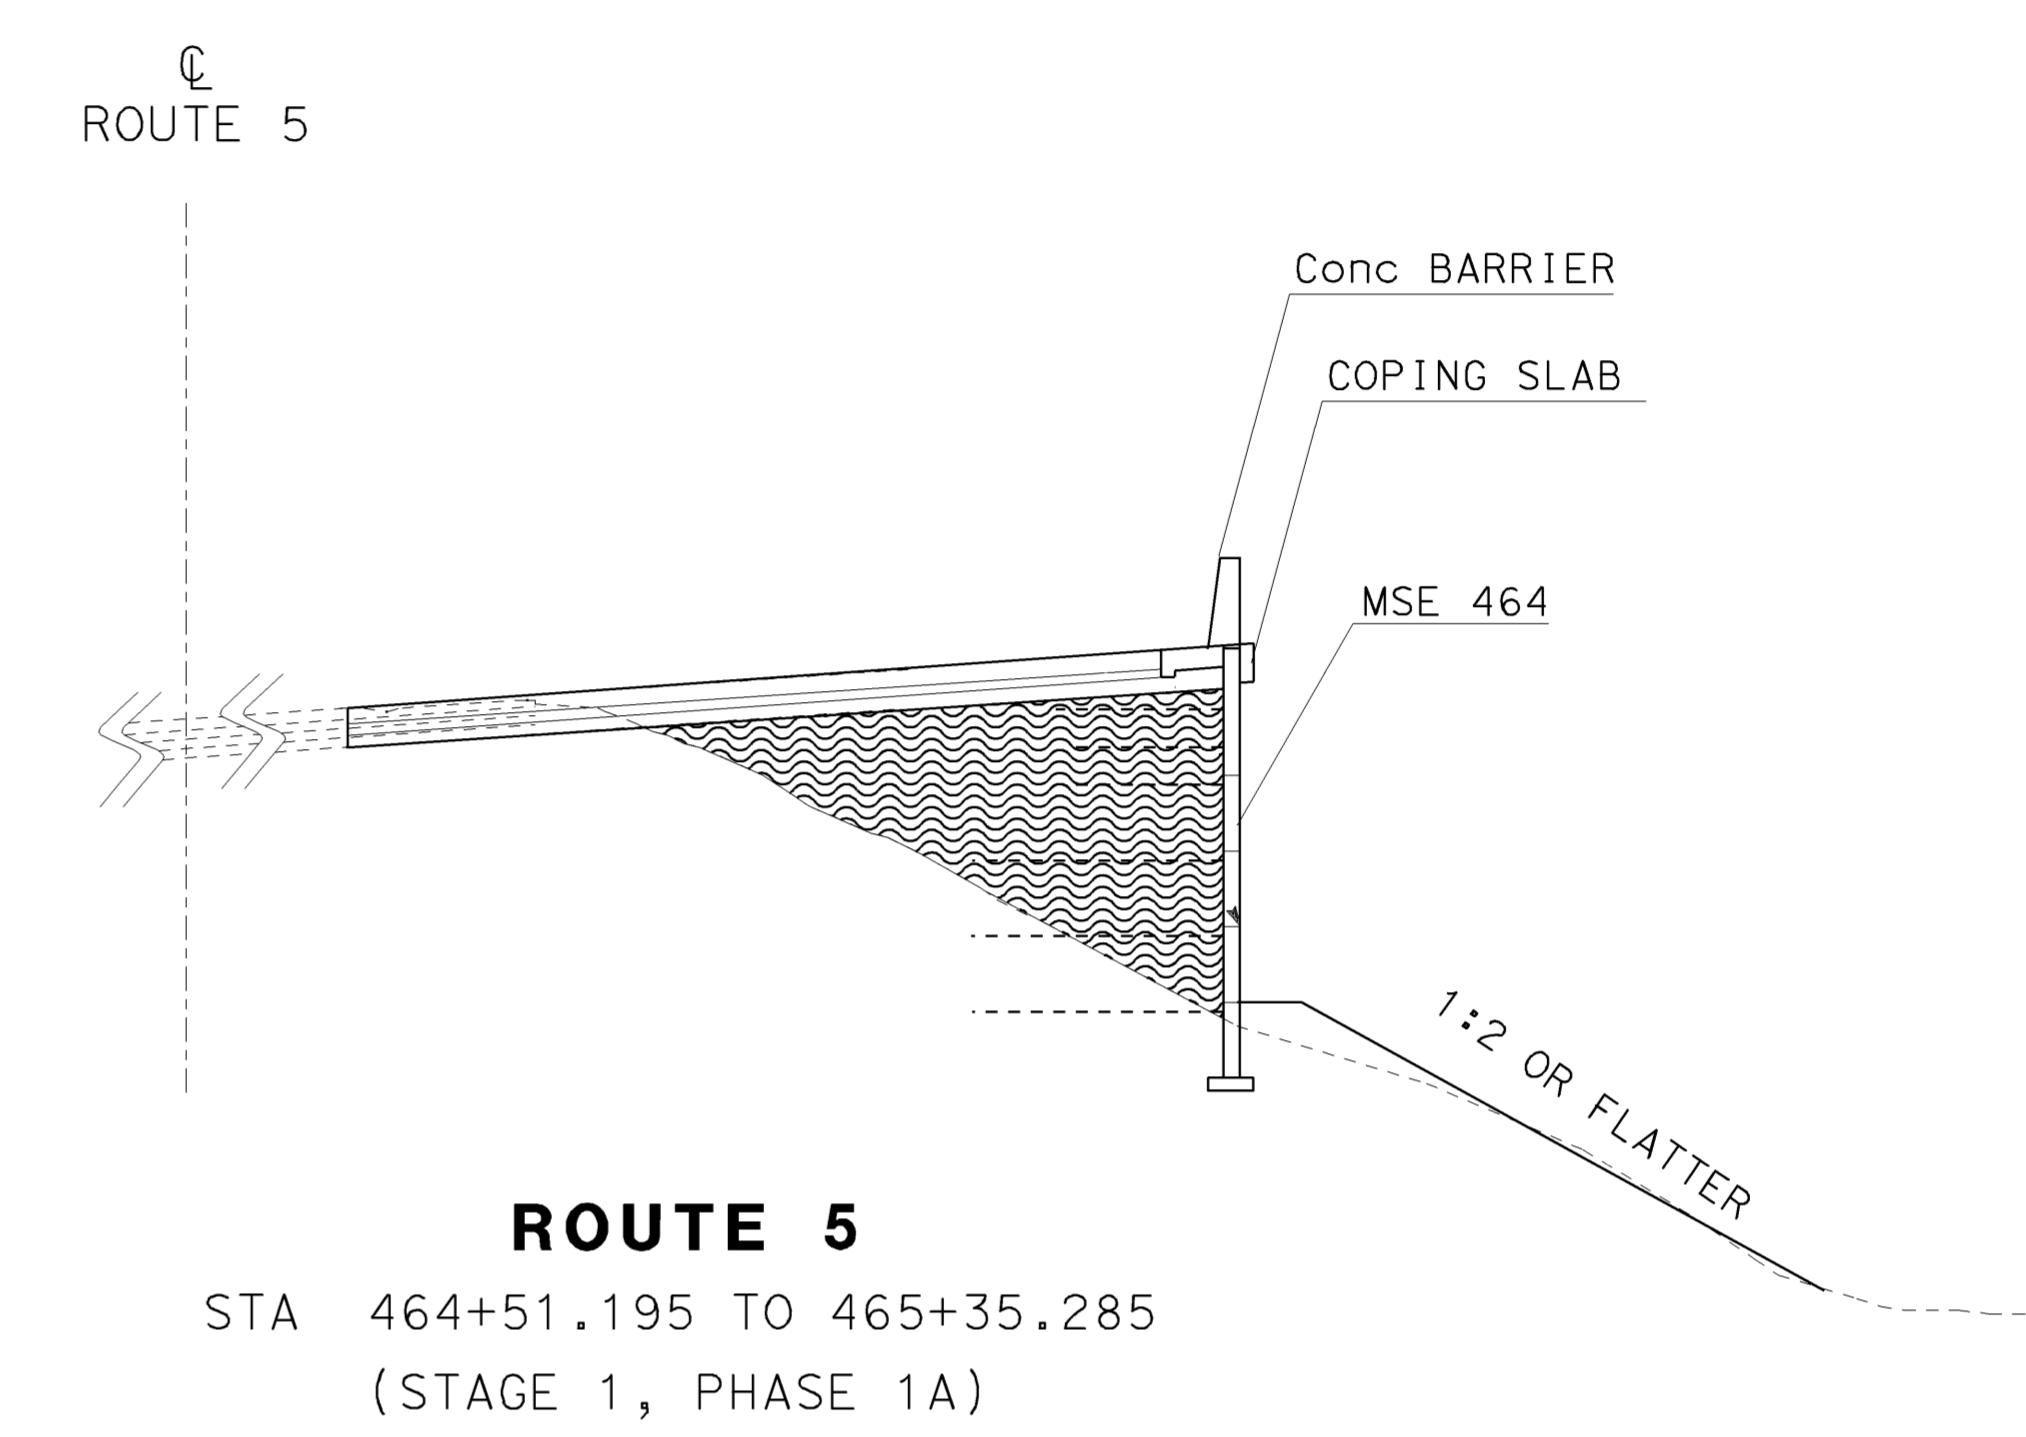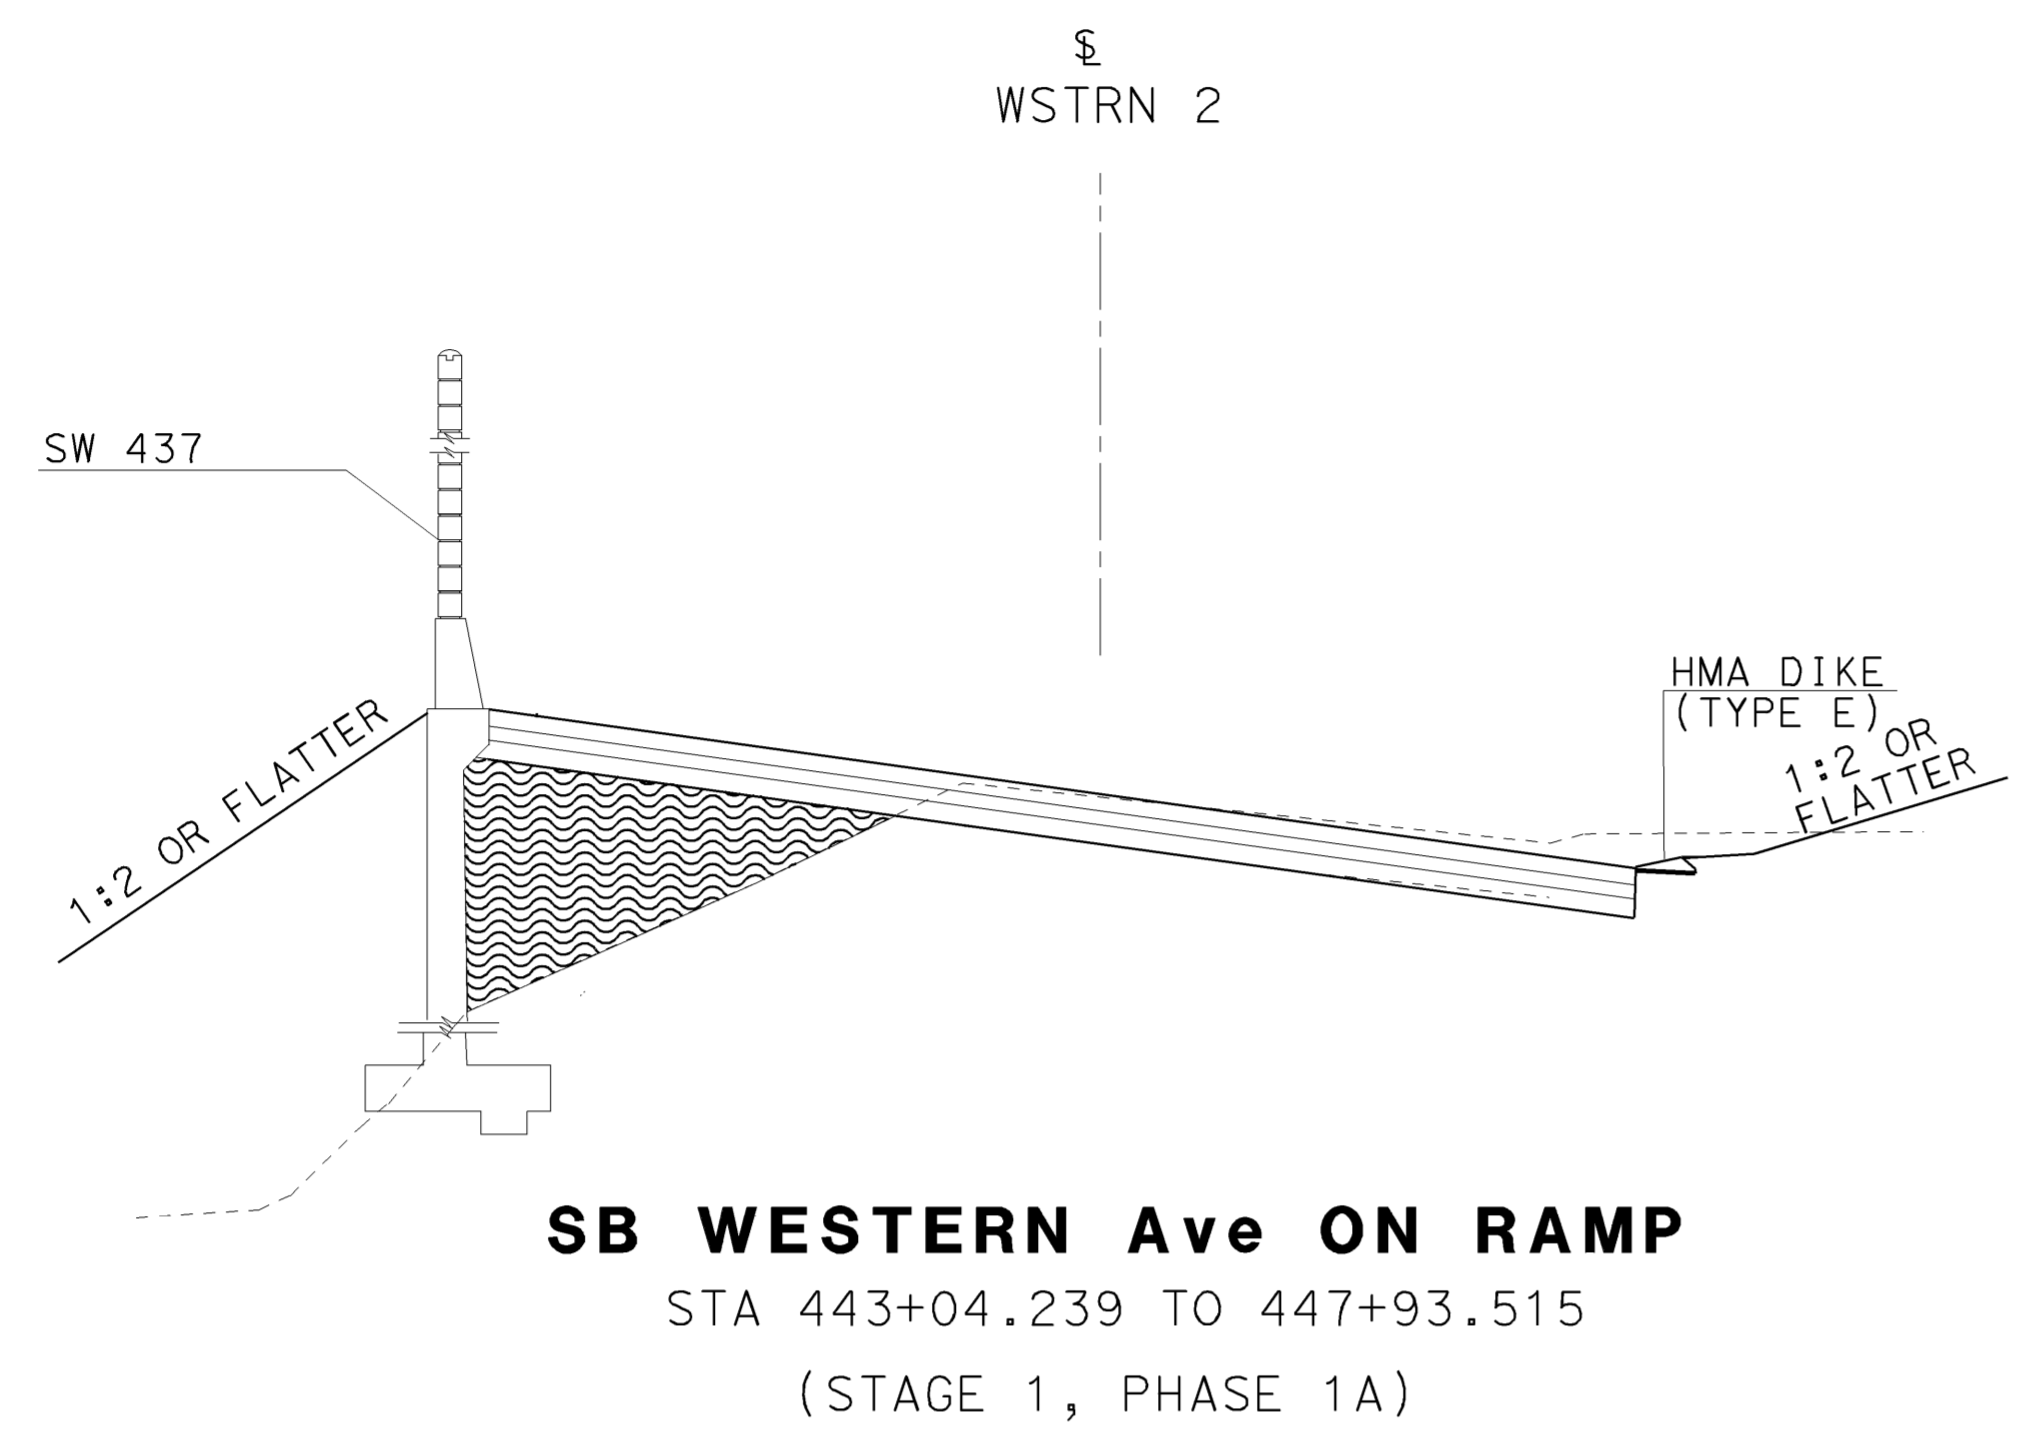THIS PLAN IS ACCURATE FOR AERIALY DEPOSITED LEAD EXCAVATION AND EMBANKMENT WORK ONLY.




Dist	COUNTY	ROUTE	KILOMETER POST TOTAL PROJECT	SHEET No.	TOTAL SHEETS
07	LA	5	42.8/47.3	70	1073
 REGISTERED CIVIL ENGINEER				2-24-09	DATE
PLANS APPROVAL DATE				6-8-09	
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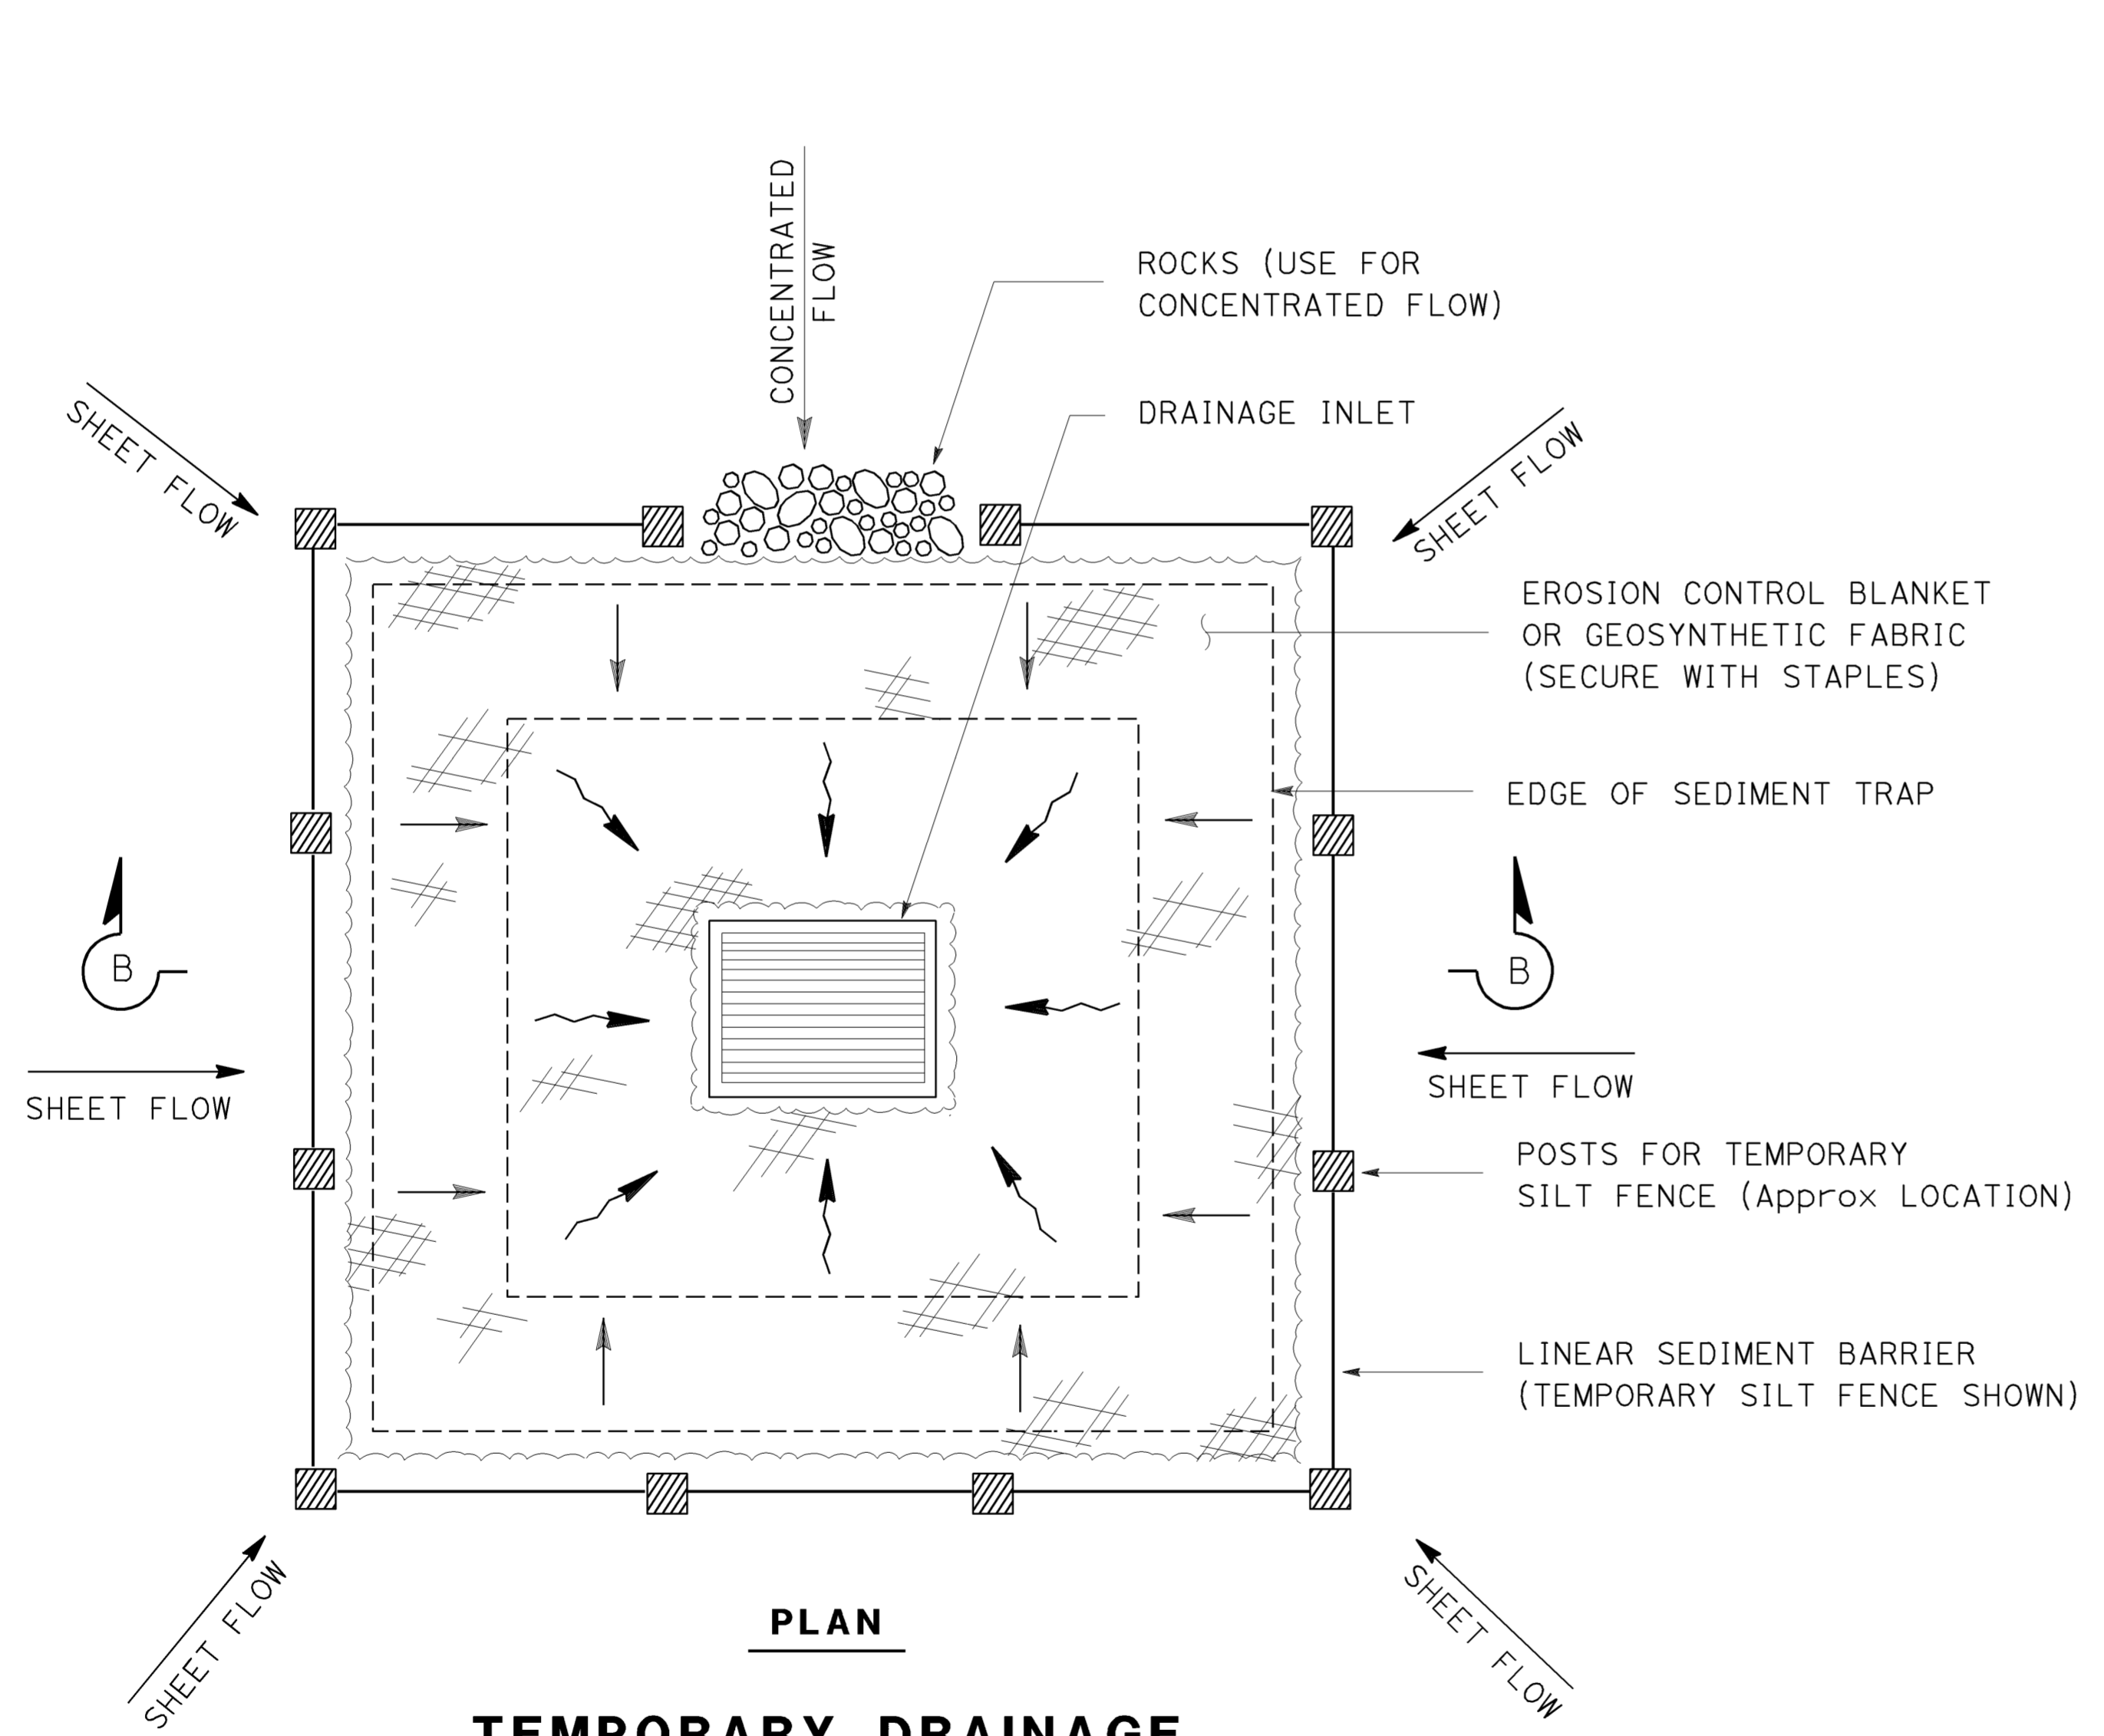

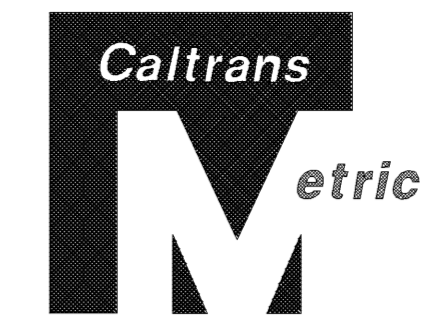
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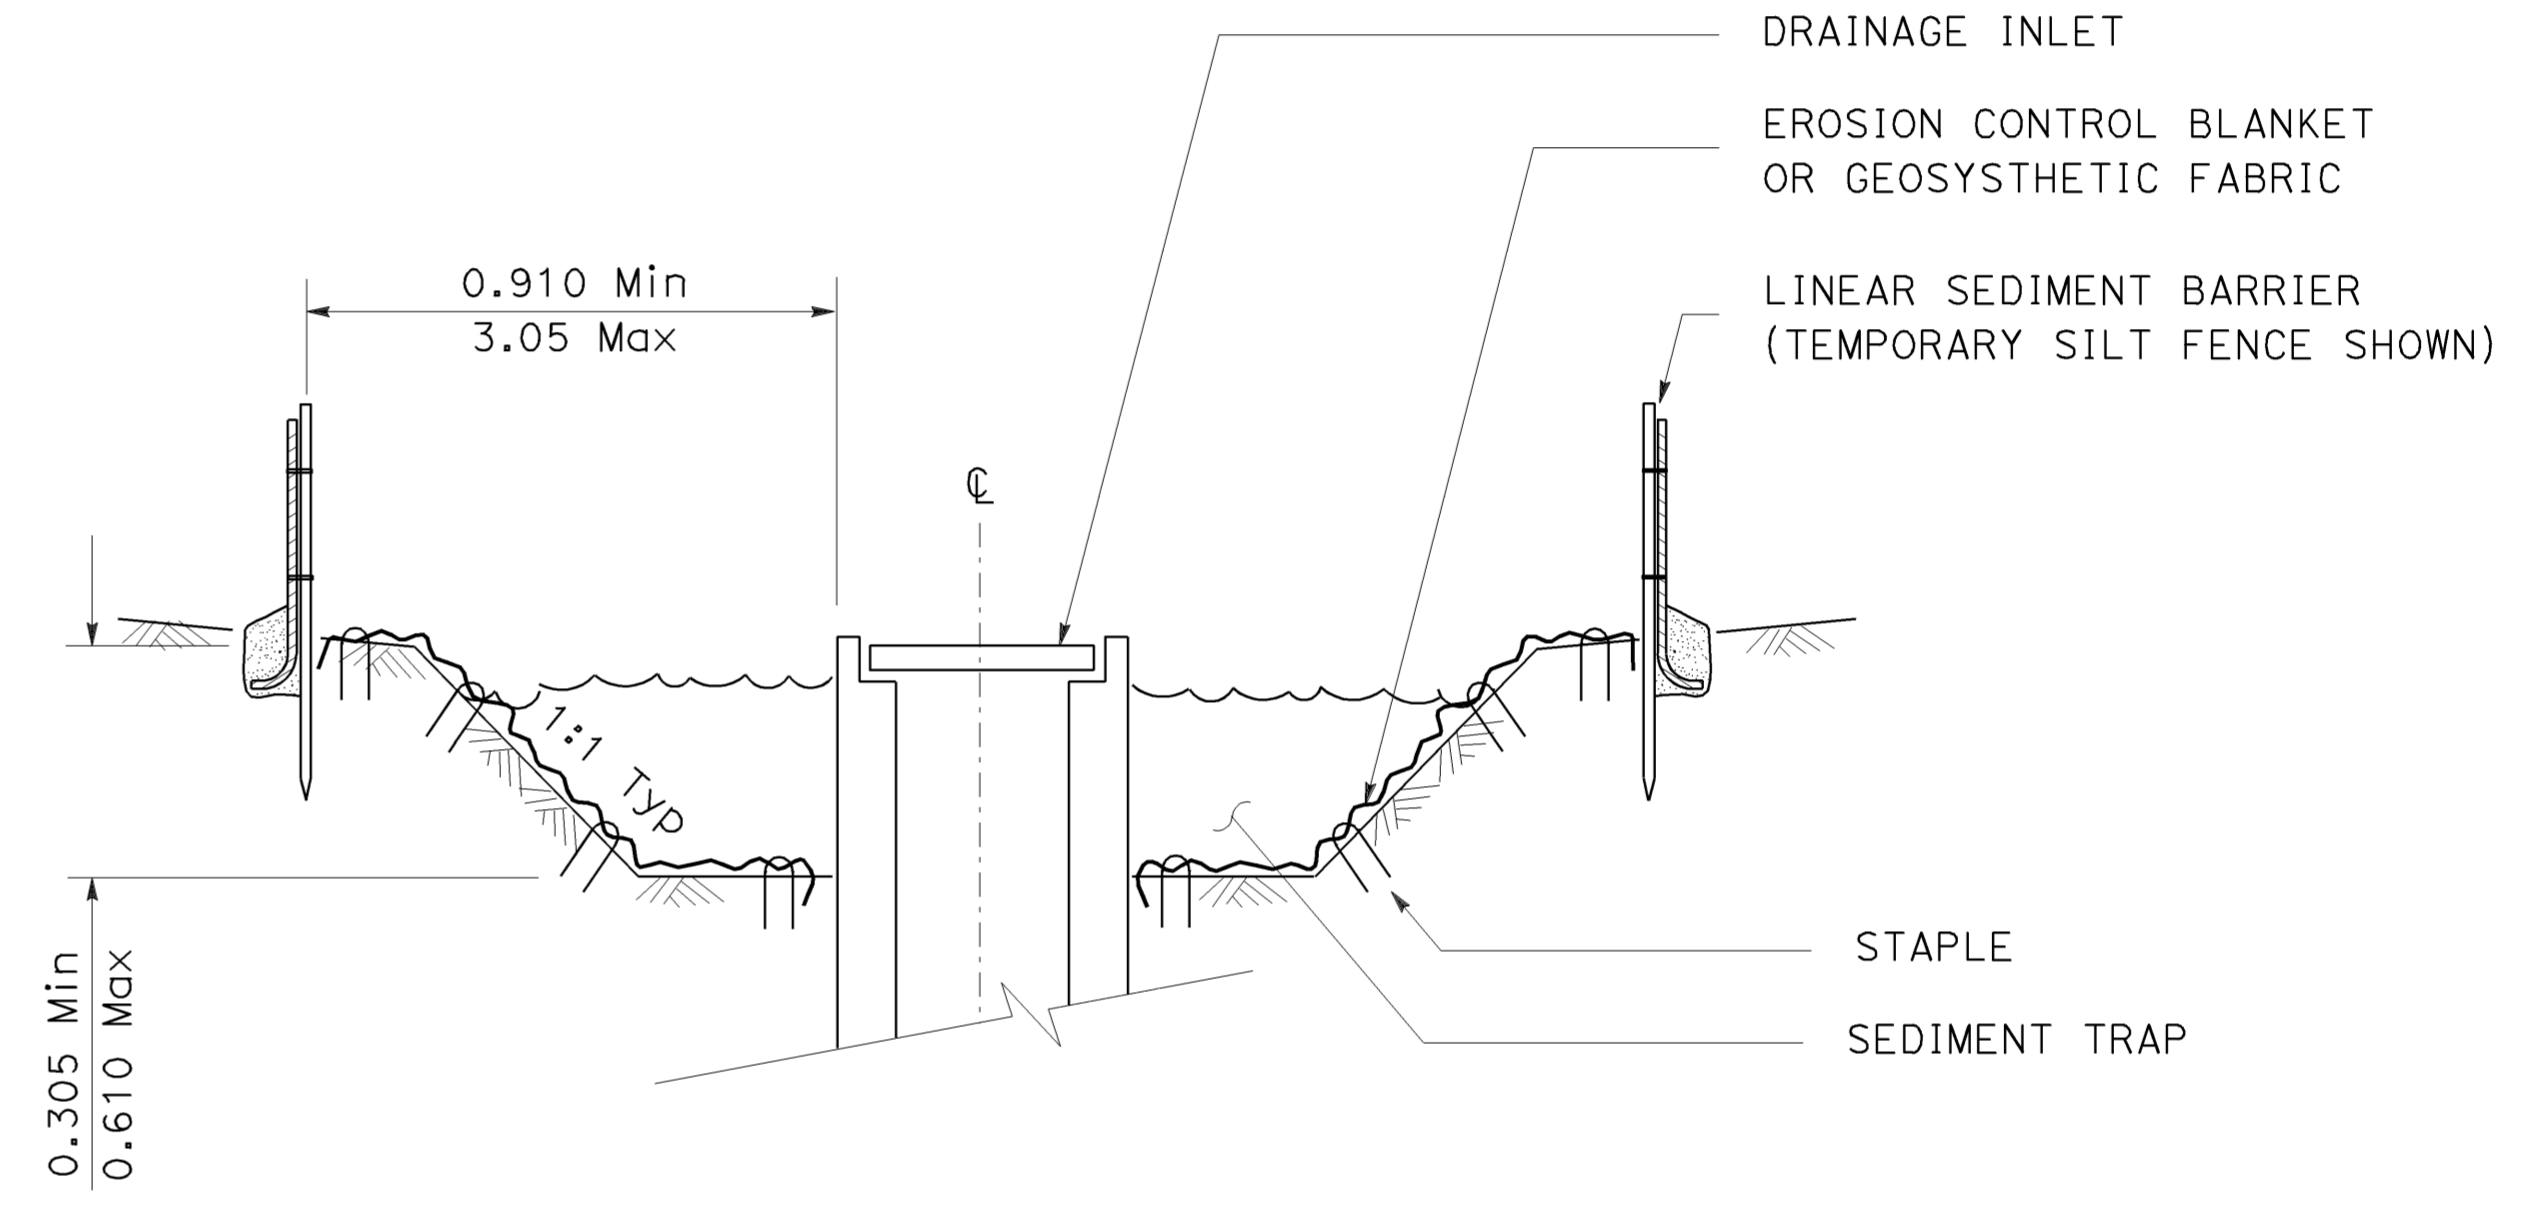
1. SEE STANDARD PLAN T51 FOR TEMPORARY SILT FENCE.
2. DIMENSIONS MAY VARY TO FIT FIELD CONDITIONS.



STAPLE DETAIL

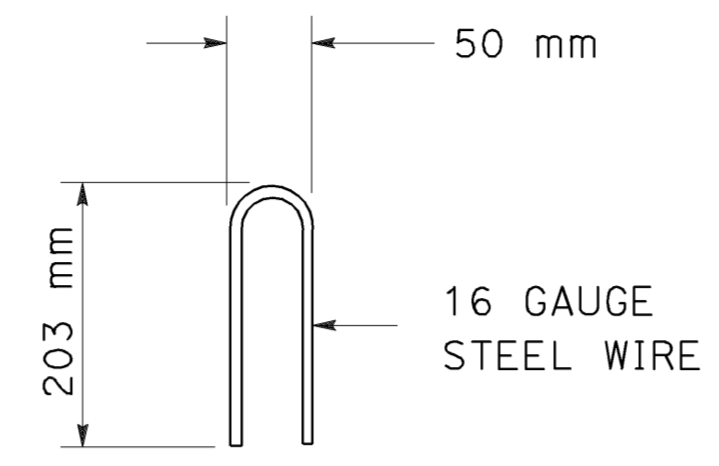

TEMPORARY DRAINAGE INLET PROTECTION (TYPE 2) (EXCAVATED SEDIMENT TRAP)



SECTION B-B

ALL DIMENSIONS ARE IN METERS UNLESS OTHERWISE SHOWN

CONSTRUCTION DETAILS
TEMPORARY DRAINAGE INLET PROTECTION

NO SCALE **C-29**




Dist	COUNTY	ROUTE	KILOMETER POST TOTAL PROJECT	SHEET No.	TOTAL SHEETS
07	LA	5	42.8/47.3	71	1073

REGISTERED CIVIL ENGINEER	DATE
<i>M. S.</i>	12-17-08
PLANS APPROVAL DATE	
6-8-09	

REGISTERED PROFESSIONAL ENGINEER
BALDEV K. BHALLA
No. 34350
Exp. 9/30/09
CIVIL

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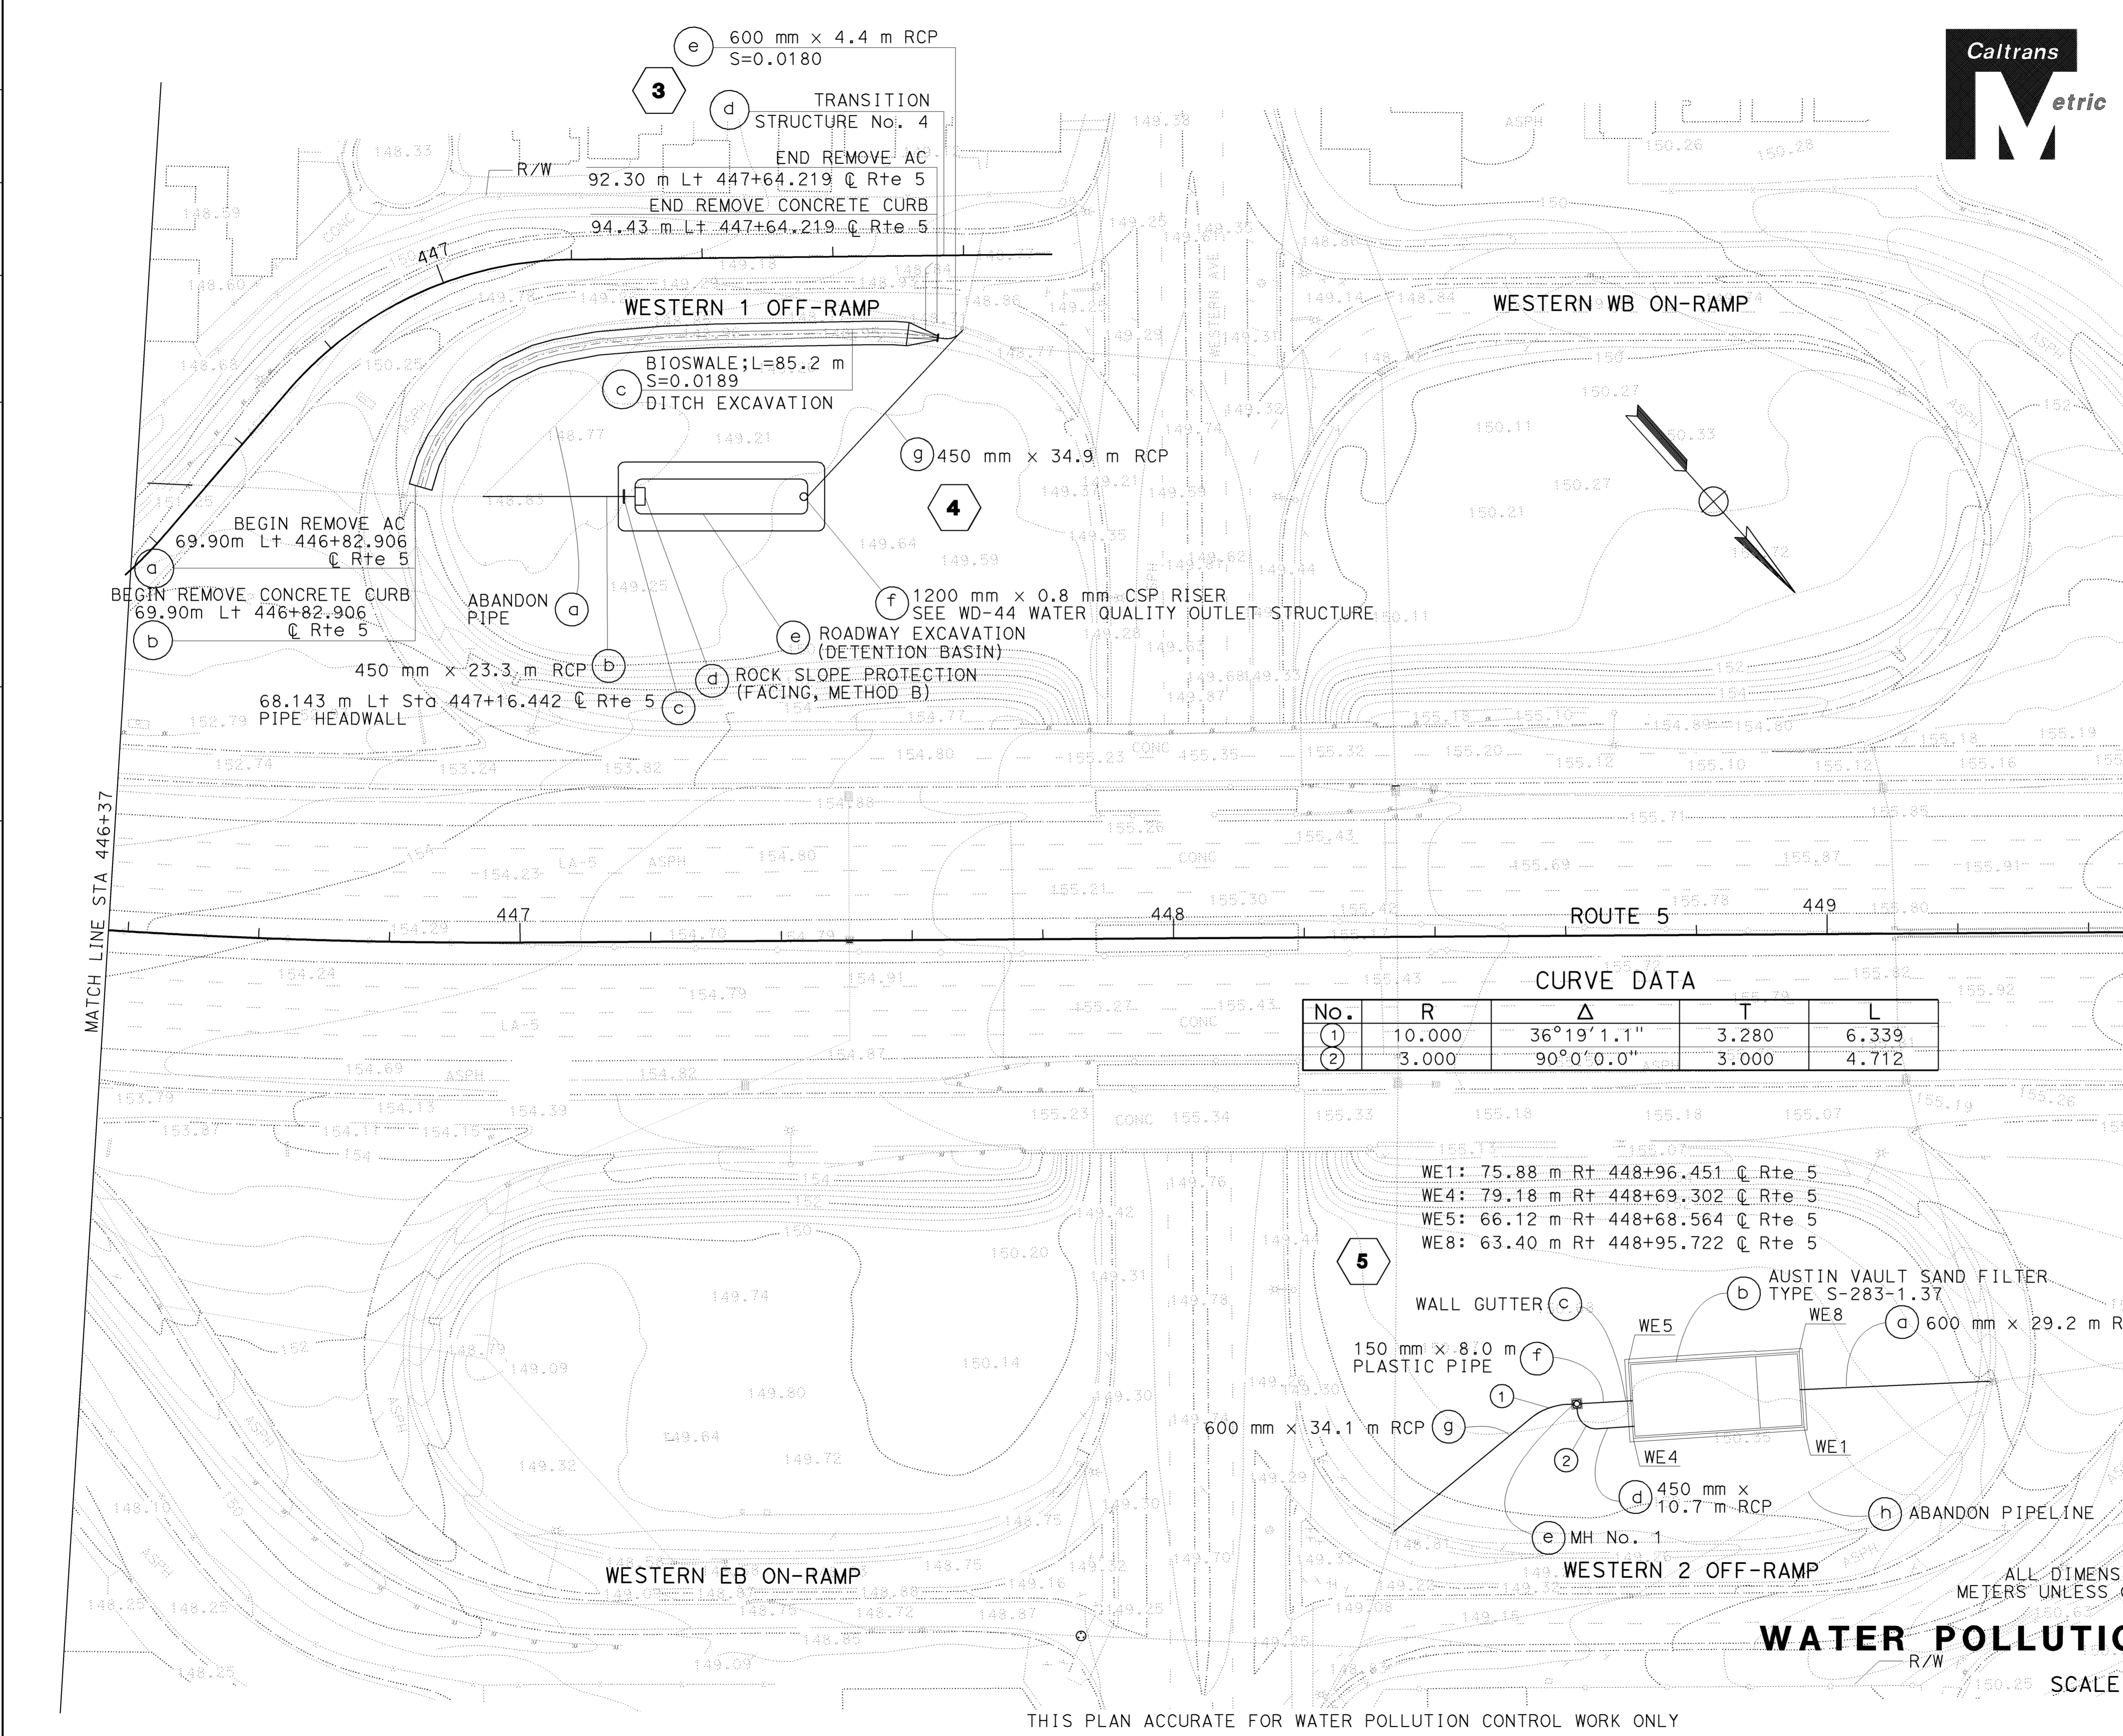
ALL DIMENSIONS ARE IN METERS UNLESS OTHERWISE SHOWN

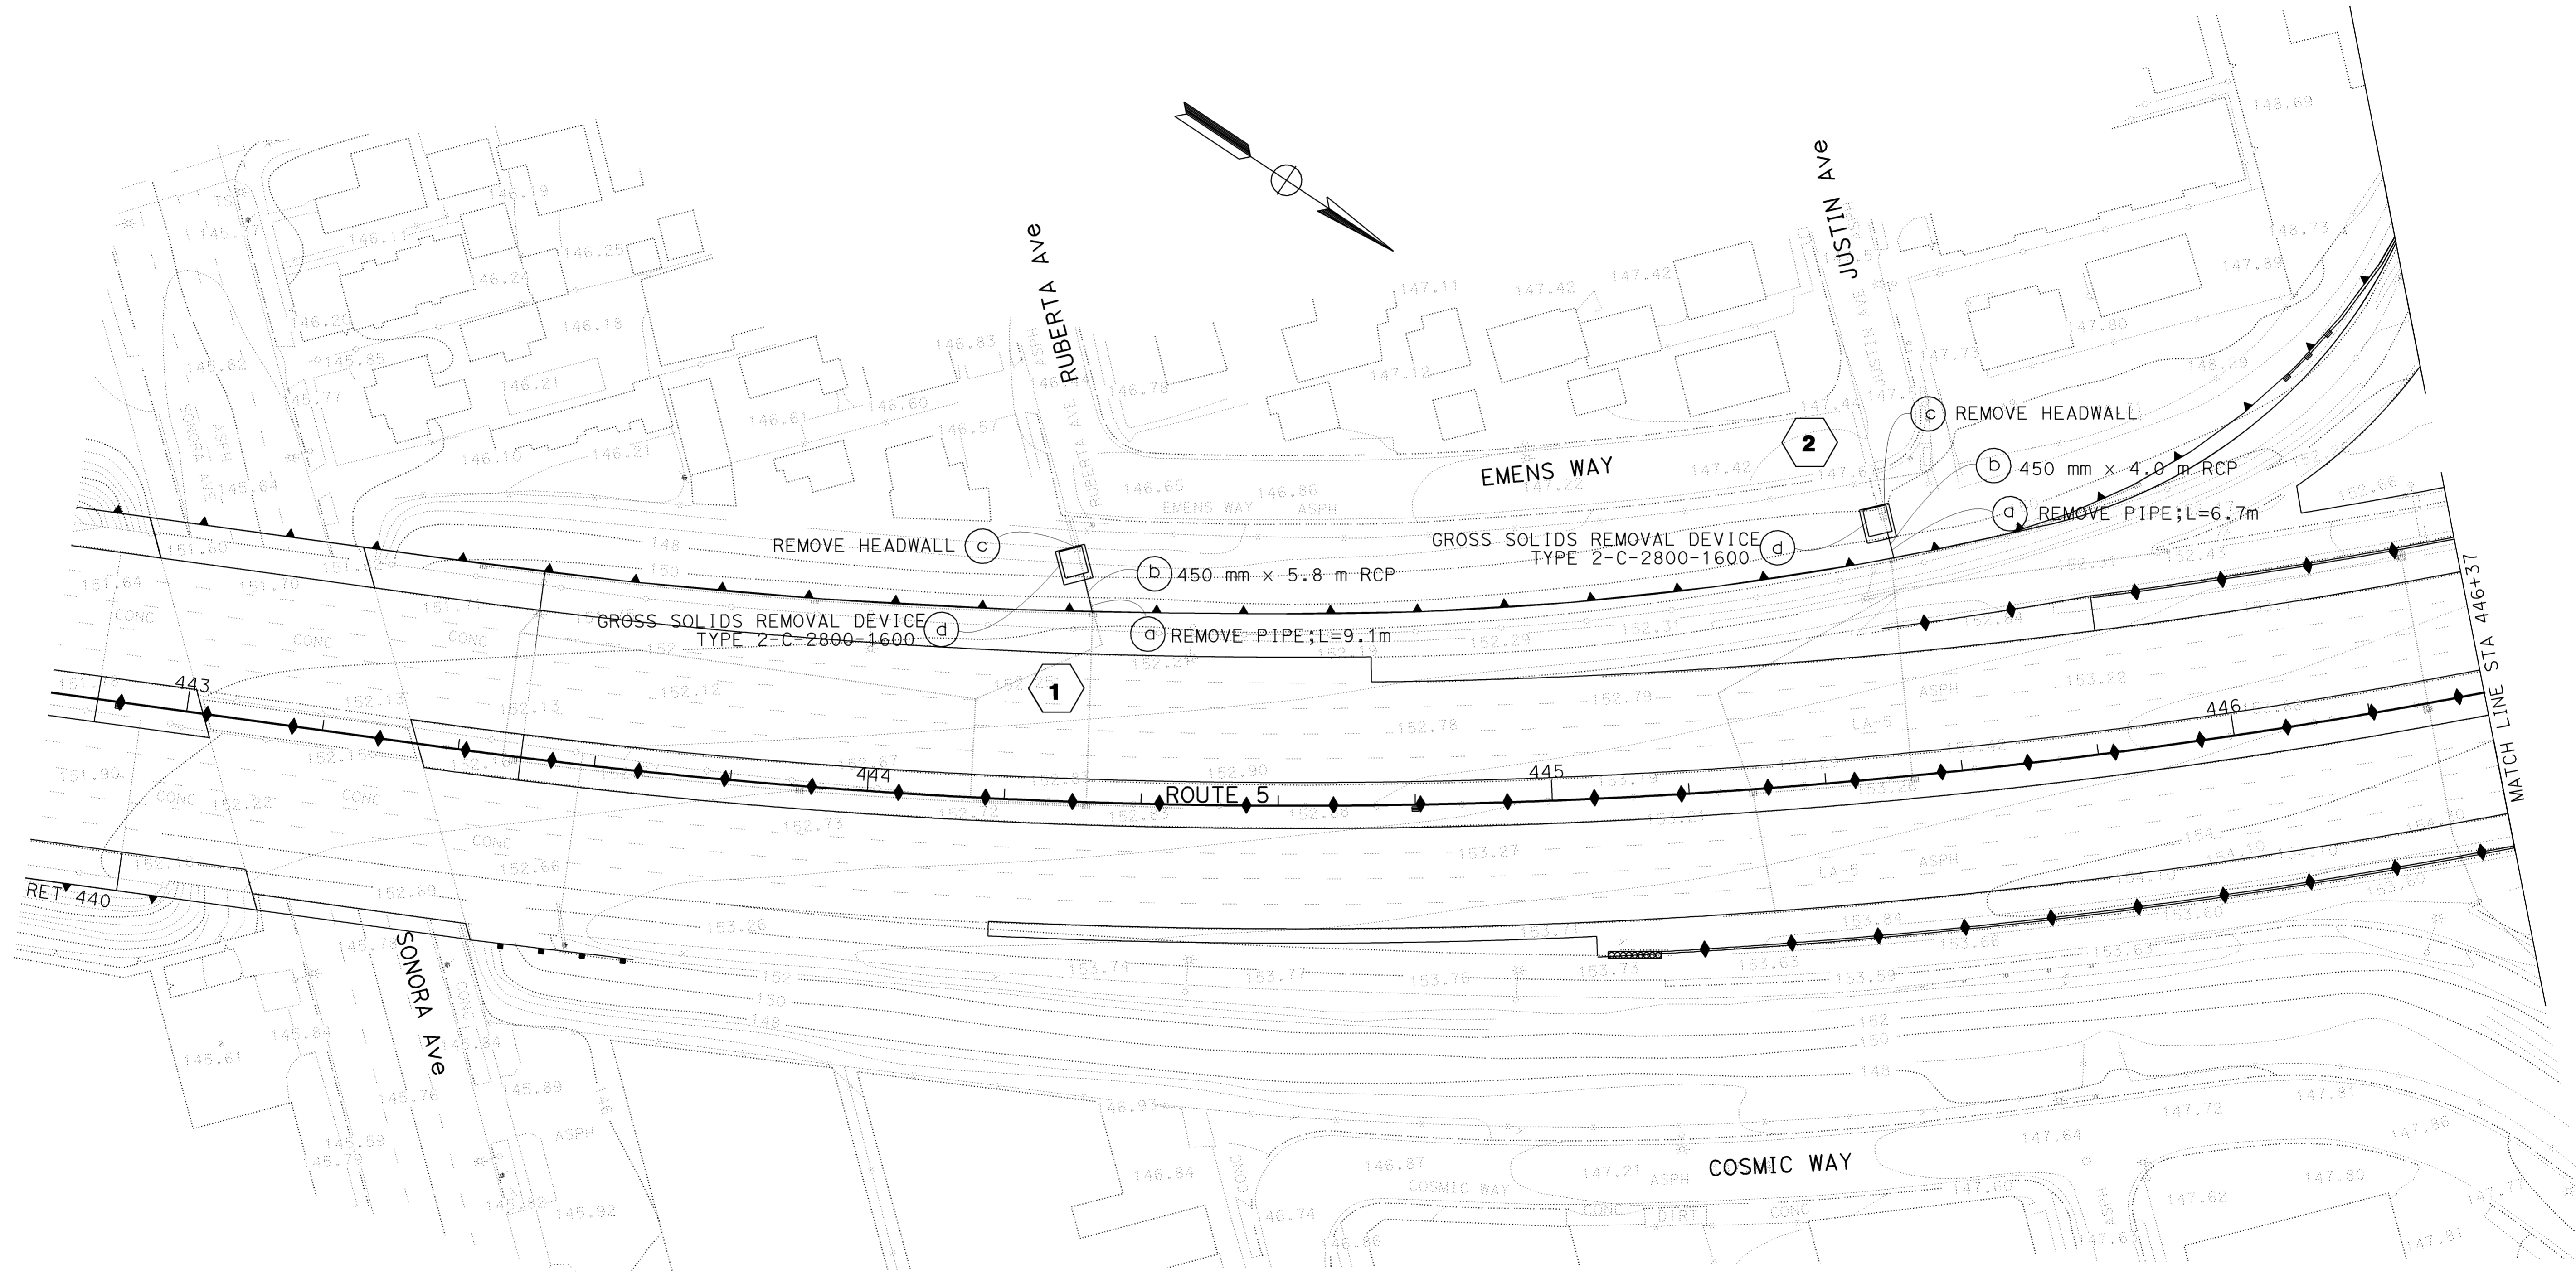WATER POLLUTION CONTROL PLAN

SCALE 1:500

W-1

THIS PLAN ACCURATE FOR WATER POLLUTION CONTROL WORK ONLY



Dist	COUNTY	ROUTE	KILOMETER POST TOTAL PROJECT	SHEET No.	TOTAL SHEETS
07	LA	5	42.8/47.3	72	1073

12-17-08
 REGISTERED CIVIL ENGINEER DATE
 6-8-09
 PLANS APPROVAL DATE

BALDEV K. BHALLA
 No. 34350
 Exp. 9/30/09
 CIVIL
 STATE OF CALIFORNIA

Caltrans
Metric

CURVE DATA

No.	R	Δ	T	L
(1)	10.000	36°19'1.1"	3.280	6.339
(2)	3.000	90°0'0.0"	3.000	4.712

- WE1: 75.88 m Rt 448+96.451 C Rte 5
- WE4: 79.18 m Rt 448+69.302 C Rte 5
- WE5: 66.12 m Rt 448+68.564 C Rte 5
- WE8: 63.40 m Rt 448+95.722 C Rte 5

ALL DIMENSIONS ARE IN METERS UNLESS OTHERWISE SHOWN

WATER POLLUTION CONTROL PLAN



SCALE 1:500

W-2



Dist	COUNTY	ROUTE	KILOMETER POST TOTAL PROJECT	SHEET No.	TOTAL SHEETS
07	LA	5	42.8/47.3	73	1073
REGISTERED CIVIL ENGINEER			DATE	12-17-08	
6-8-09			PLANS APPROVAL DATE		
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REGISTERED PROFESSIONAL ENGINEER
 BALDEV K. BHALLA
 No. 34350
 Exp. 9/30/09
 CIVIL
 STATE OF CALIFORNIA

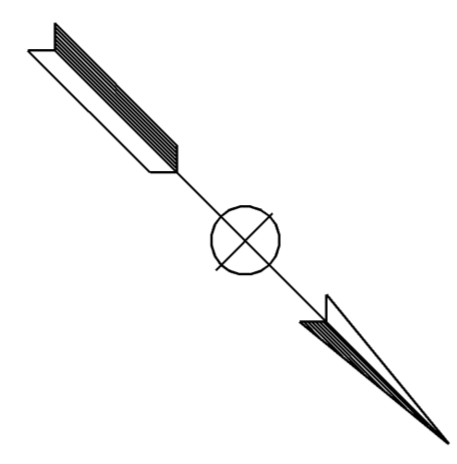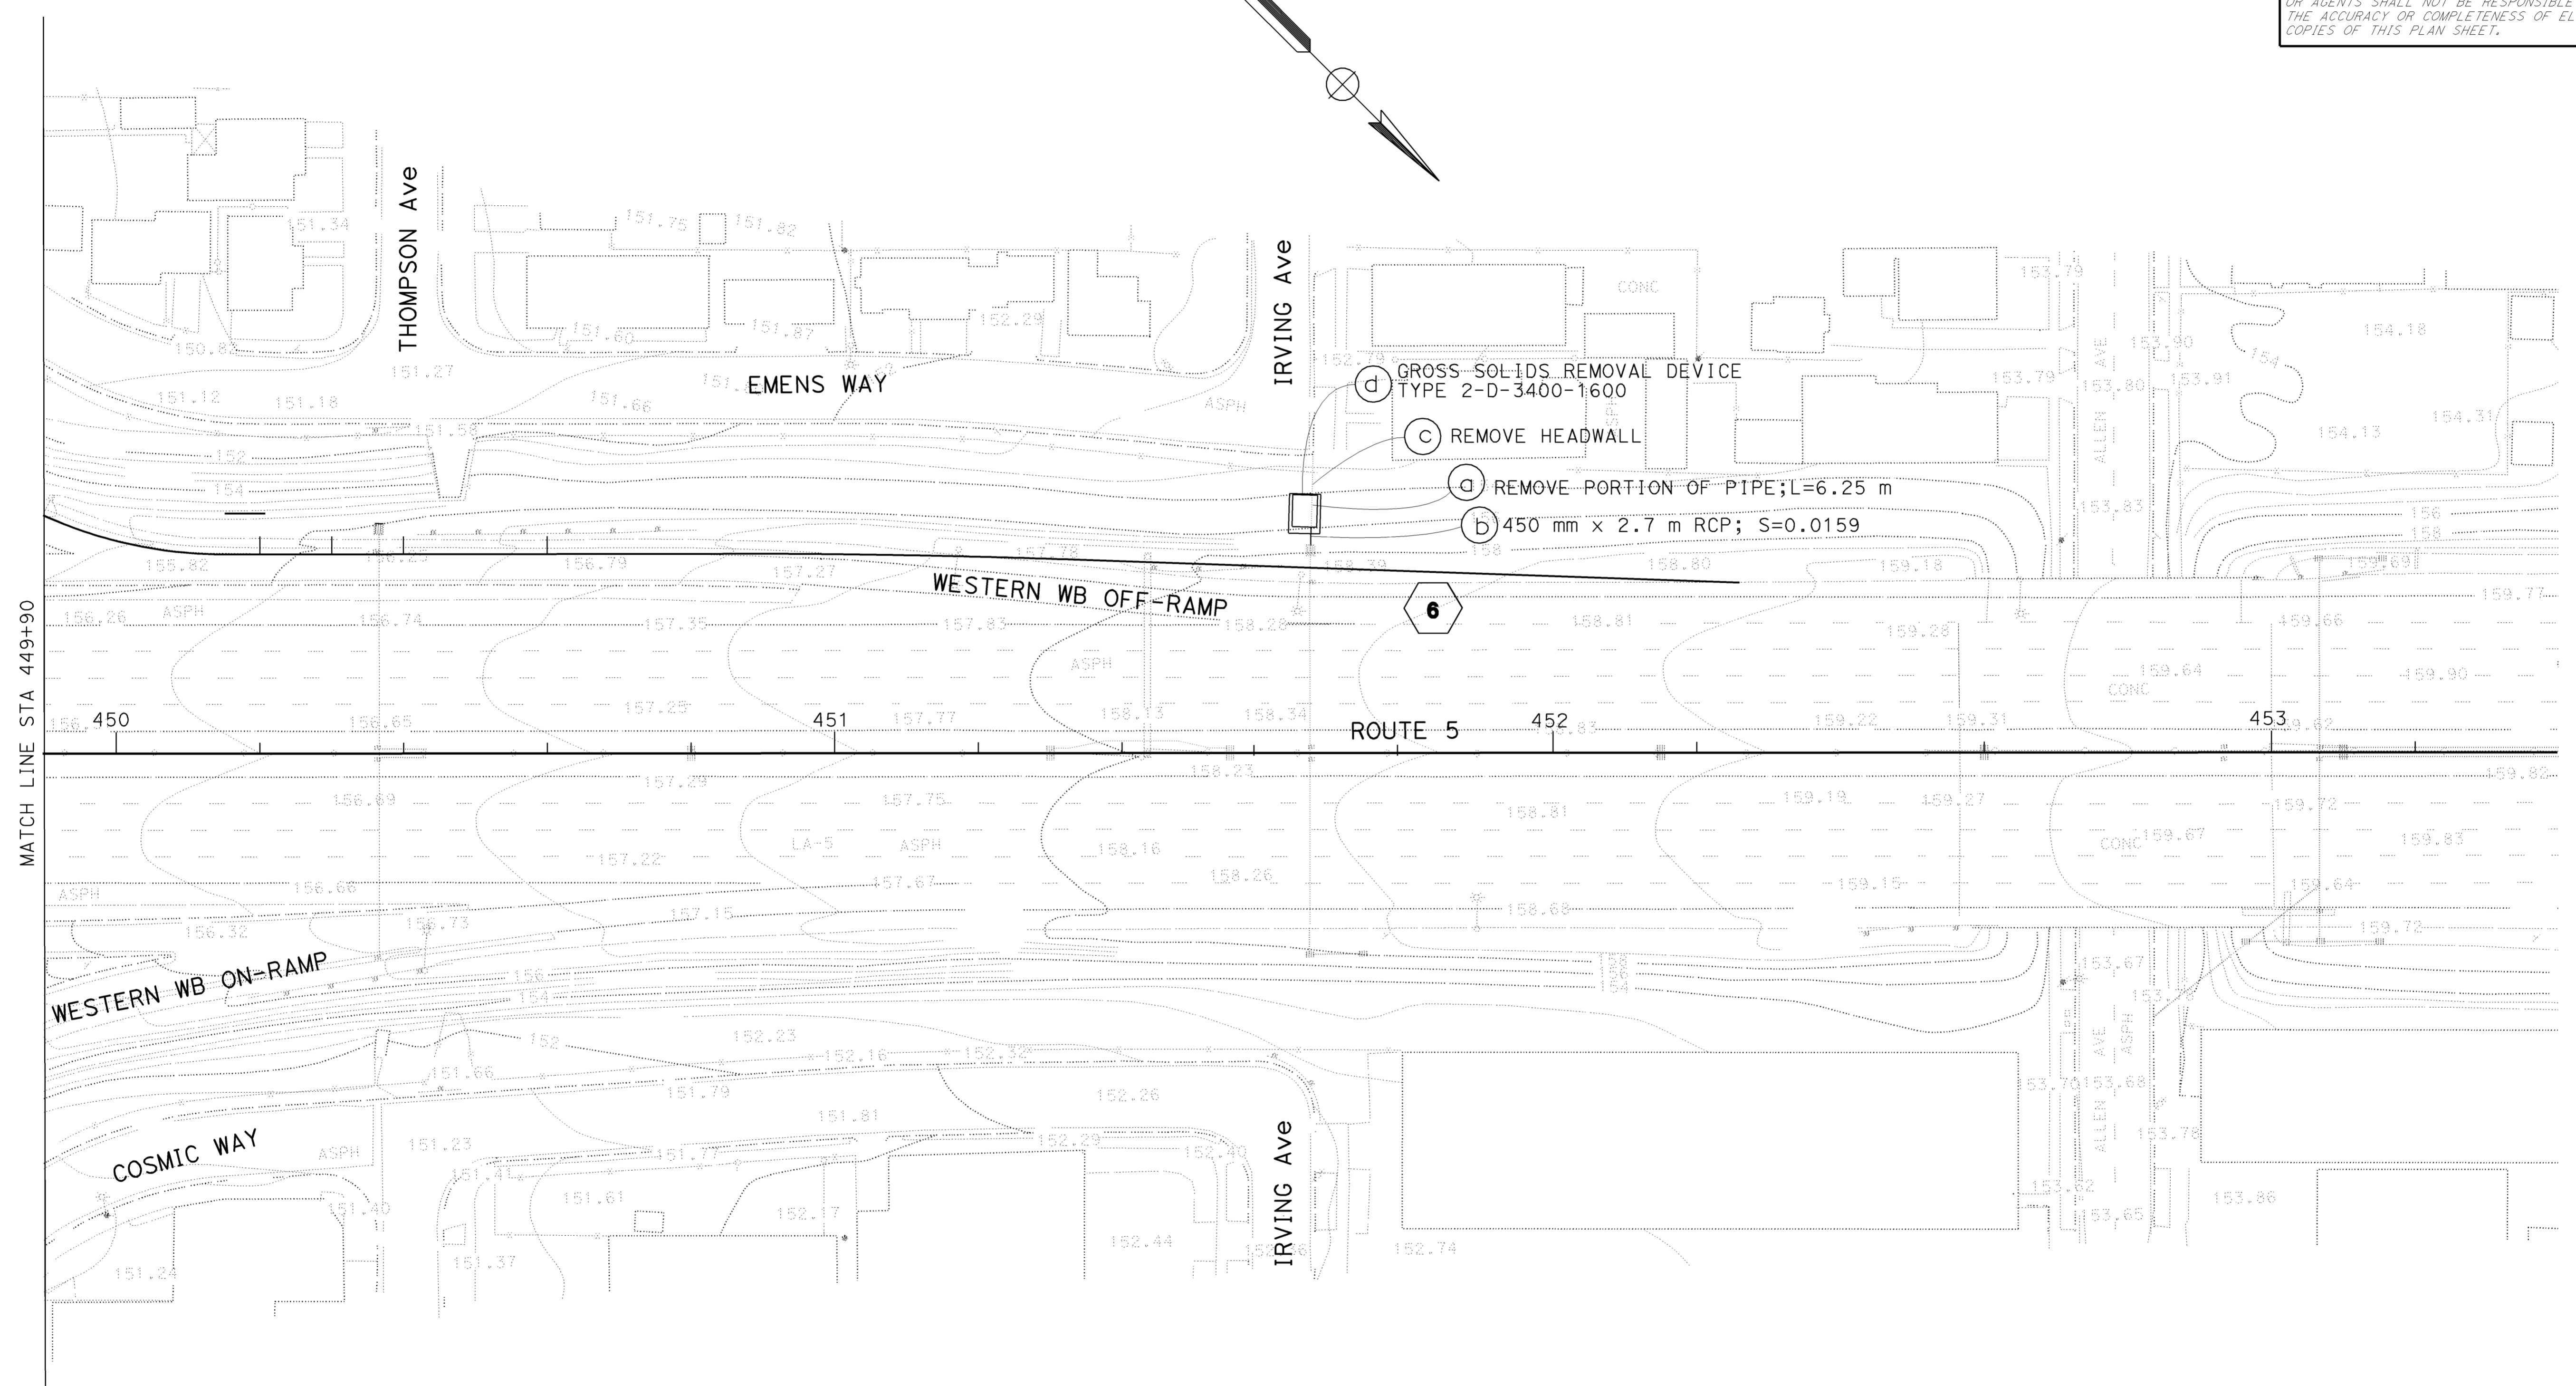

ALL DIMENSIONS ARE IN METERS UNLESS OTHERWISE SHOWN

WATER POLLUTION CONTROL PLAN

SCALE 1:500


W-3

THIS PLAN ACCURATE FOR WATER POLLUTION CONTROL WORK ONLY



STATE OF CALIFORNIA - DEPARTMENT OF TRANSPORTATION
Caltrans
 HYDRAULICS

FUNCTIONAL SUPERVISOR: DAVE BHALLA
 CHECKED BY: S. THAI
 DESIGNED BY: C.P. NGUYEN
 REVISIONS: (None)
 DATE REVISION: (None)


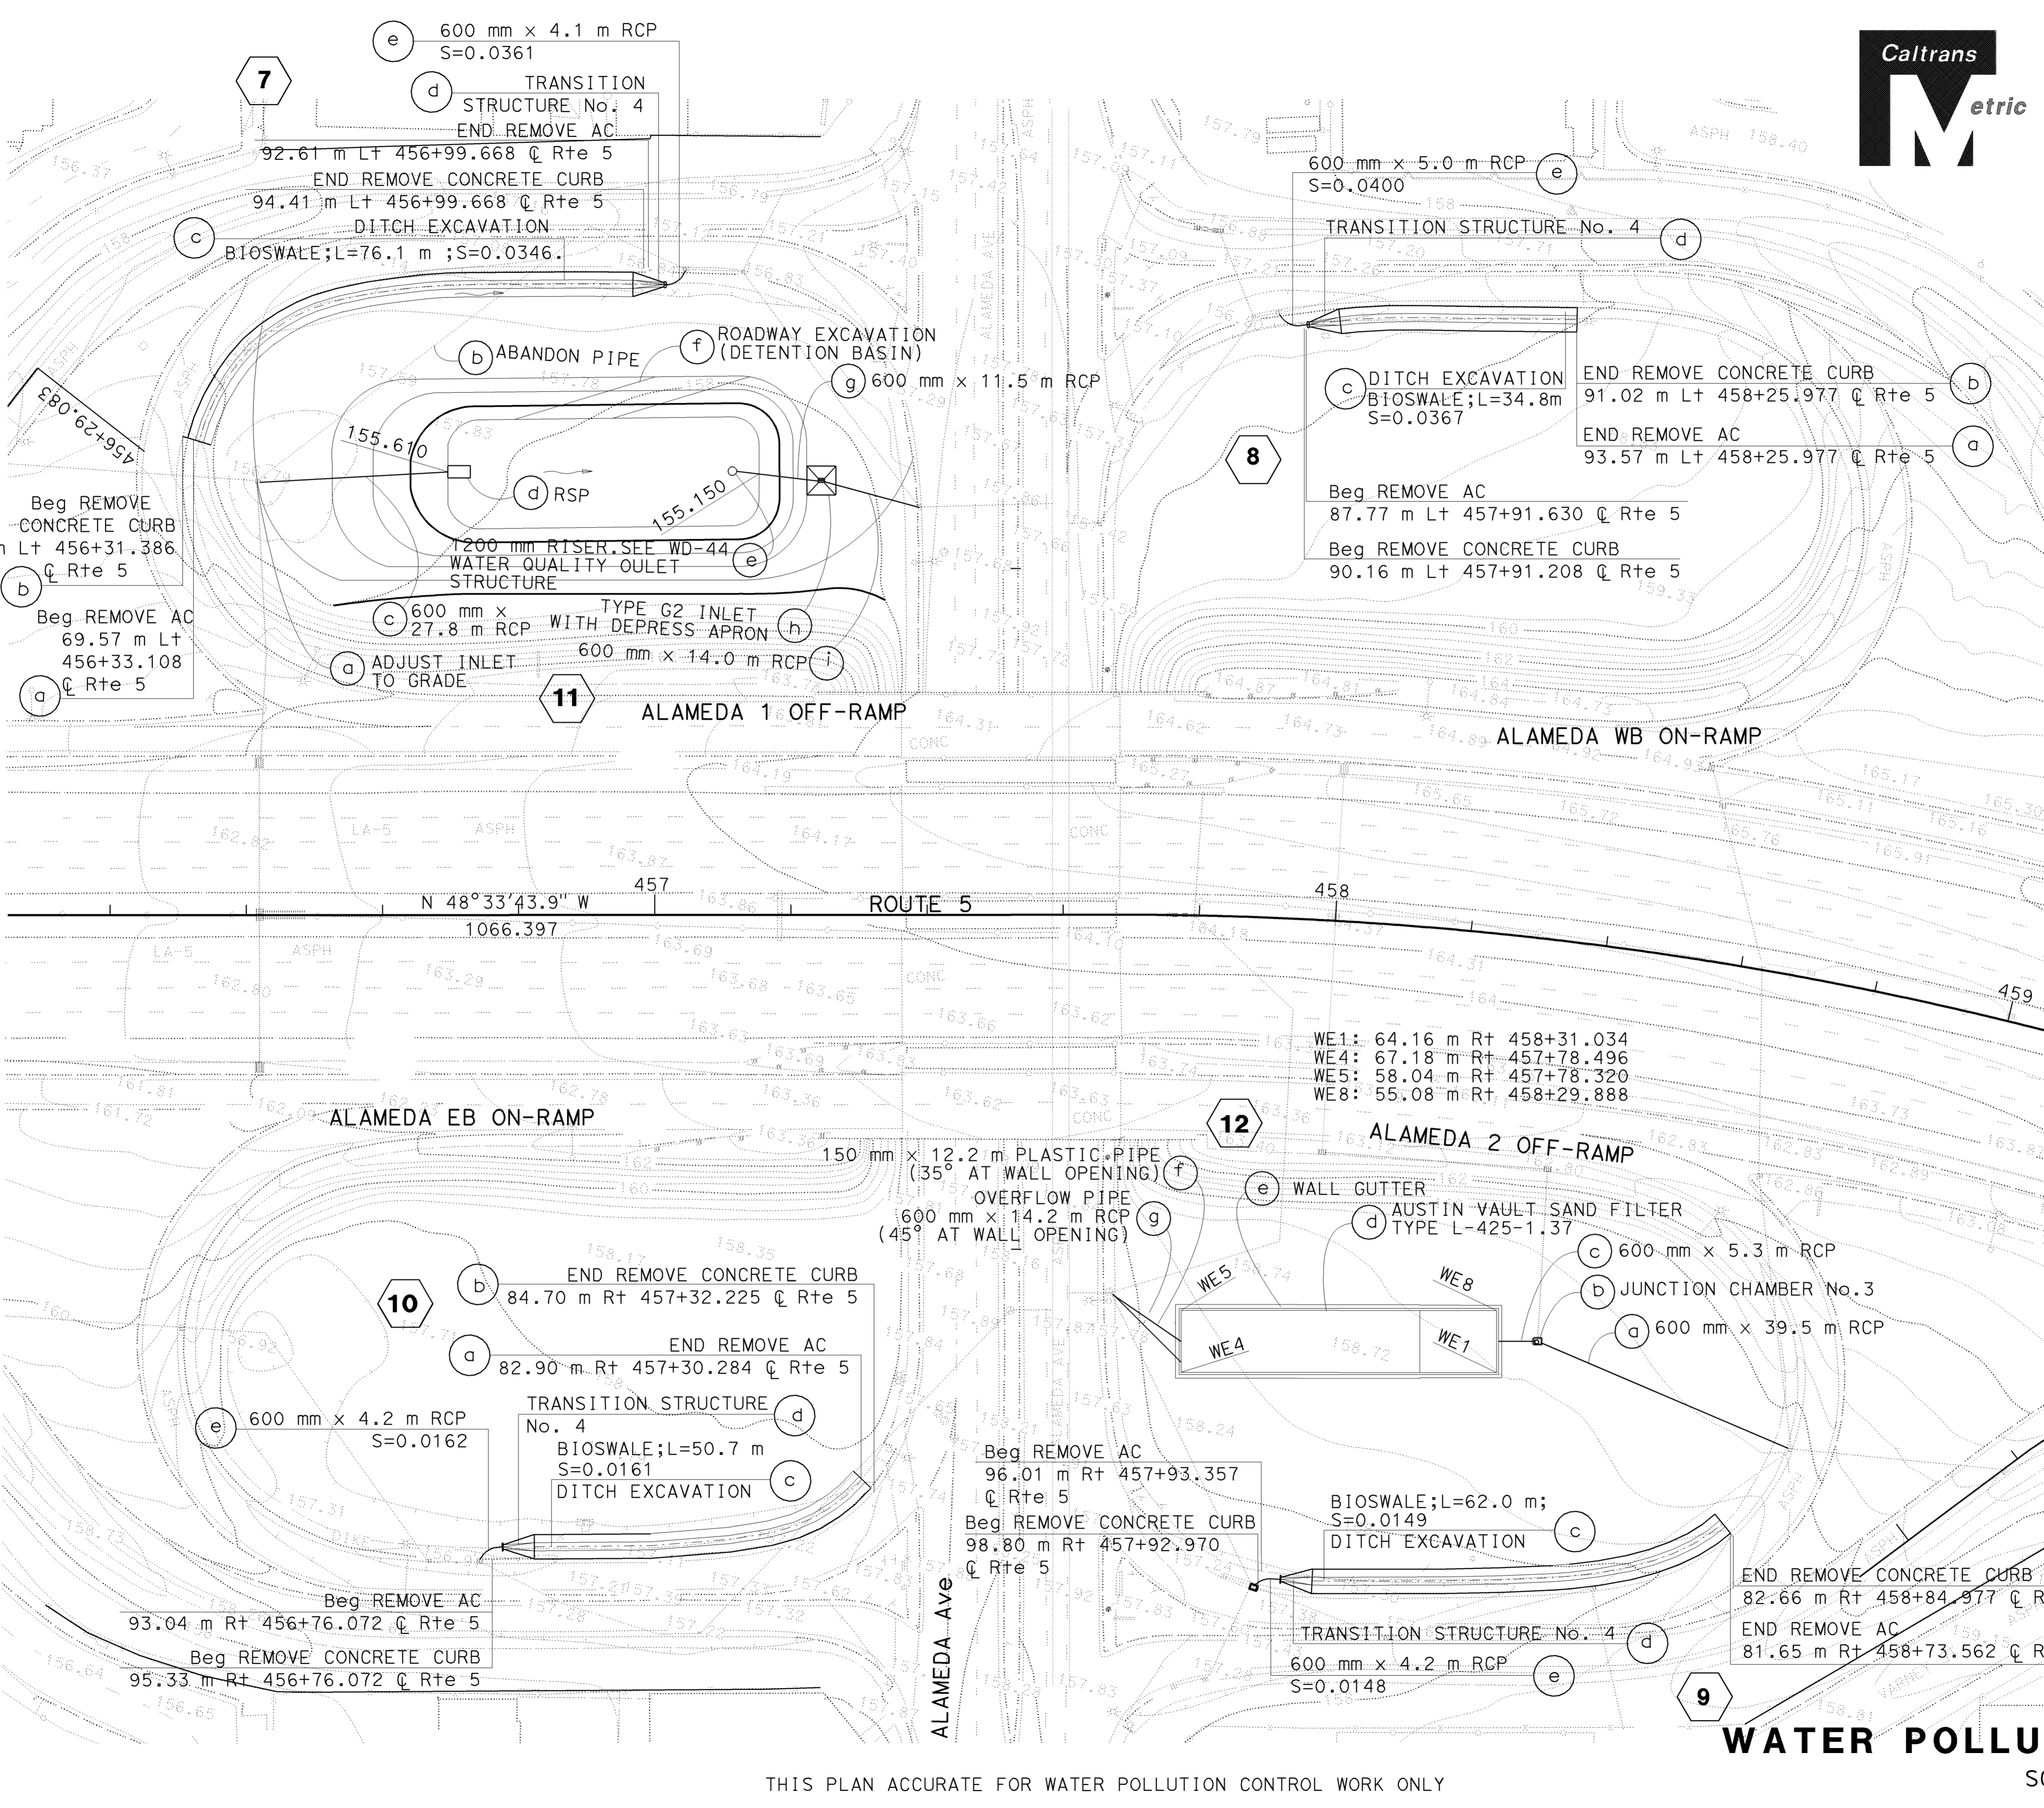


Dist	COUNTY	ROUTE	KILOMETER POST TOTAL PROJECT	SHEET No.	TOTAL SHEETS
07	LA	5	42.8/47.3	74	1073

REGISTERED CIVIL ENGINEER: BALDEV K. BHALLA
 No. 34350
 Exp. 9/30/09
 CIVIL

DATE: 12-17-08
 PLANS APPROVAL DATE: 6-8-09

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THIS PLAN ACCURATE FOR WATER POLLUTION CONTROL WORK ONLY

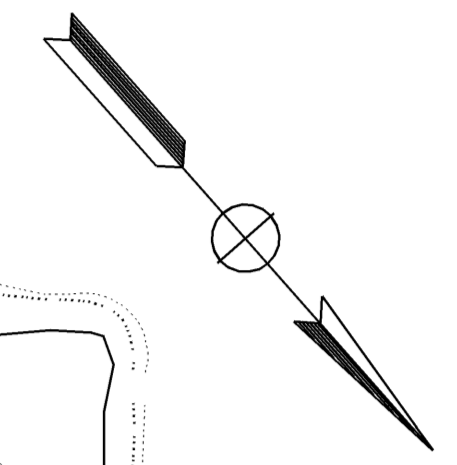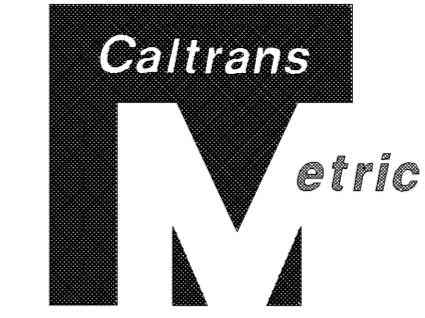WATER POLLUTION CONTROL PLAN
 SCALE 1:500
W-4

FUNCTIONAL SUPERVISOR
 DAVE BHALLA

CALCULATED-DESIGNED BY
 CHECKED BY

C.P. NGUYEN
 S. THAI

REVISED BY
 DATE REVISED

CURVE DATA

No.	R	Δ	T	L
①	4.000	70°55'34.1"	2.849	4.952
②	4.000	82°23'6.0"	3.501	5.752
③	4.000	58°20'14.3"	2.233	4.073





Dist	COUNTY	ROUTE	KILOMETER POST TOTAL PROJECT	SHEET No.	TOTAL SHEETS
07	LA	5	42.8/47.3	75	1073

12-17-08
 REGISTERED CIVIL ENGINEER DATE

6-8-09
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REGISTERED PROFESSIONAL ENGINEER
 BALDEV K. BHALLA
 No. 34350
 Exp. 9/30/09
 CIVIL
 STATE OF CALIFORNIA

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ALL DIMENSIONS ARE IN METERS UNLESS OTHERWISE SHOWN

WATER POLLUTION CONTROL PLAN

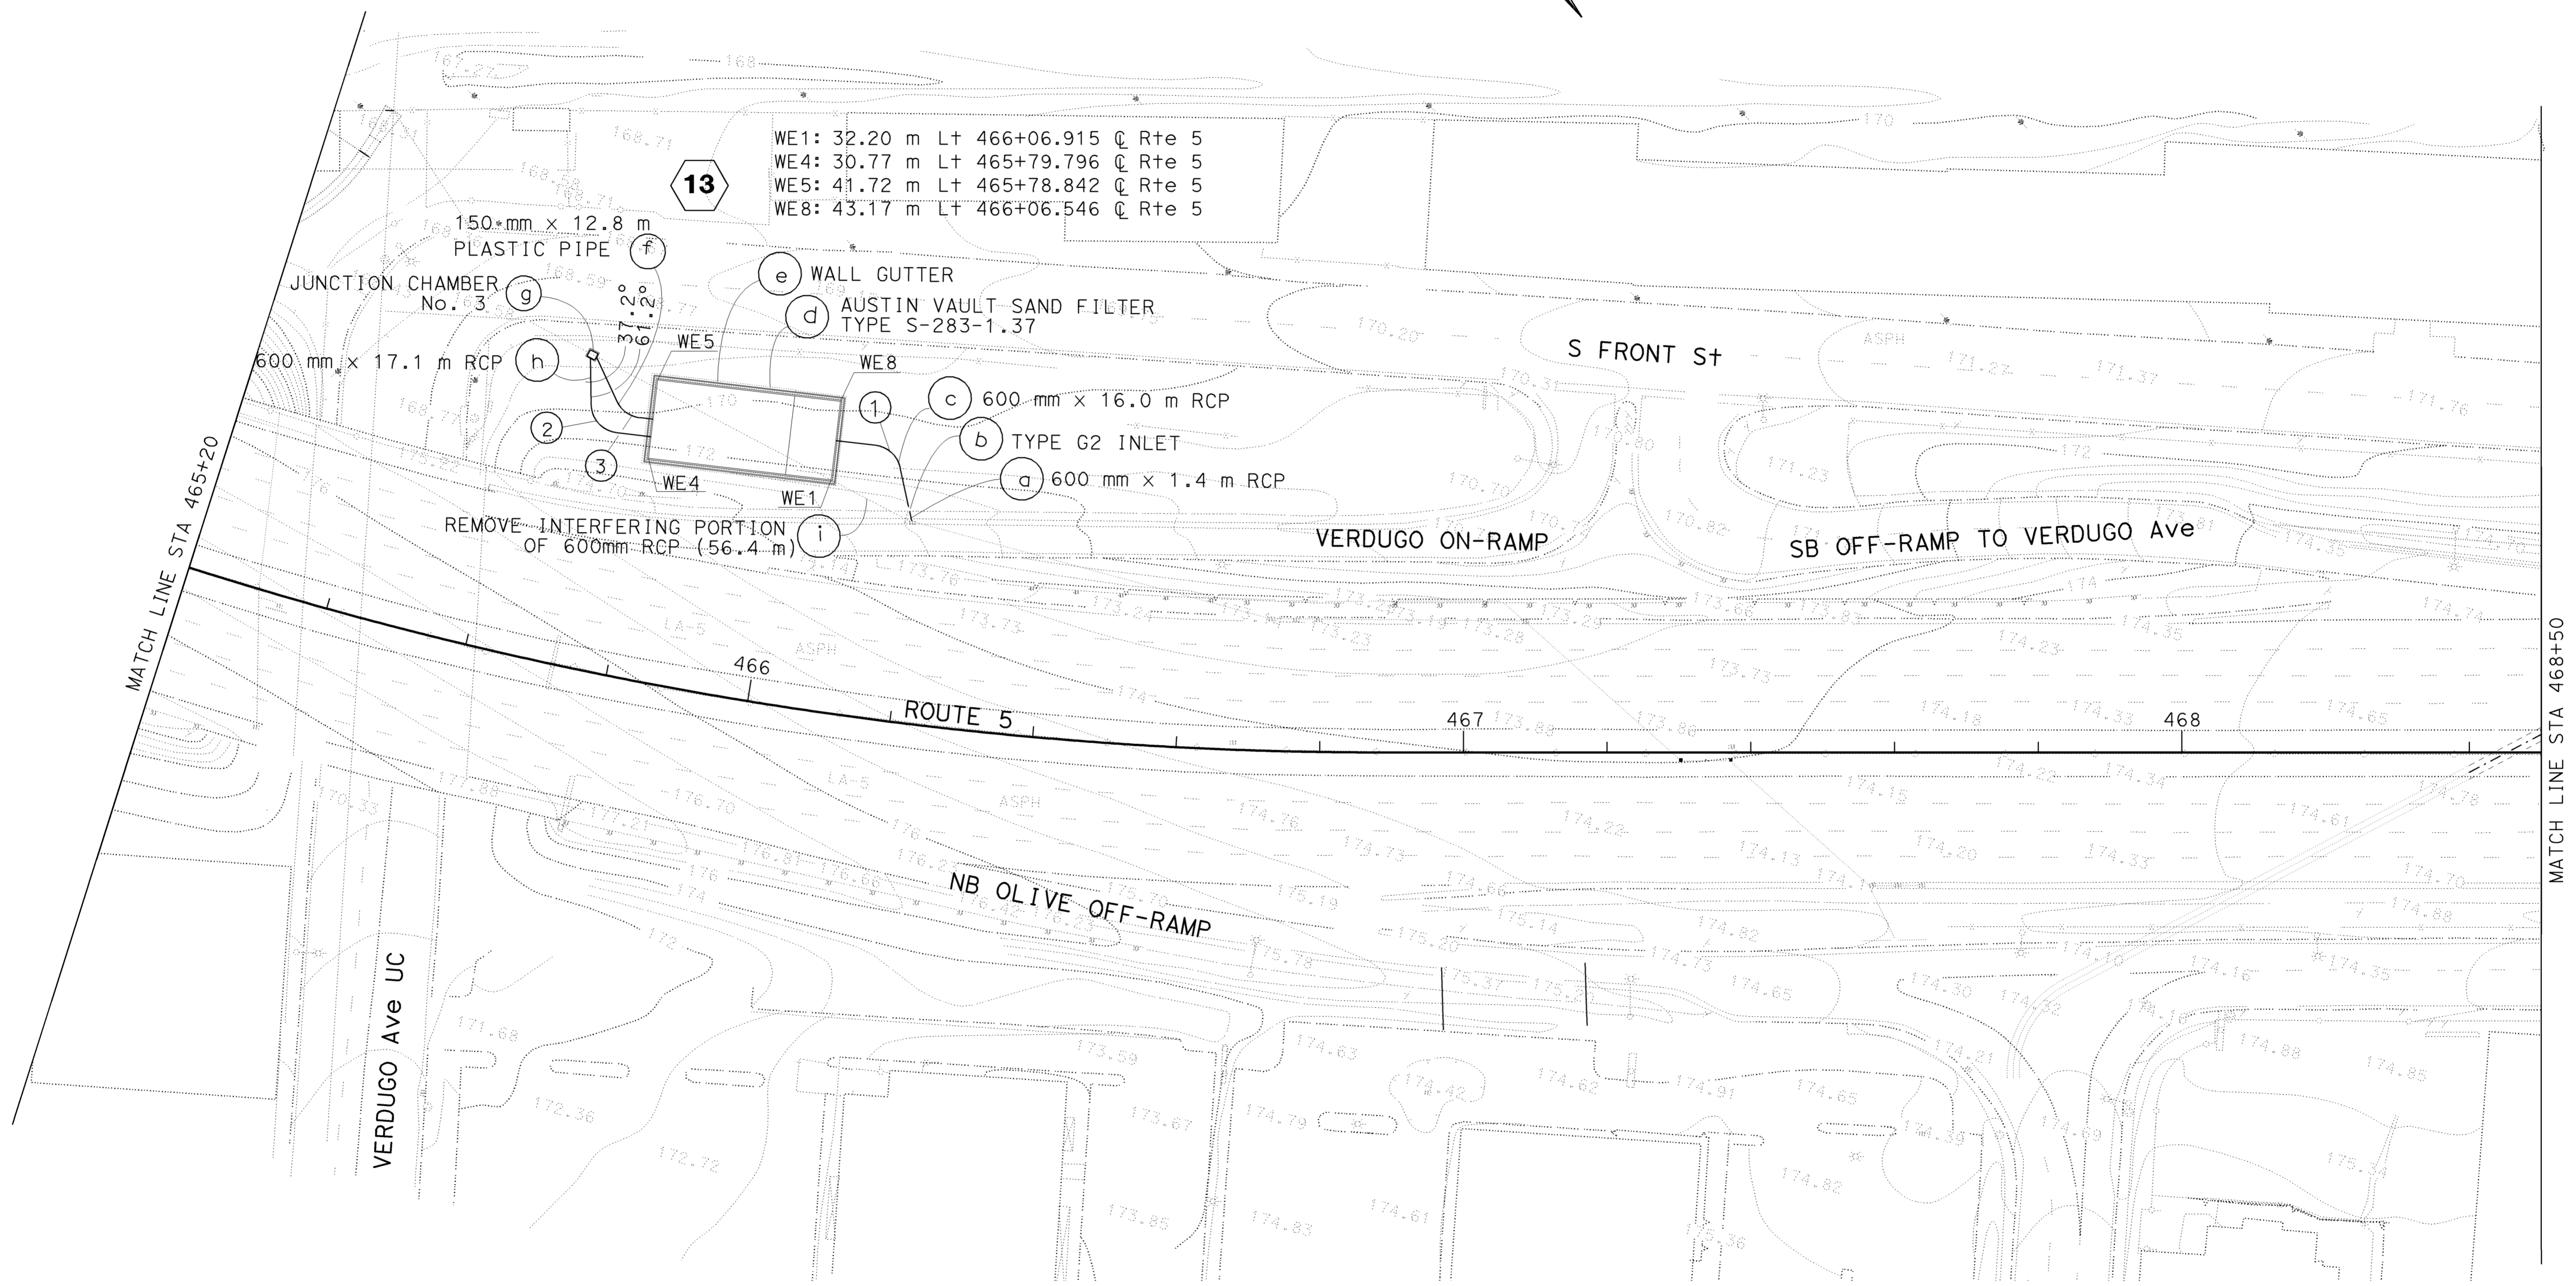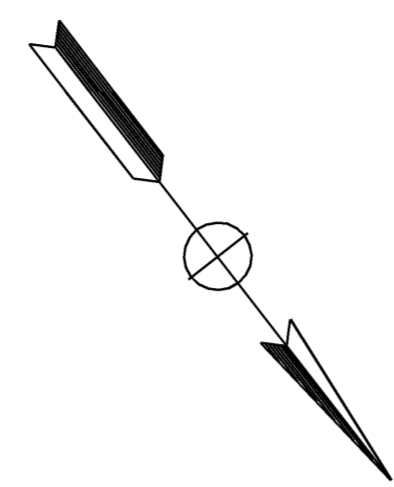SCALE 1:500

W-5

THIS PLAN ACCURATE FOR WATER POLLUTION CONTROL WORK ONLY



USERNAME => trannda
 DGN FILE => 7121841f005.dgn

CU 07314

EA 121841

LAST REVISION DATE PLOTTED => 12-JUN-2009 00:00:00 TIME PLOTTED => 08:07

GENERAL NOTES

Designation:
Partial Austin Vault Sand Filters (AVSFs) are open air reinforced concrete vaults utilizing both sedimentation and sand filtration basins. Type designation is based on length configuration, water quality volume to be drained in a 24 hour period, and average depth of water.

Standard configurations are noted for the following design water quality volumes (WQV): 142, 283, and 425 cubic meters. Length configurations are either short (S) or long (L). The average water depth can be either 910 mm, 1370 mm, 1830 mm as designed in Design Water Quality Volumes (WQV) table.

Special Reinforcement Coverage:
AVSF Standard Details are not to be used in a corrosive environment or where there is a severe abrasive flow condition or in freeze-thaw locations.

Special Design:
Required for the following conditions:
ground water conditions above bottom of AVSF, surcharge loads exceeding HS20 truck load, design bearing pressures or sizes greater than those on this plan, inlet velocities which exceed 2.44 m/sec at gabion wall, and settlement due to liquefaction.

DESIGN WATER QUALITY VOLUMES (WQV)					
AVSF Type*	WQV (m ³)	W(m)	Ls(m)	Lf(m)	Hw(m)
S-142-0.91	142	8.23	4.57	12.80	0.91
L-142-0.91	142	5.49	6.40	19.20	0.91
S-142-1.37	177	8.23	4.57	12.80	1.37
L-142-1.37	177	5.49	6.4	19.20	1.37
S-142-1.83	212	8.23	4.57	12.80	1.83
L-142-1.83	212	5.49	6.40	19.20	1.83
S-283-0.91	283	10.97	6.40	19.20	0.91
L-283-0.91	283	7.32	9.14	28.65	0.91
S-283-1.37	354	10.97	6.40	19.20	1.37
L-283-1.37	354	7.32	9.14	28.65	1.37
S-283-1.83	425	10.97	6.40	19.20	1.83
L-283-1.83	425	7.32	9.14	28.65	1.83
S-425-0.91	425	13.72	7.62	23.16	0.91
L-425-0.91	425	9.14	11.28	35.05	0.91
S-425-1.37	531	13.72	7.62	23.16	1.37
L-425-1.37	531	9.14	11.28	35.05	1.37
S-425-1.83	637	13.72	7.62	23.16	1.83
L-425-1.83	637	9.14	11.28	35.05	1.83

* AVSF Type = Length configuration (S or L) - water quality volume (CM) - design water depth (Hw elevation)

DESIGN NOTES




Specifications:
Design:
Bridge Design Specification April 2000 (LFD)
(1996 AASHTO) with interims and revisions by Caltrans

Wall & Footing (LFD): 1.5 D + 1.5 E + 1.5 W
Where D = Dead Load
E = Earth Load
W = Water Load
Capacity reduction factor is included.

Earth Load: 22 kPa/m vertical, Water Load: 9.8 kPa/m horizontal/vertical,

Equivalent Fluid Pressure = 15.7 kPa/m horizontal (Case I).

Earth pressure for 1:2 unlimited slope determined from Rankine's formula with $\phi = 33^\circ 42'$ (Case II).

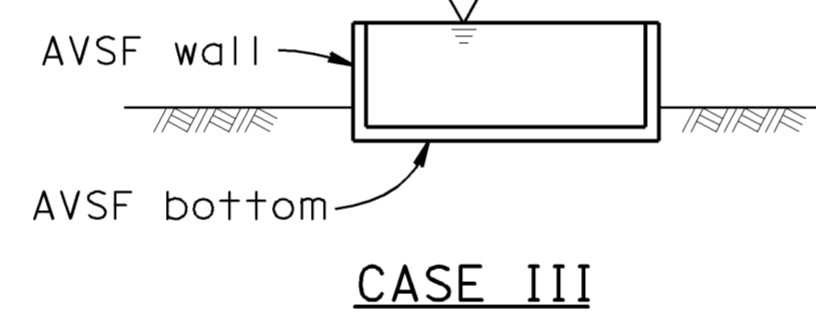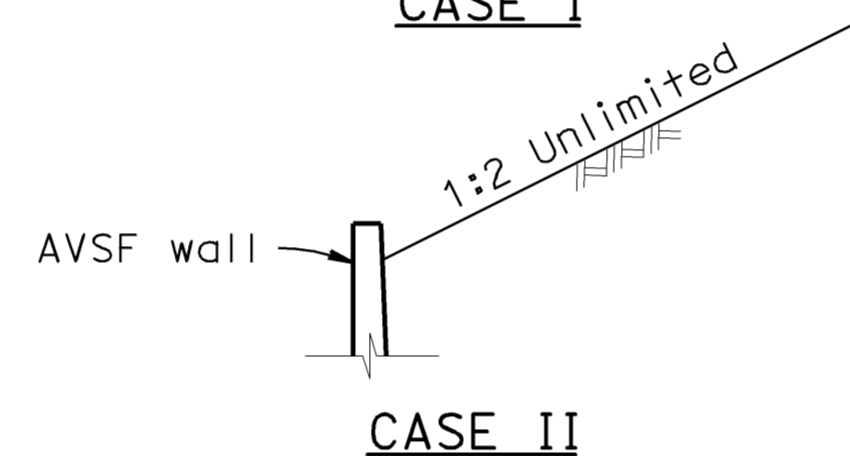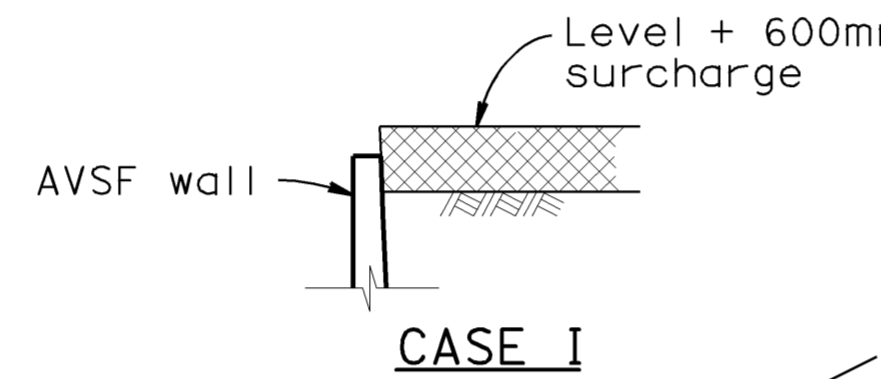

**DETAIL OF DESIGN
LOADING CASES**

CASE I Level + 600mm surcharge, AVSF empty
CASE II 1:2 Unlimited slope, AVSF empty
CASE III AVSF full of water, no soil pressure

Design Conditions:
Design H may be exceeded by 150 mm before going to the next size.

Unit Stresses:
 $f'_c = 25 \text{ MPa}$
 $f_y = 420 \text{ MPa}$

Shear:
Maximum allowable shear, $V_c = 0.25 \sqrt{f'_c} \text{ Mpa}$

Design Bearing Pressure = 144 kPa (service)

INDEX TO PLAN

SHEET No.	TITLE
1	GENERAL NOTES
2	LAYOUT No. 1
3	LAYOUT No. 2
4	WALL DETAILS
5	FOOTING DETAILS
6	DETAILS No. 1
7	DETAILS No. 2
8	DETAILS No. 3
9	DETAILS No. 4
10	MISCELLANEOUS DETAILS No. 1
11	MISCELLANEOUS QUANTITIES


CONSTRUCTION NOTES

Expansion joints:
Inverts and sidewalls - Place 50 mm expansion joint filler at 9145 mm + centers with waterstop, see "Details No. 2" sheet for specific wall & invert details.

Construction Joints:
Temporary joints may be permitted if normal (or radial) to ϕ of AVSF. Otherwise, the contractor is to submit a proposal for consideration.

Backfill:
See Standard Specifications, except the difference in backfill shall not exceed 2.40m between side walls and inlet and outlet walls.

Earthwork:
Limits of payment for excavation and backfill.

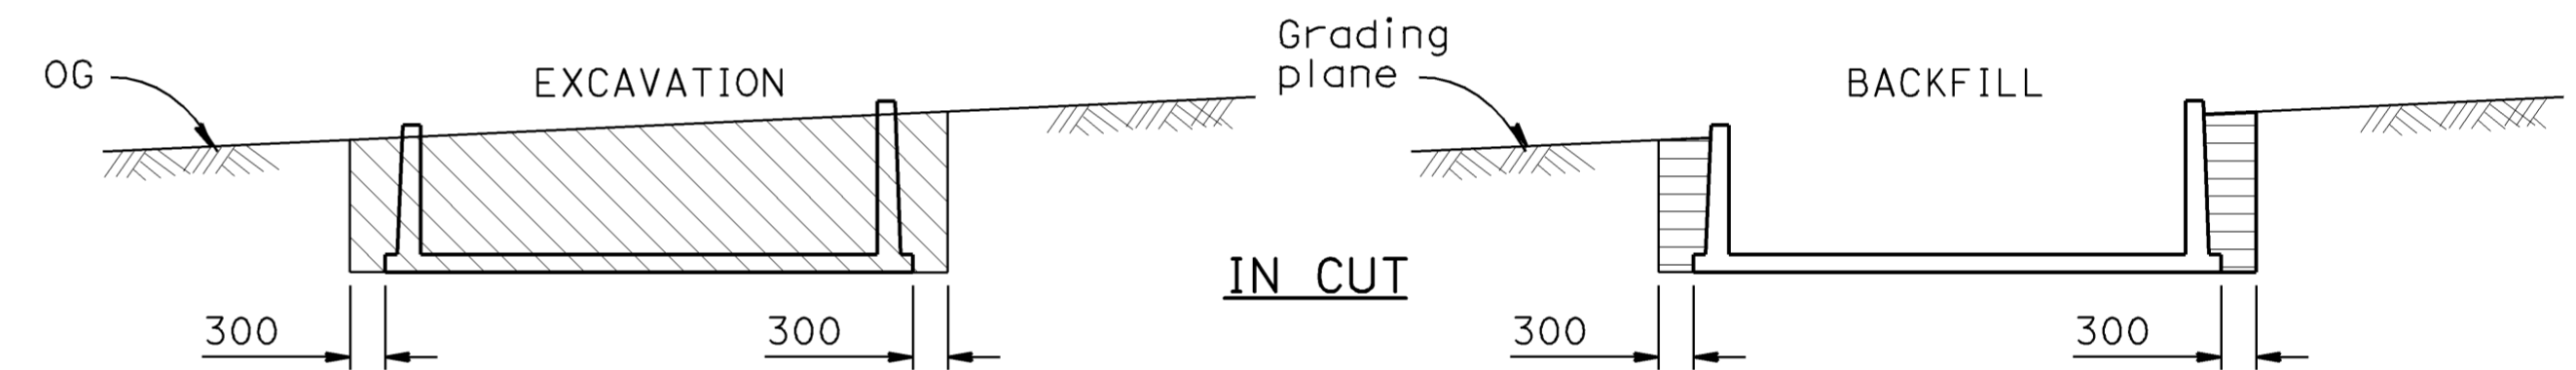

LEGEND:


- Structure excavation (AVSF)
- Structure backfill (AVSF)
- Original ground, OG

NOTES:

1. Slope or shore excavation sides as necessary.
2. Dimensions shown are minimum.

STANDARD PLANS DATED JULY 2004

- B0-3 BRIDGE DETAILS
- B3-9 RETAINING WALL DETAILS No. 2
- B6-21 JOINT SEALS (MAXIMUM MOVEMENT RATING = 50 mm)
- B11-47 CABLE RAILING
- D100A GABION BASKET DETAILS No. 1
- D100B GABION BASKET DETAILS No. 2

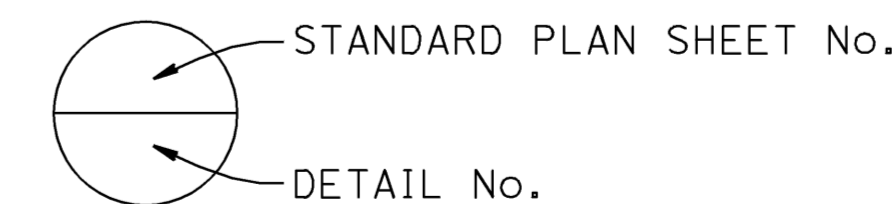

ALL DIMENSIONS ARE IN MILLIMETERS UNLESS OTHERWISE SHOWN

**WATER POLLUTION CONTROL DETAILS
WD-1**

DESIGN BY <i>D. Dunrud</i> CHECKED <i>J&P Peterson</i>	DETAILS BY <i>J&P Peterson</i> CHECKED <i>J&P Peterson</i>	SUBMITTED BY <i>J&P Peterson</i> DRAWING DATE <i>8/07</i>	STATE OF CALIFORNIA DEPARTMENT OF TRANSPORTATION	DIVISION OF ENGINEERING SERVICES	BRIDGE NO. MILE POST	AUSTIN VAULT SAND FILTER GENERAL NOTES
ORIGINAL SCALE IN MILLIMETERS FOR REDUCED PLANS: 0 10 20 30 40 50 60 70 80 90 100			CU 07 EA 121841		DISREGARD PRINTS BEARING EARLIER REVISION DATES	
USERNAME => trandda DGN FILE => 7121841n001.dgn						SHEET 1 OF 11


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DIST.	COUNTY	ROUTE	MILE POST TOTAL PROJECT	SHEET NO.	TOTAL SHEETS
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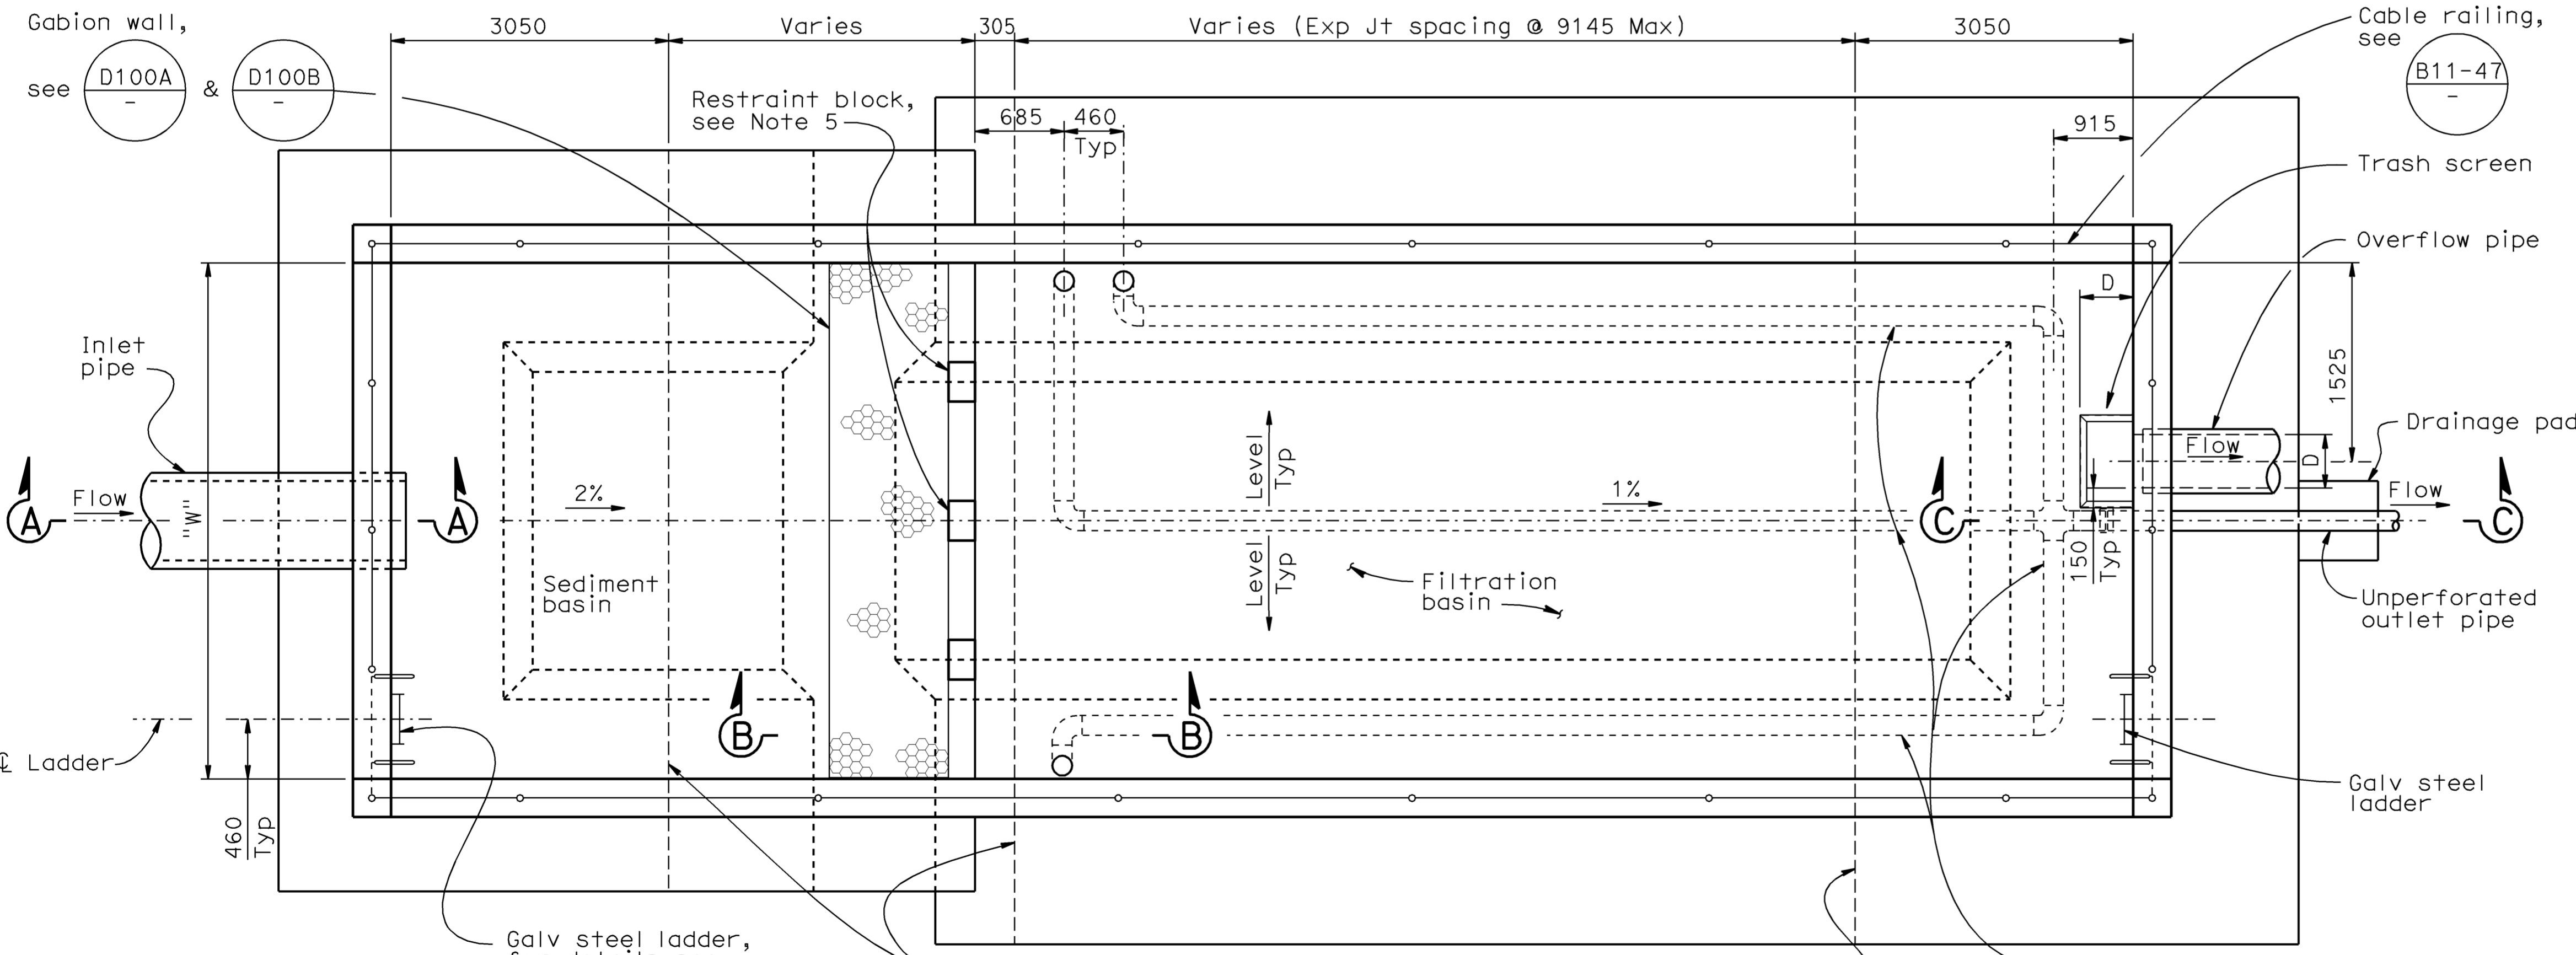
REGISTERED ENGINEER - CIVIL
 DOUGLAS DUNRUD
 No. 47240
 Exp. 12/31/09
 CIVIL
 STATE OF CALIFORNIA

PLANS APPROVAL DATE
 6-8-09
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LONGITUDINAL SECTION

No Scale



PLAN (Type 2 footing shown, Type 1 similar)

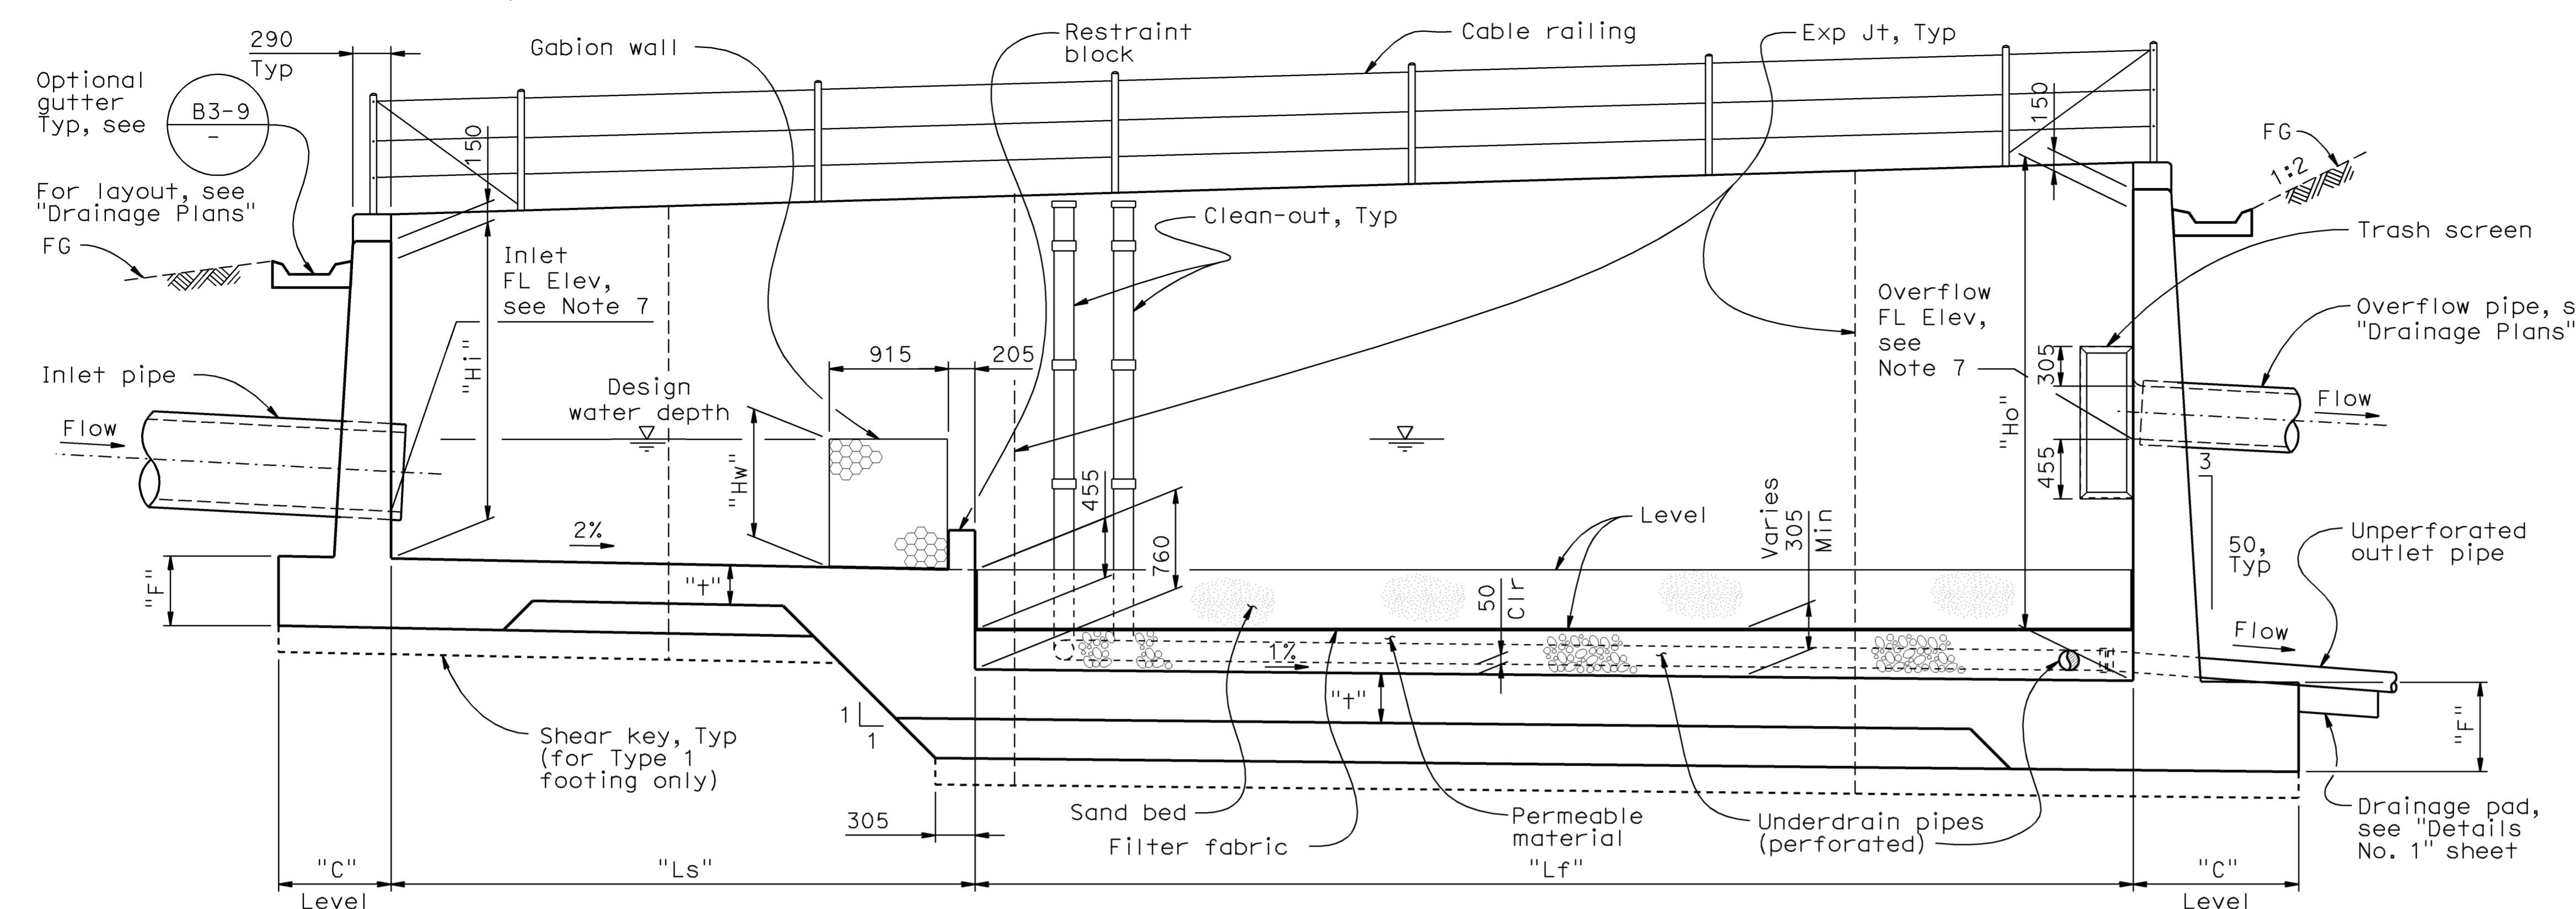No Scale

Note: Gutter and shear key not shown for clarity.

WATER POLLUTION CONTROL DETAILS

WD-2


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Austin Type	Allowable Wall Heights	
	Sediment Basin (Hi)	Filtration Basin (Ho)
S-142-0.91	1830-3660	3050-4880
L-142-0.91	1830-3660	3050-4880
S-142-1.37	2440-3660	3660-4880
L-142-1.37	2440-3660	3660-4880
S-142-1.83	3050-3660	4270-4880
L-142-1.83	3050-3660	4270-4880
S-283-0.91	1830-3660	3050-4880
L-283-0.91	1830-3660	3050-4880
S-283-1.37	2440-3660	3660-4880
L-283-1.37	2440-3660	3660-4880
S-283-1.83	3050-3660	4270-4880
L-283-1.83	3050-3660	4270-4880
S-425-0.91	1830-3660	3050-4880
L-425-0.91	1830-3660	3050-4880
S-425-1.37	2440-3660	3660-4880
L-425-1.37	2440-3660	3660-4880
S-425-1.83	3050-3660	4270-4880
L-425-1.83	3050-3660	4270-4880

RELEASE DATE	DESIGN BY	BY	CHECKED
---	D. Dunrud	J&P Peterson	J&P Peterson
FILE NO.	DETAILS BY	BY	CHECKED
---	J&P Peterson	J&P Peterson	J&P Peterson
	SUBMITTED BY	BY	DRAWING DATE
	J&P Peterson	J&P Peterson	8/07

STATE OF CALIFORNIA
 DEPARTMENT OF TRANSPORTATION
 DIVISION OF ENGINEERING SERVICES

BRIDGE NO.
 MILE POST
AUSTIN VAULT SAND FILTER
LAYOUT No. 1

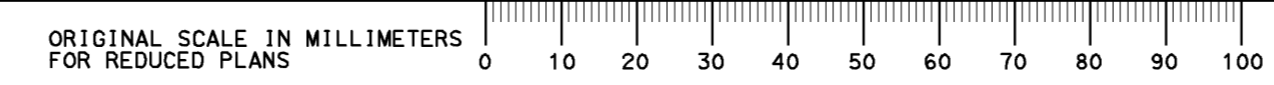

ORIGINAL SCALE IN MILLIMETERS FOR REDUCED PLANS
 USERNAME => trannda
 DGN FILE => 7121841h002.dgn

CU 07	EA 121841	DISREGARD PRINTS BEARING EARLIER REVISION DATES
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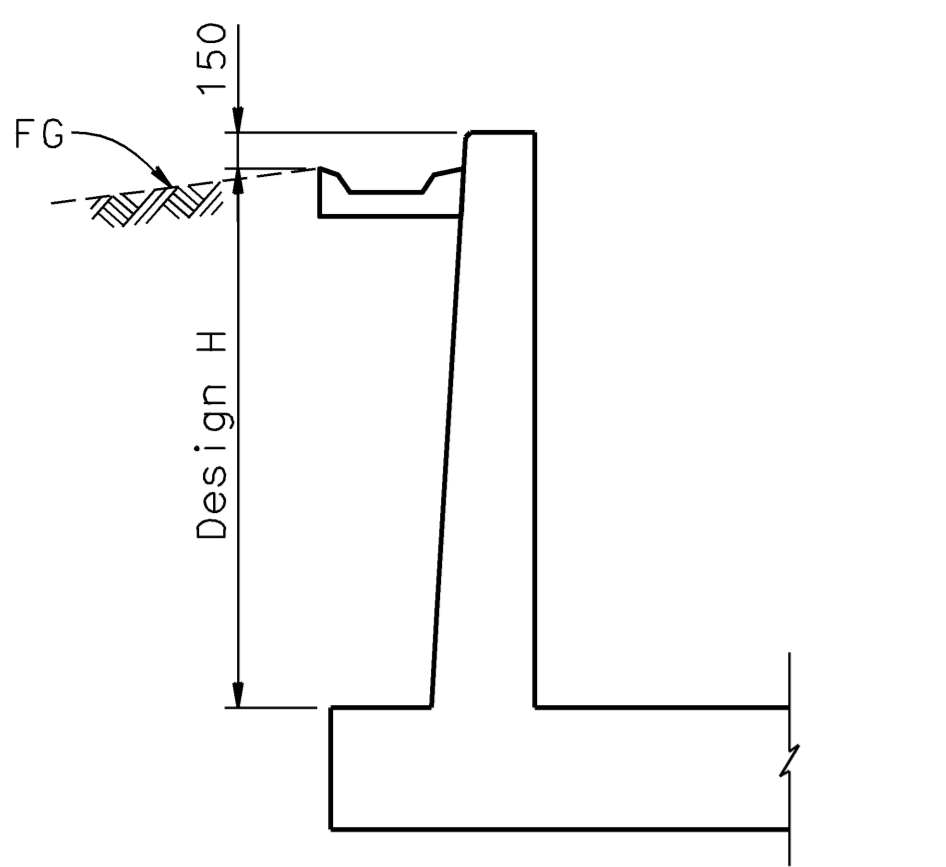
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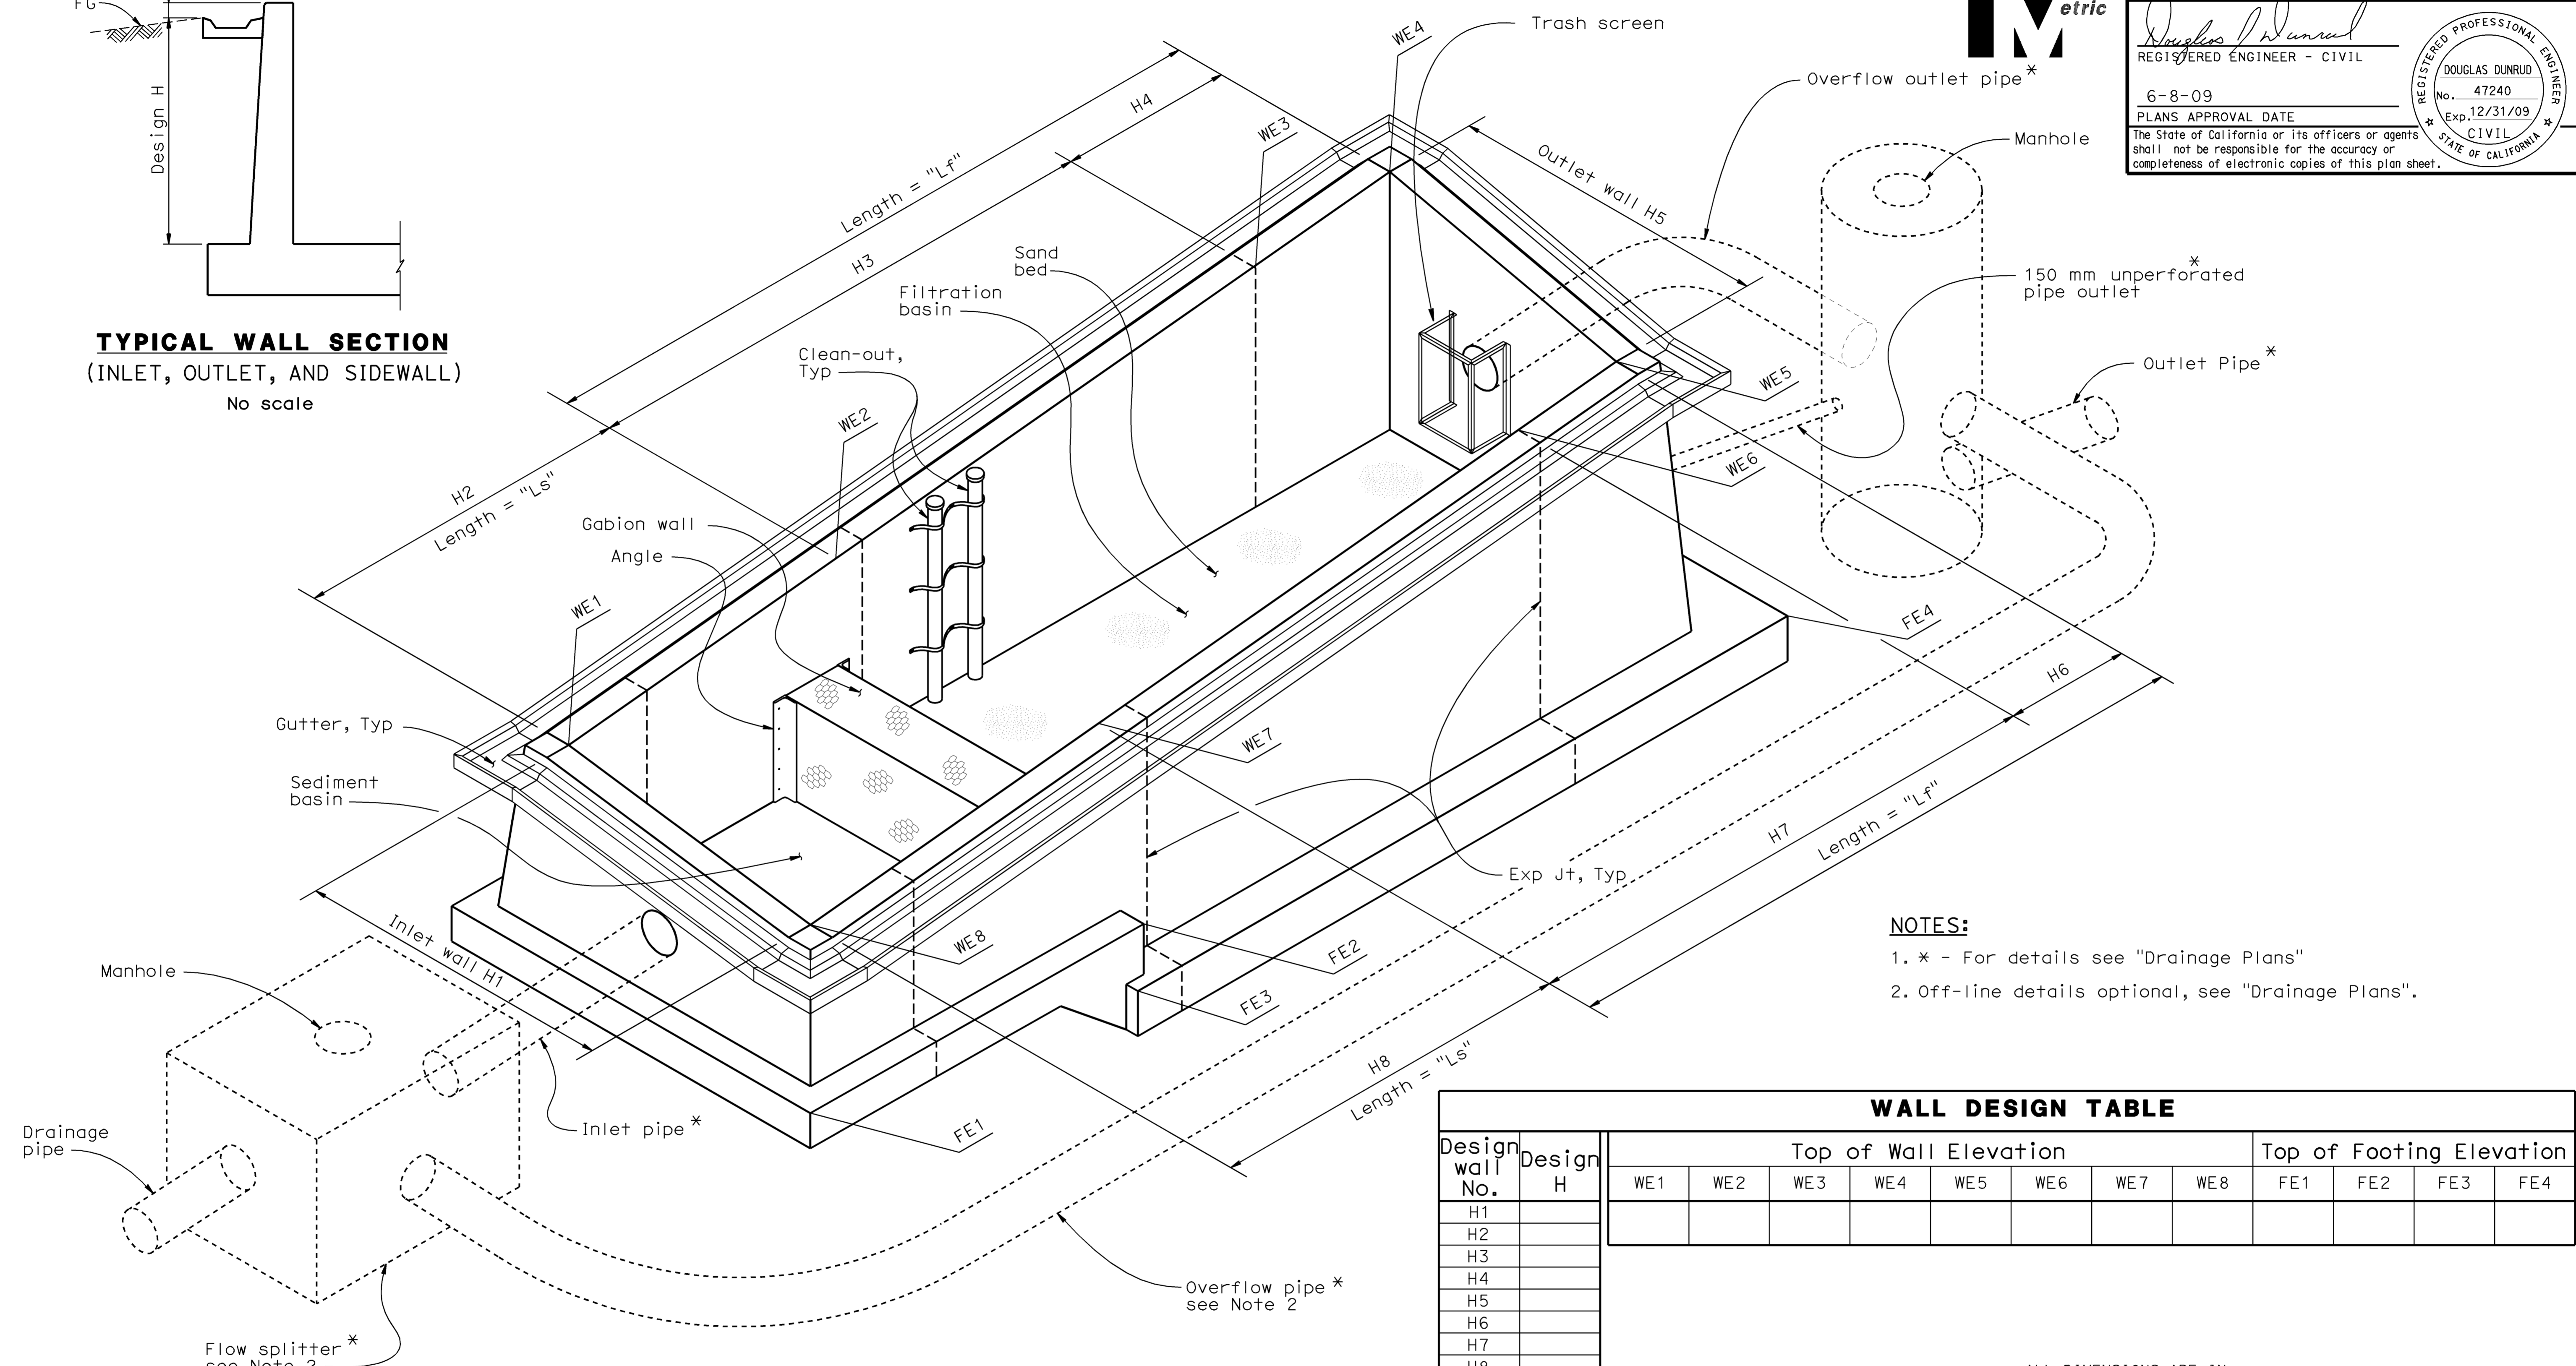
DIST.	COUNTY	ROUTE	MILE POST TOTAL PROJECT	SHEET NO.	TOTAL SHEETS
07	LA	5	42.8/47.3	78	1073

REGISTERED ENGINEER - CIVIL
 Douglas Dunrud
 No. 47240
 Exp. 12/31/09
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6-8-09
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TYPICAL WALL SECTION
(INLET, OUTLET, AND SIDEWALL)
No scale



ISOMETRIC VIEW - AUSTIN VAULT SAND FILTER DRAINAGE SYSTEM
No Scale

NOTE: Steel ladders and cable railings not shown for clarity.

- NOTES:**
- * - For details see "Drainage Plans"
 - Off-line details optional, see "Drainage Plans".

Design wall No.	Design H	Top of Wall Elevation								Top of Footing Elevation			
		WE1	WE2	WE3	WE4	WE5	WE6	WE7	WE8	FE1	FE2	FE3	FE4
H1													
H2													
H3													
H4													
H5													
H6													
H7													
H8													

ALL DIMENSIONS ARE IN MILLIMETERS UNLESS OTHERWISE SHOWN

WATER POLLUTION CONTROL DETAILS
WD-3

RELEASE DATE	DESIGN BY	CHECKED
---	D. Dunrud	J&P Peterson
FILE NO.	DETAILS BY	CHECKED
---	J&P Peterson	J&P Peterson
	SUBMITTED BY	DRAWING DATE
	J&P Peterson	8/07

STATE OF CALIFORNIA
DEPARTMENT OF TRANSPORTATION

DIVISION OF ENGINEERING SERVICES

BRIDGE NO.
MILE POST

AUSTIN VAULT SAND FILTER
LAYOUT No. 2

REVISION DATES (PRELIMINARY STAGE ONLY)

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SHEET 3 OF 11

ORIGINAL SCALE IN MILLIMETERS FOR REDUCED PLANS

CU 07
EA 121841

DISREGARD PRINTS BEARING EARLIER REVISION DATES

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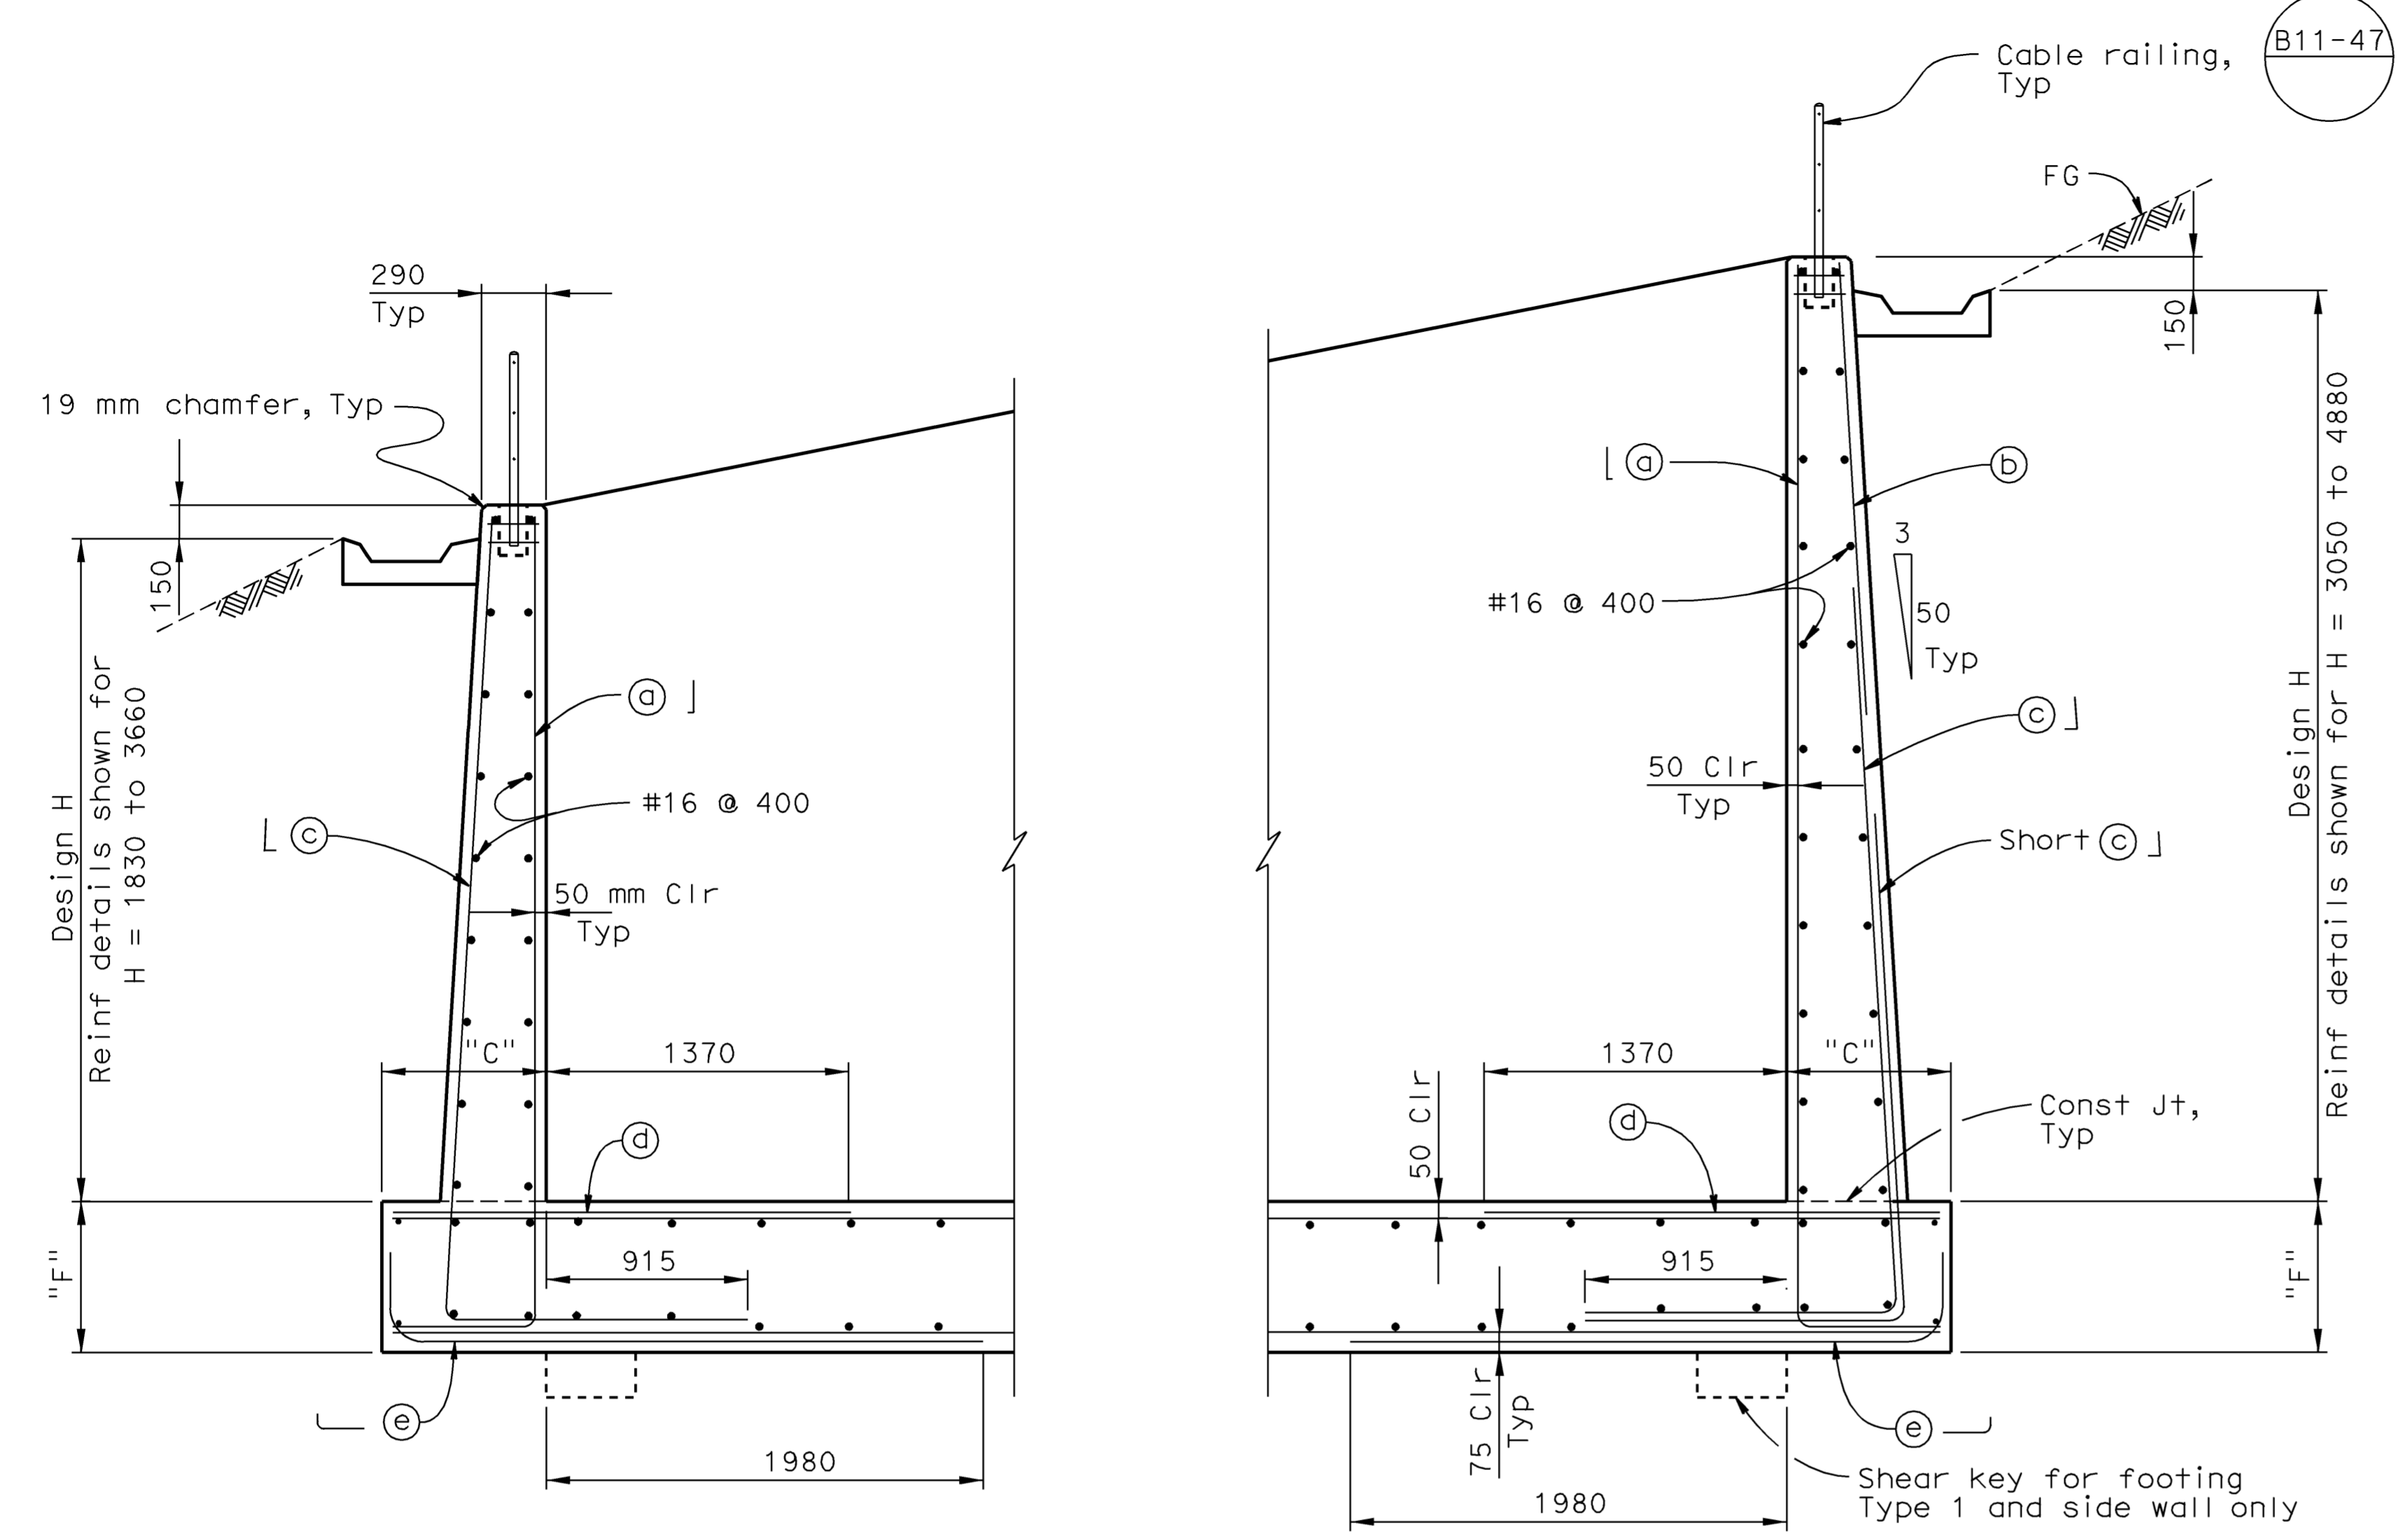
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DIST.	COUNTY	ROUTE	MILE POST TOTAL PROJECT	SHEET NO.	TOTAL SHEETS
07	LA	5	42.8/47.3	79	1073

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 DOUGLAS DUNRUD
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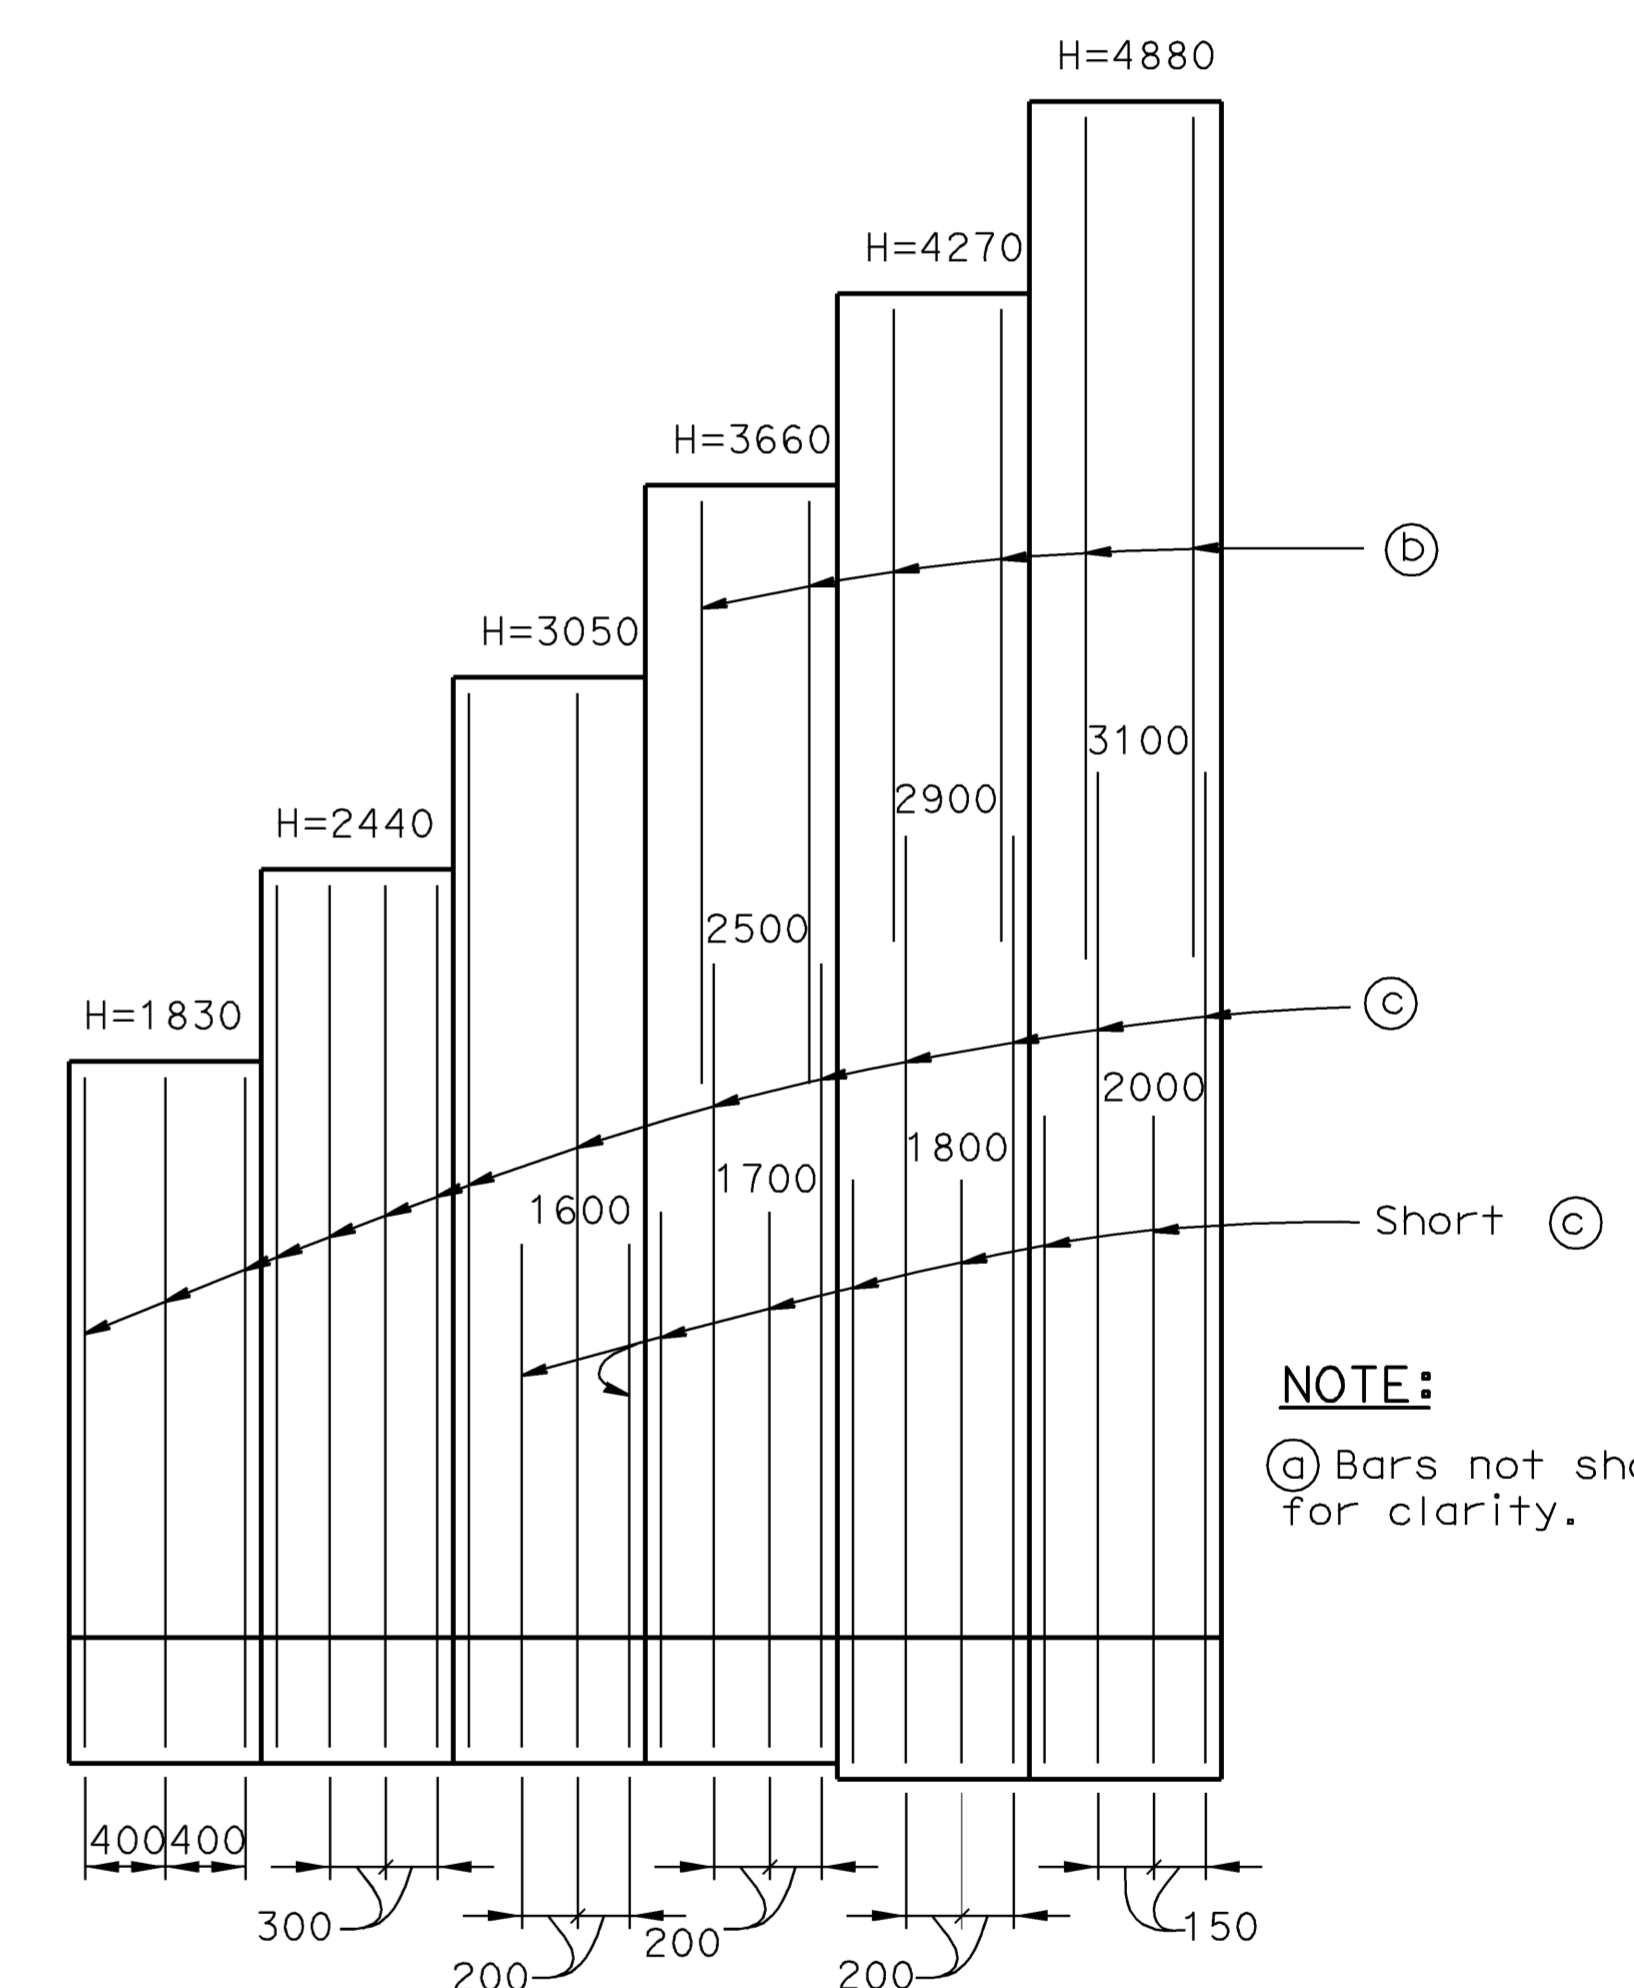
TYPICAL SECTION
No Scale

NOTES:

1. For dimension W, see "General Notes" sheet.
2. Design "H" may be exceeded by 150 mm before going to next size.
3. For footing details not shown, see "Footing Details" sheet.
4. Concrete and steel quantities noted are based on foot of wall length.

TABLE OF REINFORCING STEEL DIMENSIONS AND DATA FOR WALL						
Design H	1830	2440	3050	3660	4270	4880
Batter V:H	100:6	100:6	100:6	100:6	100:6	100:6
C	760	760	760	760	840	840
F	535	535	535	535	685	685
⌋ (a) bars # @ "	16 @ 400	16 @ 300	19 @ 400	16 @ 200	19 @ 200	16 @ 150
(b) bars # @ "	-	-	-	16 @ 400	16 @ 400	16 @ 300
⌈ (c) bars # @ "	16 @ 400	19 @ 300	19 @ 200	22 @ 200	25 @ 200	25 @ 150
(d) bars # @ "	19 @ 400	19 @ 300	16 @ 200	19 @ 200	19 @ 200	19 @ 150
⌋ (e) bars # @ "	19 @ 400	19 @ 300	22 @ 200	25 @ 200	25 @ 200	29 @ 150
Concrete (m ³ /m)	0.70	0.95	1.25	1.56	1.88	2.23
* Steel (kg/m)	74.41	116.08	165.19	226.20	287.22	391.39

* Including all wall stem reinforcement and footing slab (d), (e) bars.



ELEVATION
No Scale

NOTE:
ⓐ Bars not shown for clarity.

ALL DIMENSIONS ARE IN MILLIMETERS UNLESS OTHERWISE SHOWN
WATER POLLUTION CONTROL DETAILS
WD-4

RELEASE DATE --- FILE NO. --- DESIGN BY <i>D. Dunrud</i> DETAILS BY <i>J&P Peterson</i> SUBMITTED BY <i>J&P Peterson</i>	CHECKED <i>J&P Peterson</i> CHECKED <i>J&P Peterson</i> DRAWING DATE <i>8/07</i>	STATE OF CALIFORNIA DEPARTMENT OF TRANSPORTATION	DIVISION OF ENGINEERING SERVICES	BRIDGE NO. MILE POST	AUSTIN VAULT SAND FILTER WALL DETAILS
ORIGINAL SCALE IN MILLIMETERS FOR REDUCED PLANS		CU 07 EA 121841		DISREGARD PRINTS BEARING EARLIER REVISION DATES	
USERNAME => trannda DGN FILE => 7121841h004.dgn		REVISION DATES (PRELIMINARY STAGE ONLY)		SHEET 4 OF 11	


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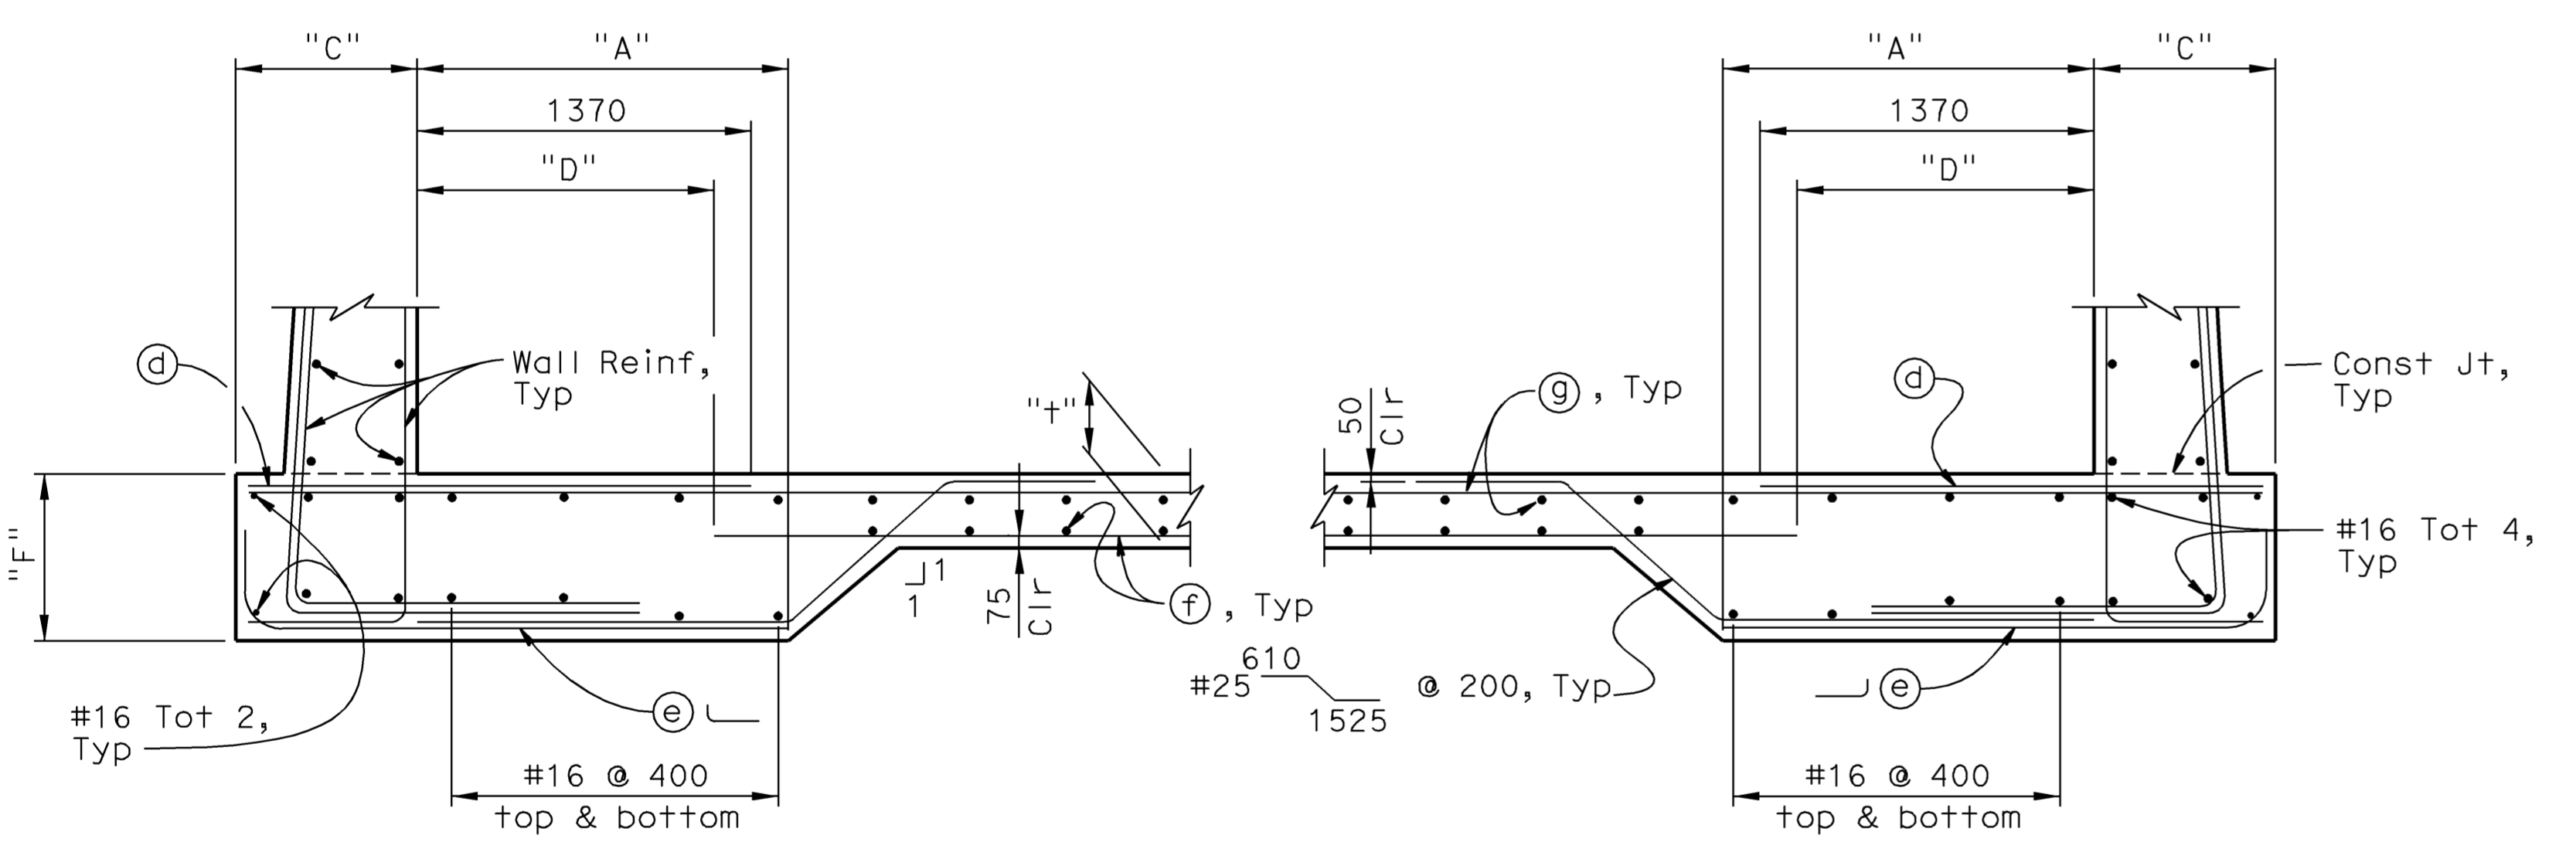
DIST.	COUNTY	ROUTE	MILE POST TOTAL PROJECT	SHEET NO.	TOTAL SHEETS
07	LA	5	42.8/47.3	80	1073

Douglas Dunrud
 REGISTERED ENGINEER - CIVIL
 No. 47240
 Exp. 12/31/09
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6-8-09
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TYPICAL FOOTING (TYPE 1)
No Scale



TYPICAL FOOTING (TYPE 2)
No Scale

"t" - 380 for Sediment Basin
 380 for Filtration Basin if all adjacent walls H ≤ 3660
 535 for Filtration Basin if any adjacent walls H = 4270 or 4880

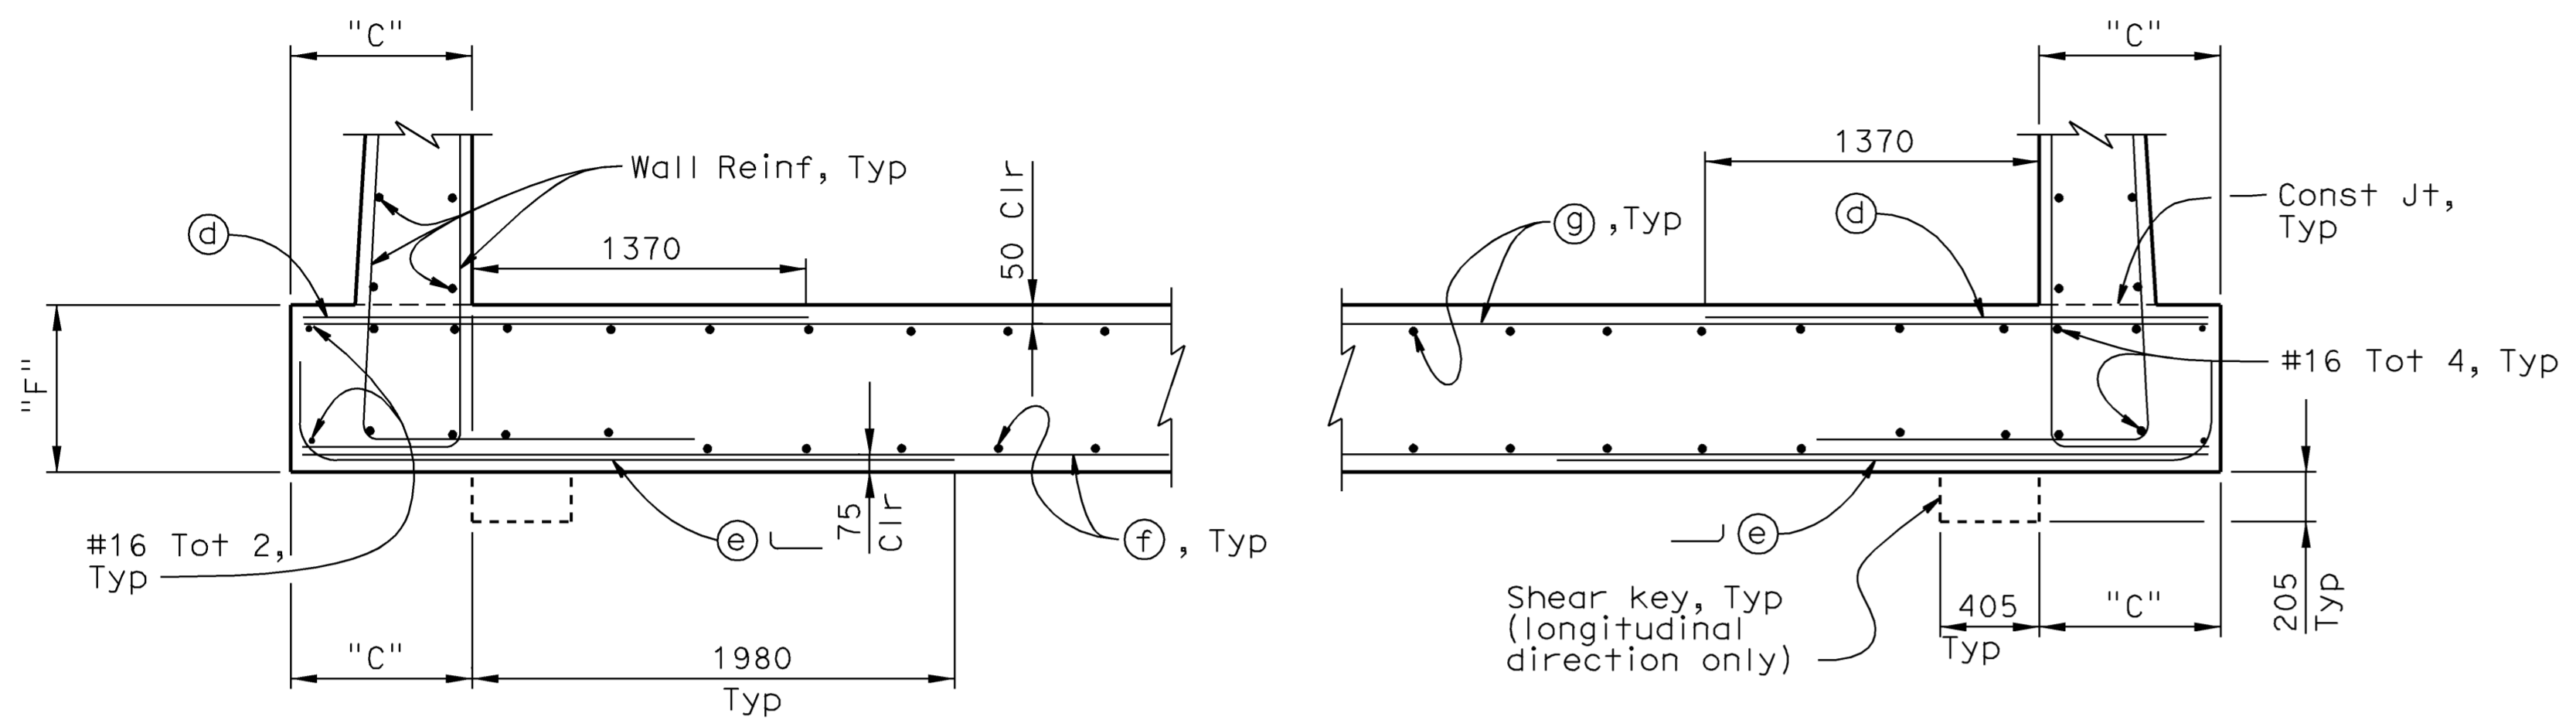TABLE OF REINFORCING STEEL DIMENSIONS AND DATA FOR INVERT								
		W	5485	7315	8230	9145	10975	13715
		A	-	-	1830	1830	1830	1830
		D	1220	1220	1220	1220	1220	1220
Footing Type		1	1	2	2	2	2	2
Sediment basin	(f) bars # @ "	19 @ 200	19 @ 200	19 @ 200	16 @ 200	19 @ 200	19 @ 200	19 @ 200
	(g) bars # @ "	16 @ 200	16 @ 200	16 @ 200	16 @ 200	16 @ 200	16 @ 200	16 @ 200
Filtration basin	(f) bars # @ "	29 @ 150	29 @ 150	22 @ 150	22 @ 150	22 @ 150	22 @ 150	22 @ 150
	(g) bars # @ "	19 @ 150	19 @ 150	16 @ 150	16 @ 150	16 @ 150	16 @ 150	16 @ 150
Concrete (m ³ /basin type) see Note 2	Sediment basin	31.4	52.8	32.1	67.3	50.5	69.6	
	Filtration basin if H ≤ 3660	78.0	143.7	64.2	178.1	116.2	165.1	
	Filtration basin if H = 4270 or 4880	101.7	186.6	85.6	240.1	156.0	222.5	
Steel (kg/basin type) see Note 2	Sediment basin	2113	3498	2131	5222	3700	5281	
	Filtration basin if H ≤ 3660	12554	23763	6530	20148	13202	19830	
	Filtration basin if H = 4270 or 4880	12722	24009	6616	20368	13334	19993	

NOTES:

- For dimensions "C" and "F", and reinforcement "d" and "e", see "Wall Details" sheet.
- Quantities noted are for the full length and width of each basin type. For total invert quantities of each AVSF type, combine quantities of sedimentation basin and appropriate filtration basin.

ALL DIMENSIONS ARE IN MILLIMETERS UNLESS OTHERWISE SHOWN

WATER POLLUTION CONTROL DETAILS
WD-5

RELEASE DATE --- DESIGN BY <i>D. Dunrud</i> CHECKED <i>J&P Peterson</i>	DETAILS BY <i>J&P Peterson</i> CHECKED <i>J&P Peterson</i>	SUBMITTED BY <i>J&P Peterson</i> DRAWING DATE <i>8/07</i>	STATE OF CALIFORNIA DEPARTMENT OF TRANSPORTATION	DIVISION OF ENGINEERING SERVICES	BRIDGE NO. MILE POST	AUSTIN VAULT SAND FILTER FOOTING DETAILS	REVISION DATES (PRELIMINARY STAGE ONLY)	SHEET 5 OF 11
ORIGINAL SCALE IN MILLIMETERS FOR REDUCED PLANS			CU 07 EA 121841		DISREGARD PRINTS BEARING EARLIER REVISION DATES			USERNAME => trandda DGN FILE => 7121841n005.dgn


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DIST.	COUNTY	ROUTE	MILE POST TOTAL PROJECT	SHEET NO.	TOTAL SHEETS
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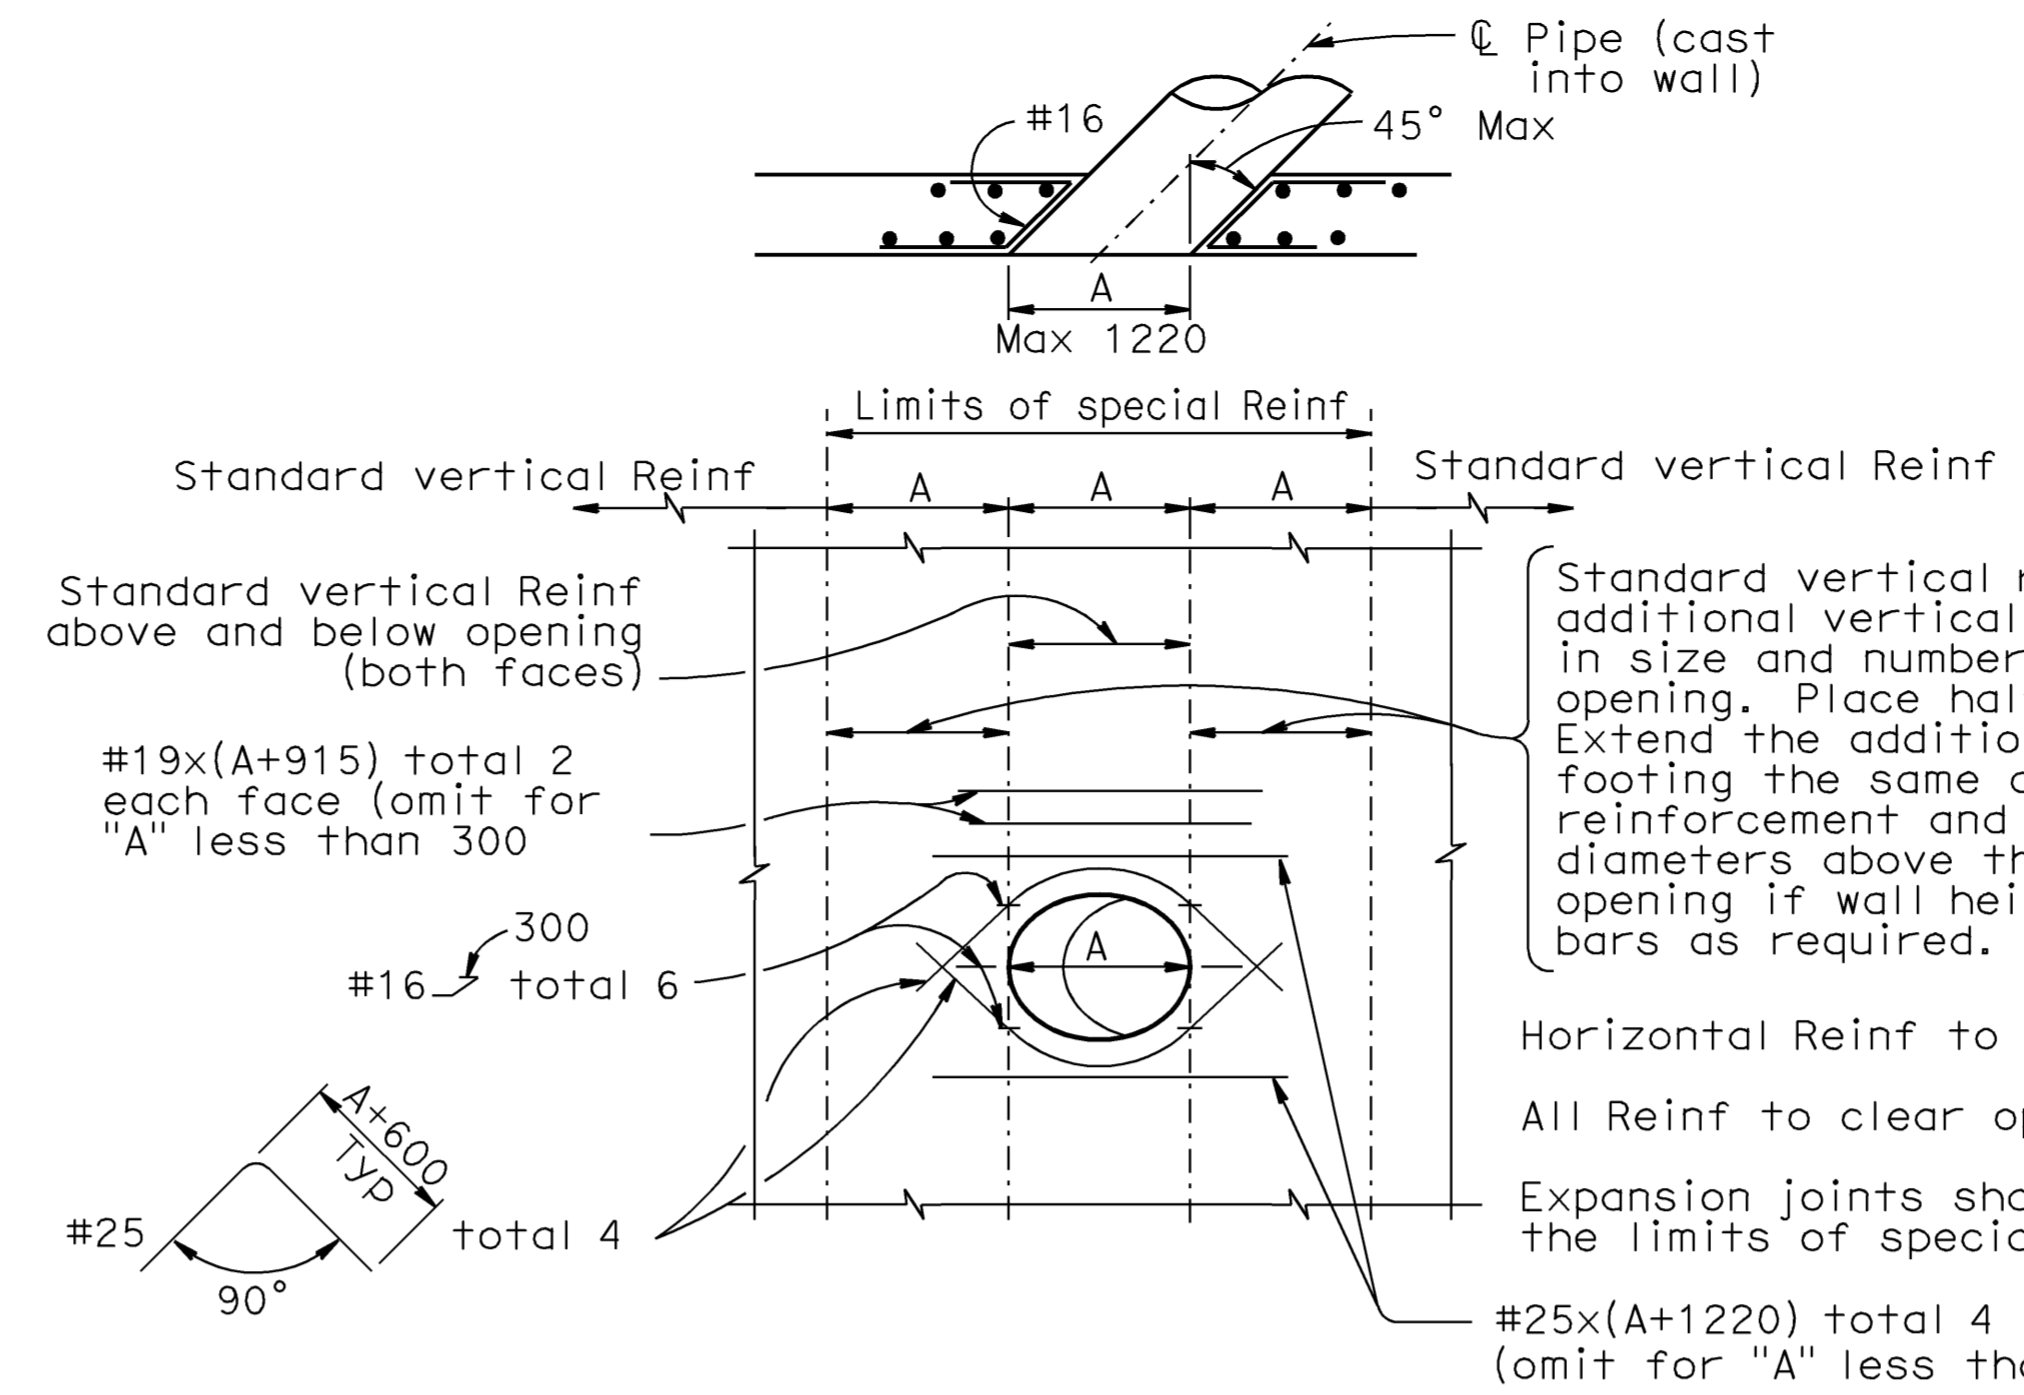
REGISTERED ENGINEER - CIVIL
 DOUGLAS DUNRUD
 No. 47240
 Exp. 12/31/09
 CIVIL
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6-8-09
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PARTIAL PLAN

No Scale
 NOTE: Inlet wall shown, outlet wall similar.



WALL OPENING DETAIL

No Scale
 To be used at inlet, outlet and overflow pipe locations

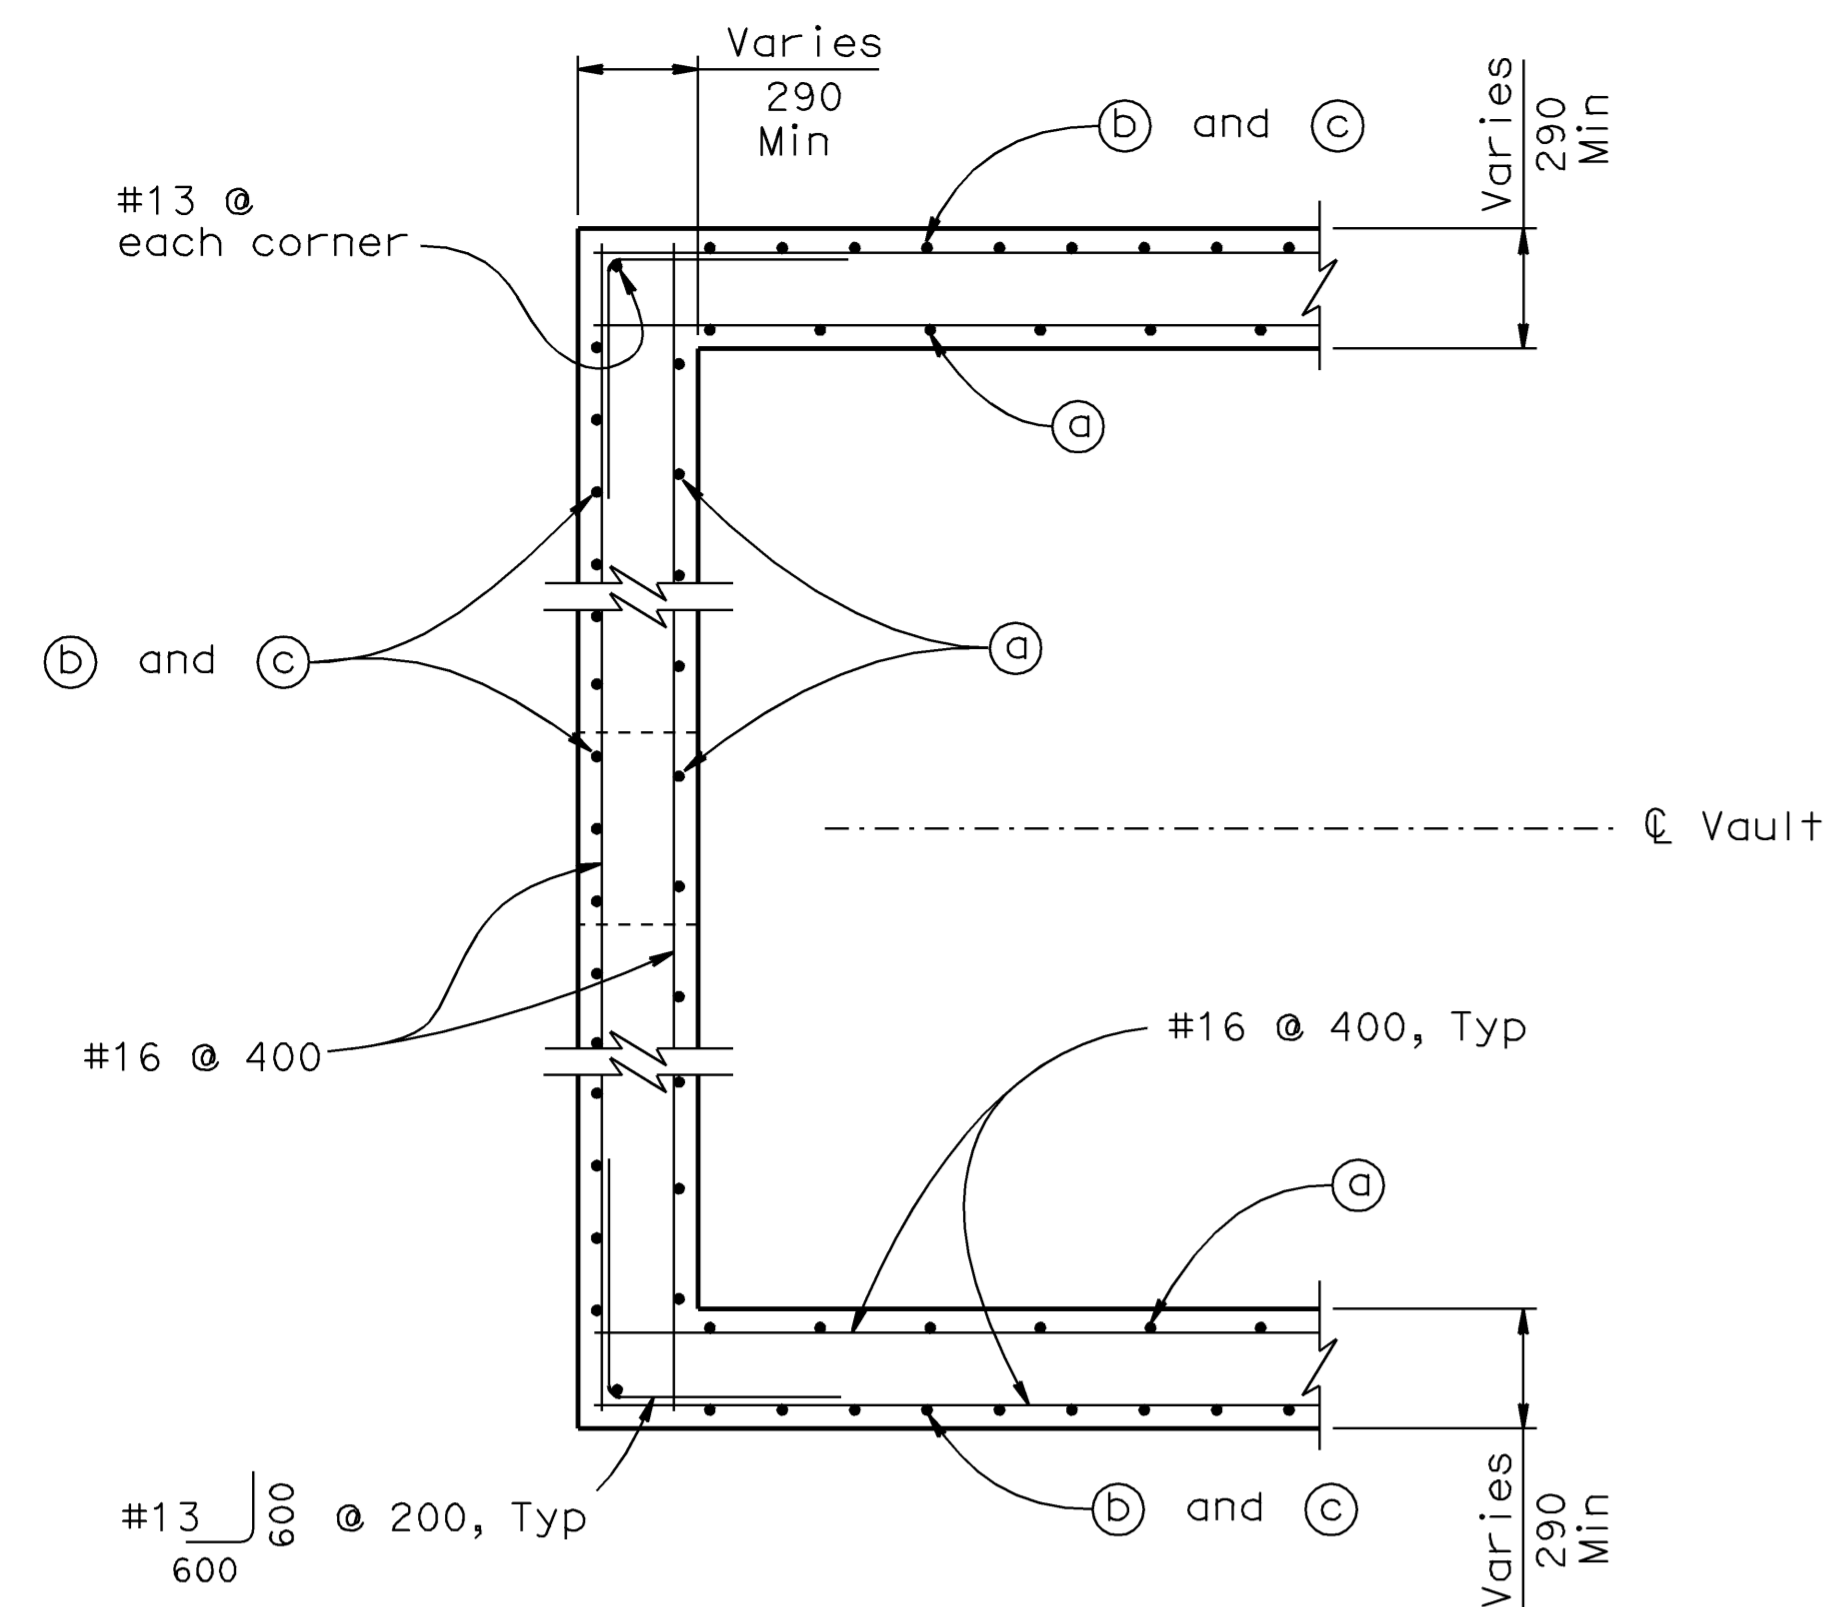Standard vertical reinforcement plus additional vertical bars corresponding in size and number to bars cut by the opening. Place half on each side. Extend the additional bars into the footing the same as other vertical wall reinforcement and to a minimum of 60 diameters above the top of utility opening if wall height permits. Bundle bars as required.


Horizontal Reinf to be standard except as shown.

All Reinf to clear opening by 50 mm minimum.

Expansion joints shall not be located within the limits of special reinforcing.


NOTES:

- For section locations, see "Layout No. 1" sheet.
- For wall and footing reinforcement details, see Typical Section on "Wall Details" sheet.

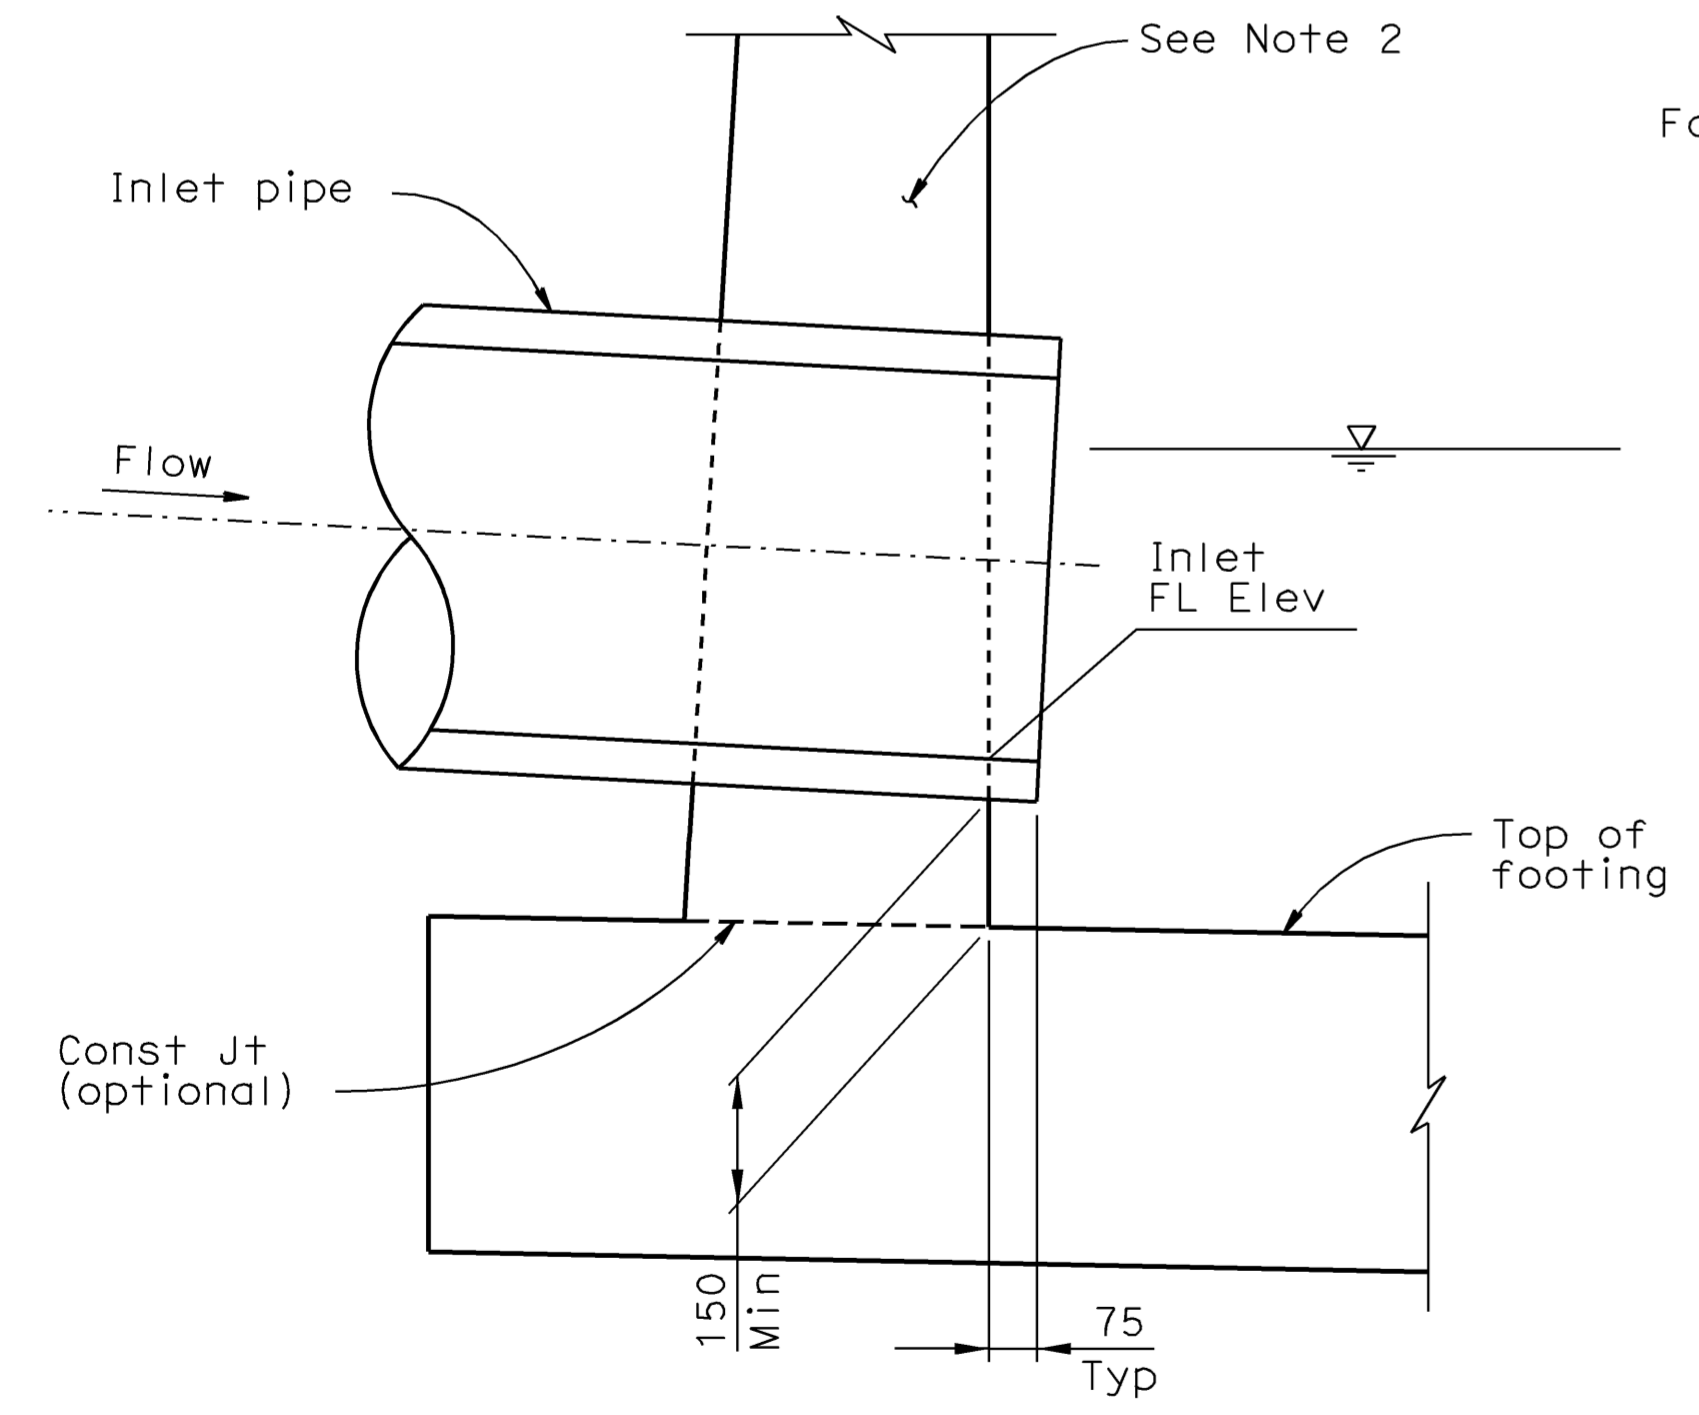


SECTION A - A

No Scale

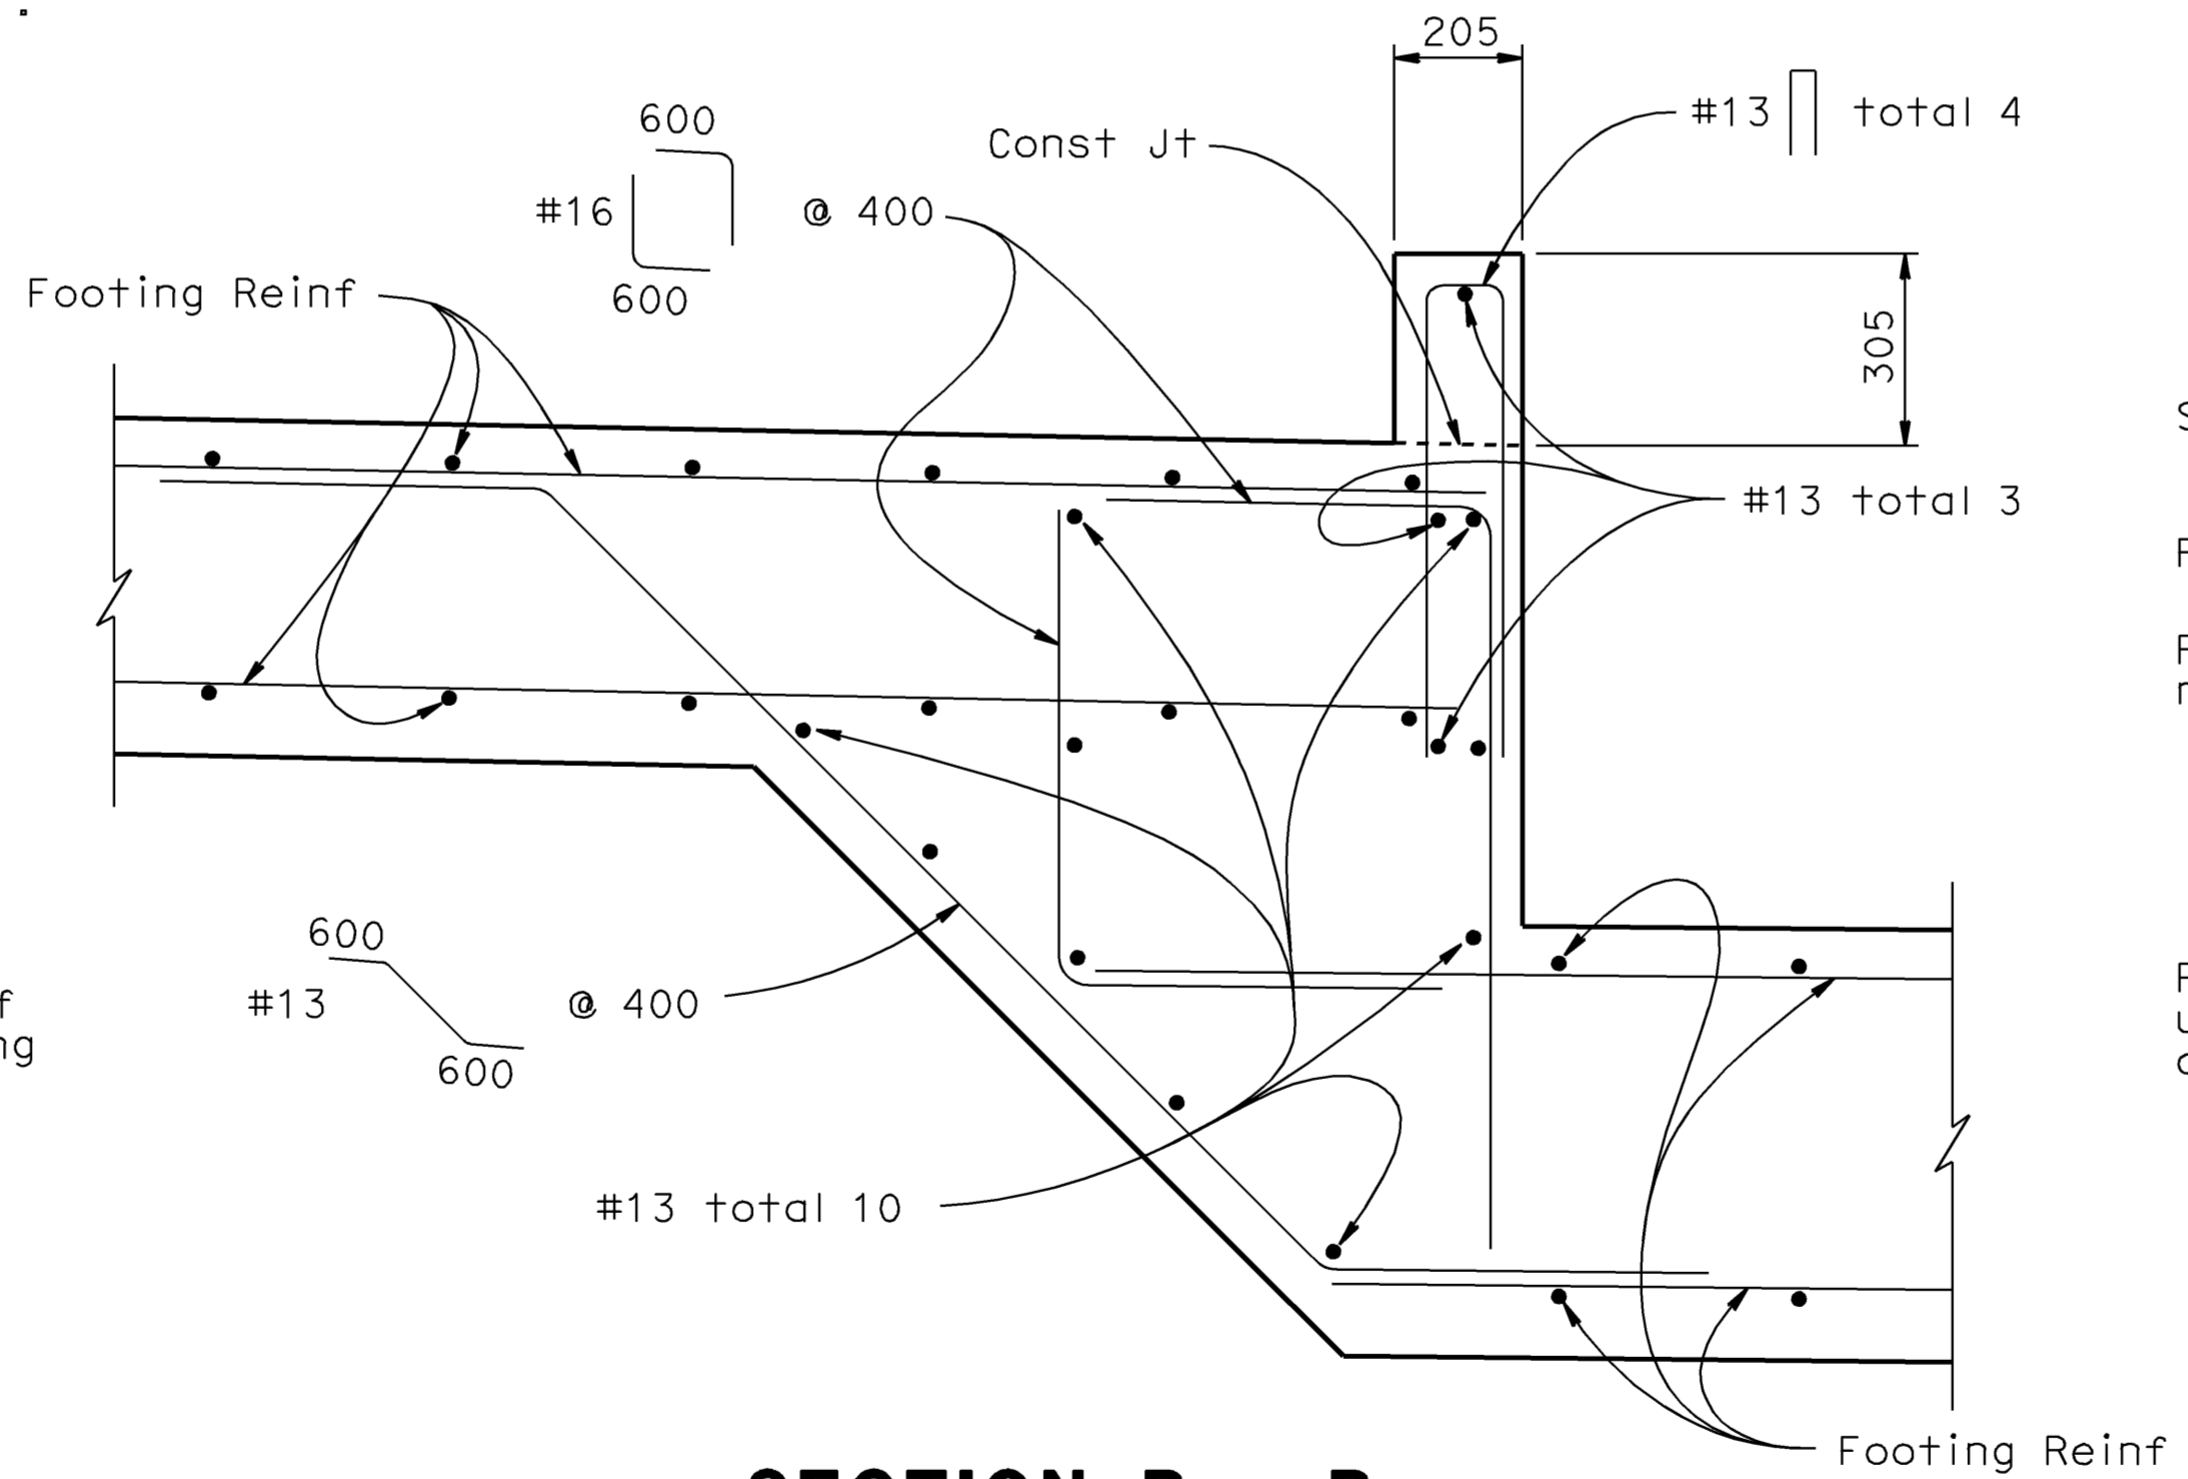

SECTION B - B

No Scale
 (Gabion wall and other details not shown for clarity)

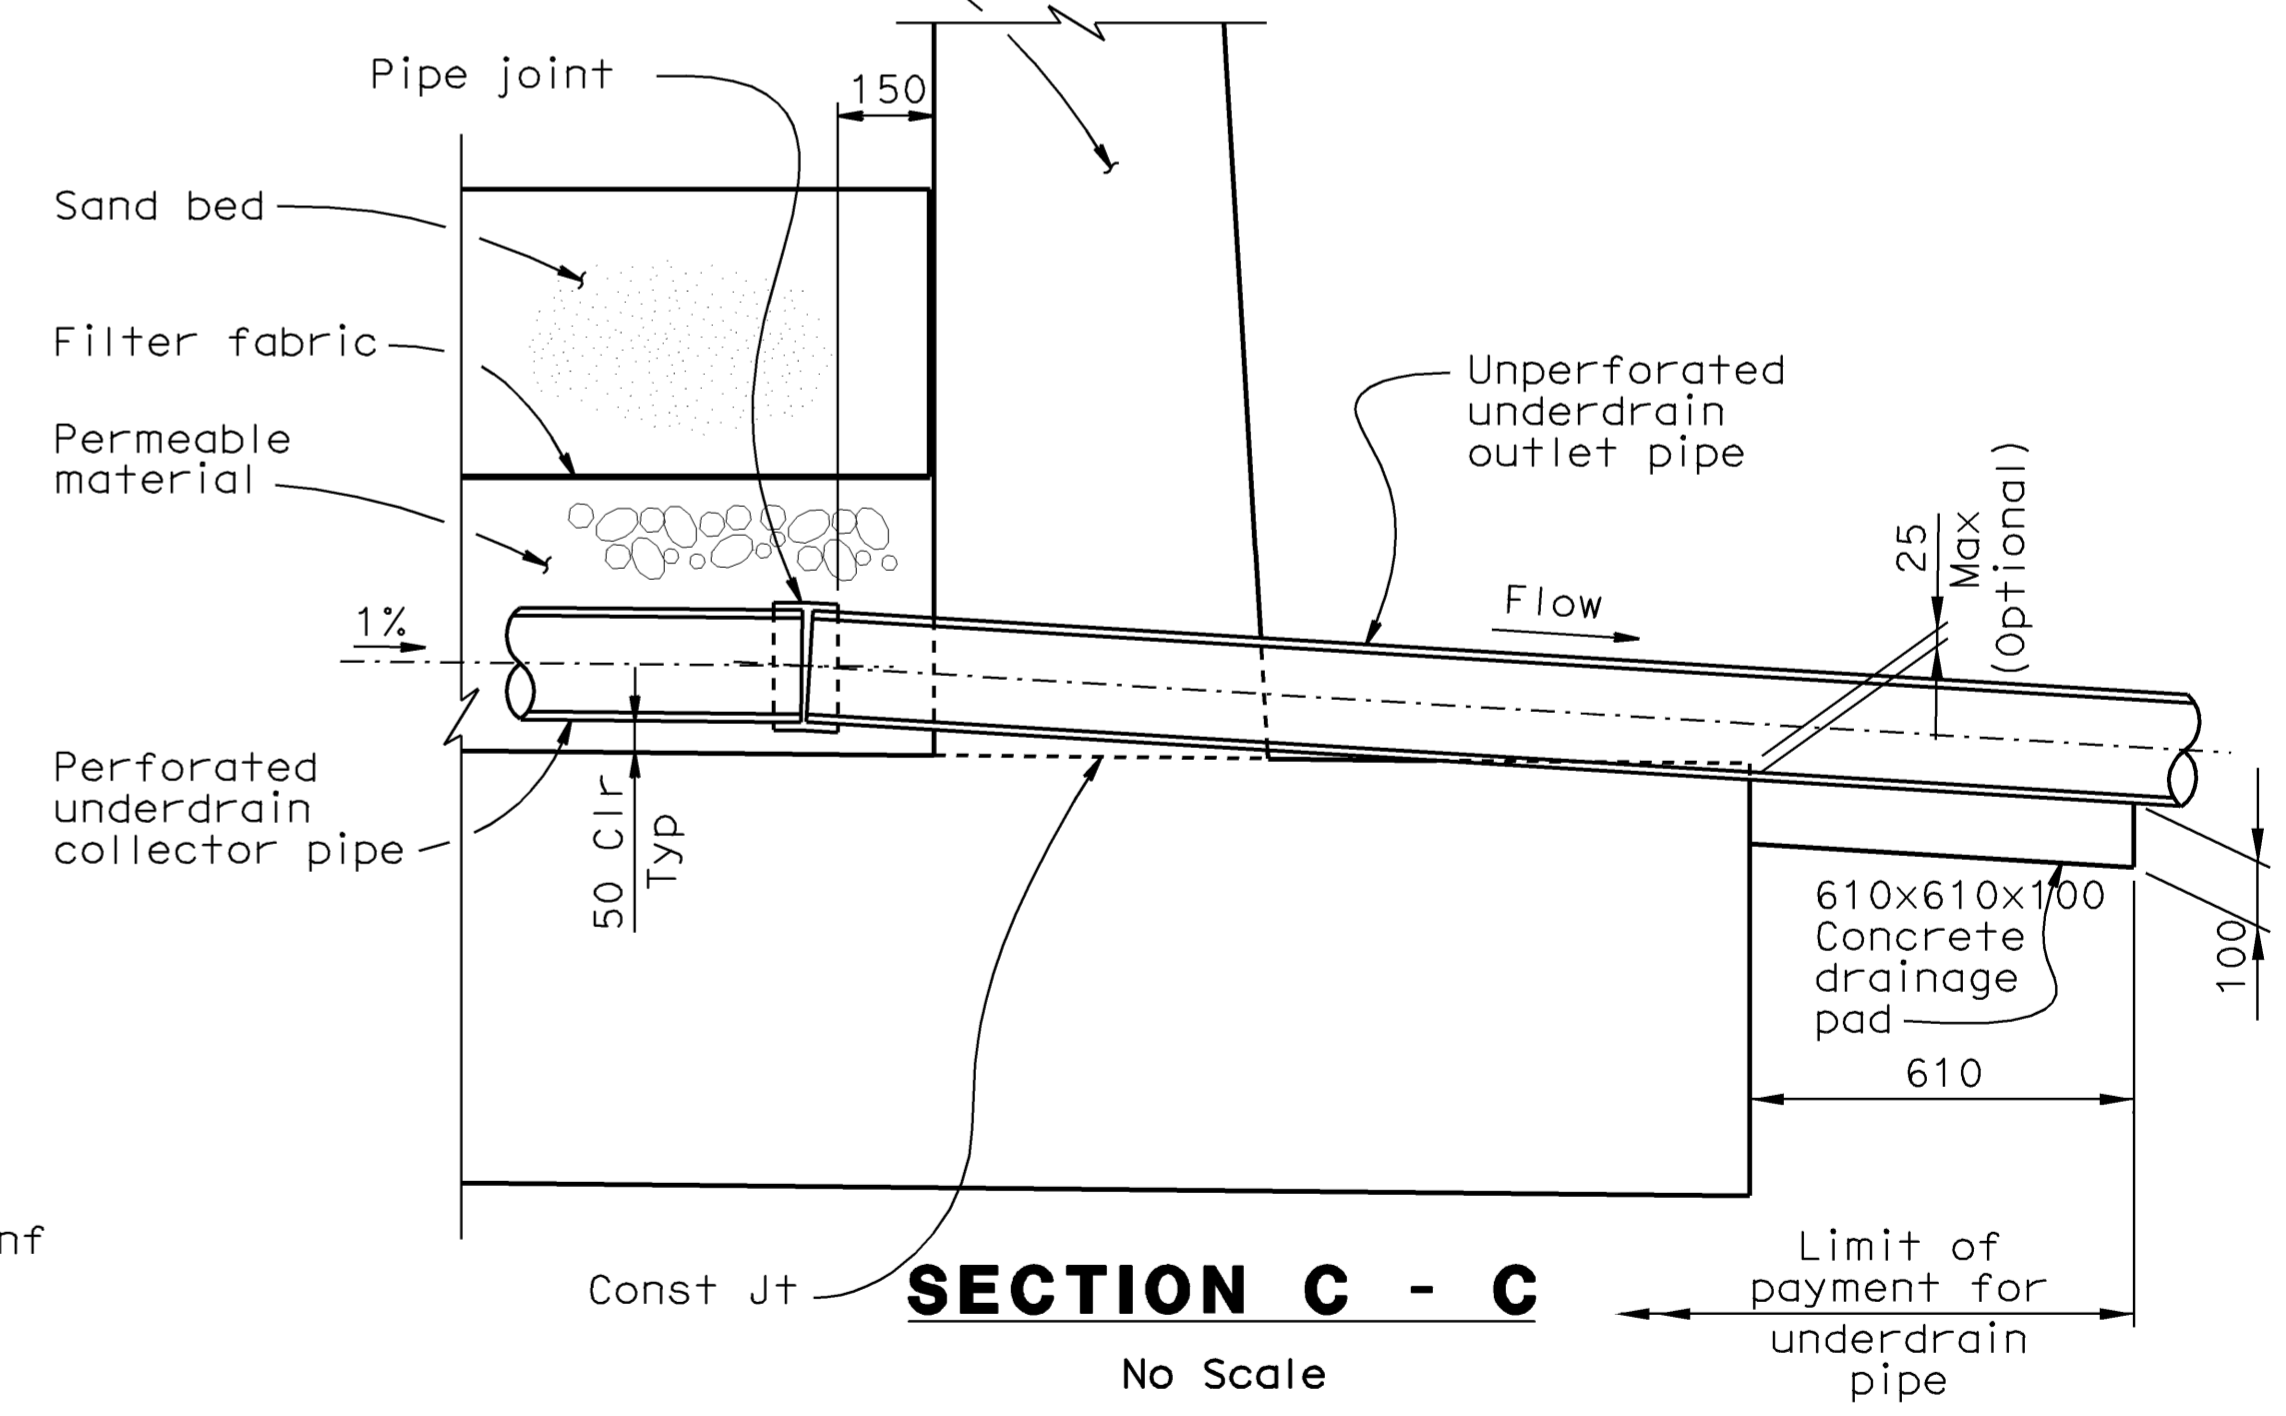

SECTION C - C

No Scale

WATER POLLUTION CONTROL DETAILS

ALL DIMENSIONS ARE IN MILLIMETERS UNLESS OTHERWISE SHOWN


WD-6

RELEASE DATE	DESIGN BY	BY	CHECKED
---	D. Dunrud	J&P Peterson	J&P Peterson
FILE NO.	DETAILS BY	BY	CHECKED
---	J&P Peterson	J&P Peterson	J&P Peterson
	SUBMITTED BY	BY	DRAWING DATE
	J&P Peterson	J&P Peterson	8/07

BRIDGE NO.	
MILE POST	

STATE OF CALIFORNIA	DIVISION OF ENGINEERING SERVICES
DEPARTMENT OF TRANSPORTATION	

AUSTIN VAULT SAND FILTER	
DETAILS No. 1	
REVISION DATES (PRELIMINARY STAGE ONLY)	
SHEET	OF
6	11

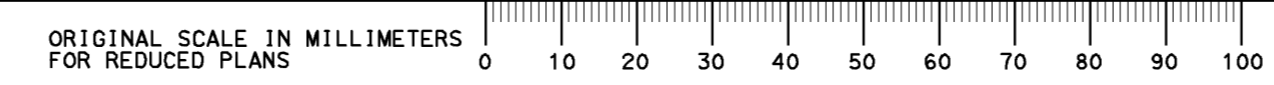

CU 07
EA 121841

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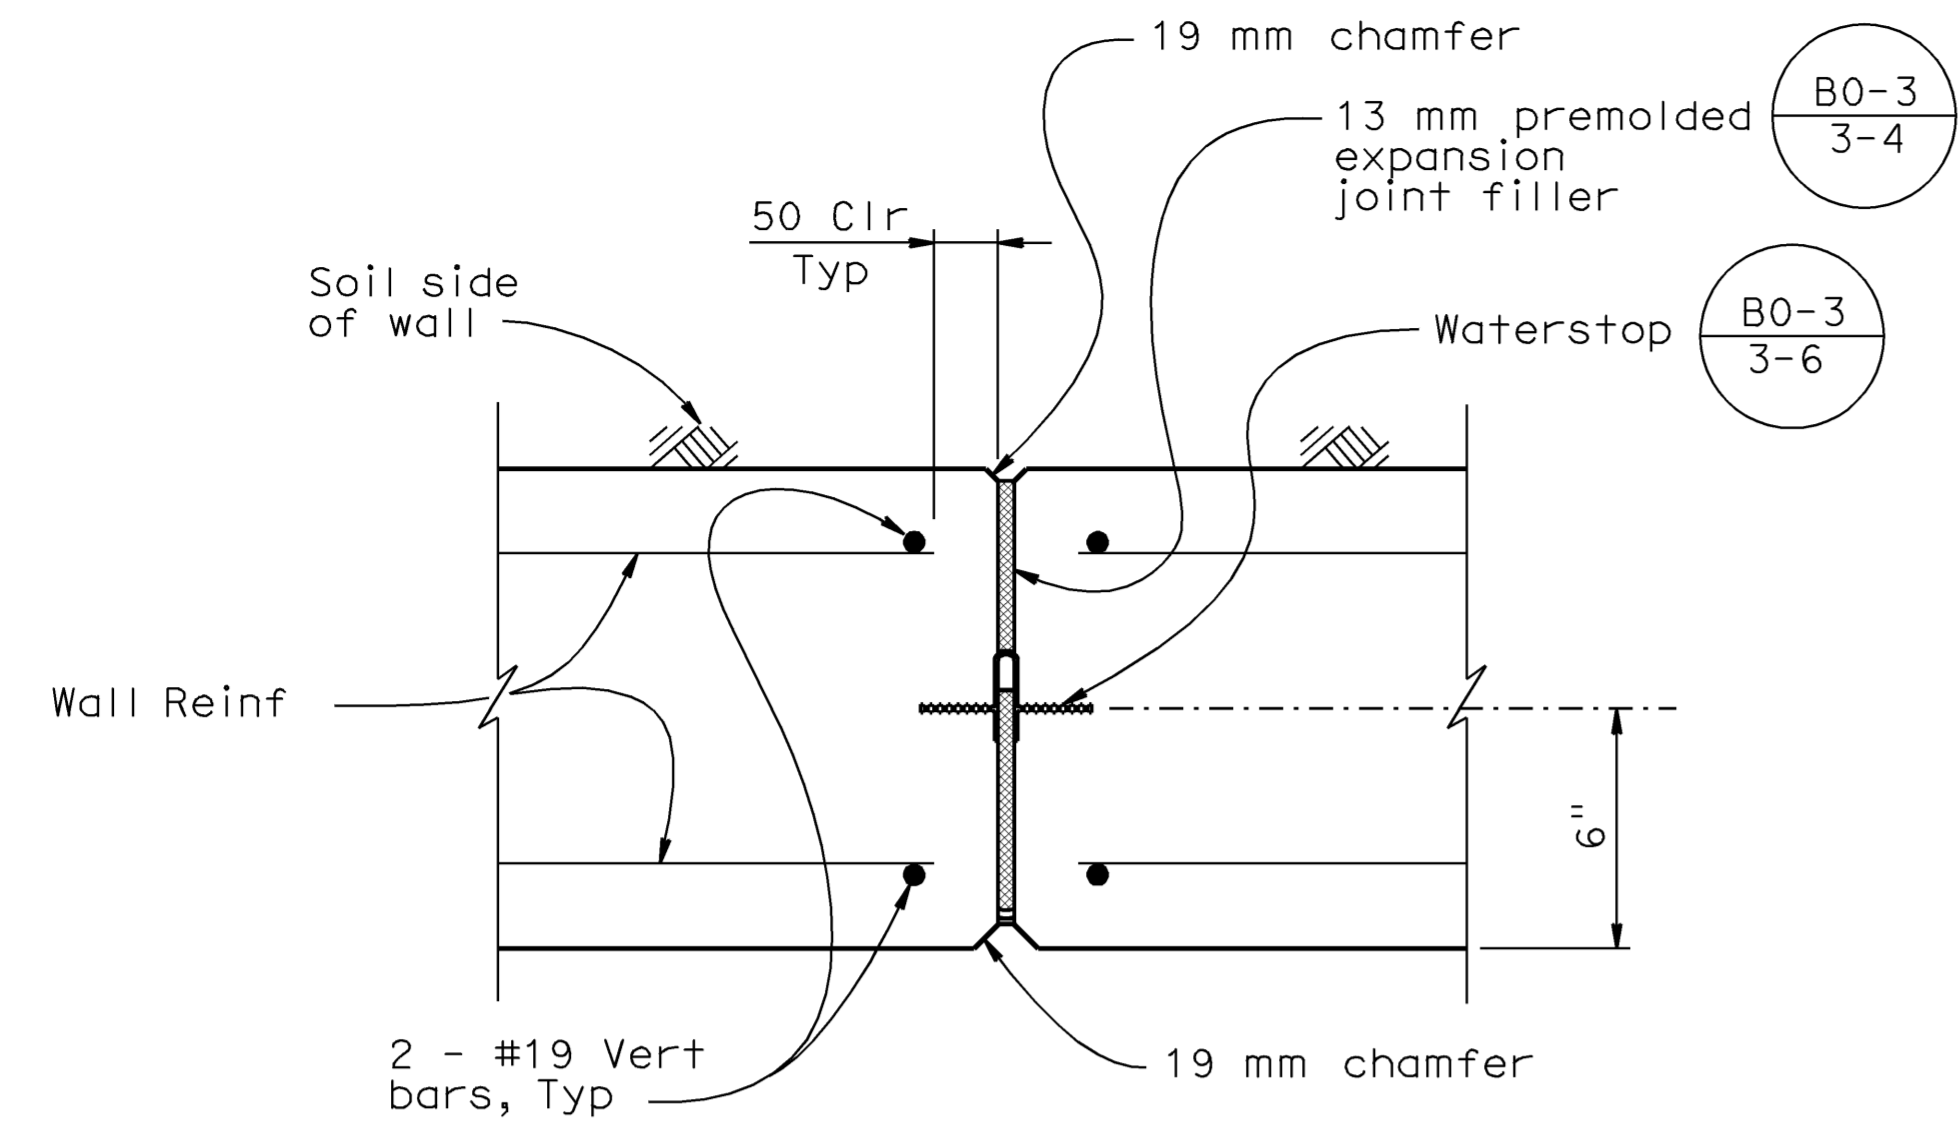
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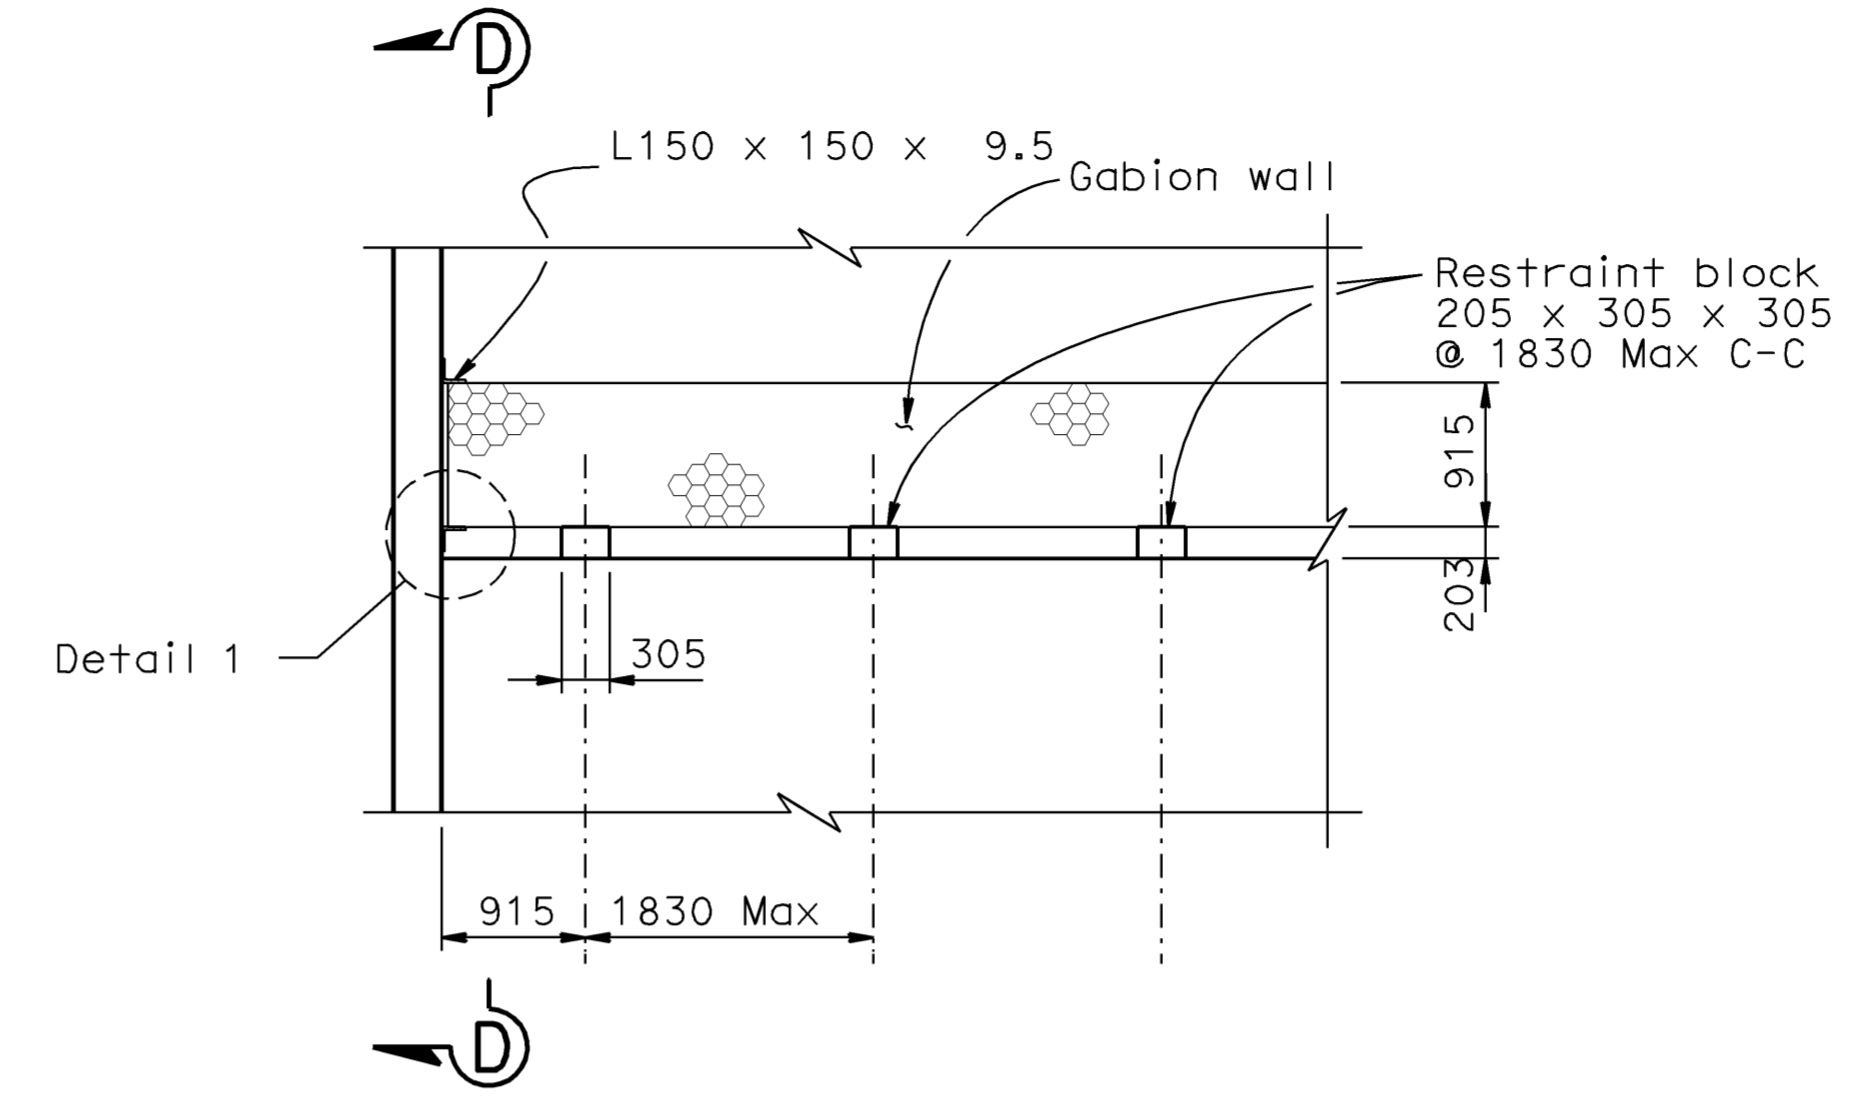


DIST.	COUNTY	ROUTE	MILE POST TOTAL PROJECT	SHEET NO.	TOTAL SHEETS
07	LA	5	42.8/47.3	82	1073


 REGISTERED ENGINEER - CIVIL		
6-8-09 PLANS APPROVAL DATE		
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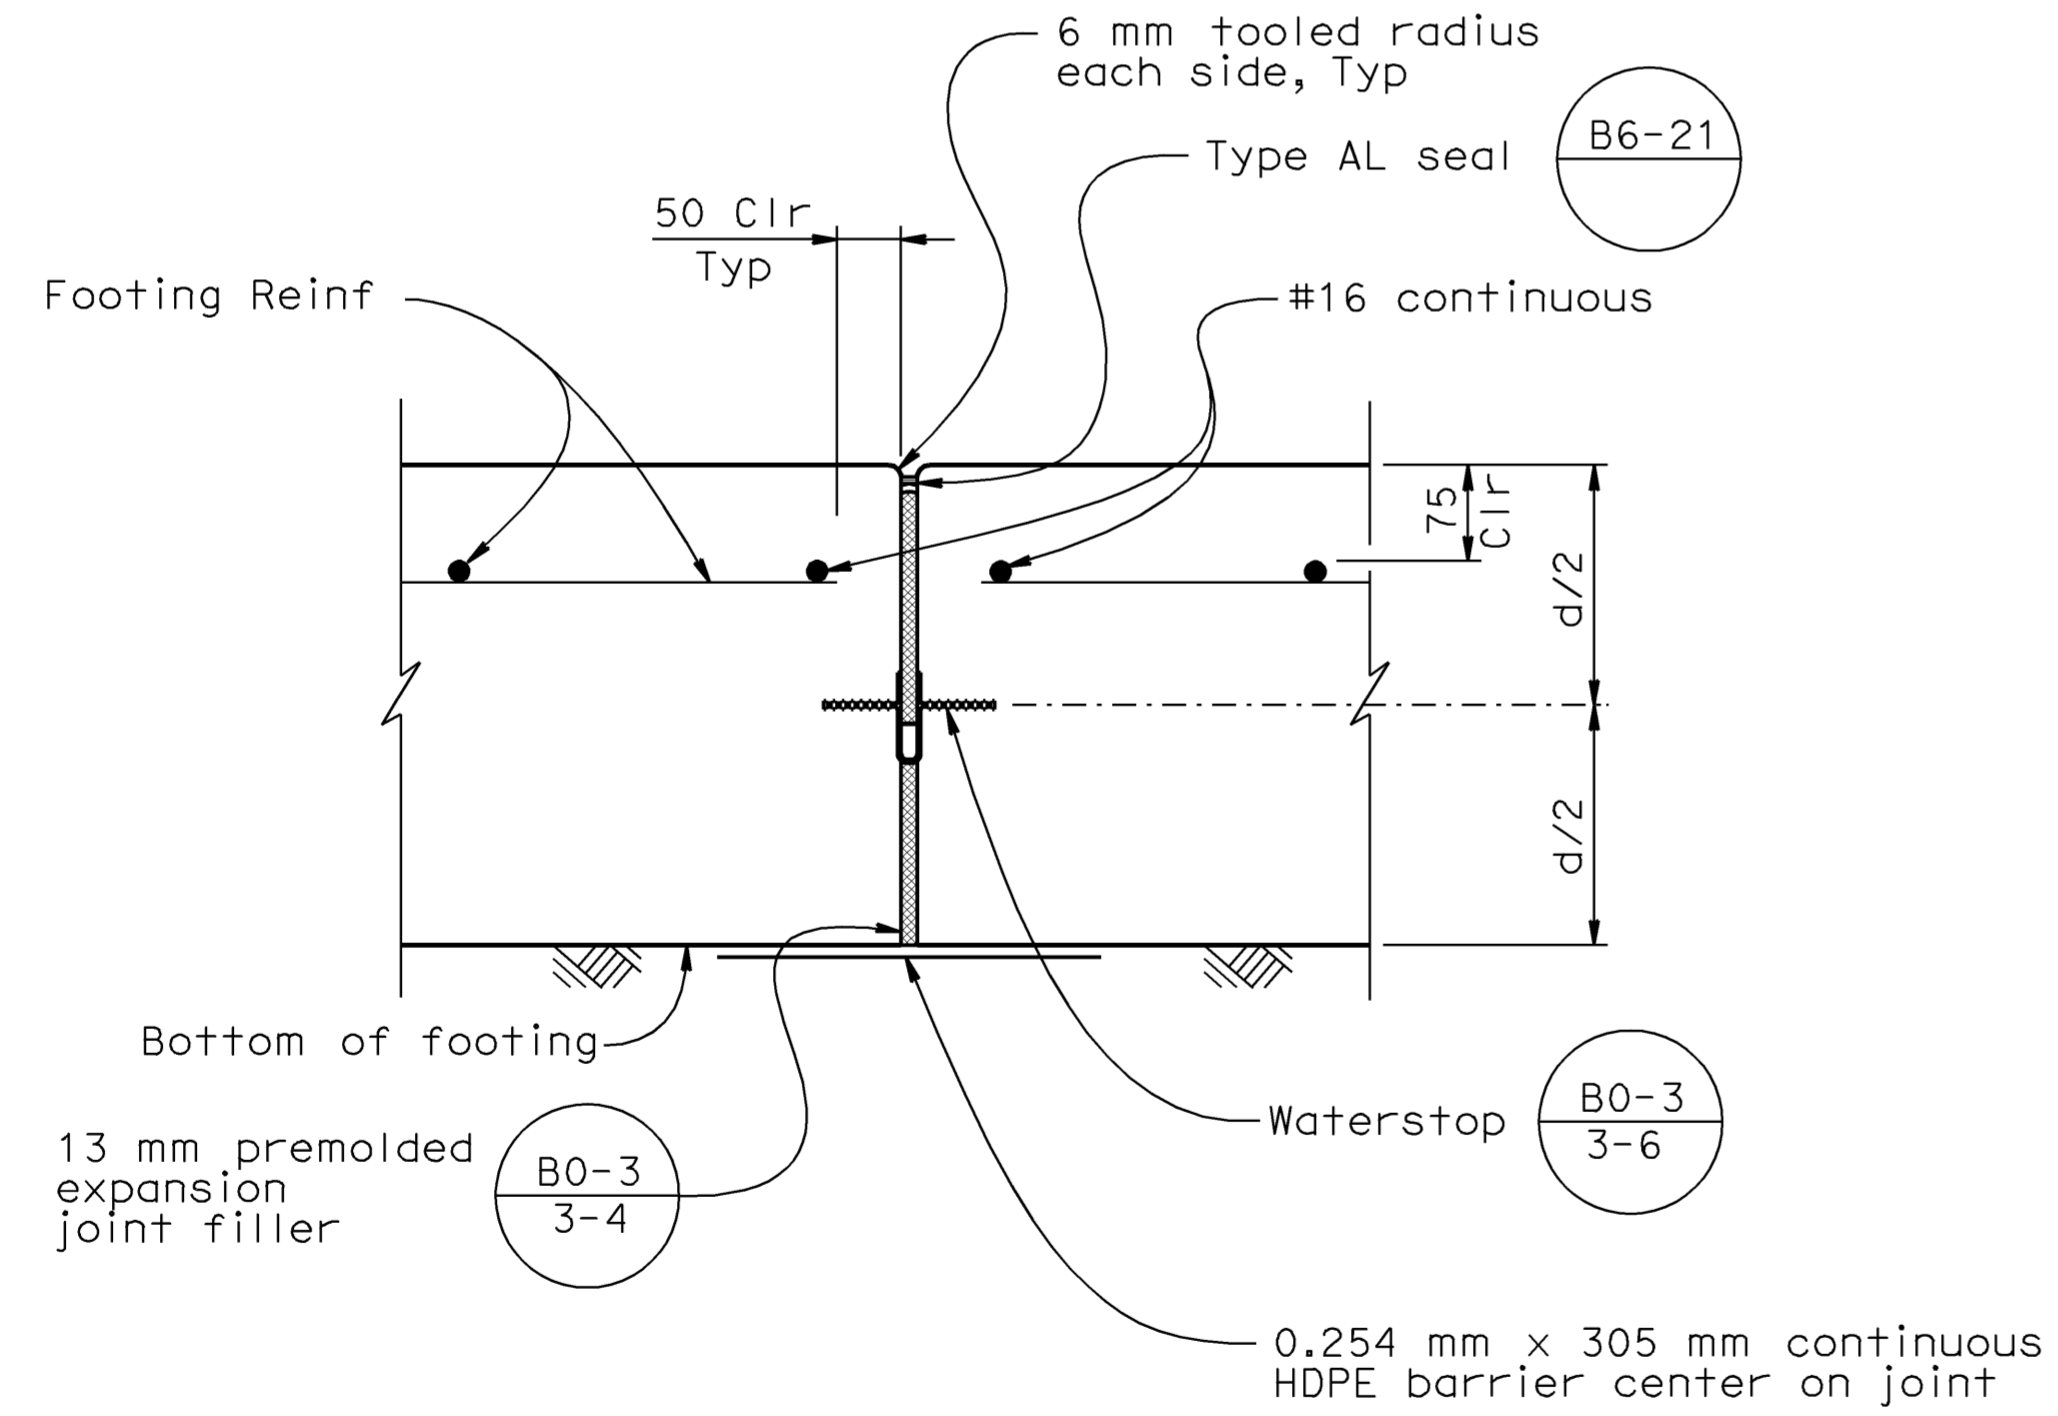
WALL EXPANSION JOINT DETAIL - PLAN SECTION
No Scale




RESTRAINT BLOCK DETAIL
No Scale



DETAIL 1
1:10

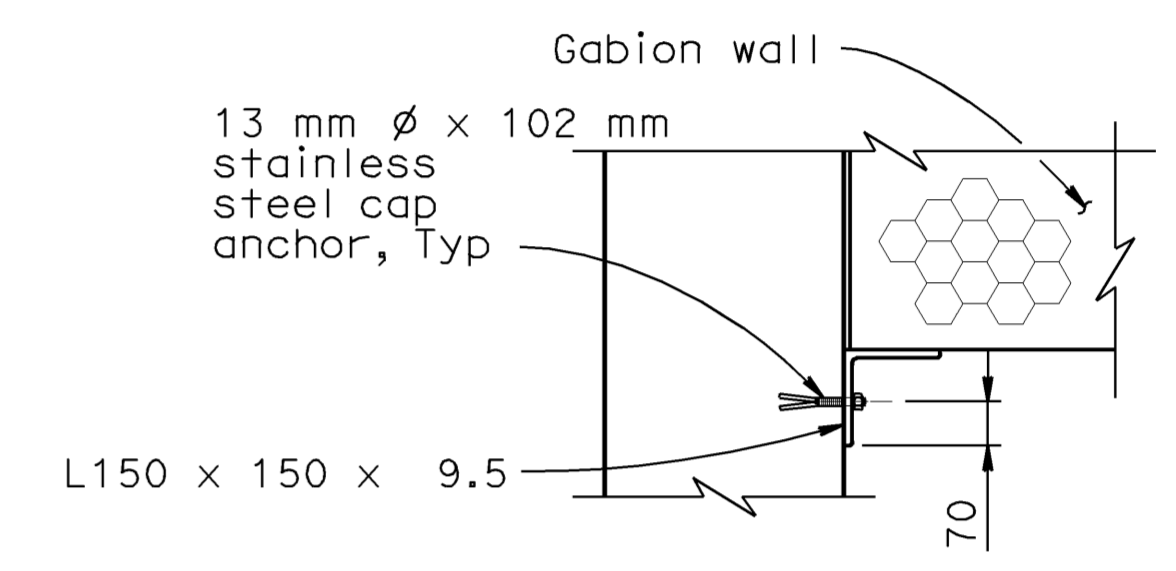

FOOTING EXPANSION JOINT DETAIL
No Scale

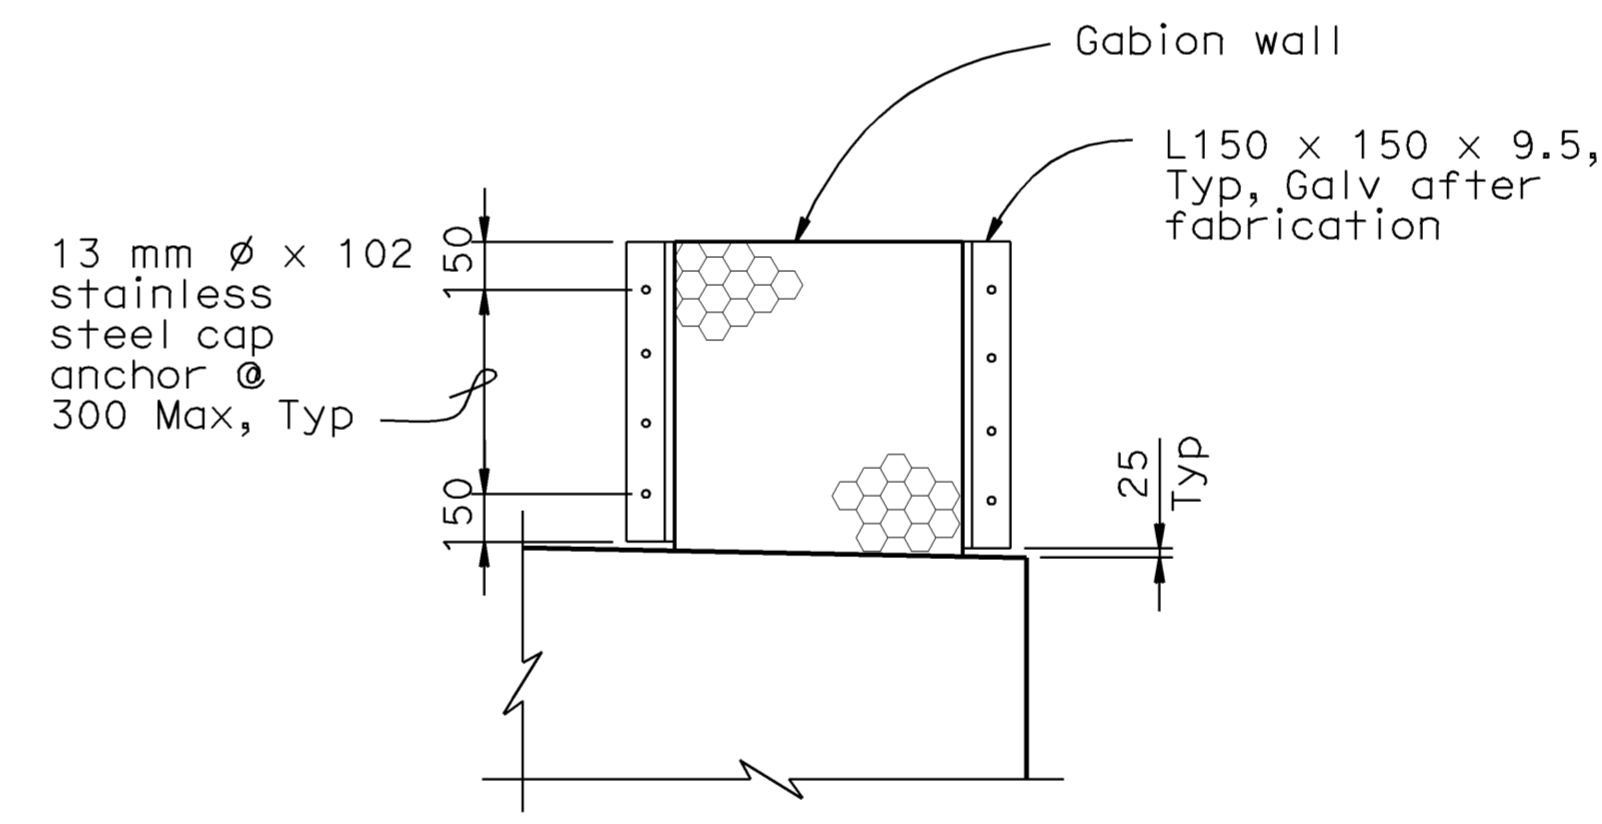

SECTION D - D
No Scale

ALL DIMENSIONS ARE IN MILLIMETERS UNLESS OTHERWISE SHOWN


WATER POLLUTION CONTROL DETAILS
WD-7

RELEASE DATE ---	DESIGN BY <i>D. Dunrud</i>	CHECKED <i>J&P Peterson</i>
FILE NO. ---	DETAILS BY <i>J&P Peterson</i>	CHECKED <i>J&P Peterson</i>
	SUBMITTED BY <i>J&P Peterson</i>	DRAWING DATE <i>8/07</i>

STATE OF CALIFORNIA
DEPARTMENT OF TRANSPORTATION

DIVISION OF ENGINEERING SERVICES

BRIDGE NO.	AUSTIN VAULT SAND FILTER
MILE POST	
DETAILS No. 2	

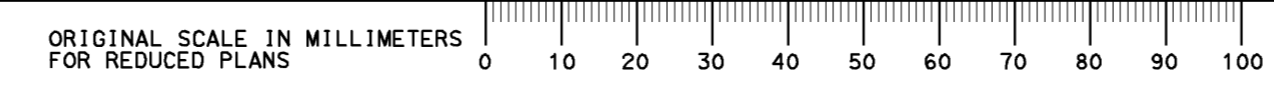

CU 07
EA 121841

DISREGARD PRINTS BEARING EARLIER REVISION DATES	REVISION DATES (PRELIMINARY STAGE ONLY)	SHEET 7 OF 11
---	---	---------------

USERNAME => trandda
DGN FILE => 7121841n007.dgn


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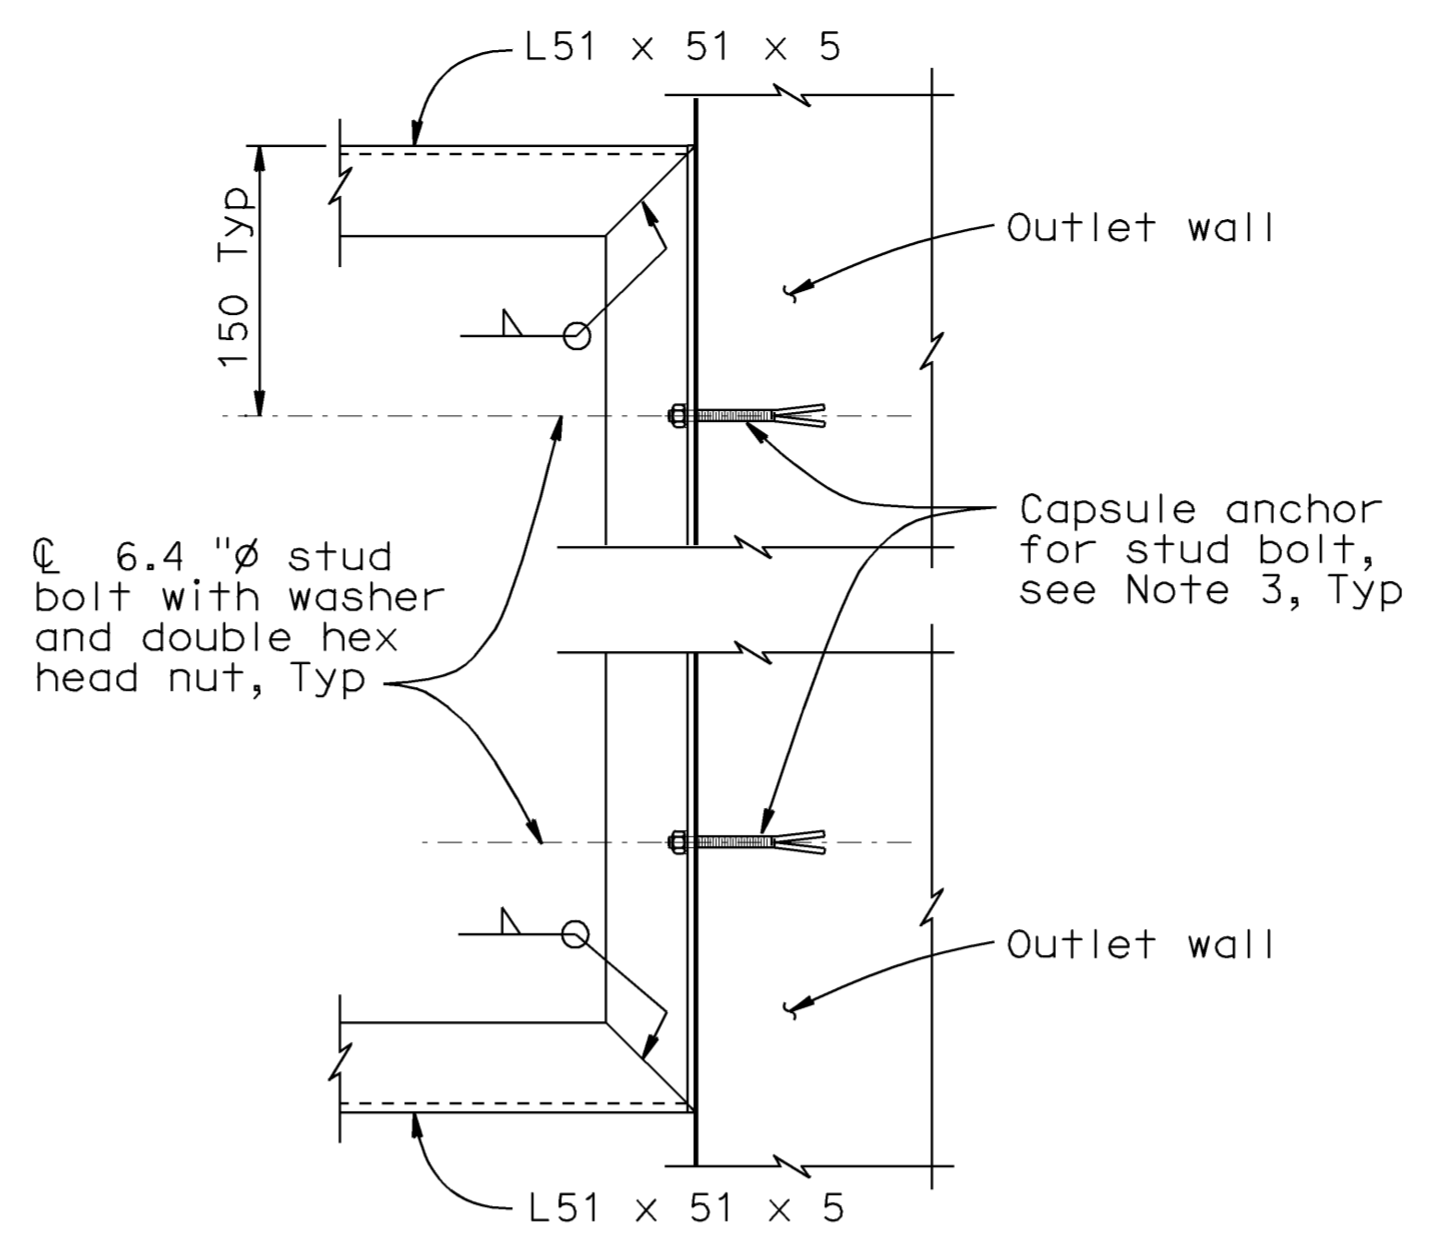
DIST.	COUNTY	ROUTE	MILE POST TOTAL PROJECT	SHEET NO.	TOTAL SHEETS
07	LA	5	42.8/47.3	83	1073

REGISTERED ENGINEER - CIVIL
 DOUGLAS DUNRUD
 No. 47240
 Exp. 12/31/09
 CIVIL
 STATE OF CALIFORNIA


6-8-09
 PLANS APPROVAL DATE
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TRASH SCREEN - SIDE ELEVATION
No scale



SECTION F - F
No Scale

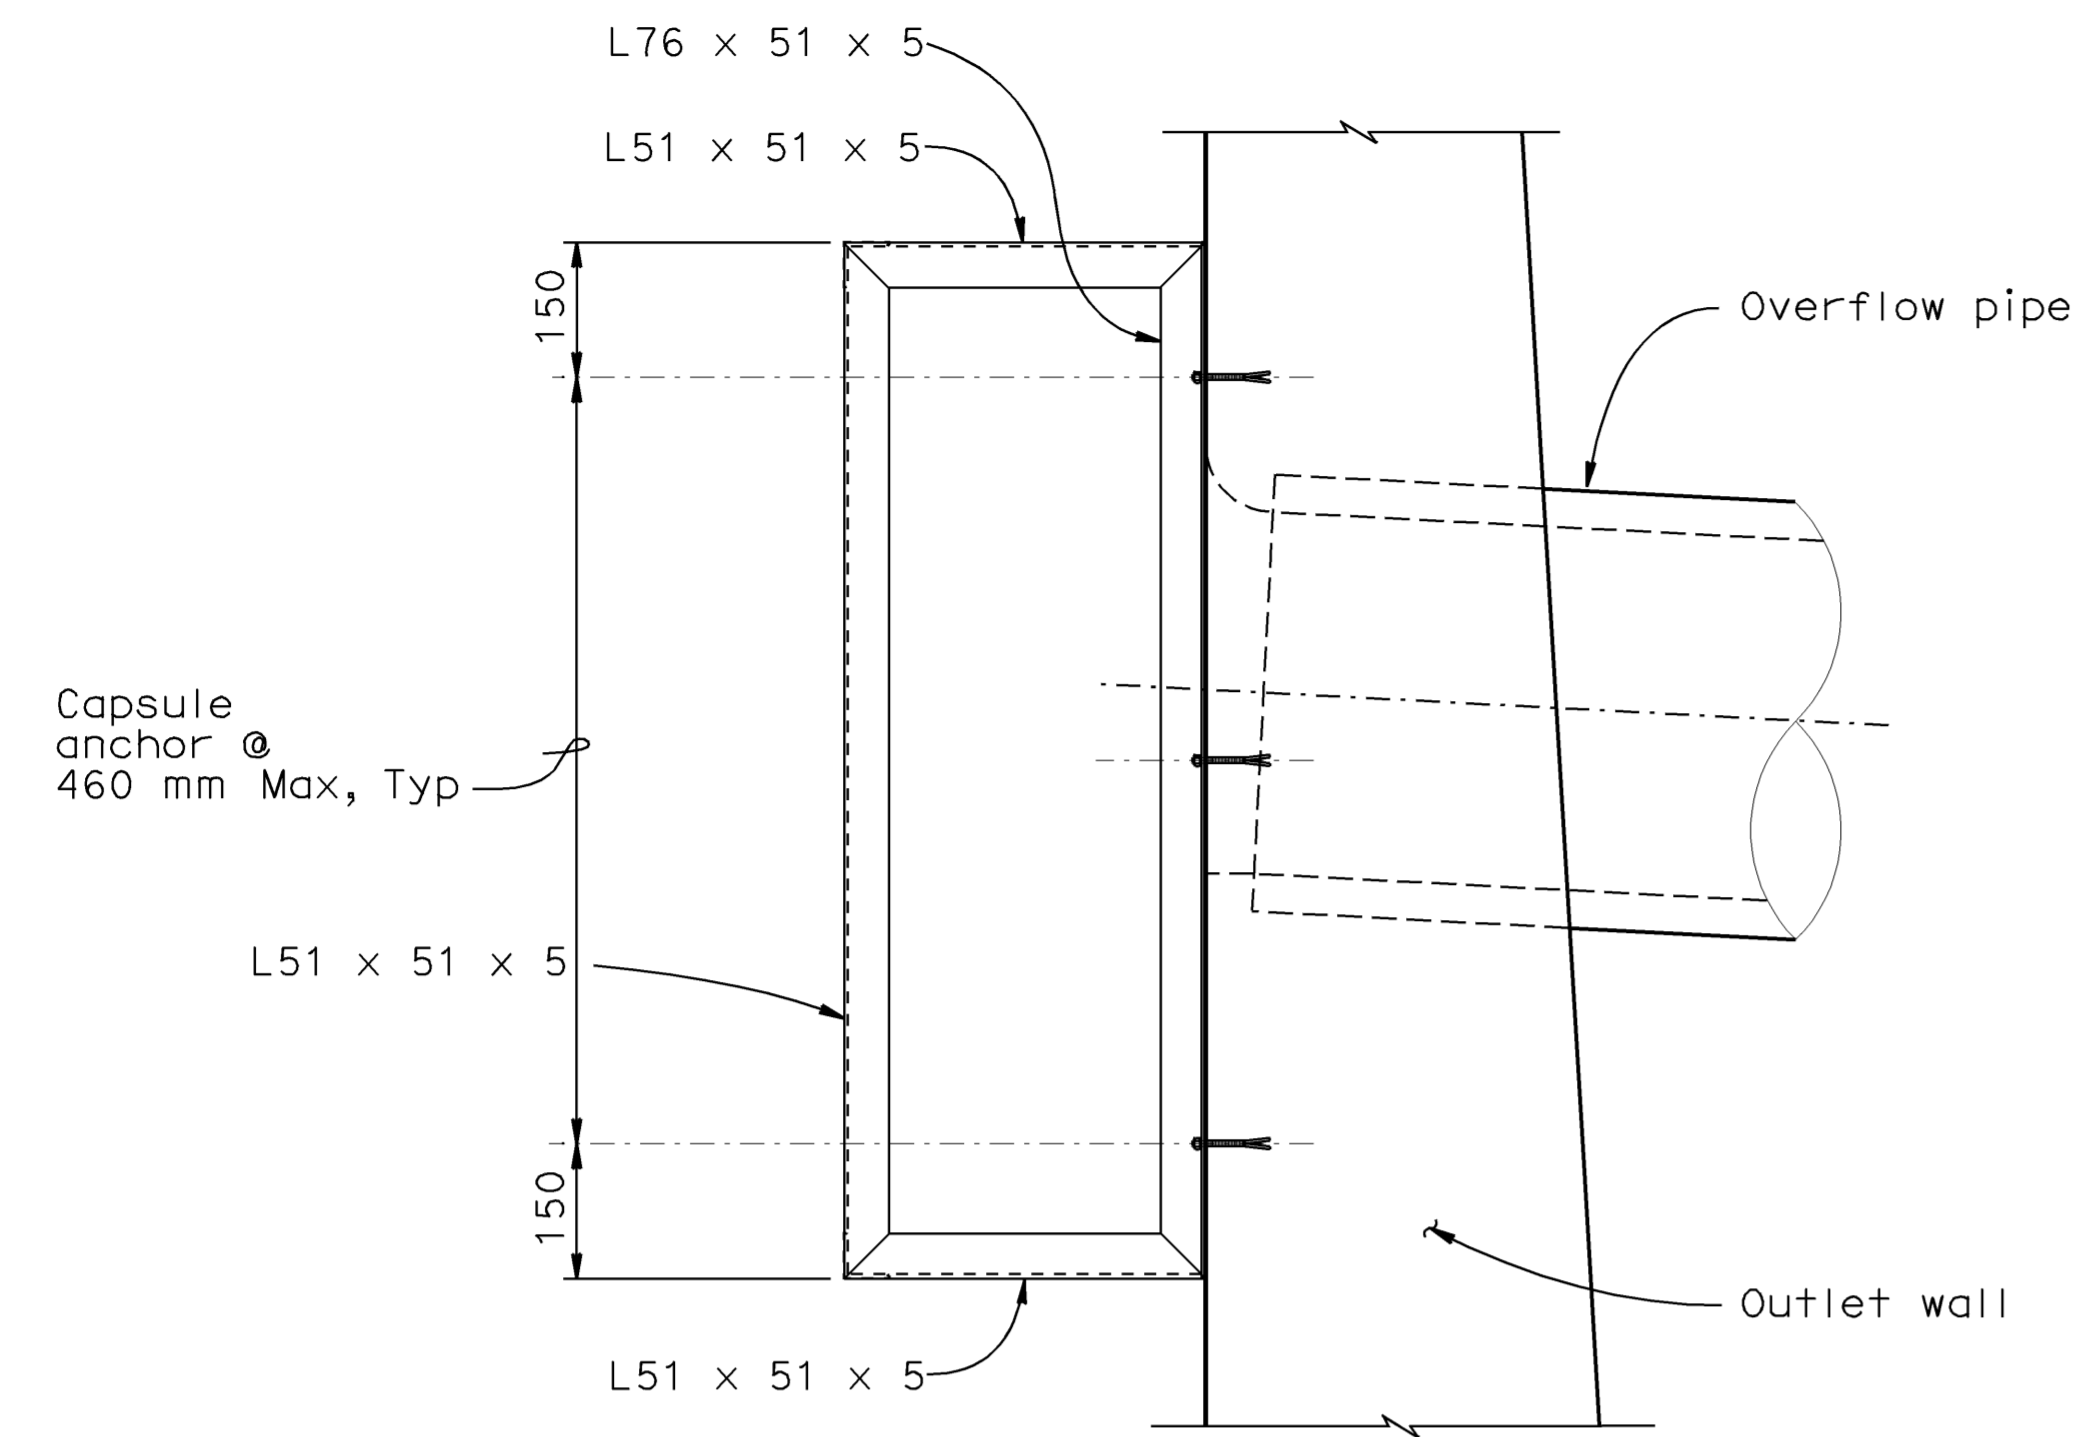

6.4 mm ϕ x 25 mm self tapping metal screw, pre-drilled, total 6 per side, total three sides

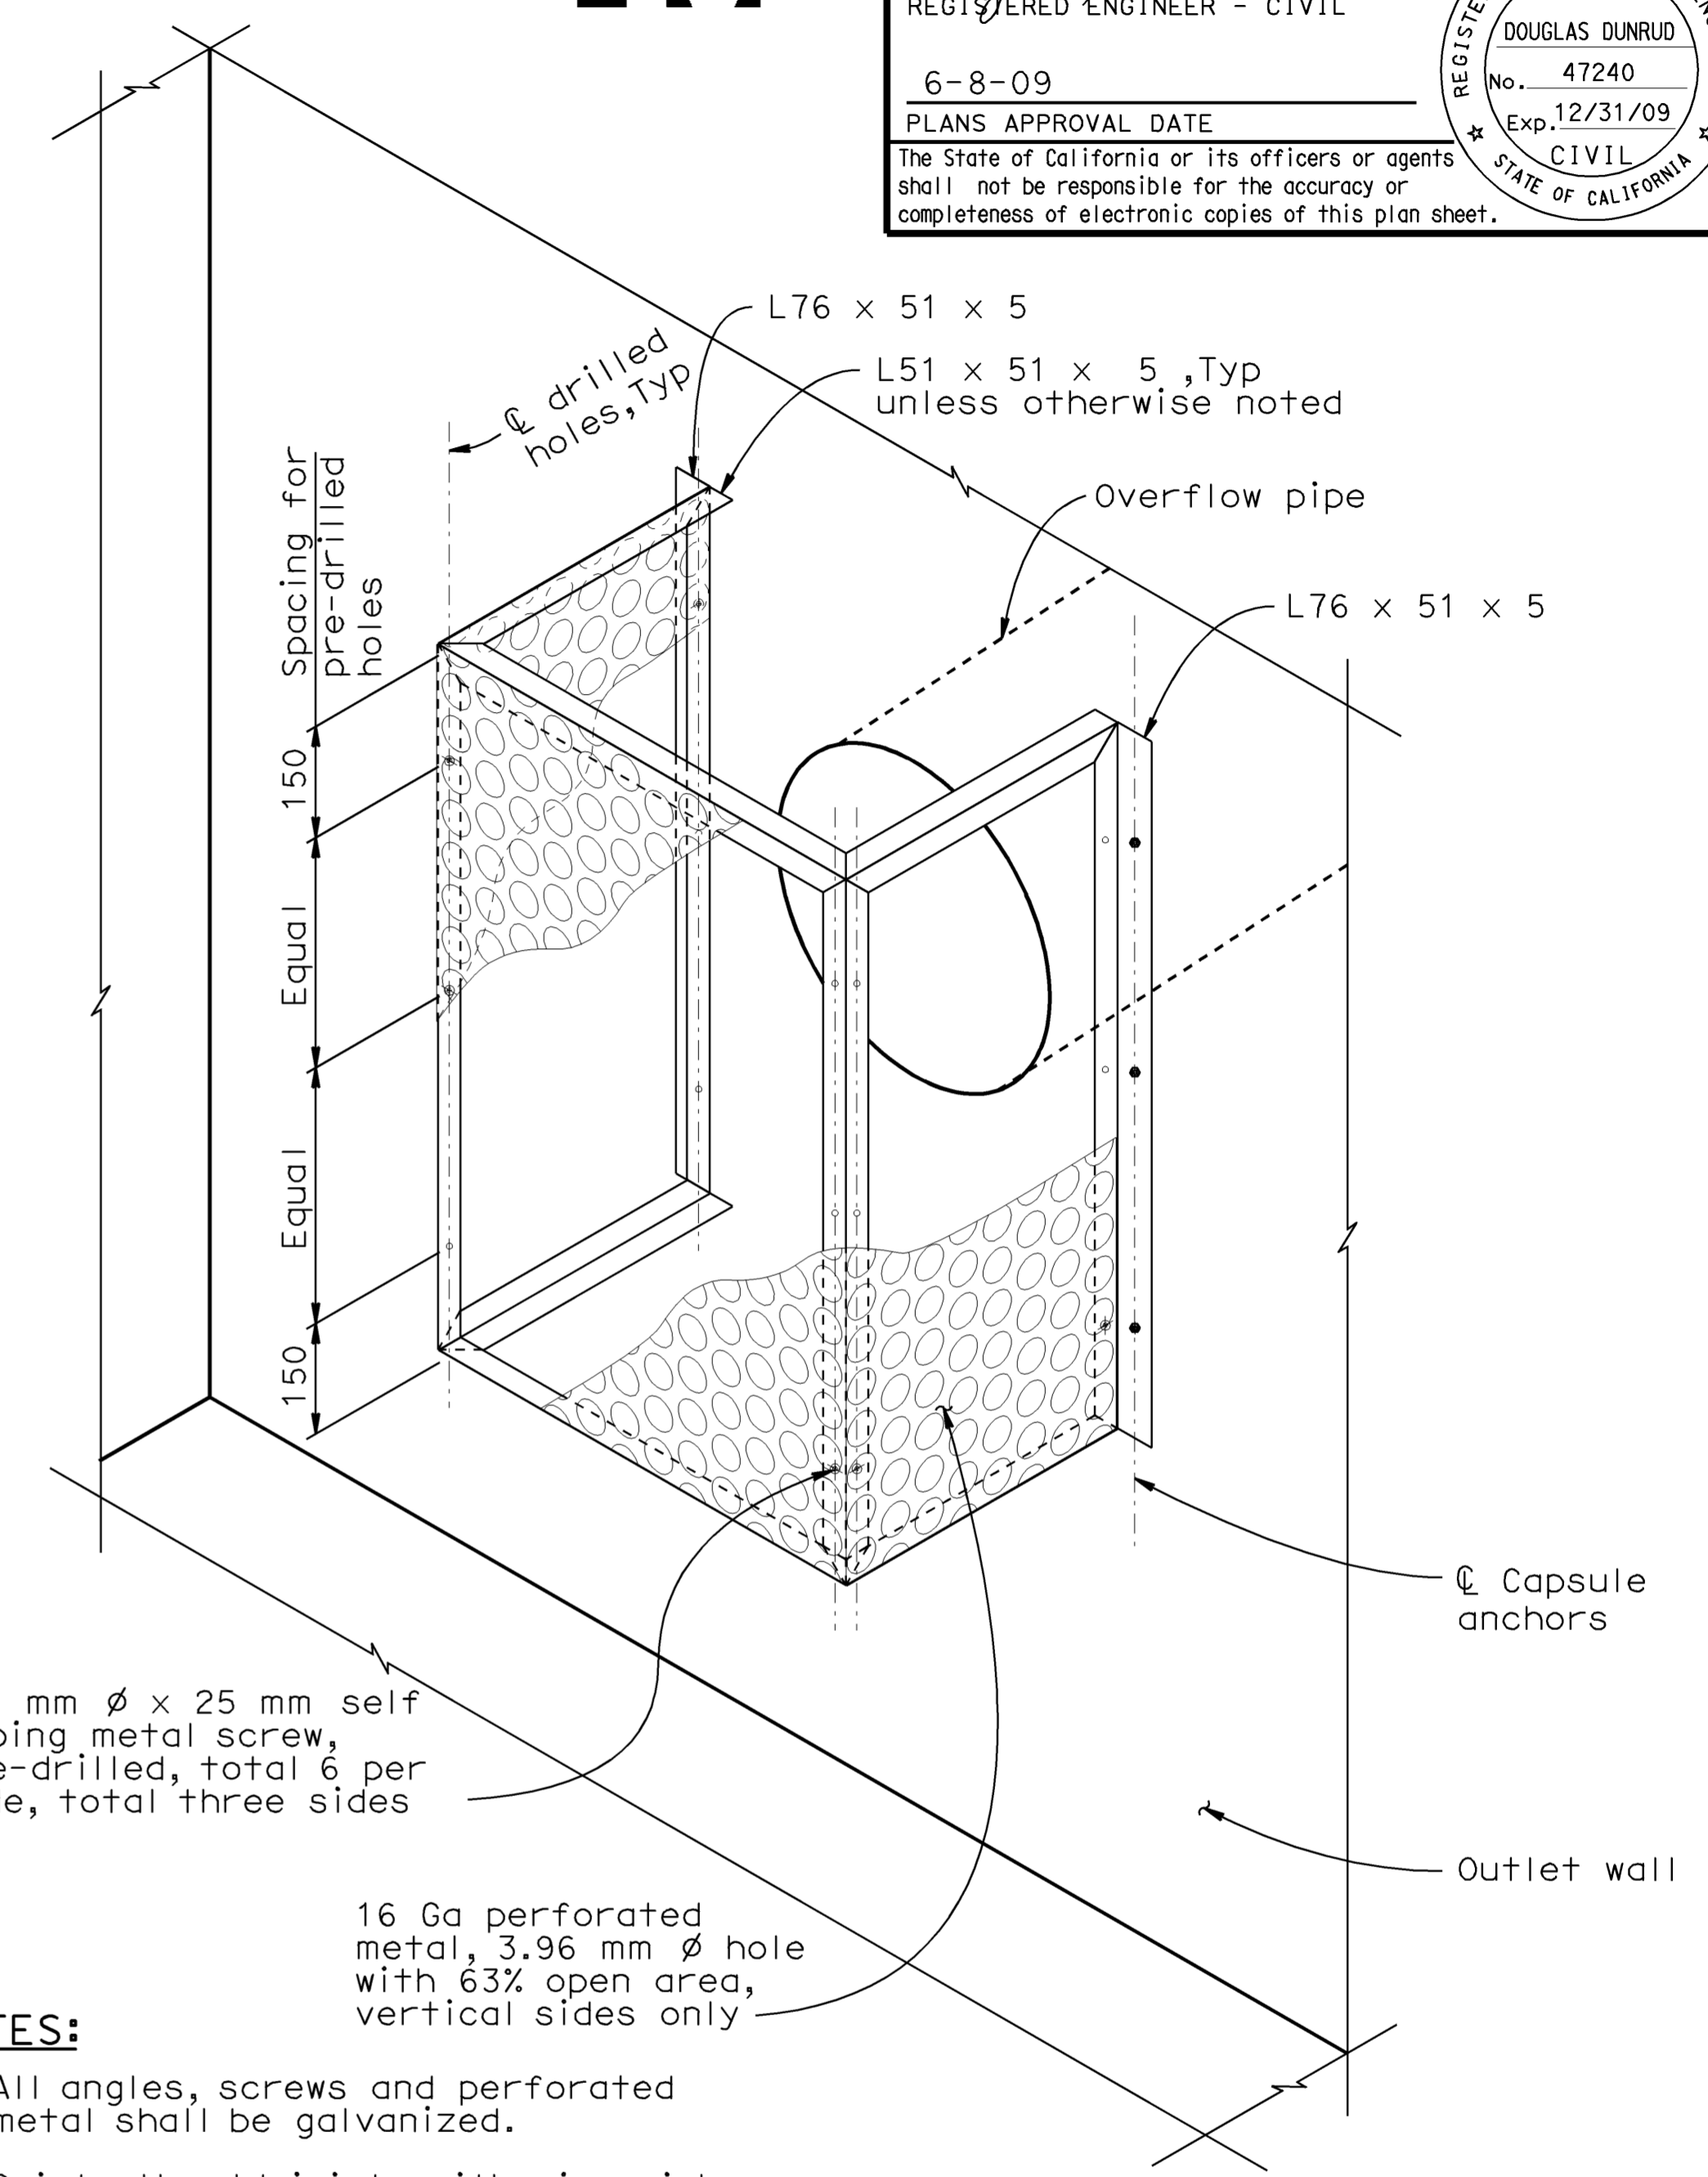
16 Ga perforated metal, 3.96 mm ϕ hole with 63% open area, vertical sides only

NOTES:


1. All angles, screws and perforated metal shall be galvanized.
2. Paint all weld joints with zinc rich paint or galvanize after welding.
3. Resin capsule type bolt anchorage is subject to approval by the Engineer. Installation procedures shall comply with the manufacturers instructions.

ISOMETRIC VIEW - TRASH SCREEN
No scale


NOTE: Metal hole ϕ exaggerated for emphasis.

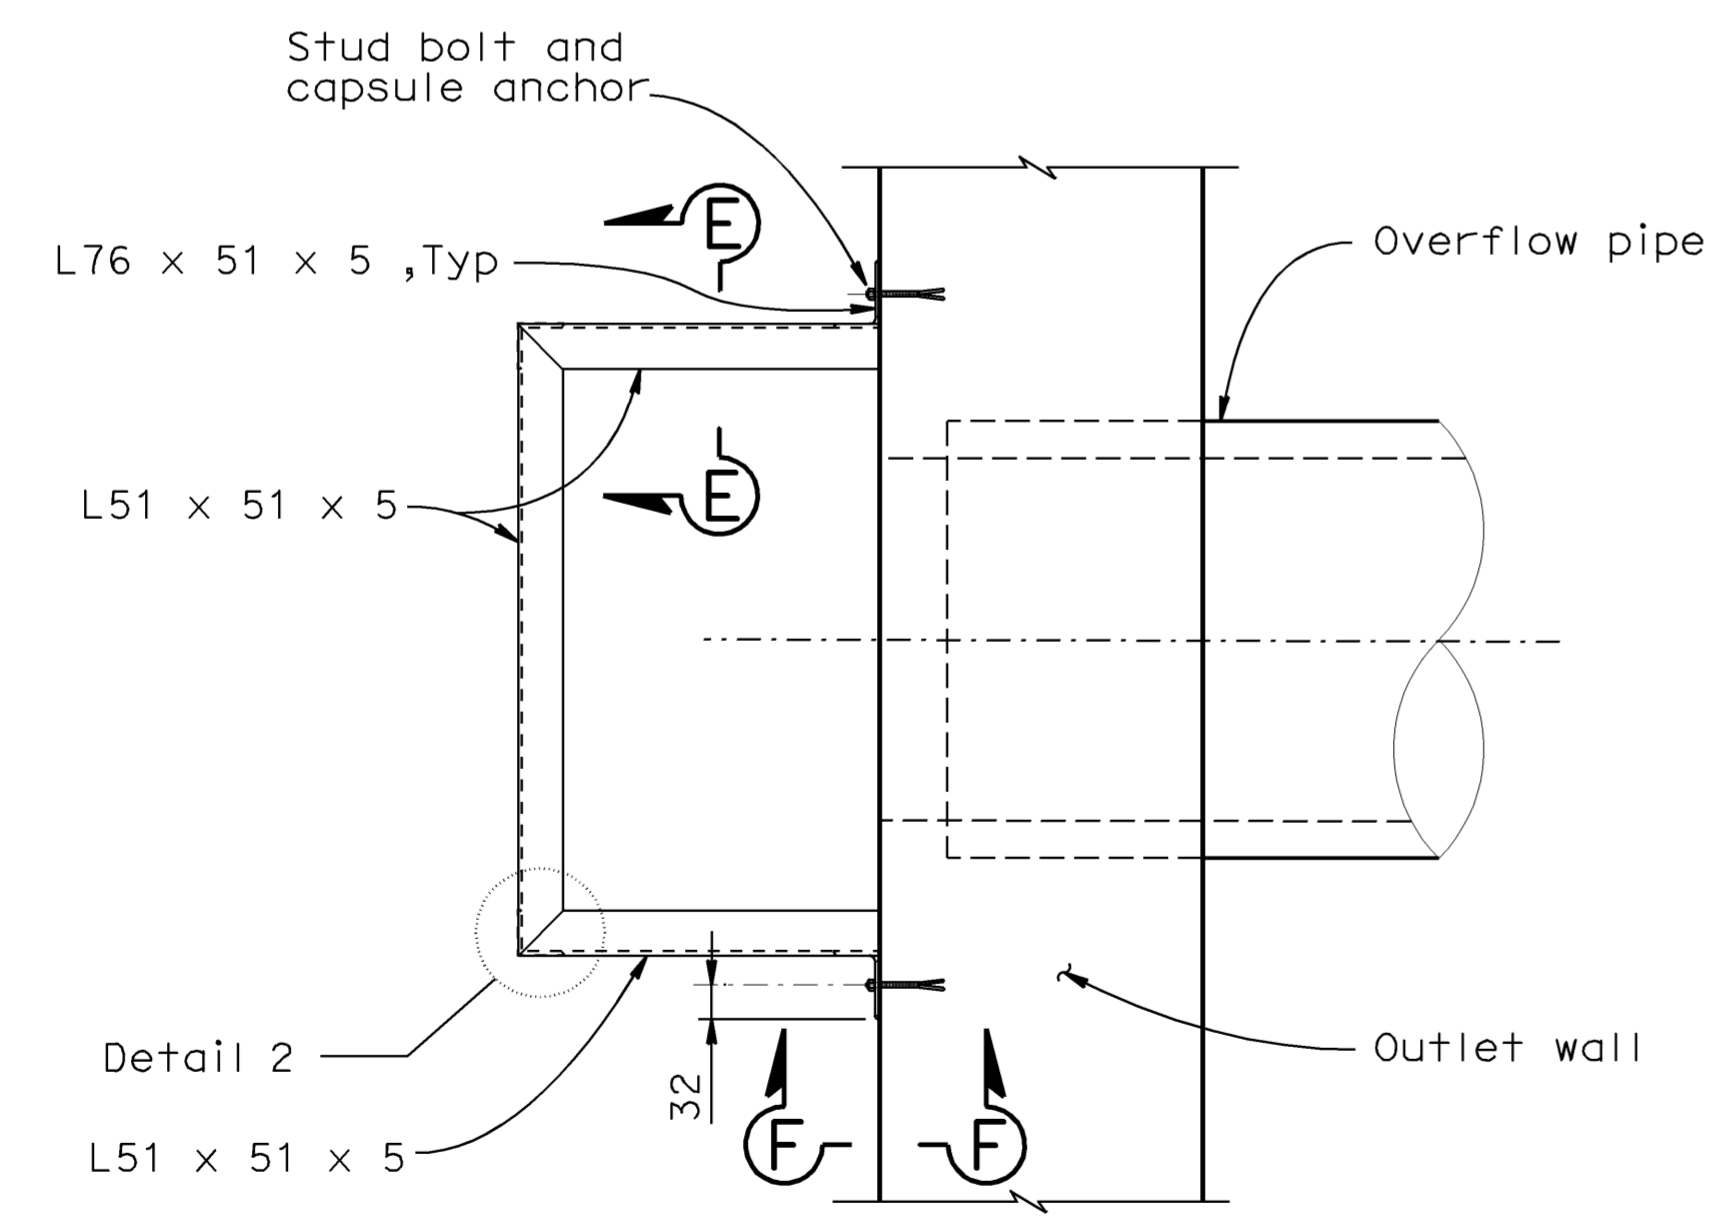

TRASH SCREEN - PLAN
No Scale

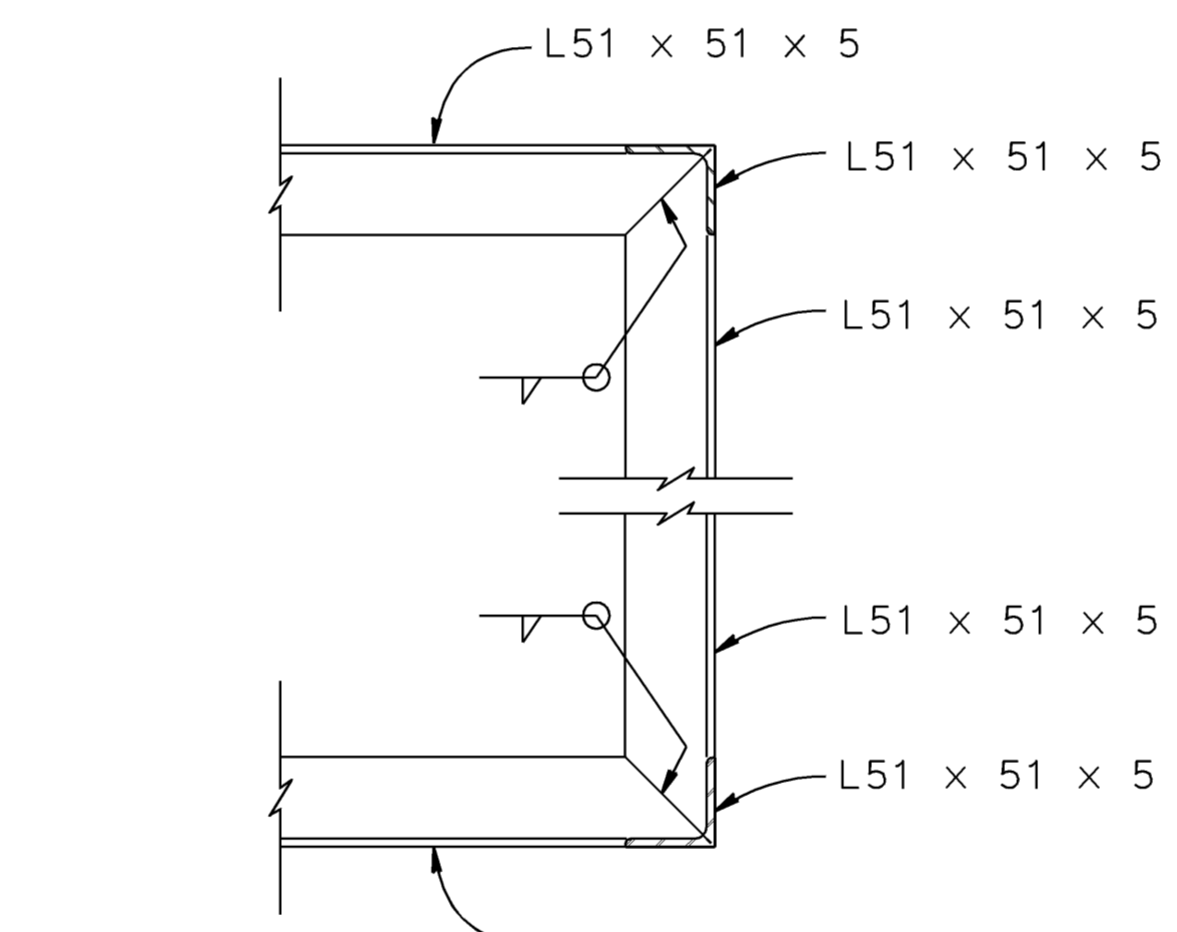

SECTION E - E
No Scale

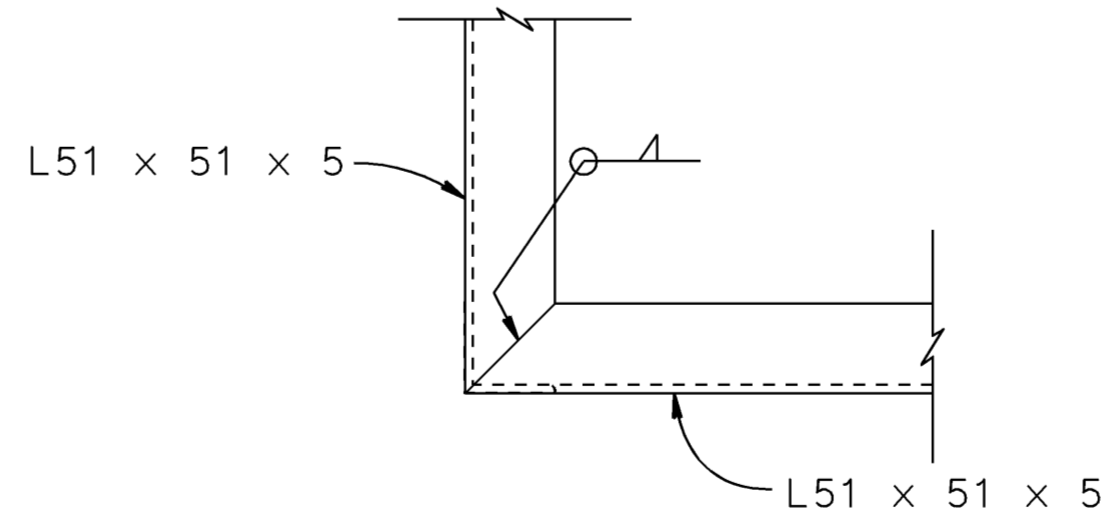

DETAIL 2
No Scale

WATER POLLUTION CONTROL DETAILS
WD-8

RELEASE DATE	DESIGN BY	BY	CHECKED
---	D. Dunrud	D. Dunrud	J&P Peterson
FILE NO.	DETAILS BY	BY	CHECKED
---	J&P Peterson	J&P Peterson	J&P Peterson
	SUBMITTED BY	BY	DRAWING DATE
	J&P Peterson	J&P Peterson	8/07

STATE OF CALIFORNIA
 DEPARTMENT OF TRANSPORTATION
 DIVISION OF ENGINEERING SERVICES

BRIDGE NO.	AUSTIN VAULT SAND FILTER
MILE POST	
DETAILS No. 3	

ORIGINAL SCALE IN MILLIMETERS FOR REDUCED PLANS

CU 07
EA 121841

DISREGARD PRINTS BEARING EARLIER REVISION DATES	REVISION DATES (PRELIMINARY STAGE ONLY)	SHEET	OF
		8	11

USERNAME => trannda
DGN FILE => 7121841h008.dgn


DATE PLOTTED => 12-JUN-2009 08:54




DIST.	COUNTY	ROUTE	MILE POST TOTAL PROJECT	SHEET NO.	TOTAL SHEETS
07	LA	5	42.8/47.3	84	1073

6-8-09
 PLANS APPROVAL DATE
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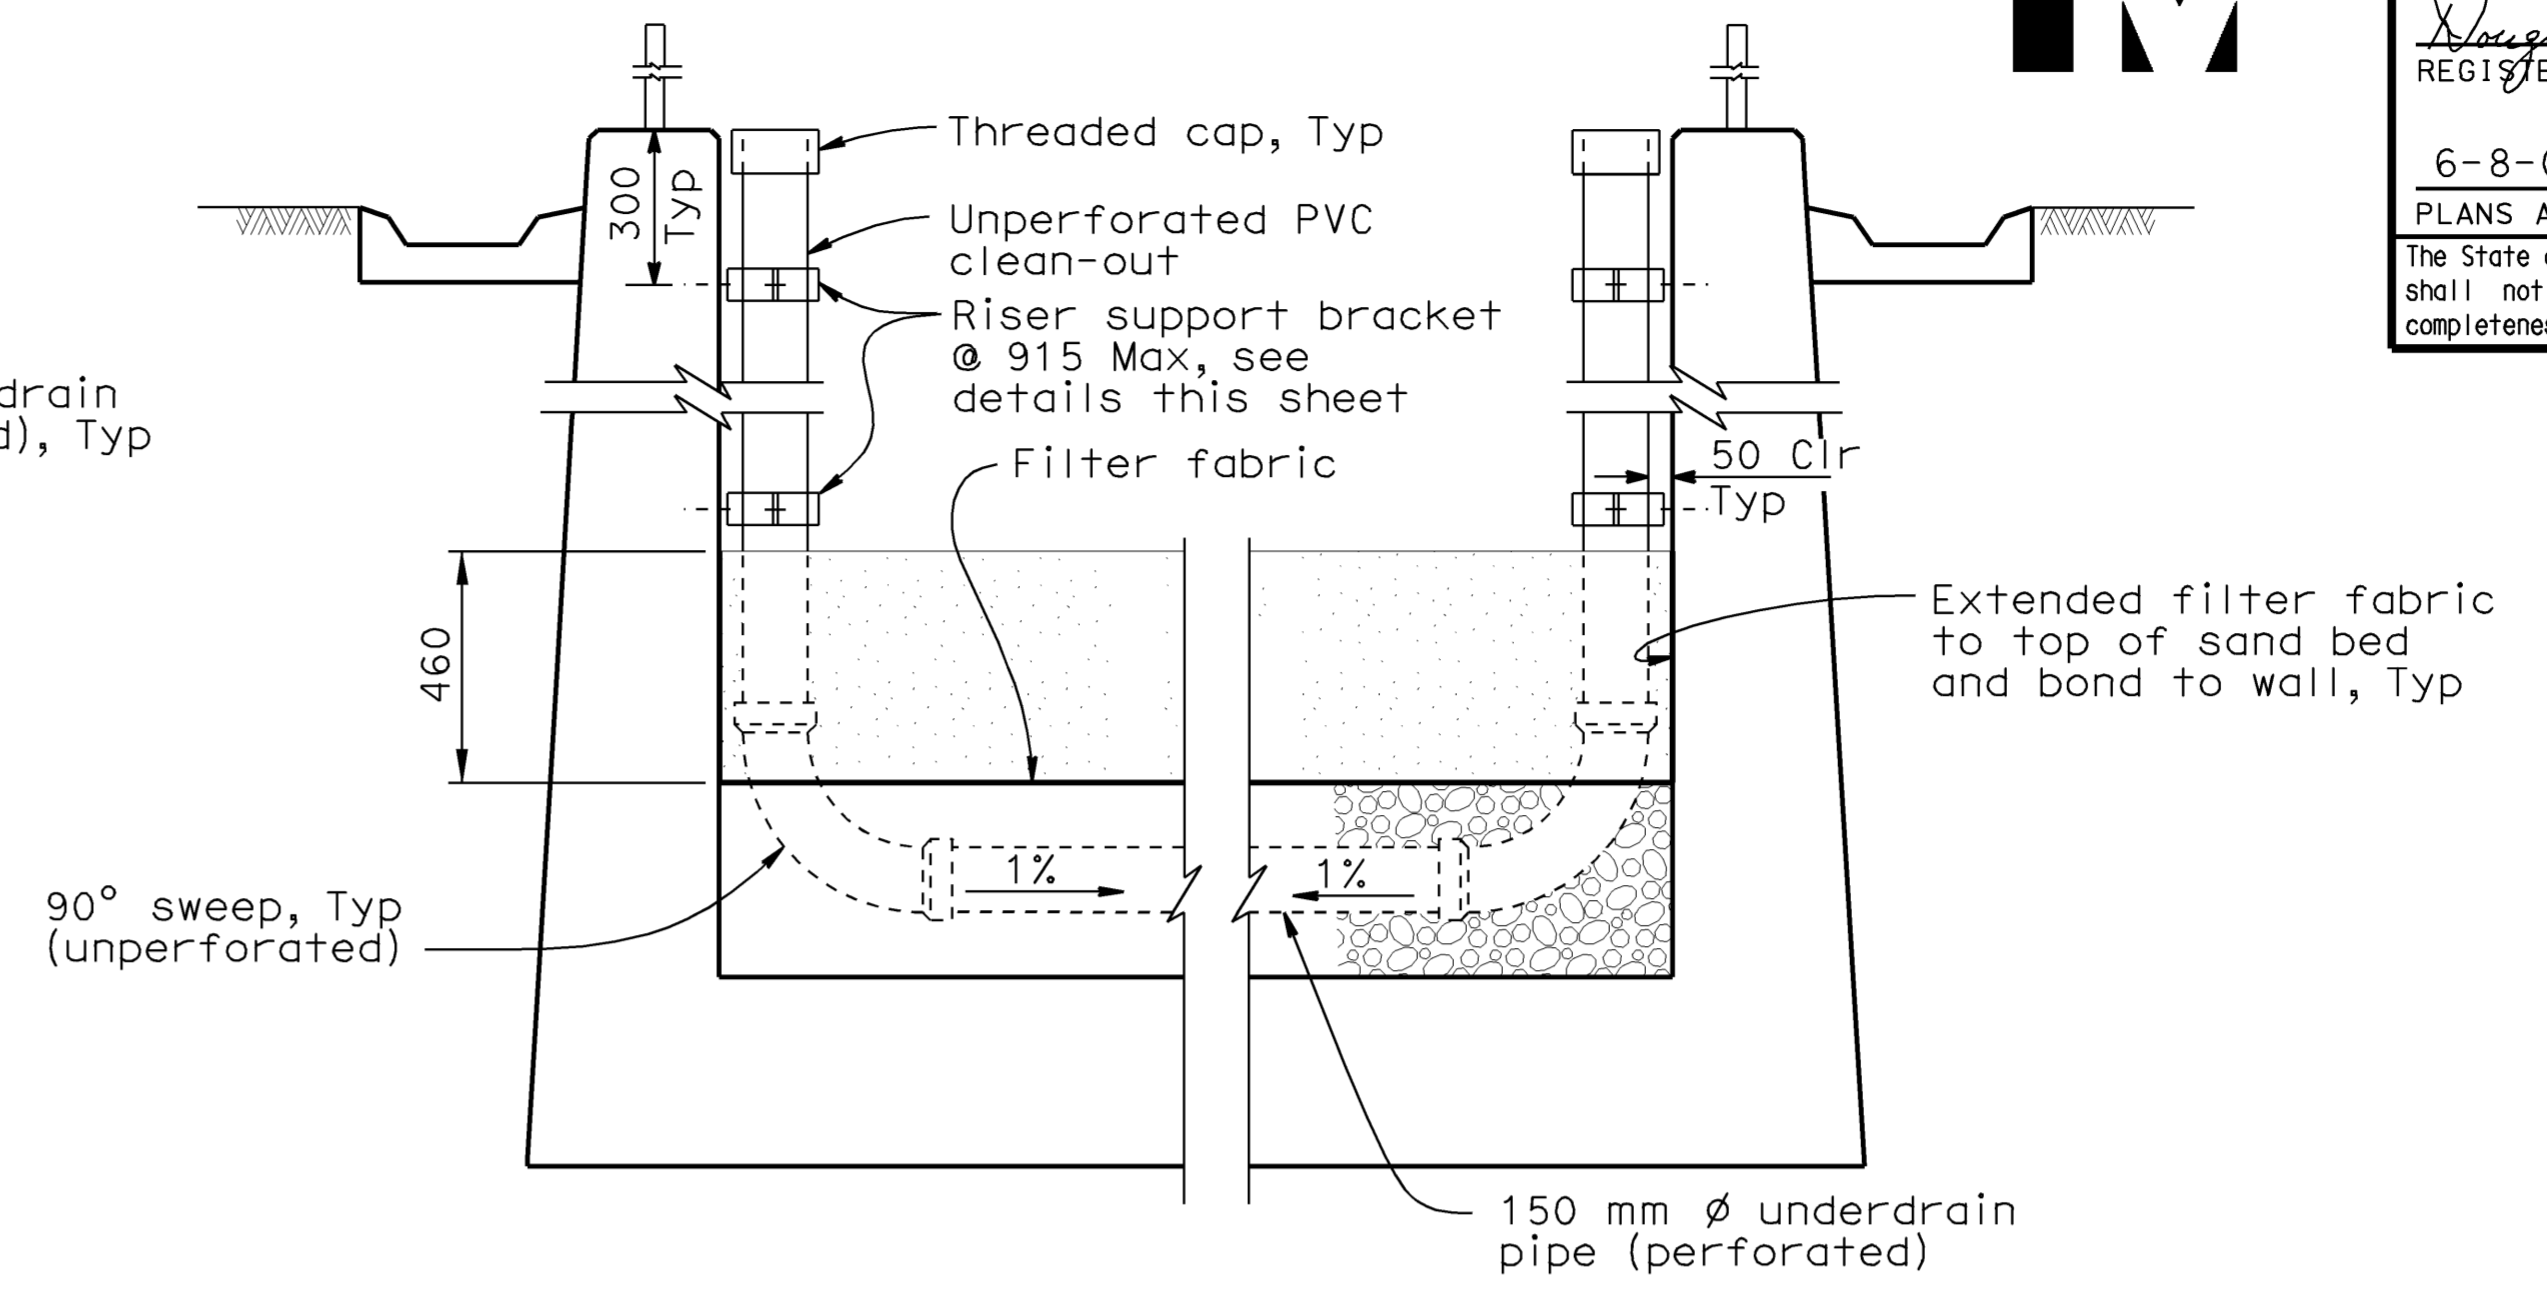
REGISTERED PROFESSIONAL ENGINEER
 DOUGLAS DUNRUD
 No. 47240
 Exp. 12/31/09
 CIVIL
 STATE OF CALIFORNIA

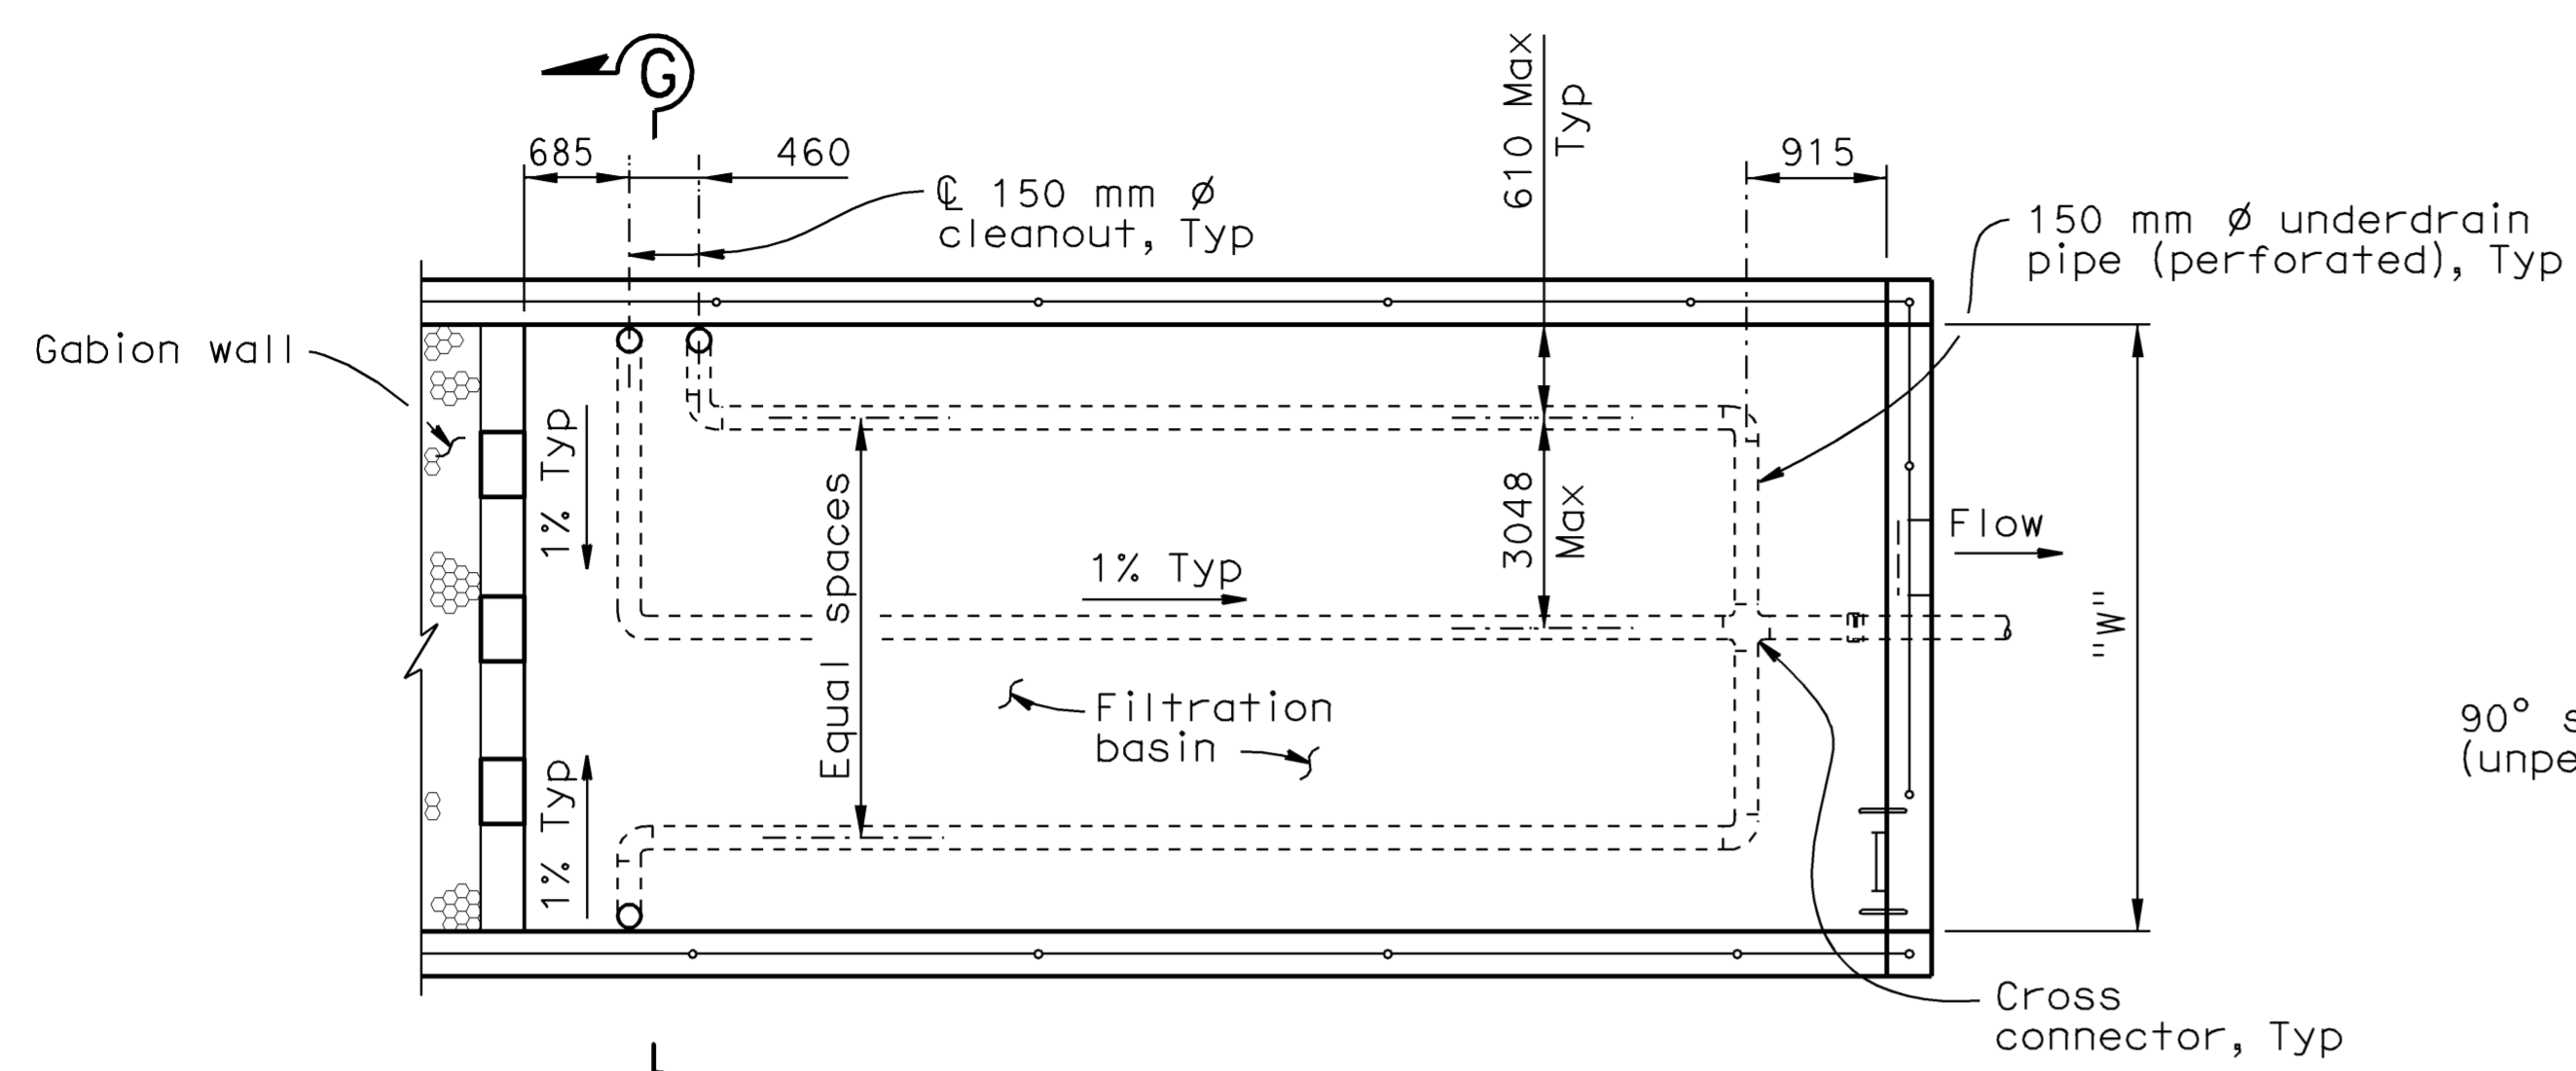

UNDERDRAIN PLAN (FILTRATION BASIN)
 "W" = 5490 - 7320
 No Scale

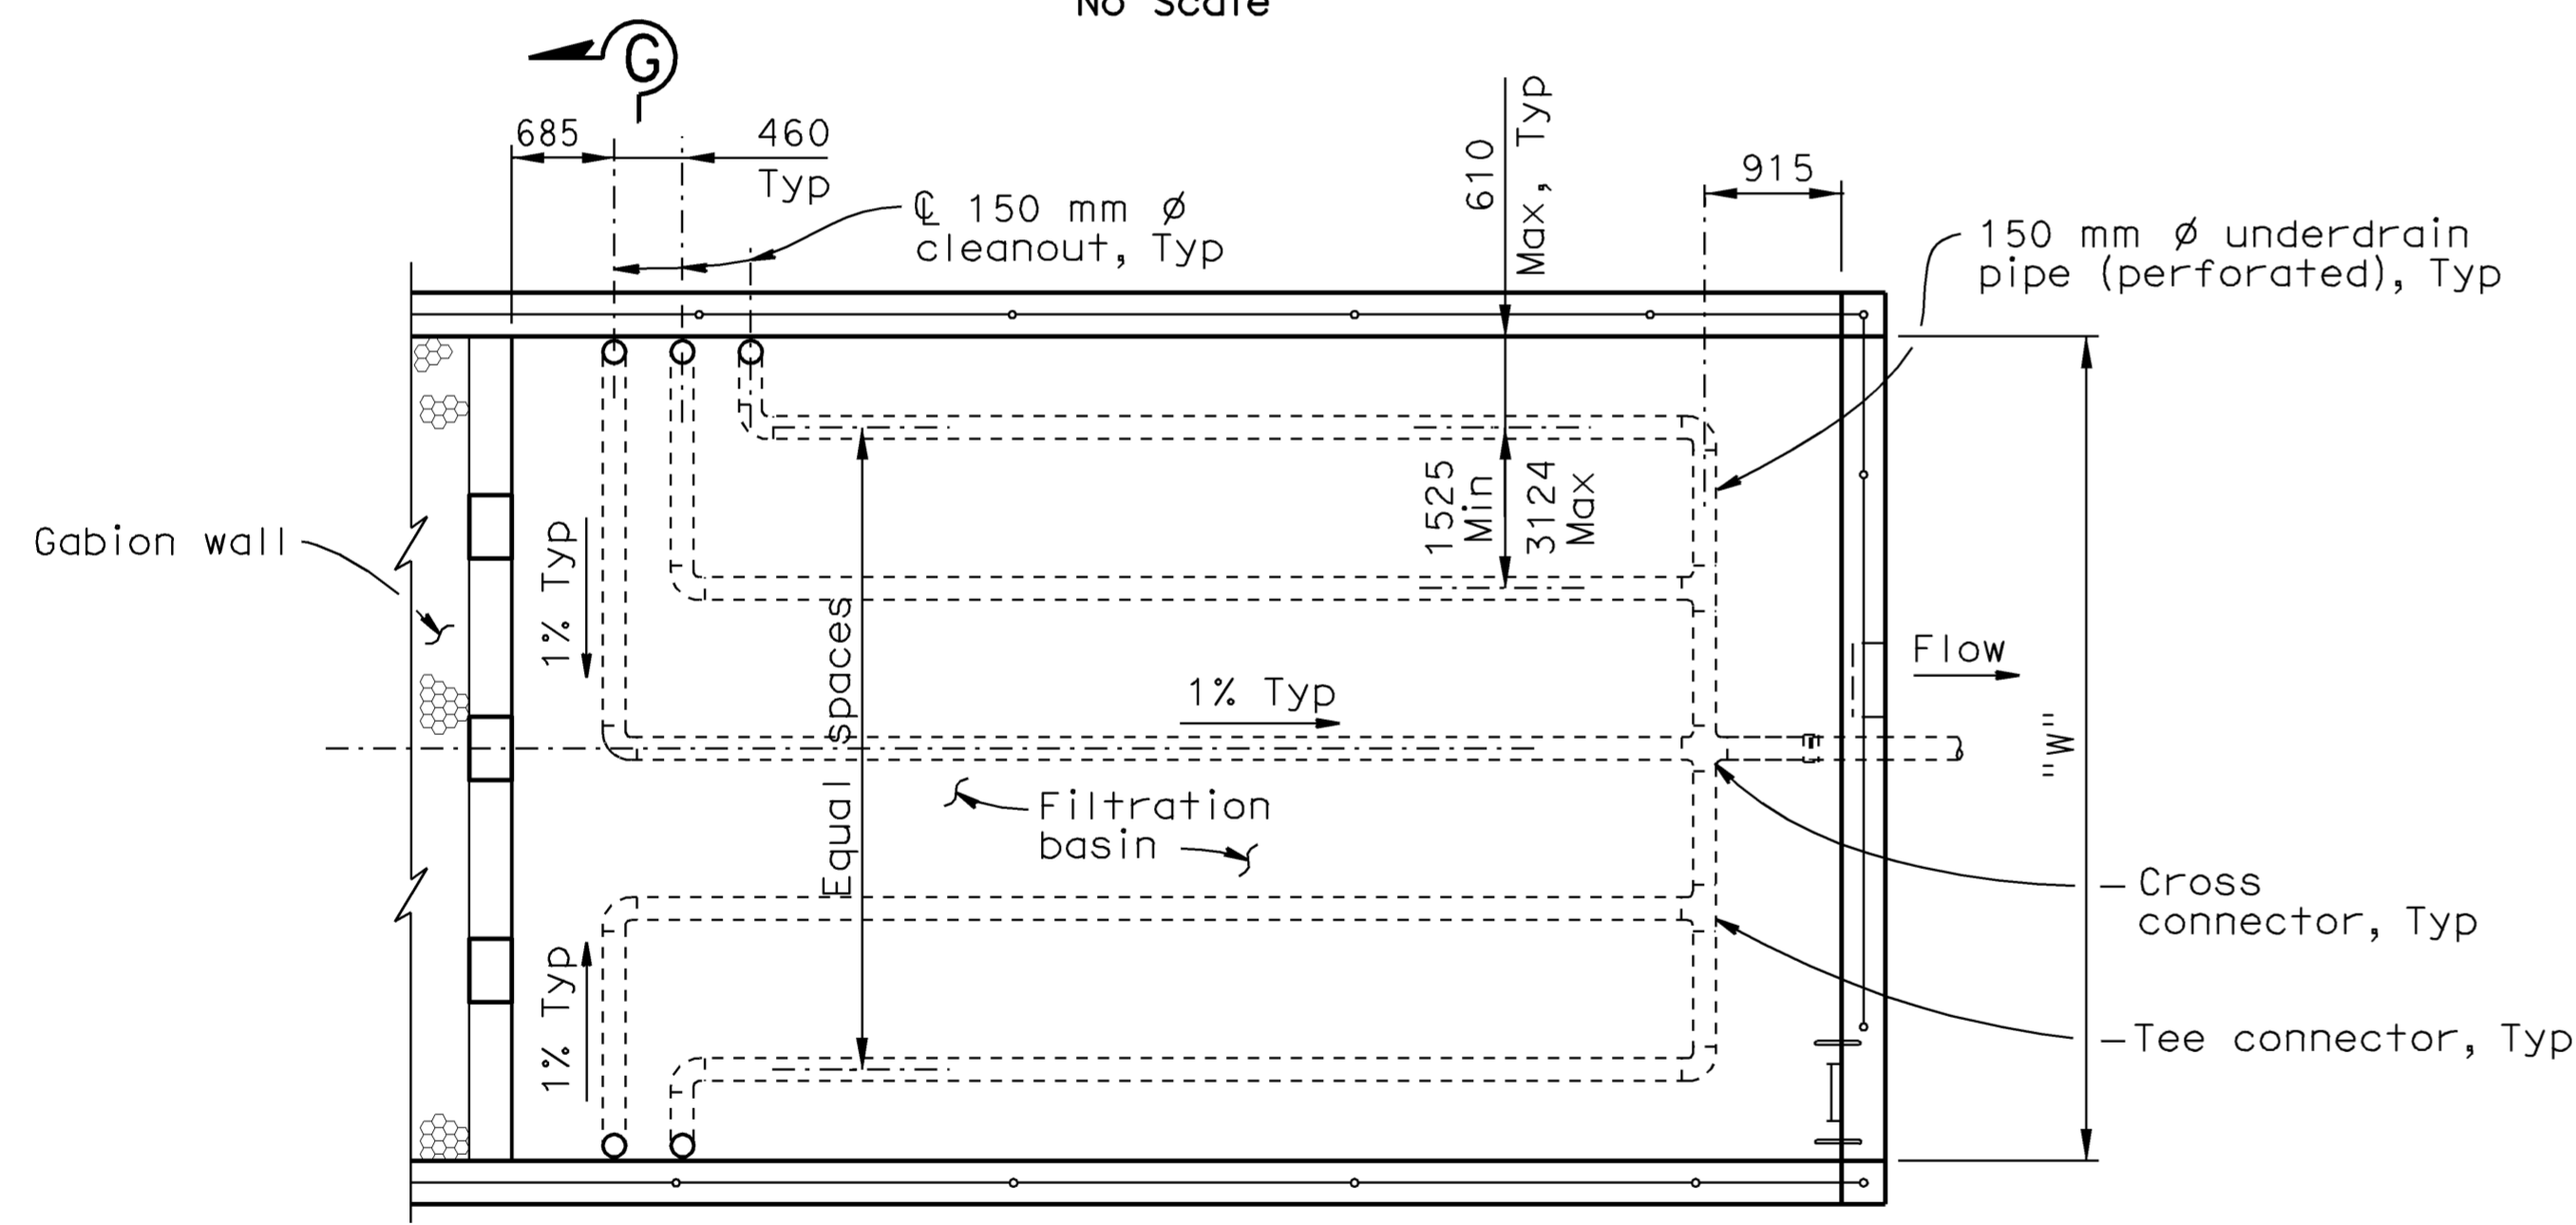


UNDERDRAIN PLAN (FILTRATION BASIN)
 "W" = 8230 - 9140 - 10970 - 13720
 No Scale




SECTION G - G
 No Scale

NOTE:
 1. See "Layout No. 1" sheet for Typical cover and depth of sand bed.

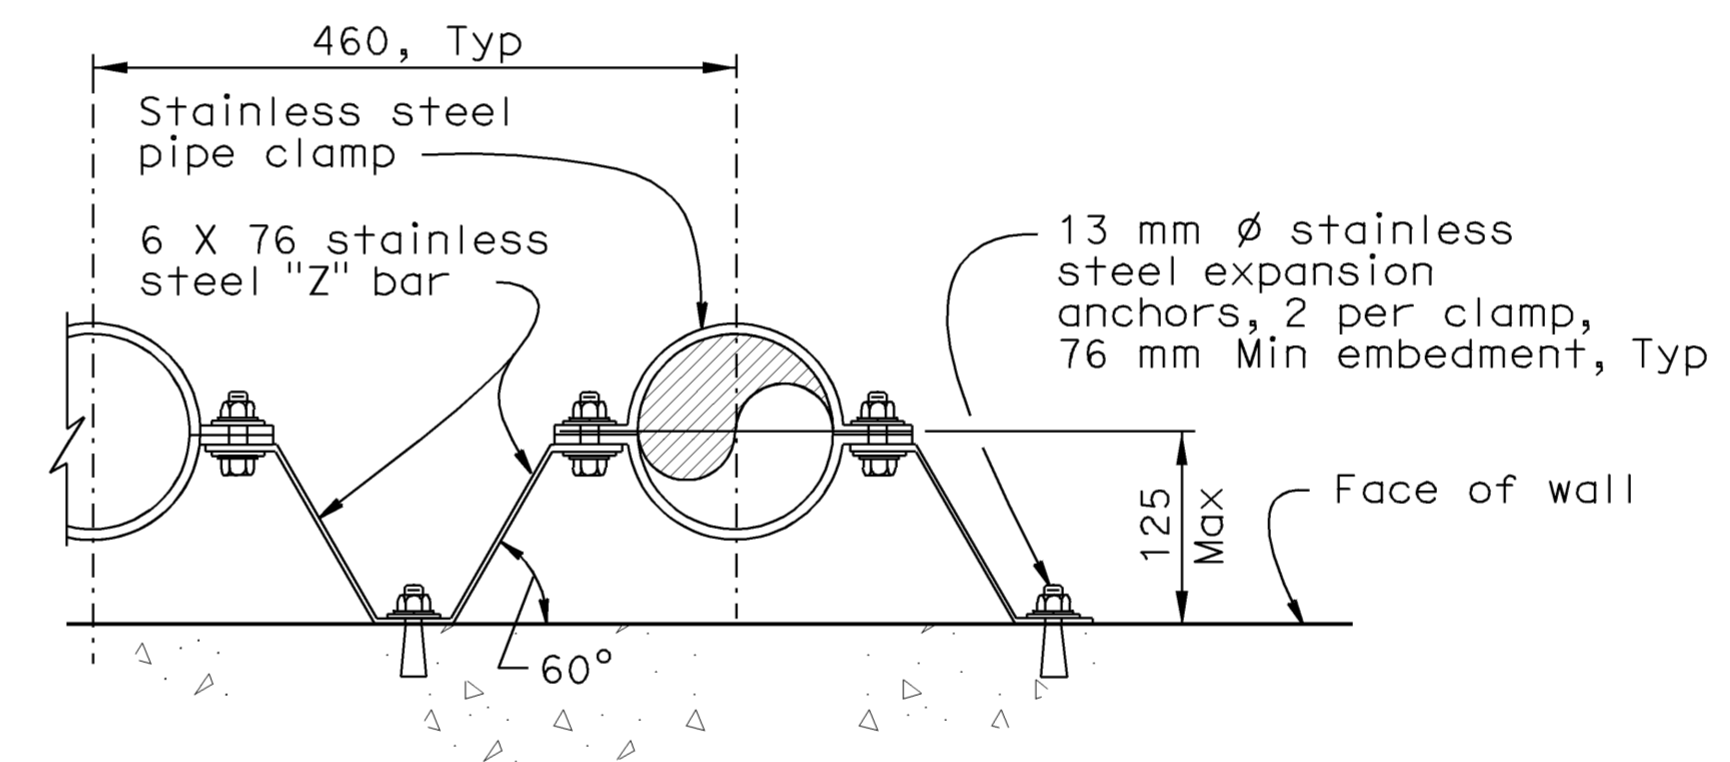

RISER SUPPORT BRACKET DETAIL
 No Scale

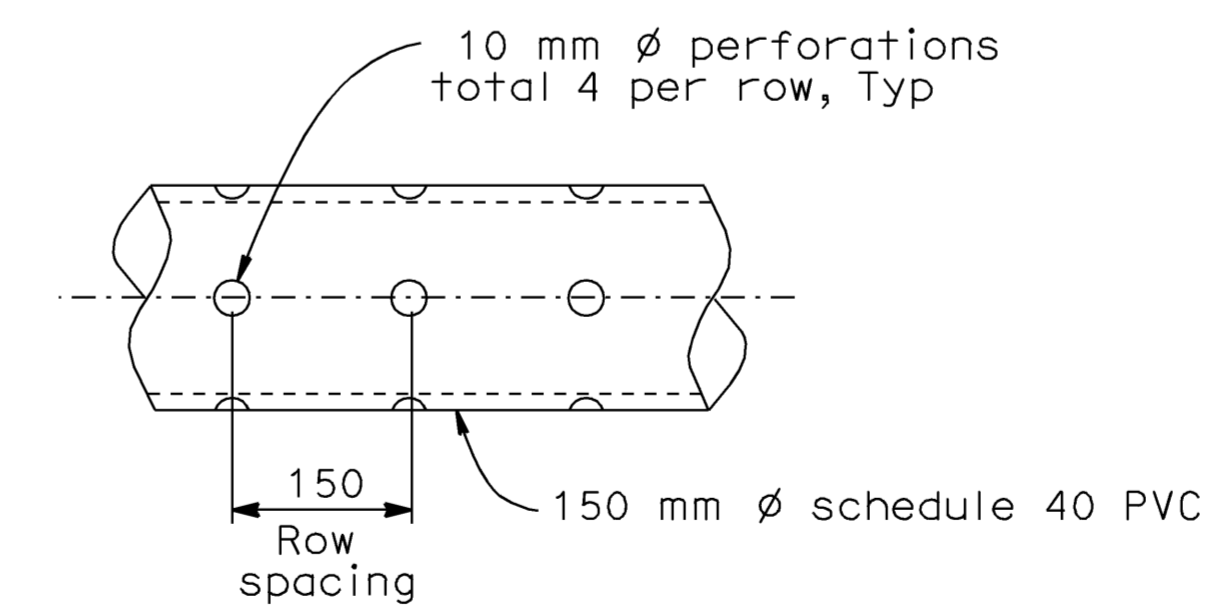

PERFORATED UNDERDRAIN PIPE
 No Scale


ALL DIMENSIONS ARE IN MILLIMETERS UNLESS OTHERWISE SHOWN

WATER POLLUTION CONTROL DETAILS
WD-9

RELEASE DATE	DESIGN BY	BY	CHECKED
---	D. Dunrud		J&P Peterson
FILE NO.	DETAILS BY	BY	CHECKED
---	J&P Peterson		J&P Peterson
	SUBMITTED BY	BY	DRAWING DATE
	J&P Peterson		8/07

STATE OF CALIFORNIA
 DEPARTMENT OF TRANSPORTATION
 DIVISION OF ENGINEERING SERVICES

BRIDGE NO.	AUSTIN VAULT SAND FILTER
MILE POST	
DETAILS No. 4	

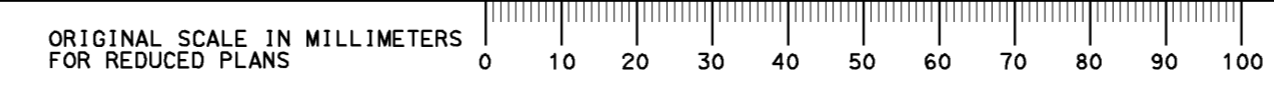

CU 07
 EA 121841

DISREGARD PRINTS BEARING EARLIER REVISION DATES	REVISION DATES (PRELIMINARY STAGE ONLY)	SHEET	OF
		9	11

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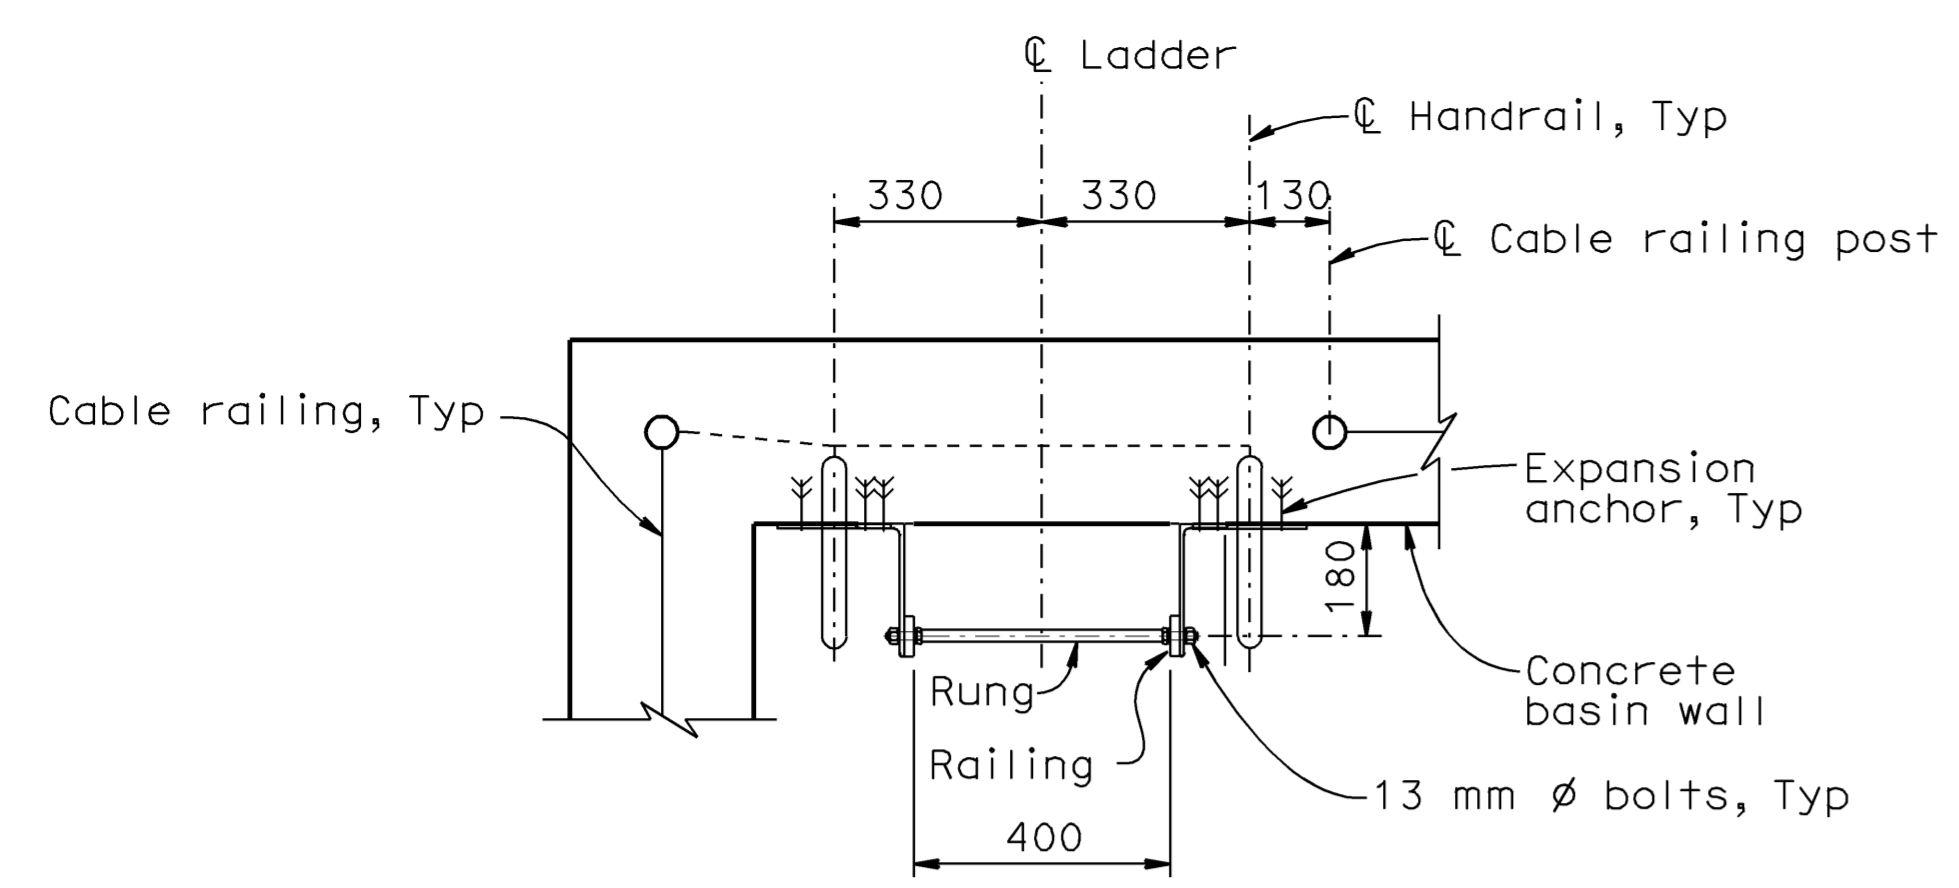
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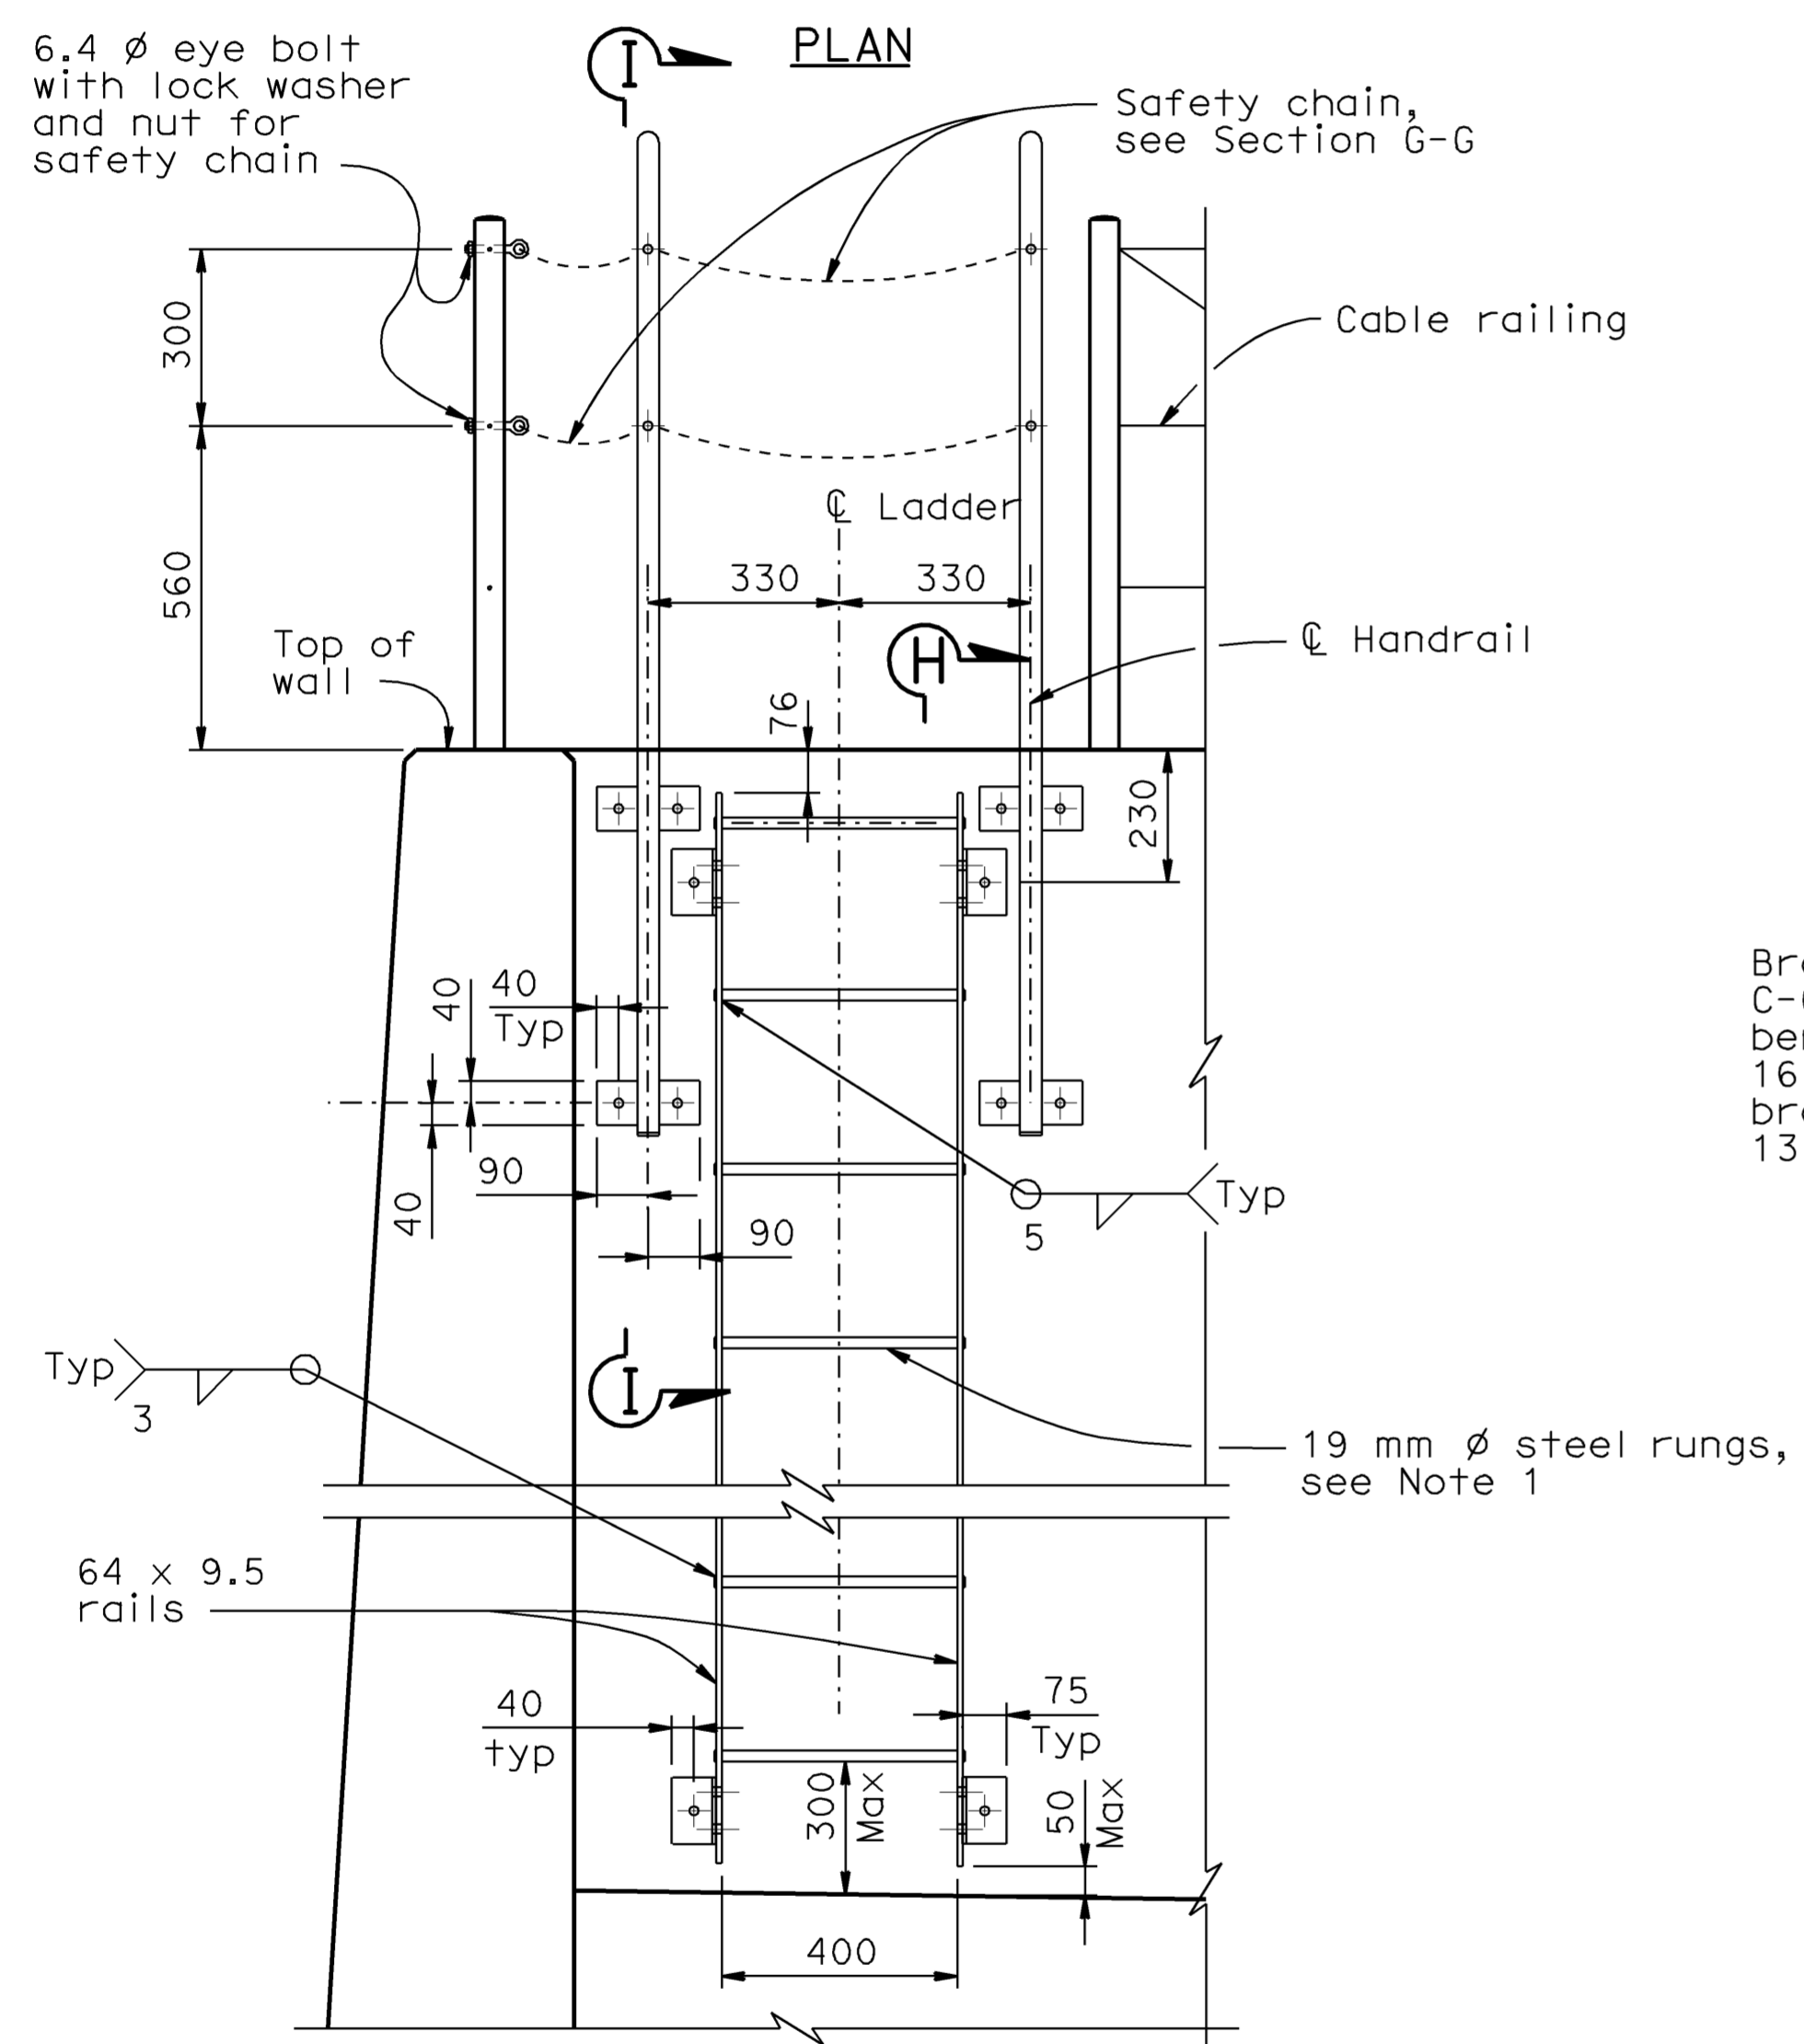
DIST.	COUNTY	ROUTE	MILE POST TOTAL PROJECT	SHEET NO.	TOTAL SHEETS
07	LA	5	42.8/47.3	85	1073

REGISTERED ENGINEER - CIVIL
 DOUGLAS DUNRUD
 No. 47240
 Exp. 12/31/09
 CIVIL
 STATE OF CALIFORNIA

6-8-09
 PLANS APPROVAL DATE
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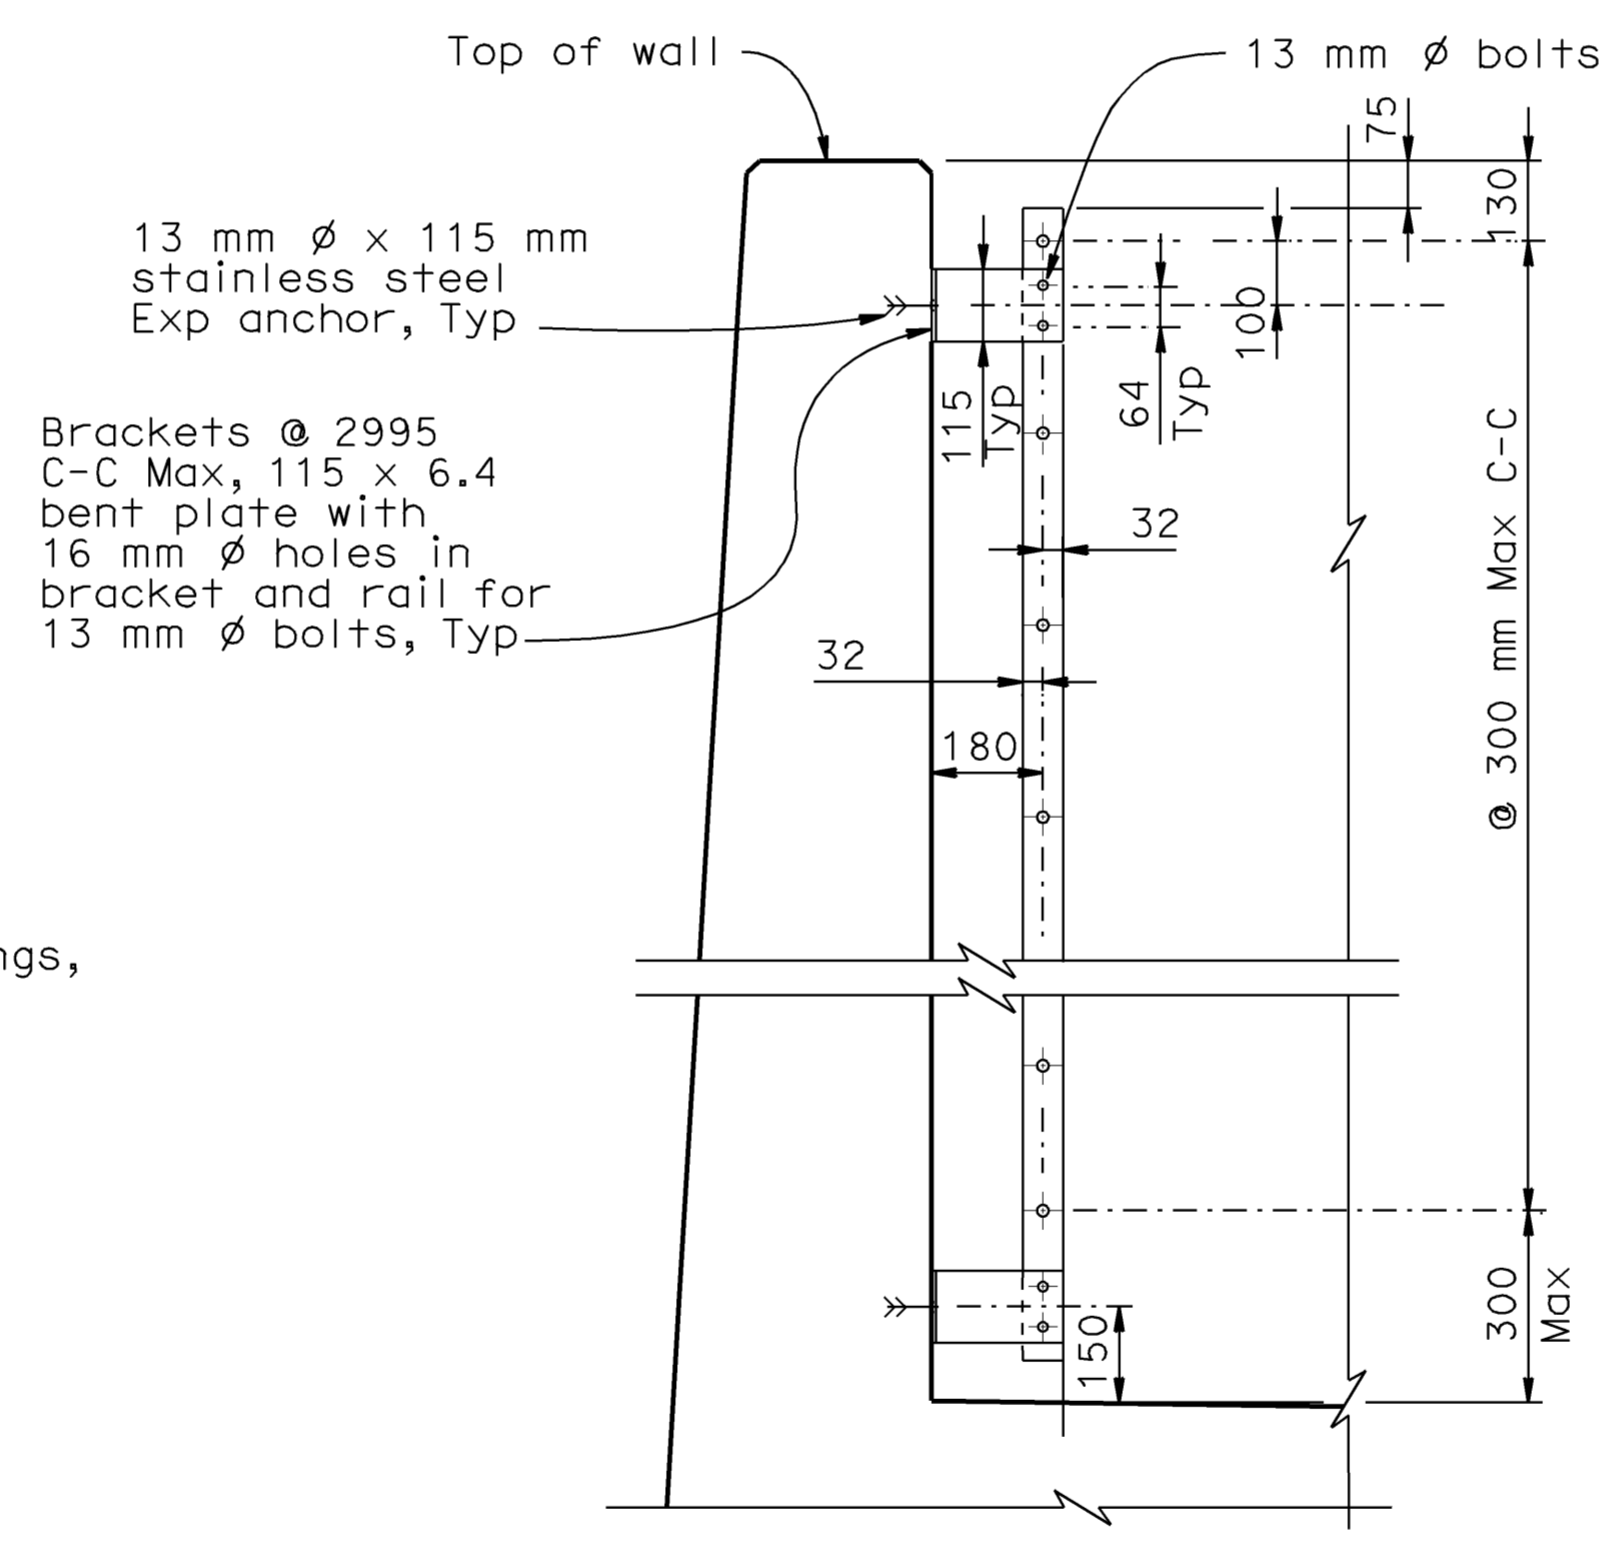
- NOTES:**
1. The distance between rungs shall not exceed 300 mm and shall be uniform throughout the length of wall.
 2. Hardware shall be galvanized after fabrication.
 3. Grind exposed corners to 5 mm radius.



ELEVATION


LADDER
No Scale

NOTE: Cable railing not shown for clarity.



SECTION H - H
No Scale

NOTE: Handrail and cable railing not shown for clarity.

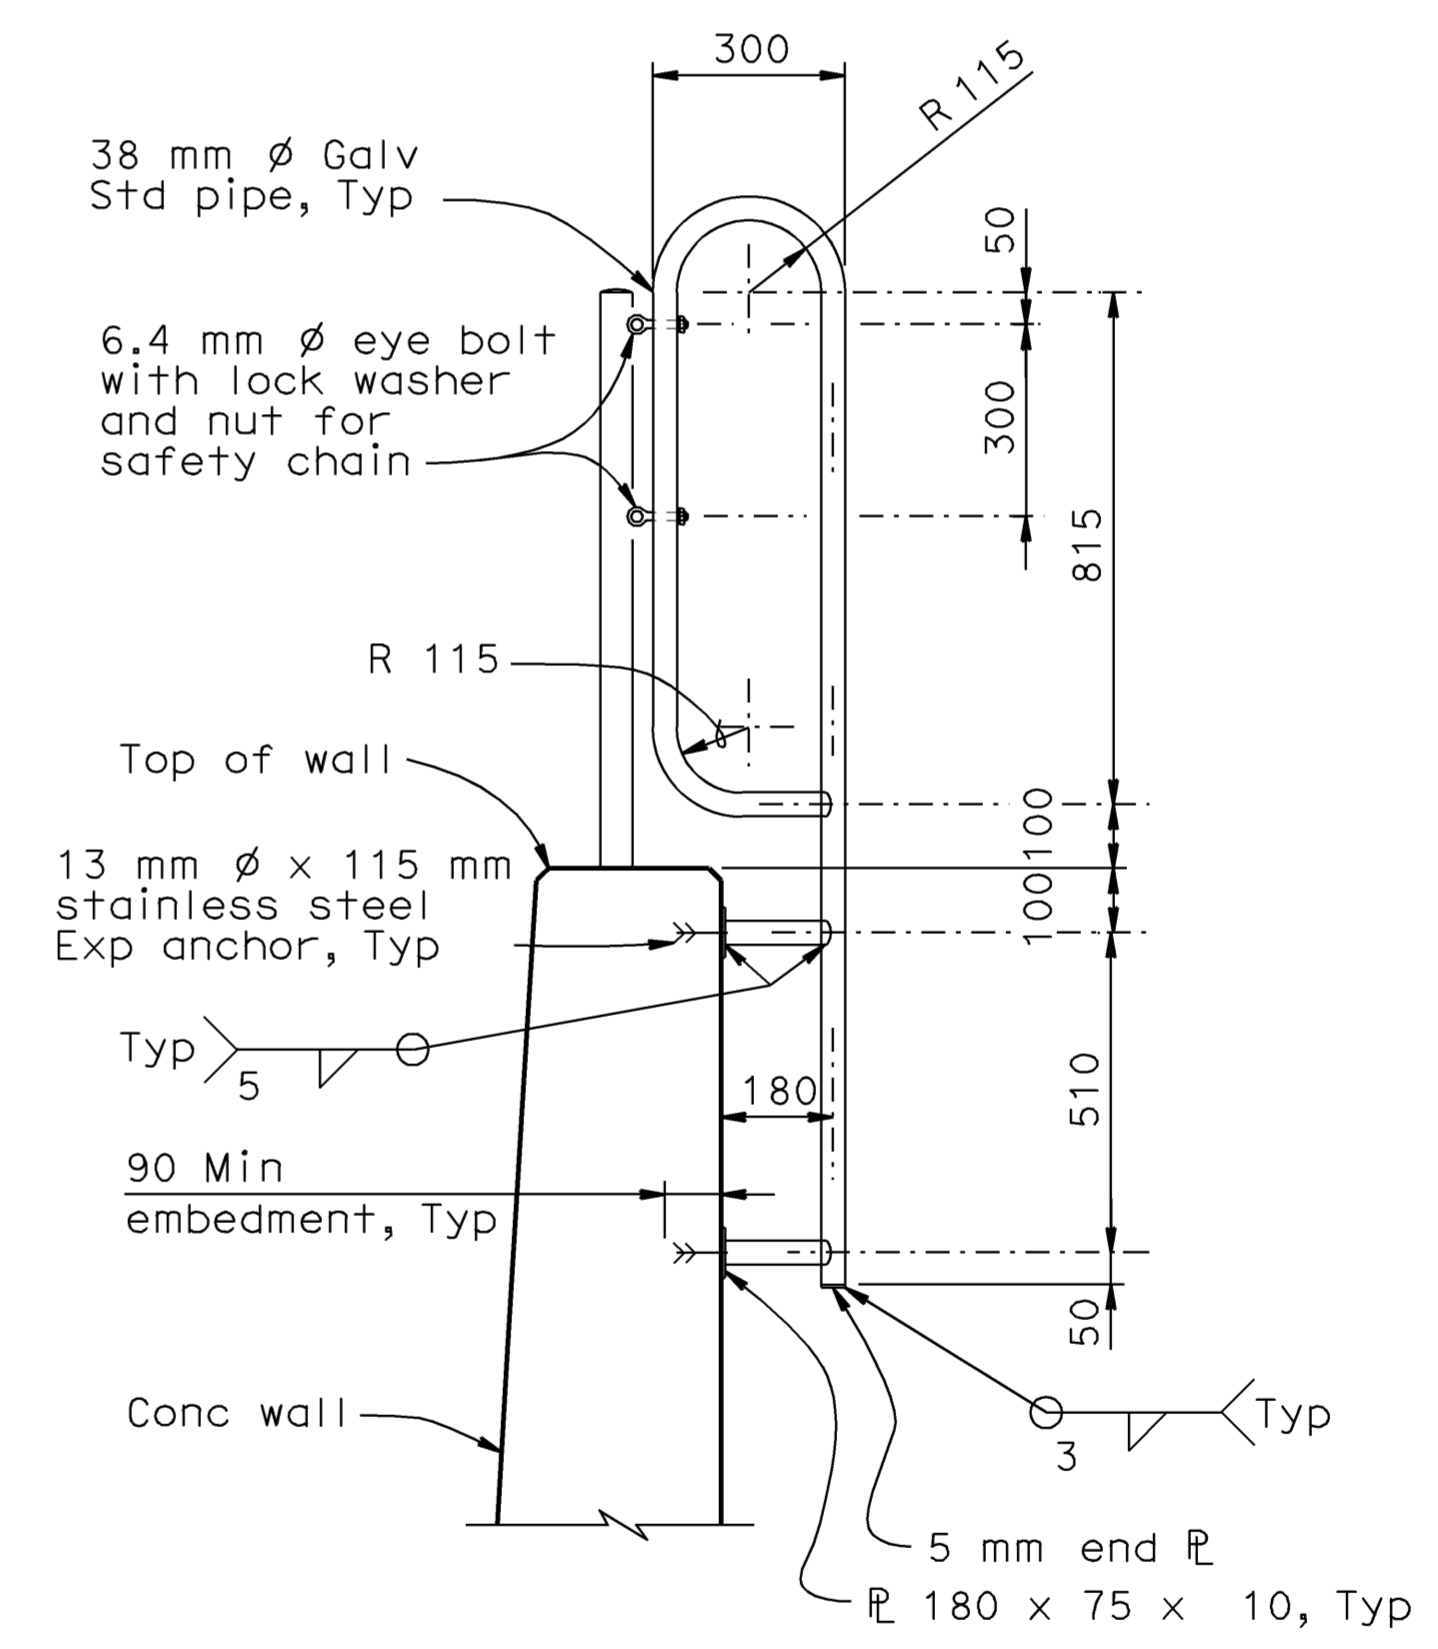

SECTION I - I
No Scale

ALL DIMENSIONS ARE IN MILLIMETERS UNLESS OTHERWISE SHOWN

WATER POLLUTION CONTROL DETAILS
WD-10

RELEASE DATE	DESIGN BY	BY	CHECKED
---	D. Dunrud	J&P Peterson	J&P Peterson
FILE NO.	DETAILS BY	BY	CHECKED
---	J&P Peterson	J&P Peterson	J&P Peterson
	SUBMITTED BY	BY	DRAWING DATE
	J&P Peterson	J&P Peterson	8/07

STATE OF CALIFORNIA
DEPARTMENT OF TRANSPORTATION


DIVISION OF ENGINEERING SERVICES

BRIDGE NO.
MILE POST

AUSTIN VAULT SAND FILTER
MISCELLANEOUS DETAILS No. 1

REVISION DATES (PRELIMINARY STAGE ONLY)

SHEET 10 OF 11

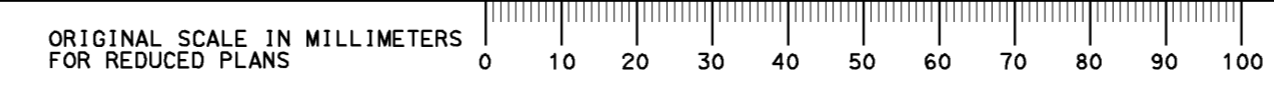

CU 07
EA 121841


DISREGARD PRINTS BEARING EARLIER REVISION DATES

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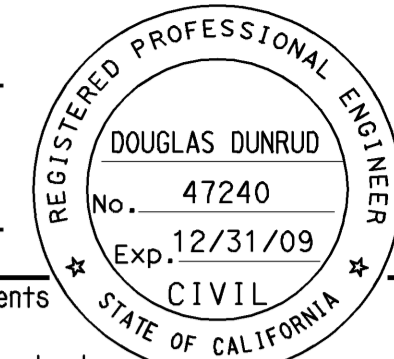
DATE PLOTTED => 12-JUN-2009 08:45



DIST.	COUNTY	ROUTE	MILE POST TOTAL PROJECT	SHEET NO.	TOTAL SHEETS
07	LA	5	42.8/47.3	86	1073


 REGISTERED ENGINEER - CIVIL
 6-8-09
 PLANS APPROVAL DATE
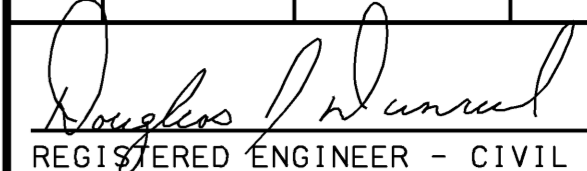
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MISCELLANEOUS ITEMS					
Austin Type	Gabion Wall (m ³)	Cable Railing (m)	Sand Bed (m ³)	Permeable Material (m ³)	Filter Fabric (m ²)
S-142-0.91	6.9	50.29	48.2	39.0	124.58
L-142-0.91	4.6	61.26	48.2	42.1	127.93
S-142-1.37	10.7	50.29	48.2	39.0	124.58
L-142-1.37	6.9	61.26	48.2	42.1	127.93
S-142-1.83	13.8	50.29	48.2	39.0	124.58
L-142-1.83	9.2	61.26	48.2	42.1	127.93
S-283-0.91	9.2	72.24	96.3	84.1	238.30
L-283-0.91	6.1	89.31	95.6	94.0	242.48
S-283-1.37	13.8	72.24	96.3	84.1	238.30
L-283-1.37	9.2	89.31	95.6	94.0	242.48
S-283-1.83	18.3	72.24	96.3	84.1	238.30
L-283-1.83	12.2	89.31	95.6	94.0	242.48
S-425-0.91	11.5	88.09	145.3	133.8	351.17
L-425-0.91	7.6	110.03	146.8	153.7	361.21
S-425-1.37	17.6	88.09	145.3	133.8	351.17
L-425-1.37	11.5	110.03	146.8	153.7	361.21
S-425-1.83	22.9	88.09	145.3	133.8	351.17
L-425-1.83	15.3	110.03	146.8	153.7	361.21


NOTES:

- For Invert concrete and reinforcing steel quantities, see "Footings Details" sheet.
- For wall concrete and reinforcing steel quantities, see "Wall Details" sheet.
- Misc metal & steel = 53 kg for all vault configurations. Includes trash screen only and is based on a 610 mm Ø overflow outlet pipe.

ALL DIMENSIONS ARE IN MILLIMETERS UNLESS OTHERWISE SHOWN

WATER POLLUTION CONTROL DETAILS

WD-11

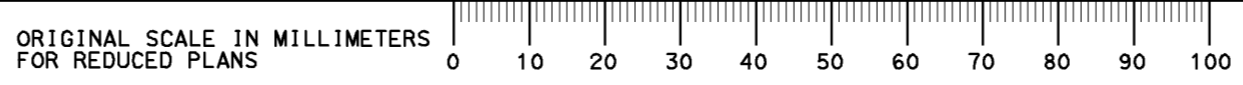RELEASE DATE ---	DESIGN BY <i>D. Dunrud</i>	CHECKED <i>J&P Peterson</i>		STATE OF CALIFORNIA DEPARTMENT OF TRANSPORTATION	DIVISION OF ENGINEERING SERVICES	BRIDGE NO.	AUSTIN VAULT SAND FILTER MISCELLANEOUS QUANTITIES
FILE NO. ---	DETAILS BY <i>J&P Peterson</i>	CHECKED <i>J&P Peterson</i>				MILE POST	
	SUBMITTED BY <i>J&P Peterson</i>	DRAWING DATE <i>8/07</i>					

USERNAME => trmartin
 DGN FILE => 7121841h011.dgn

DISREGARD PRINTS BEARING EARLIER REVISION DATES

REVISION DATES (PRELIMINARY STAGE ONLY)	SHEET	OF
	11	11

DATE PLOTTED => 12-JUN-2009 TIME PLOTTED => 08:15

GENERAL NOTES

Designation:
Types of Gross Solids Removal Devices (GSRDs) are Linear Radial (LR) and Inclined Screen (Types 1 and 2). The Linear Radial has either a standard or high velocity configuration noted as Linear Radial or Linear Radial (HV). The Type 1 has either a level or sloped sidewall configuration noted as Type 1L or Type 1S.

Special Reinforcement Coverage:
GSRD Standard Details are not to be used in a corrosive environment or where there is a severe abrasive flow condition or in freeze-thaw locations.

Special Design:
Required for ground water conditions above bottom of GSRD, surcharge loads exceeding HS20 truck load, design bearing pressures or sizes greater than those on this plan.

Traffic Loading:
No traffic load is allowed over GSRDs. As determined by the Engineer, barriers or MBGR shall be provided between GSRDs and traffic lanes.

All GSRD BMP Detail Drawings are applicable for velocities up to 6.1 m/sec.

DESIGN FLOW

LINEAR RADIAL ✕			
GSRD Type	Total Screen Length, m	Flow Rate (m ³ /sec)	Debris Area (hectares)
LR-1	1.5	0.10	0.32
LR-2	3.0	0.20	0.64
LR-3	4.6	0.31	0.91
LR-4	6.1	0.41	1.28
LR-5	7.6	0.52	1.60
LR-6	9.1	0.62	1.92

✕ When maximum inlet velocity exceeds 2.5 m/sec, High Velocity (HV) details, are required.

INCLINED SCREEN - TYPE 1			
GSRD Type	Total Screen Length, m	Flow Rate (m ³ /sec)	Debris Area (hectares)
1-A	4	0.27	1.00
1-B	6	0.41	2.08
1-C	8	0.55	3.55

INCLINED SCREEN - TYPE 2			
GSRD Type	Total Screen Length, m	Flow Rate (m ³ /sec)	Debris Area (hectares)
2-A	1.0	0.08	0.57
2-B	1.5	0.12	0.86
2-C	2.0	0.17	1.15
2-D	2.5	0.21	1.43

DESIGN NOTES

Specifications:
Design:
Bridge Design Specification April 2000 (LFD)
(1996 AASHTO) with interims and revisions by Caltrans


Wall (LFD) : 1.5 D + 1.5 E
Footing (LFD): D + PYM
Where D = Dead Load
E = Earth Load
PYM = Probable Yield Moment,
(1.3 x nominal yield moment of stem)

Capacity reduction factor is included.


Earth Load: 22.0 kPa/m vertical,
Water Load: 9.8 kPa/m horizontal,

Equivalent Fluid Pressure = 15.7 kPa/m horizontal (Case I).


Earth pressure for 1:2 unlimited slope determined from Rankine's formula with $\phi = 33^{\circ}42'$ (Case II).

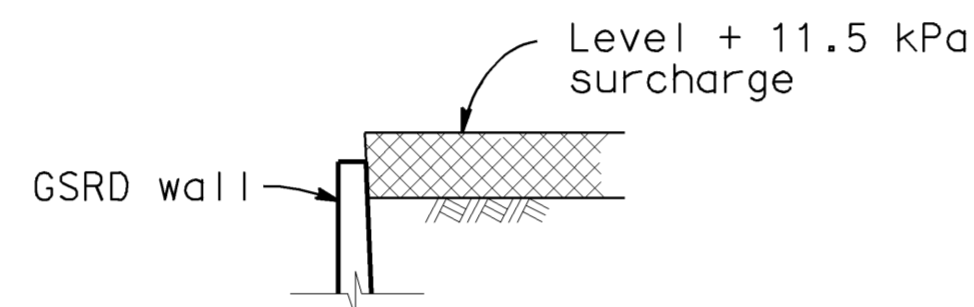

CASE I

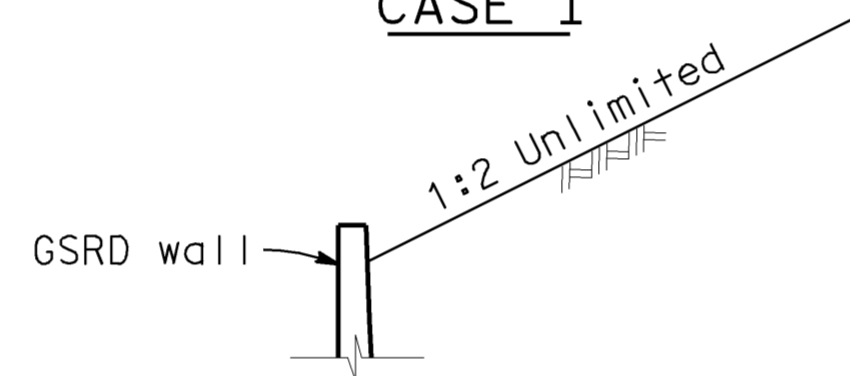

CASE II

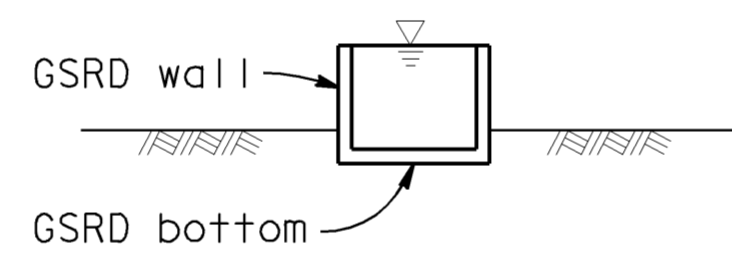

CASE III

DETAIL OF DESIGN LOADING CASES

CASE I Level + 11.5 kPa surcharge, GSRD empty
CASE II 1:2 Unlimited slope, GSRD empty
CASE III GSRD full of water, no soil pressure

Grating (LL) Load : 3.5 kPa

Design Conditions:
Design H may be exceeded by 150 mm before going to the next size.

Unit Stresses:
 $f_c = 25$ MPa
 $f_y = 420$ MPa (bar reinforcing)
 $f_y = 210$ MPa (grating)

Shear:
Maximum allowable shear,
 $V_c = 0.25 \sqrt{f'_c}$ Mpa

Design Bearing Pressure = 125 kPa

CONSTRUCTION NOTES

Expansion joints:
Inverts - No expansion joints shall be permitted.
Walls - Place 13 mm expansion joint filler vertically at 9 m \pm centers with strip water stop.


B0-1
1-3

Construction Joints:
Temporary joints may be permitted if normal (or radial) to ϕ of GSRD. Otherwise, the contractor is to submit a proposal for consideration.


Backfill:
See Standard Specifications, except the difference in backfill shall not exceed 1.2 m between side walls and shall not exceed the lesser of wall height "H" or 2.4 m between inlet and outlet walls.

Cable Railing:
As determined by the Engineer, cable railing may be added at top of wall of the Linear Radial GSRD. See "Road Plans" for quantities, and "Linear Radial Details No. 1" sheet for details.

Earthwork:
Excavation and Backfill with Cut and Exposed conditions -

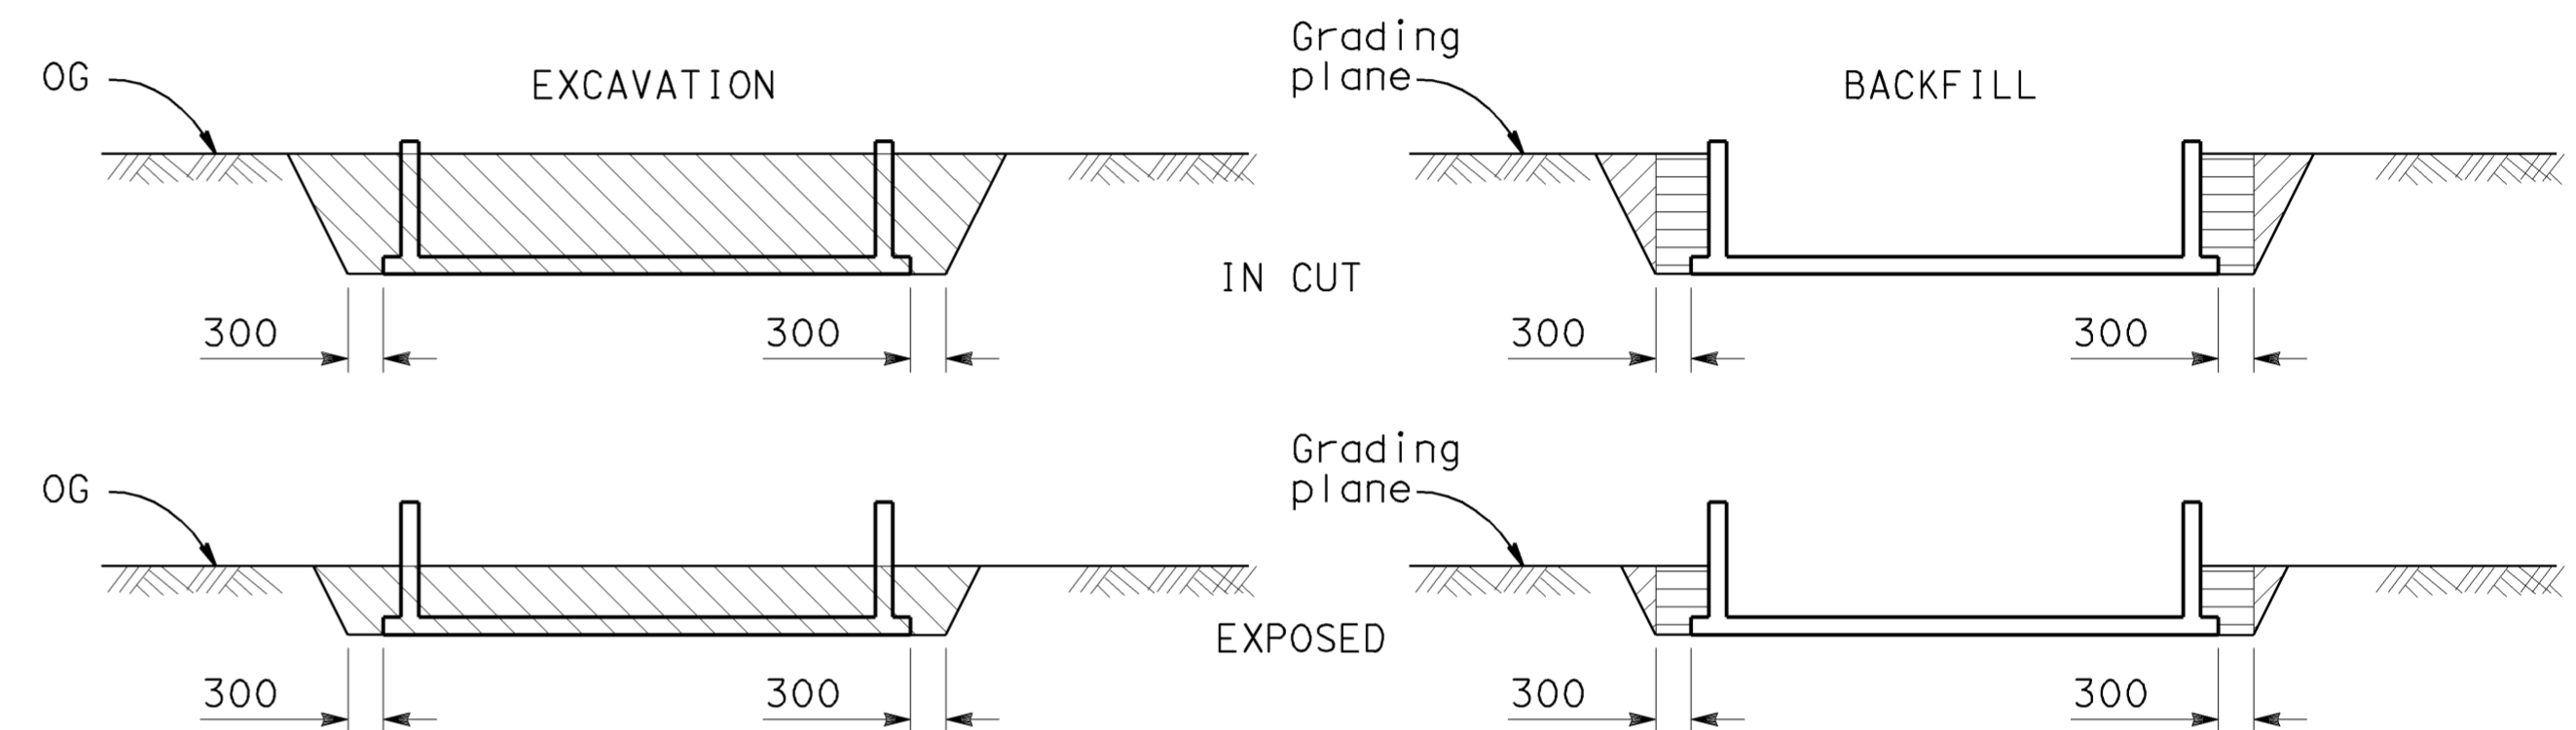

LINEAR RADIAL

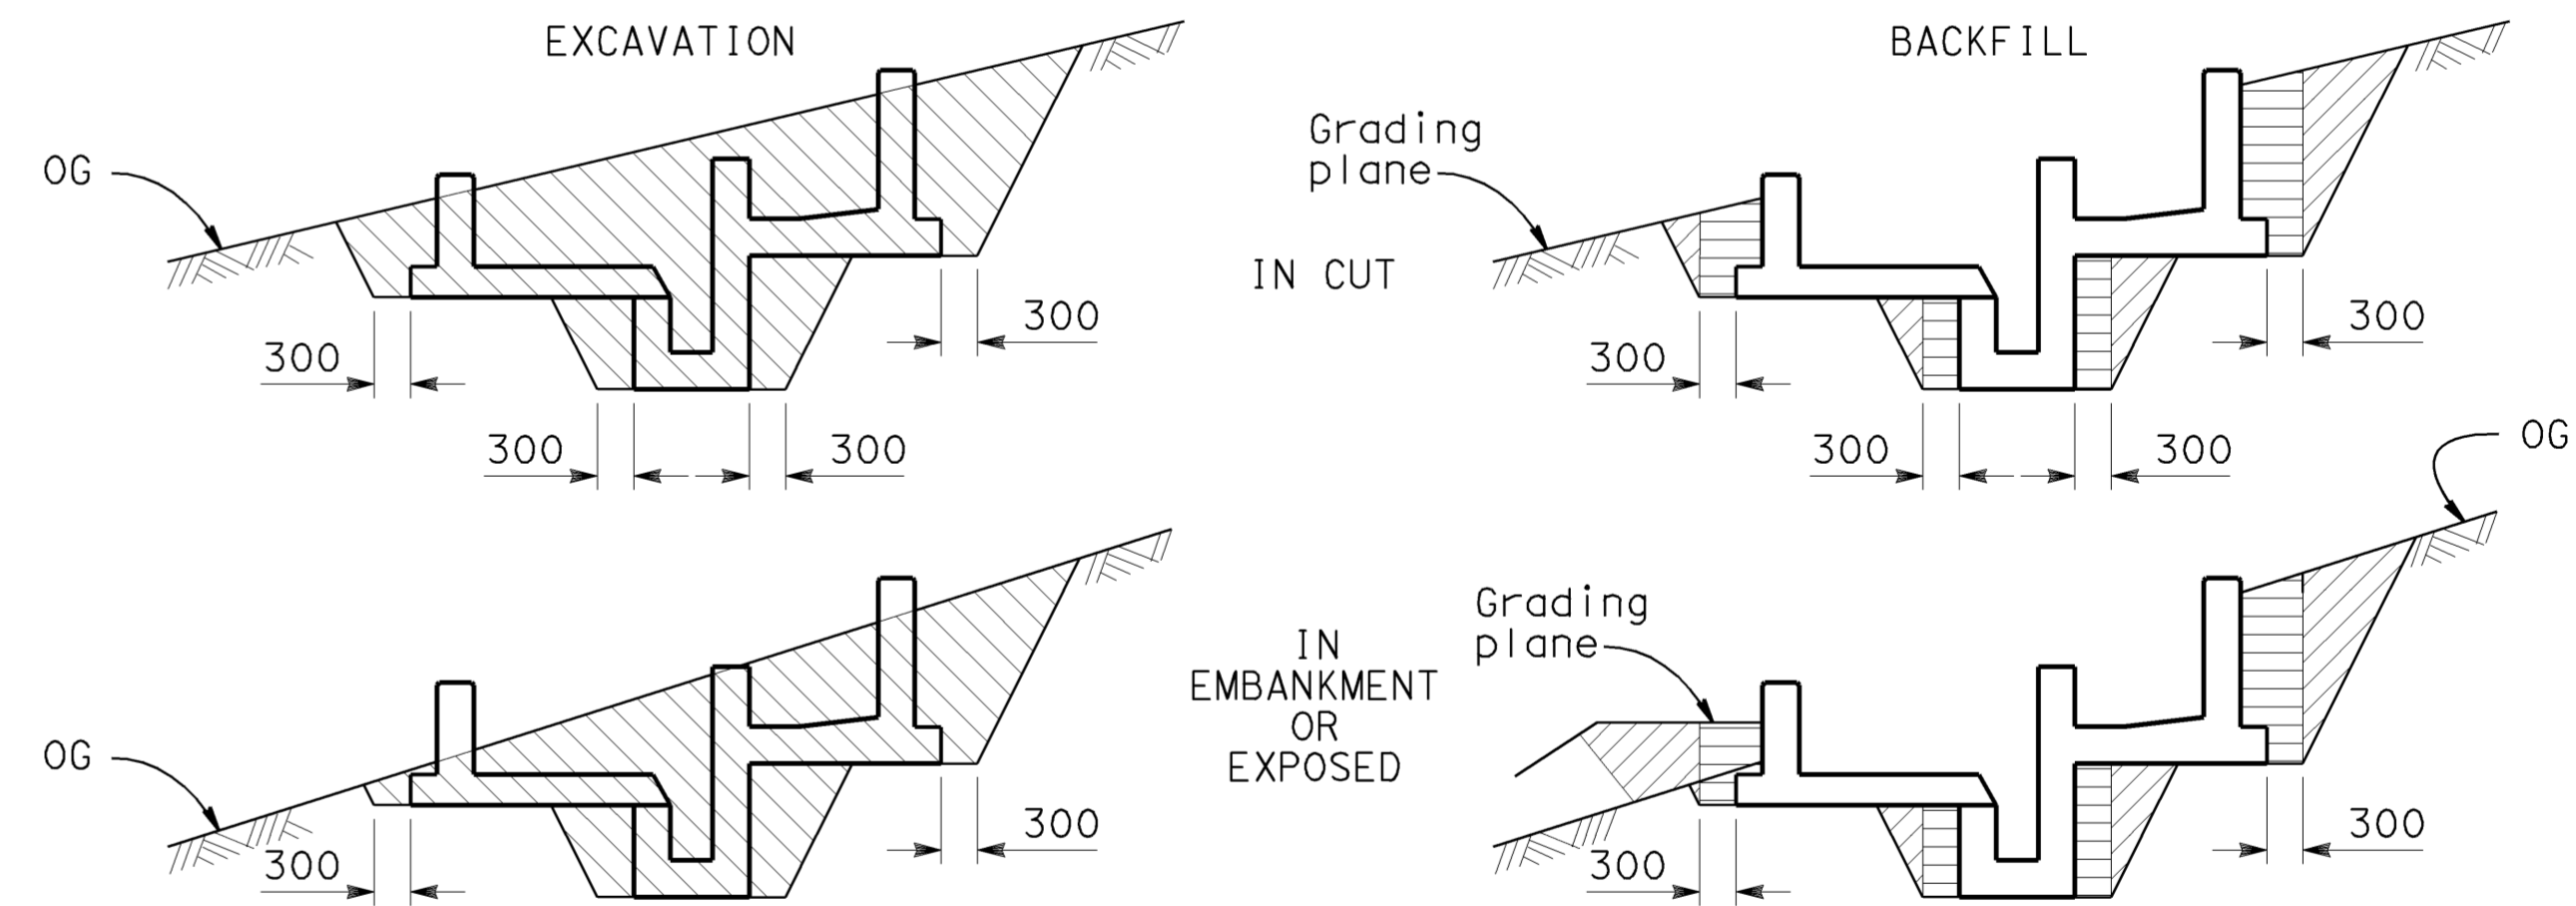

INCLINED SCREEN

(Type 1S shown, Type 1L and 2 similar)

LEGEND:

- Structure excavation (culvert)
- Structure backfill (culvert)
- 90% relative compaction
- Roadway embankment
- Original ground, OG

NOTES:

1. Slope or shore excavation sides as necessary.
2. Dimensions shown are minimum.
3. Use Structure Backfill (culvert) except where slurry backfill is required around outlet pipes.

WATER POLLUTION CONTROL DETAILS WD-12

ALL DIMENSIONS ARE IN MILLIMETERS UNLESS OTHERWISE SHOWN


RELEASE DATE ---	DESIGN BY <i>D. Dunrud</i>	CHECKED <i>J&P Peterson</i>	STATE OF CALIFORNIA DEPARTMENT OF TRANSPORTATION	DIVISION OF ENGINEERING SERVICES	BRIDGE NO.	GROSS SOLIDS REMOVAL DEVICE
FILE NO. ---	DETAILS BY <i>J&P Peterson</i>	CHECKED <i>J&P Peterson</i>			MILE POST	GENERAL NOTES
	SUBMITTED BY <i>D. Forester</i>	DRAWING DATE <i>02/07</i>				REVISION DATES (PRELIMINARY STAGE ONLY)
			ORIGINAL SCALE IN MILLIMETERS FOR REDUCED PLANS	CU 07314 EA 121841	DISREGARD PRINTS BEARING EARLIER REVISION DATES	SHEET 1 OF 32




DIST.	COUNTY	ROUTE	MILE POST TOTAL PROJECT	SHEET NO.	TOTAL SHEETS
07	LA	5	42.8/47.3	88	1073

REGISTERED ENGINEER - CIVIL
 DOUGLAS DUNRUD
 No. 47240
 Exp. 12/31/09
 CIVIL
 STATE OF CALIFORNIA


6-8-09
 PLANS APPROVAL DATE
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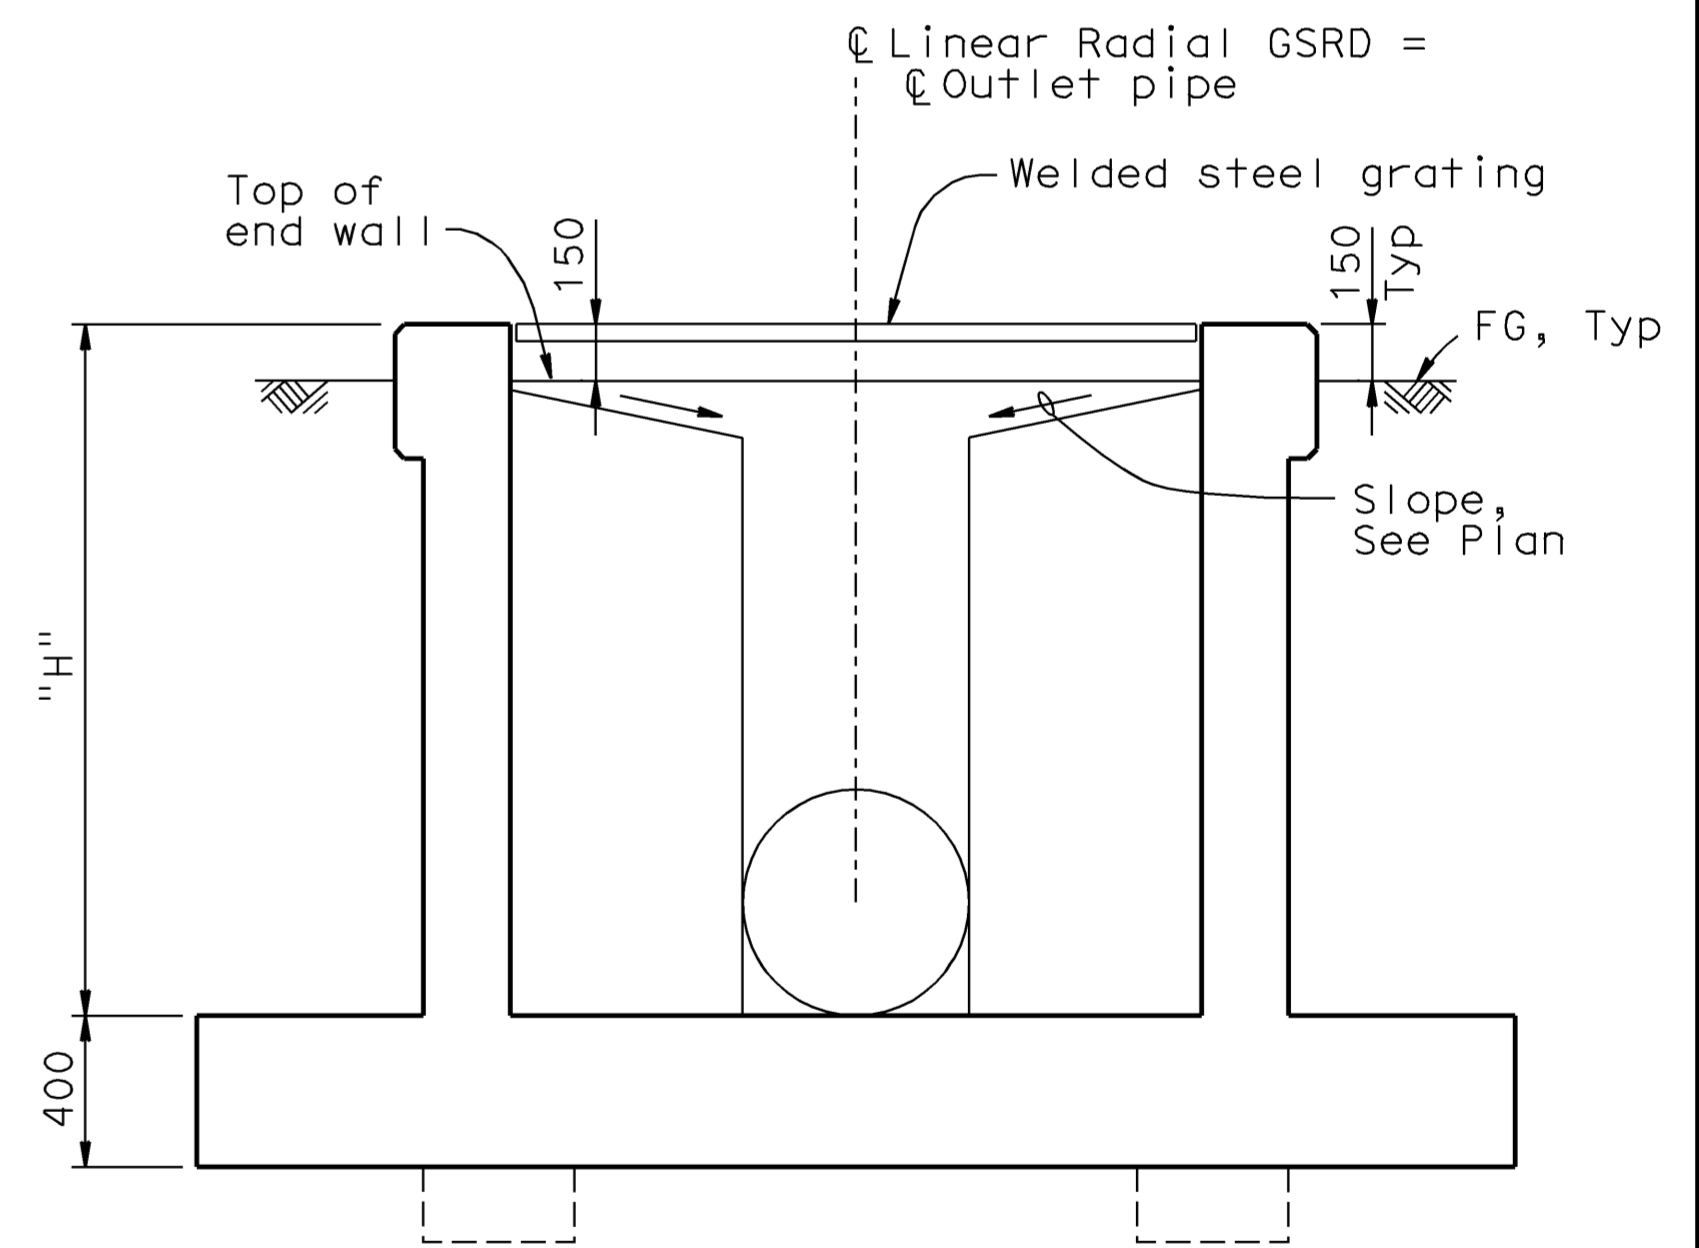
LONGITUDINAL SECTION - MAXIMUM SCREEN HEIGHT

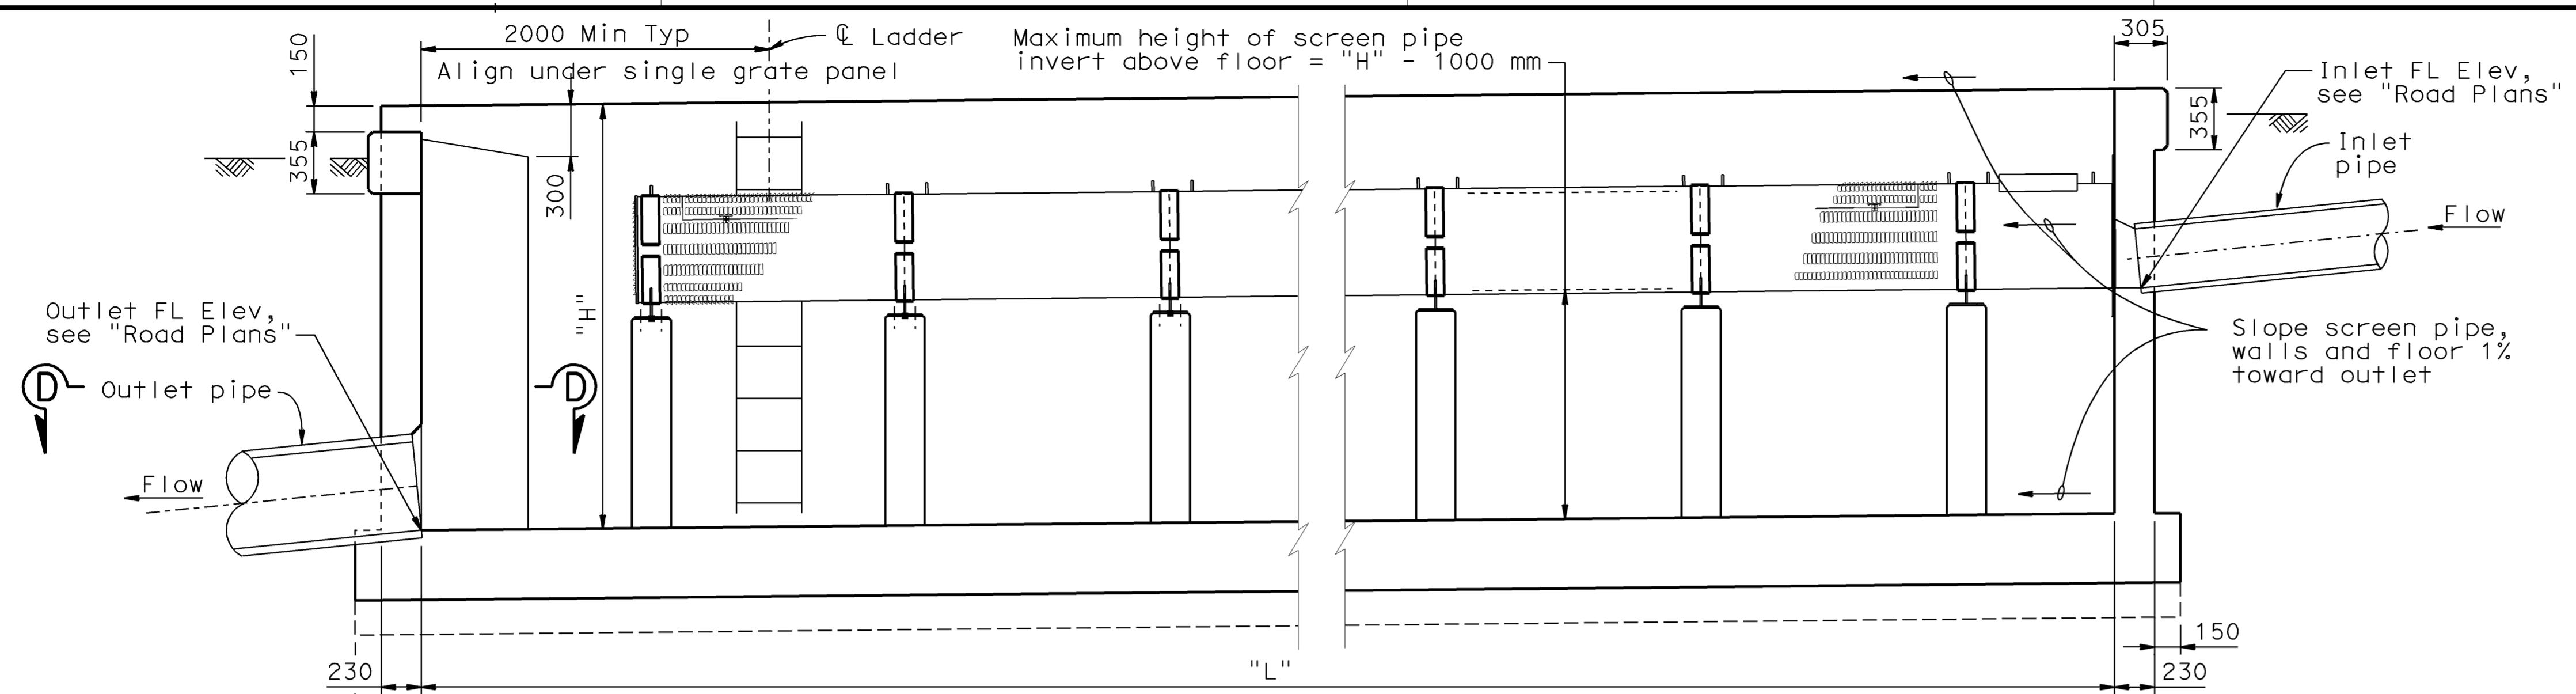

LONGITUDINAL SECTION - MINIMUM SCREEN HEIGHT

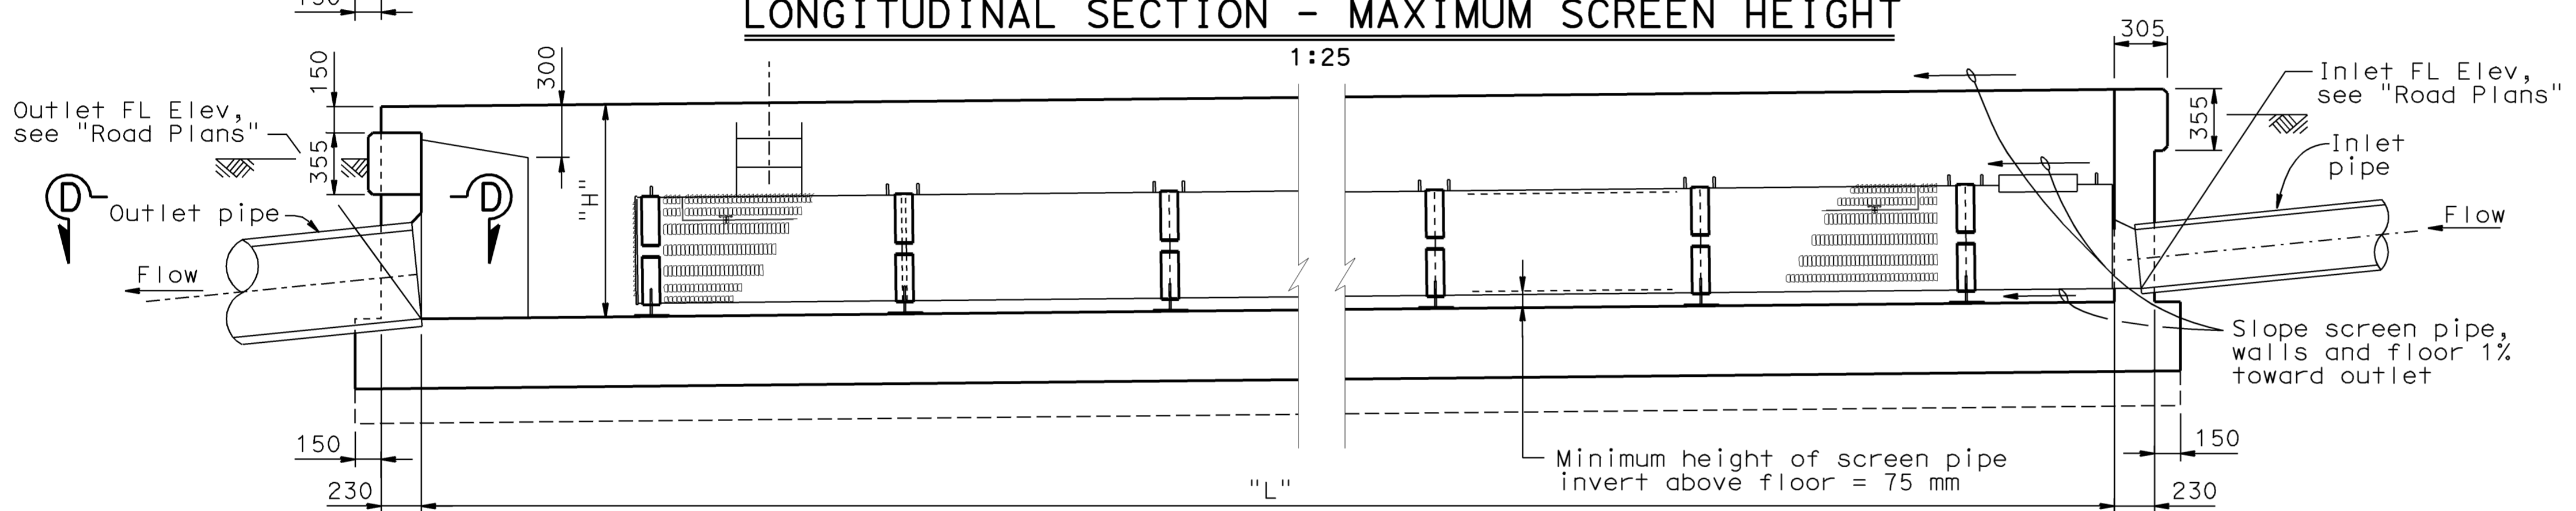

PLAN
1:25

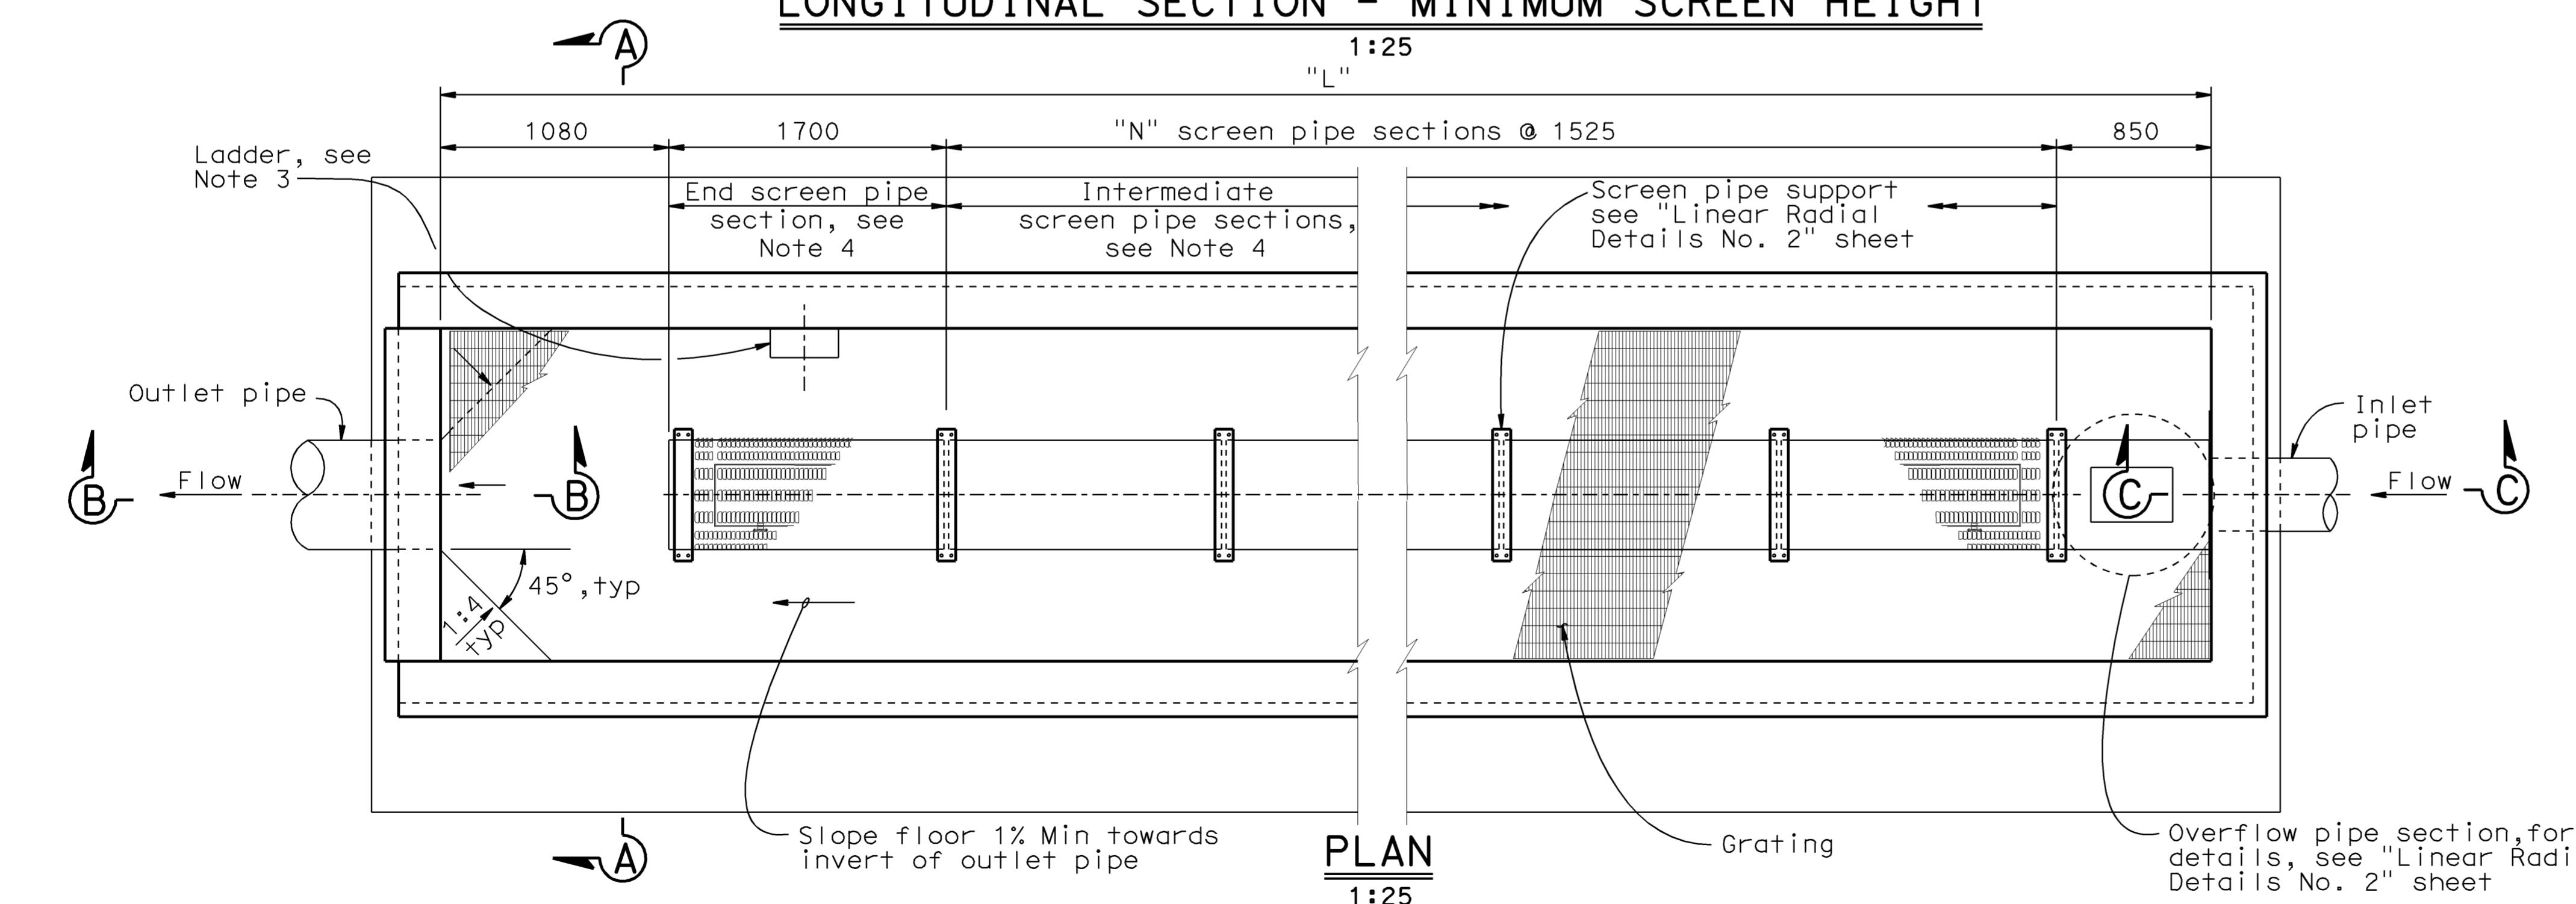

SECTION A-A
1:20

ALL DIMENSIONS ARE IN MILLIMETERS UNLESS OTHERWISE SHOWN

WATER POLLUTION CONTROL DETAILS
WD-13

RELEASE DATE	DESIGN BY	BY	CHECKED
---	D. Dunrud	J.&P. Peterson	J.&P. Peterson
FILE NO.	DETAILS BY	J.&P. Peterson	CHECKED
---	D. Forester	J.&P. Peterson	J.&P. Peterson
	SUBMITTED BY	D. Forester	DRAWING DATE
			02/07

BRIDGE NO.	GROSS SOLIDS REMOVAL DEVICE
MILE POST	LINEAR RADIAL - LAYOUT

STATE OF CALIFORNIA	DIVISION OF ENGINEERING SERVICES
DEPARTMENT OF TRANSPORTATION	

CU 07314	EA 121841	REVISION DATES (PRELIMINARY STAGE ONLY)	SHEET	OF
			2	32

ORIGINAL SCALE IN MILLIMETERS FOR REDUCED PLANS

USERNAME => trmartin
DGN FILE => 7121841h013.dgn

DATE PLOTTED => 12-JUN-2009 TIME PLOTTED => 08:16



DIST.	COUNTY	ROUTE	MILE POST TOTAL PROJECT	SHEET NO.	TOTAL SHEETS
07	LA	5	42.8/47.3	89	1073

REGISTERED ENGINEER - CIVIL
 DOUGLAS DUNRUD
 No. 47240
 Exp. 12/31/09
 CIVIL
 STATE OF CALIFORNIA


PLANS APPROVAL DATE
 6-8-09

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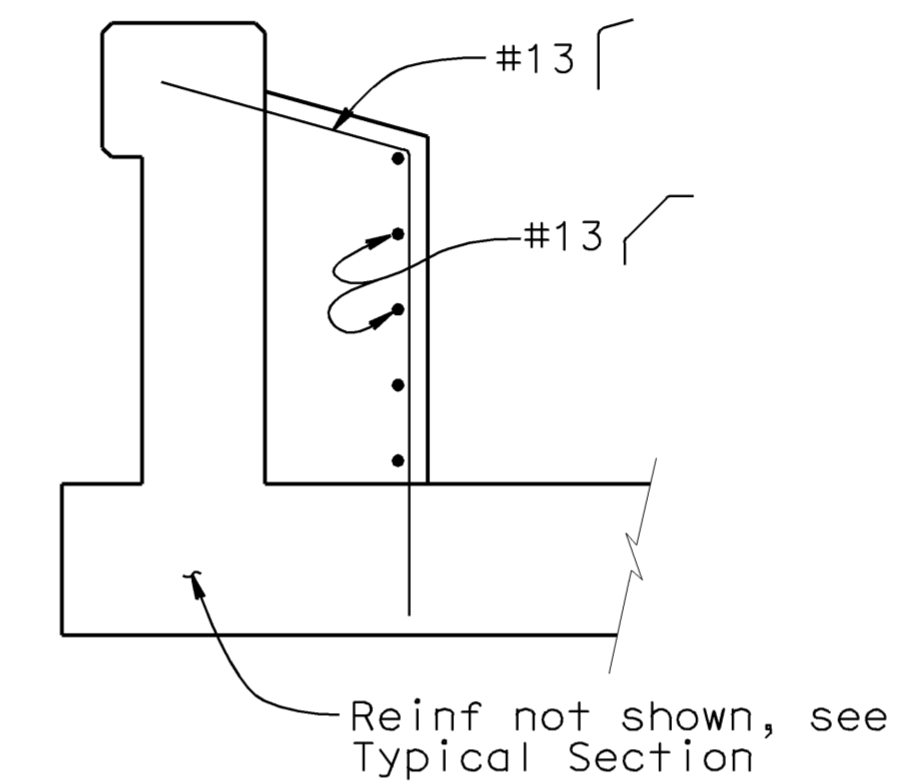
TABLE OF REINFORCING STEEL FOR LINEAR RADIAL GSRD

Design "H"	1220	1830	2440
"a" bars	#13 @ 450	#16 @ 300	#16 @ 200
"b" bars	#13 @ 450	#13 @ 450	#16 @ 400
"c" bars	#16 @ 350	#16 @ 230	#16 @ 100
"d" bars	#16 @ 350	#16 @ 350	#16 @ 300


- NOTES:
- For section locations, see "Linear Radial - Layout" sheet.
 - For invert elevation differential between inlet and outlet, see "Linear Radial - Quantities" sheet.
 - All metal components of screen pipe including connections to concrete shall be stainless steel.
 - All metal components of grating including connections to wall shall be galvanized.

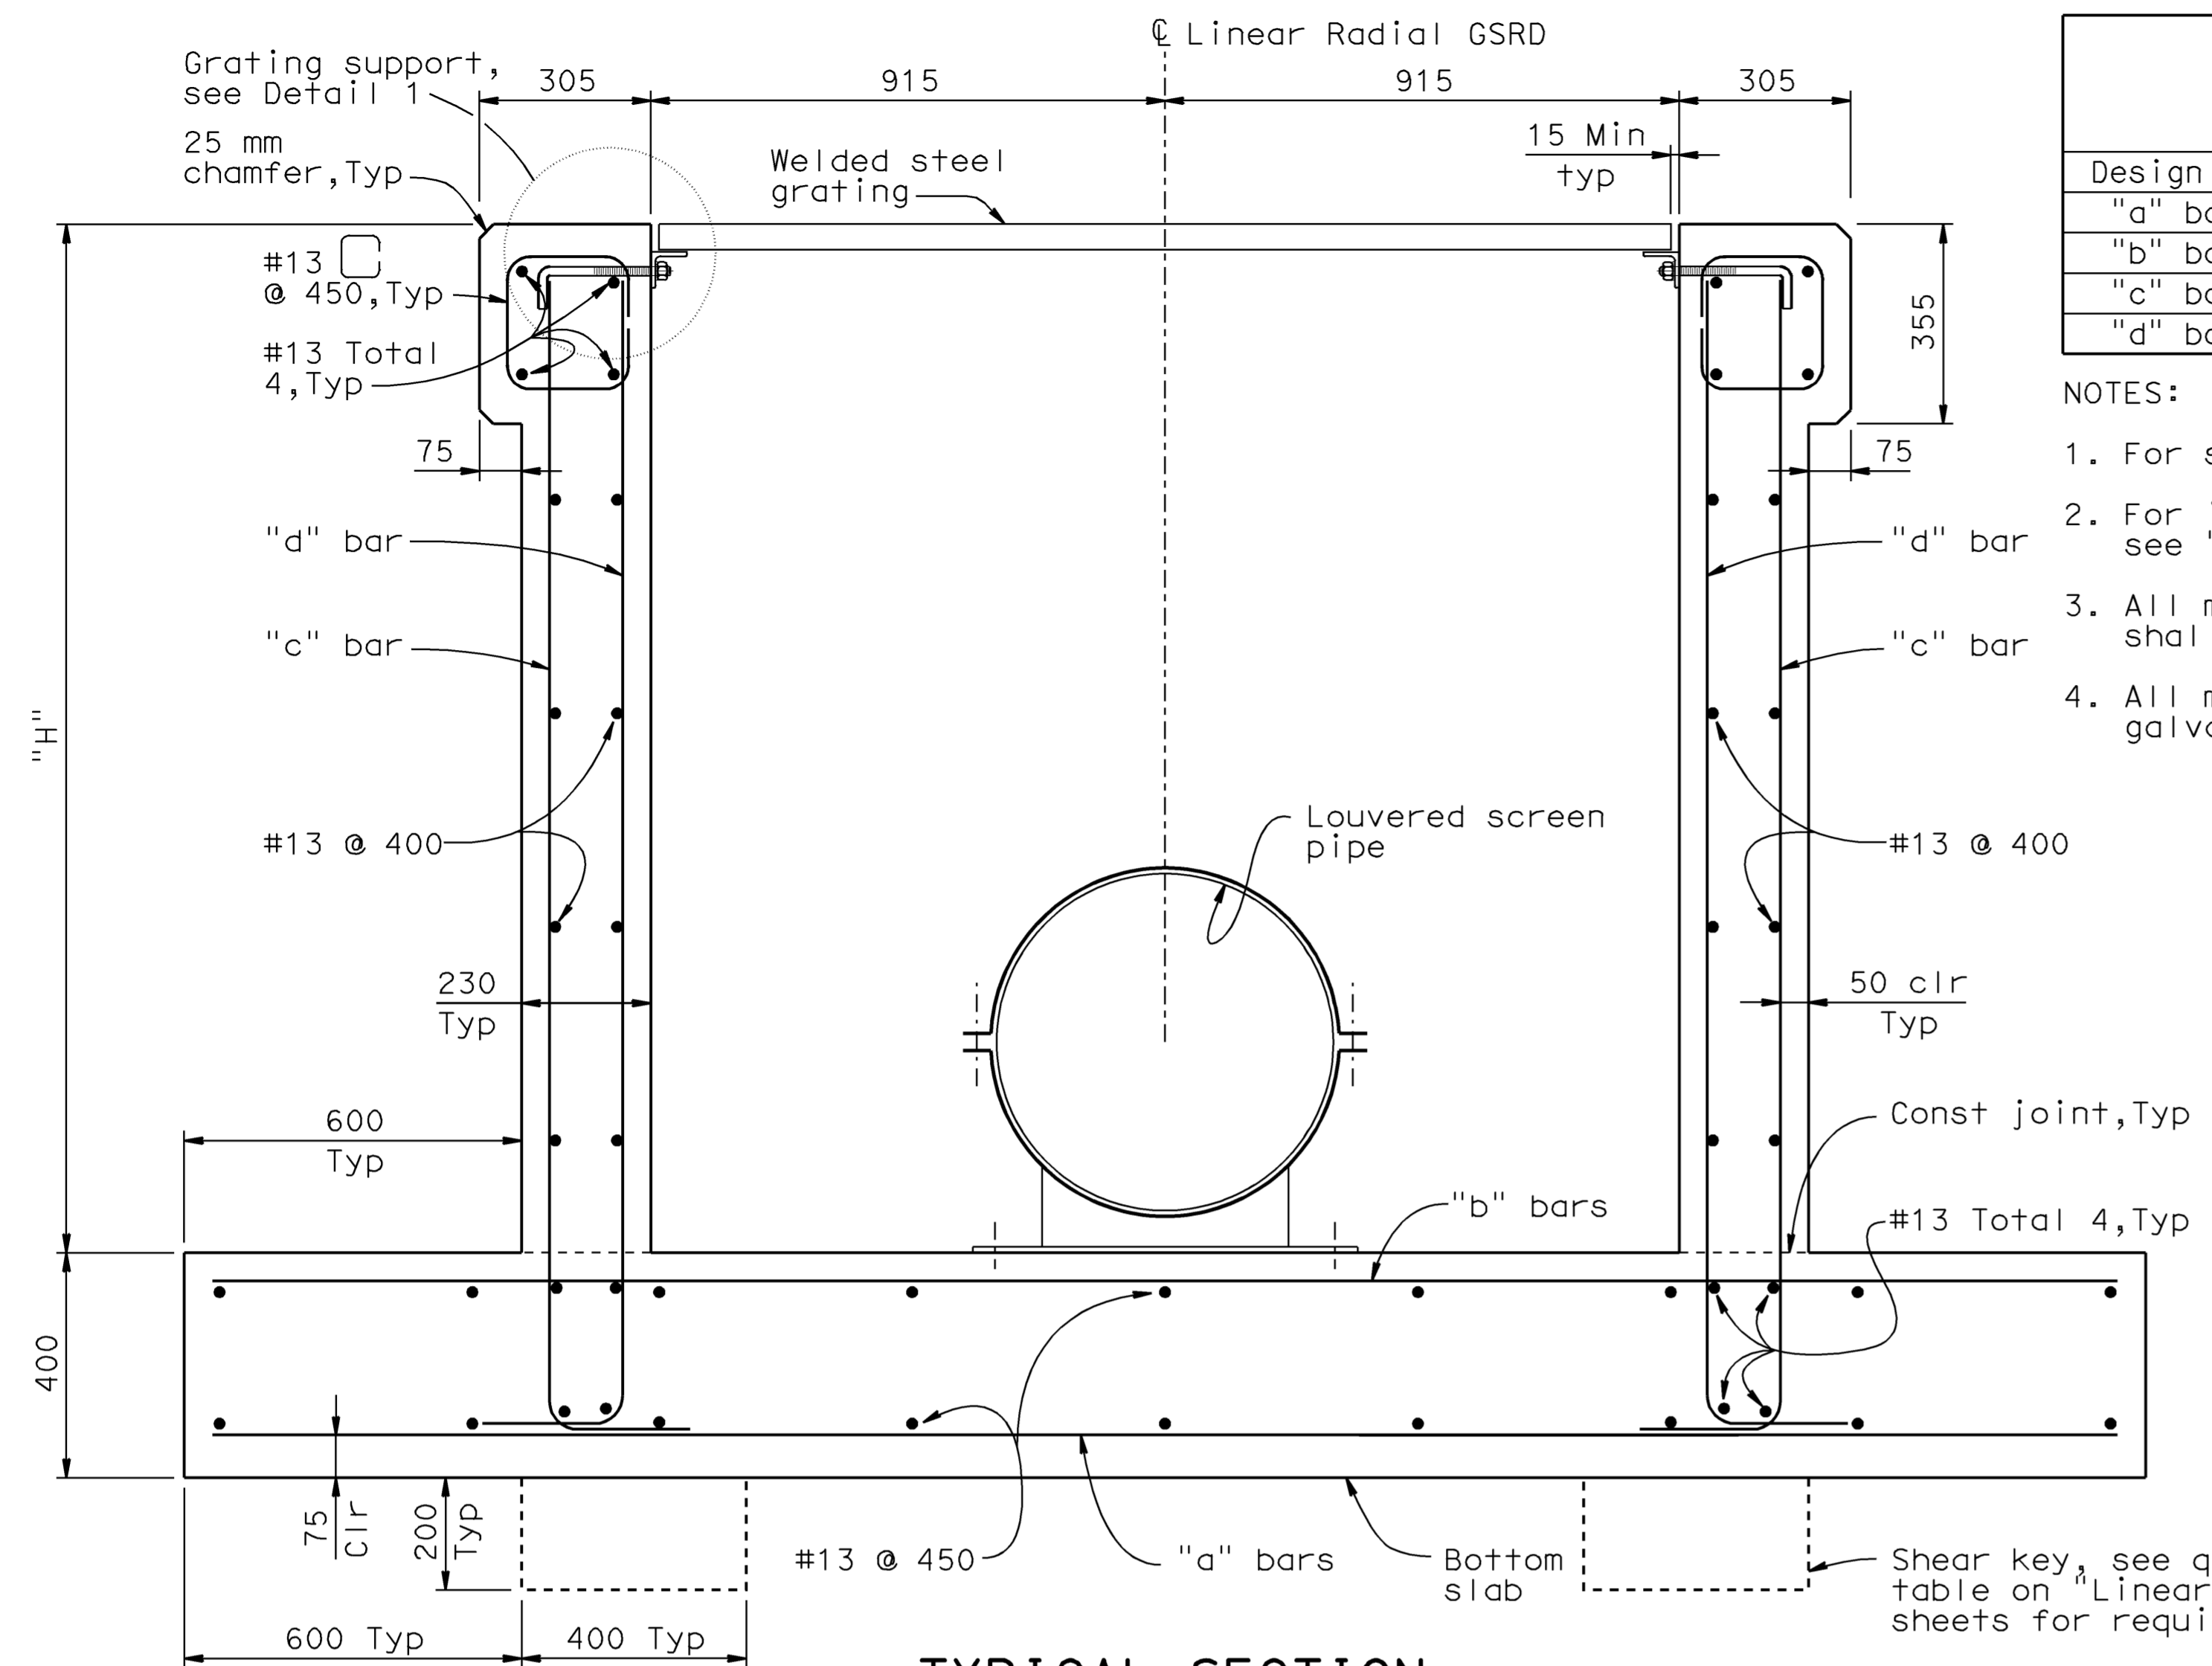


TYPICAL SECTION
1:10




VIEW E-E
1:20
(Outlet end only)

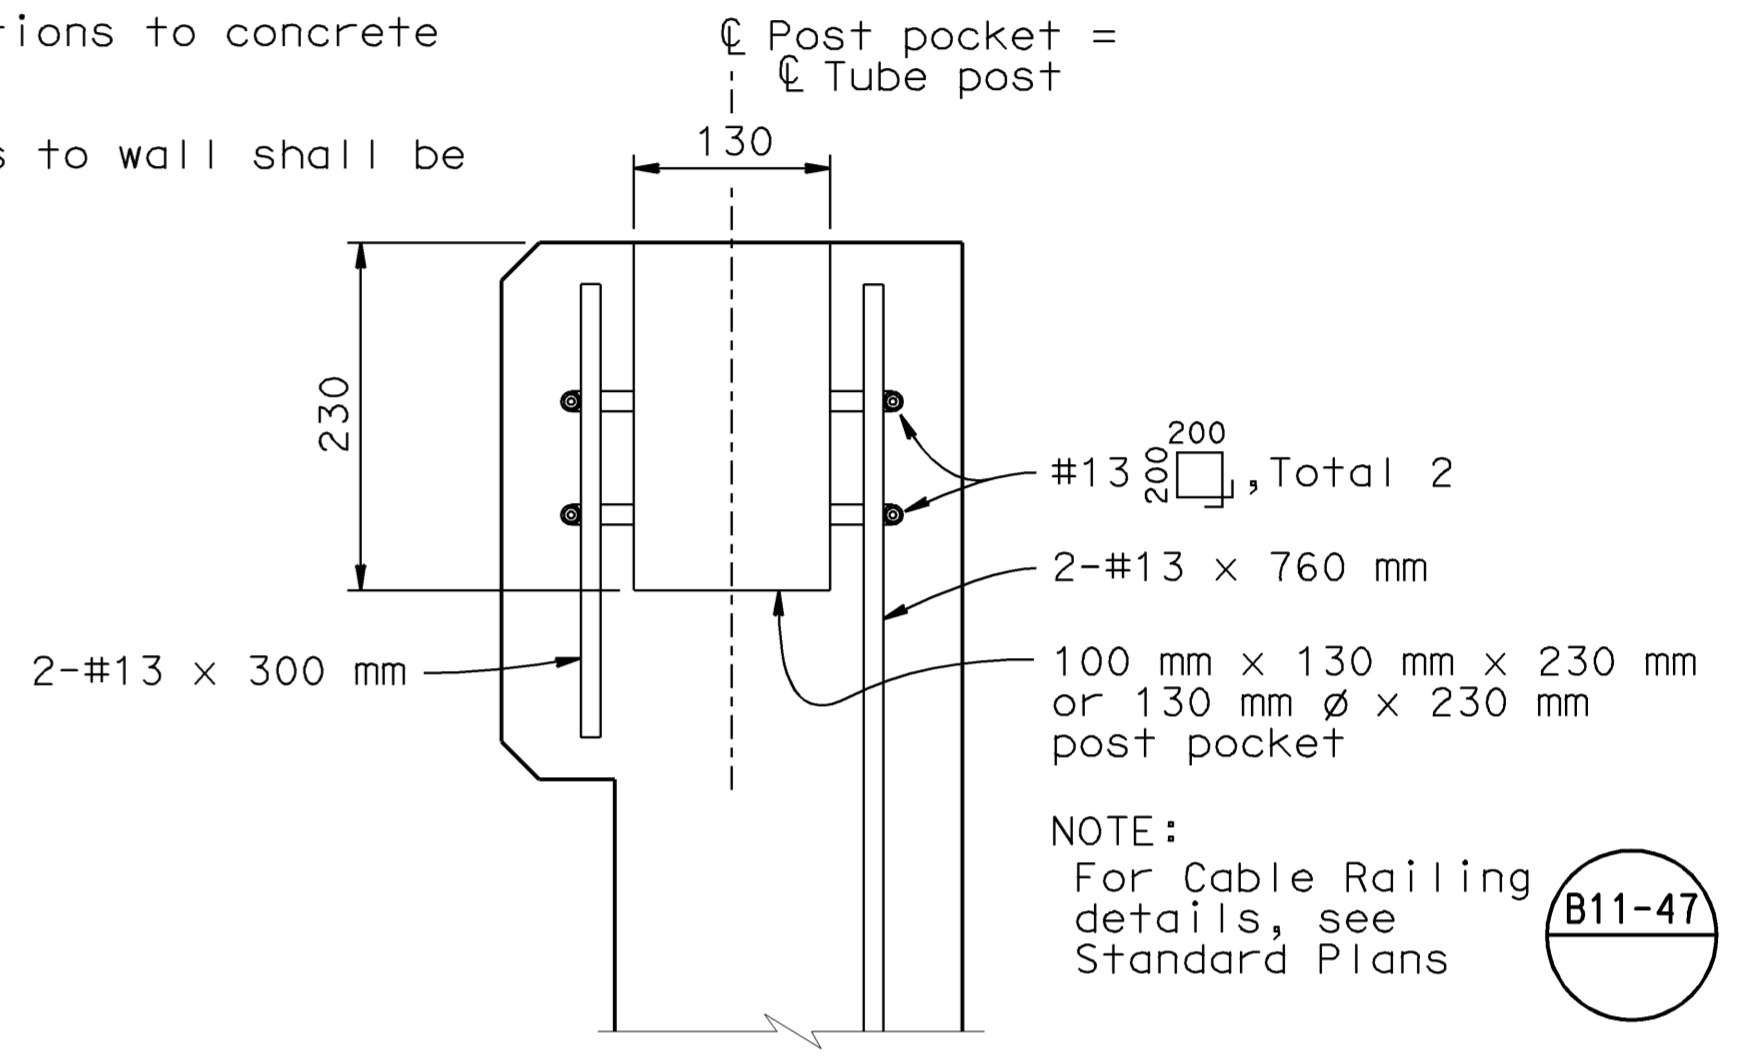


POST ANCHORAGE DETAIL (OPTIONAL)
1:5

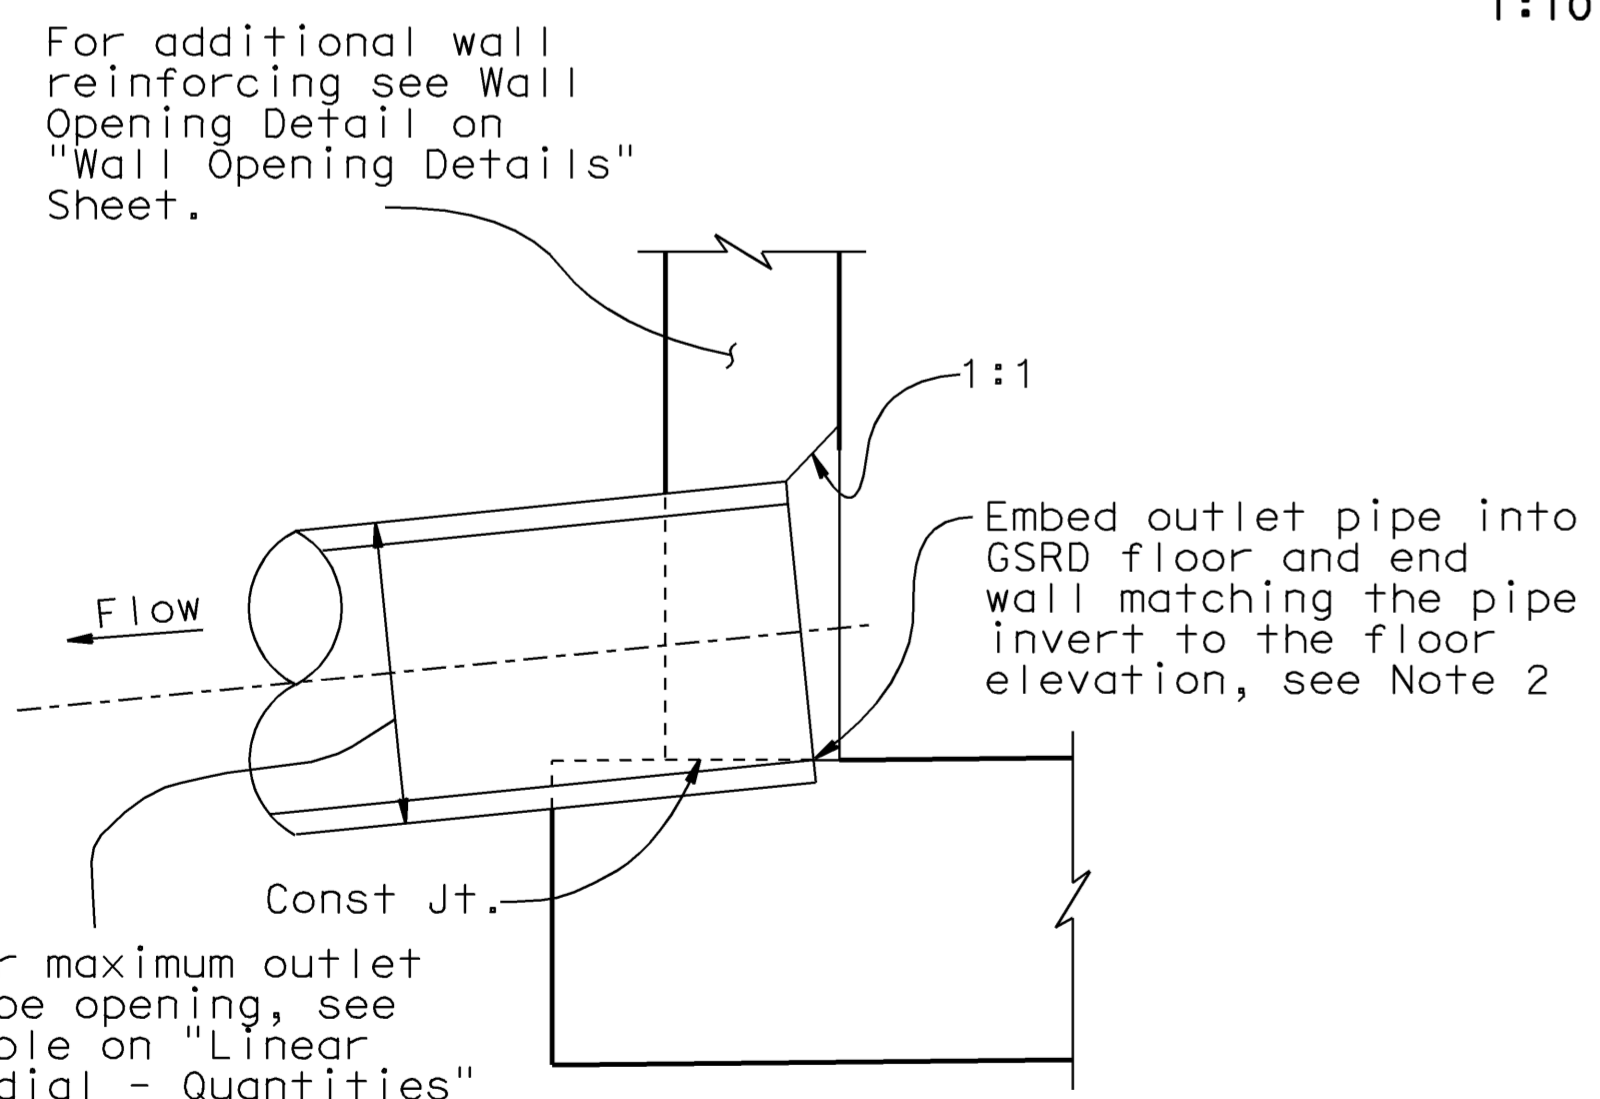


SECTION B-B
1:10

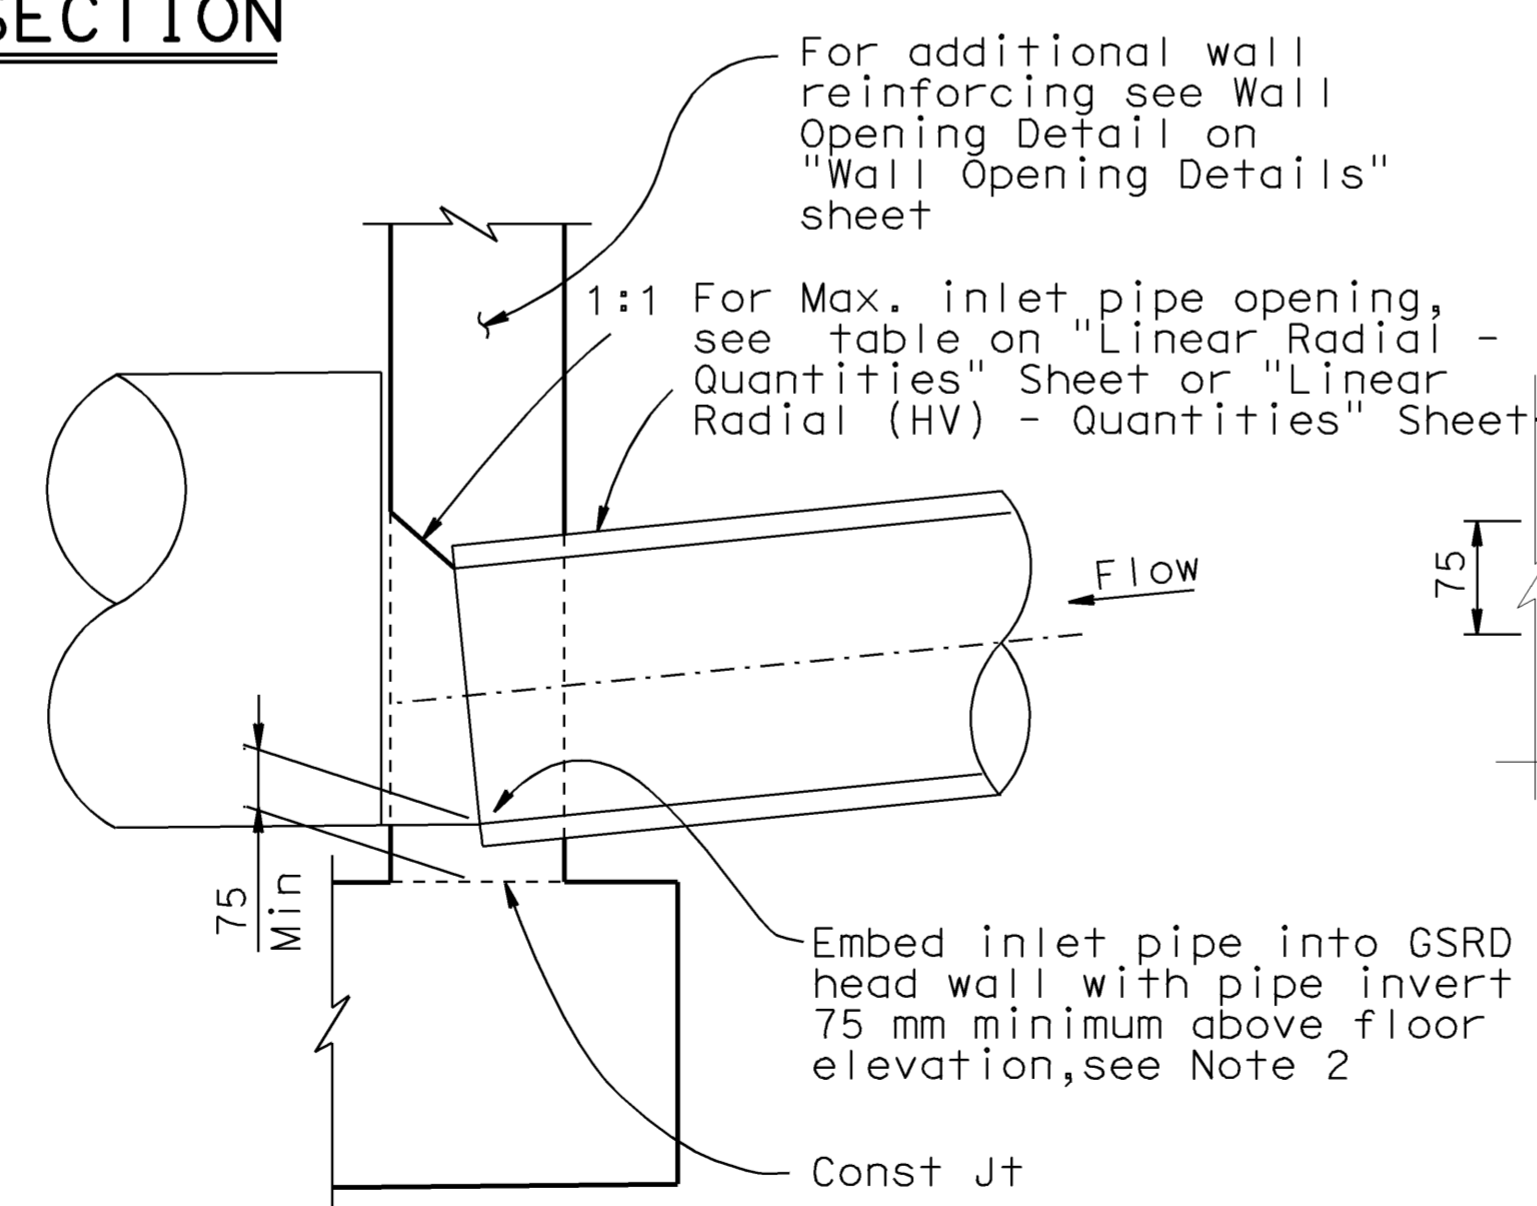

SECTION C-C
1:10

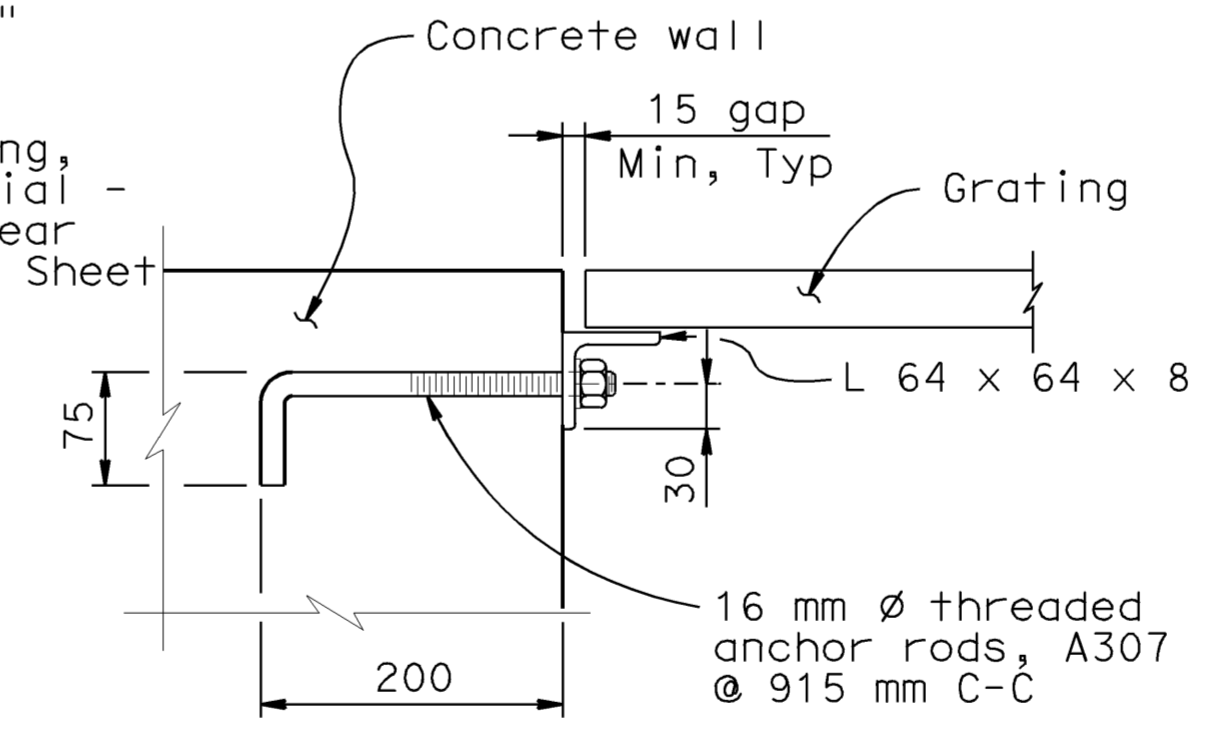

DETAIL 1
1:5

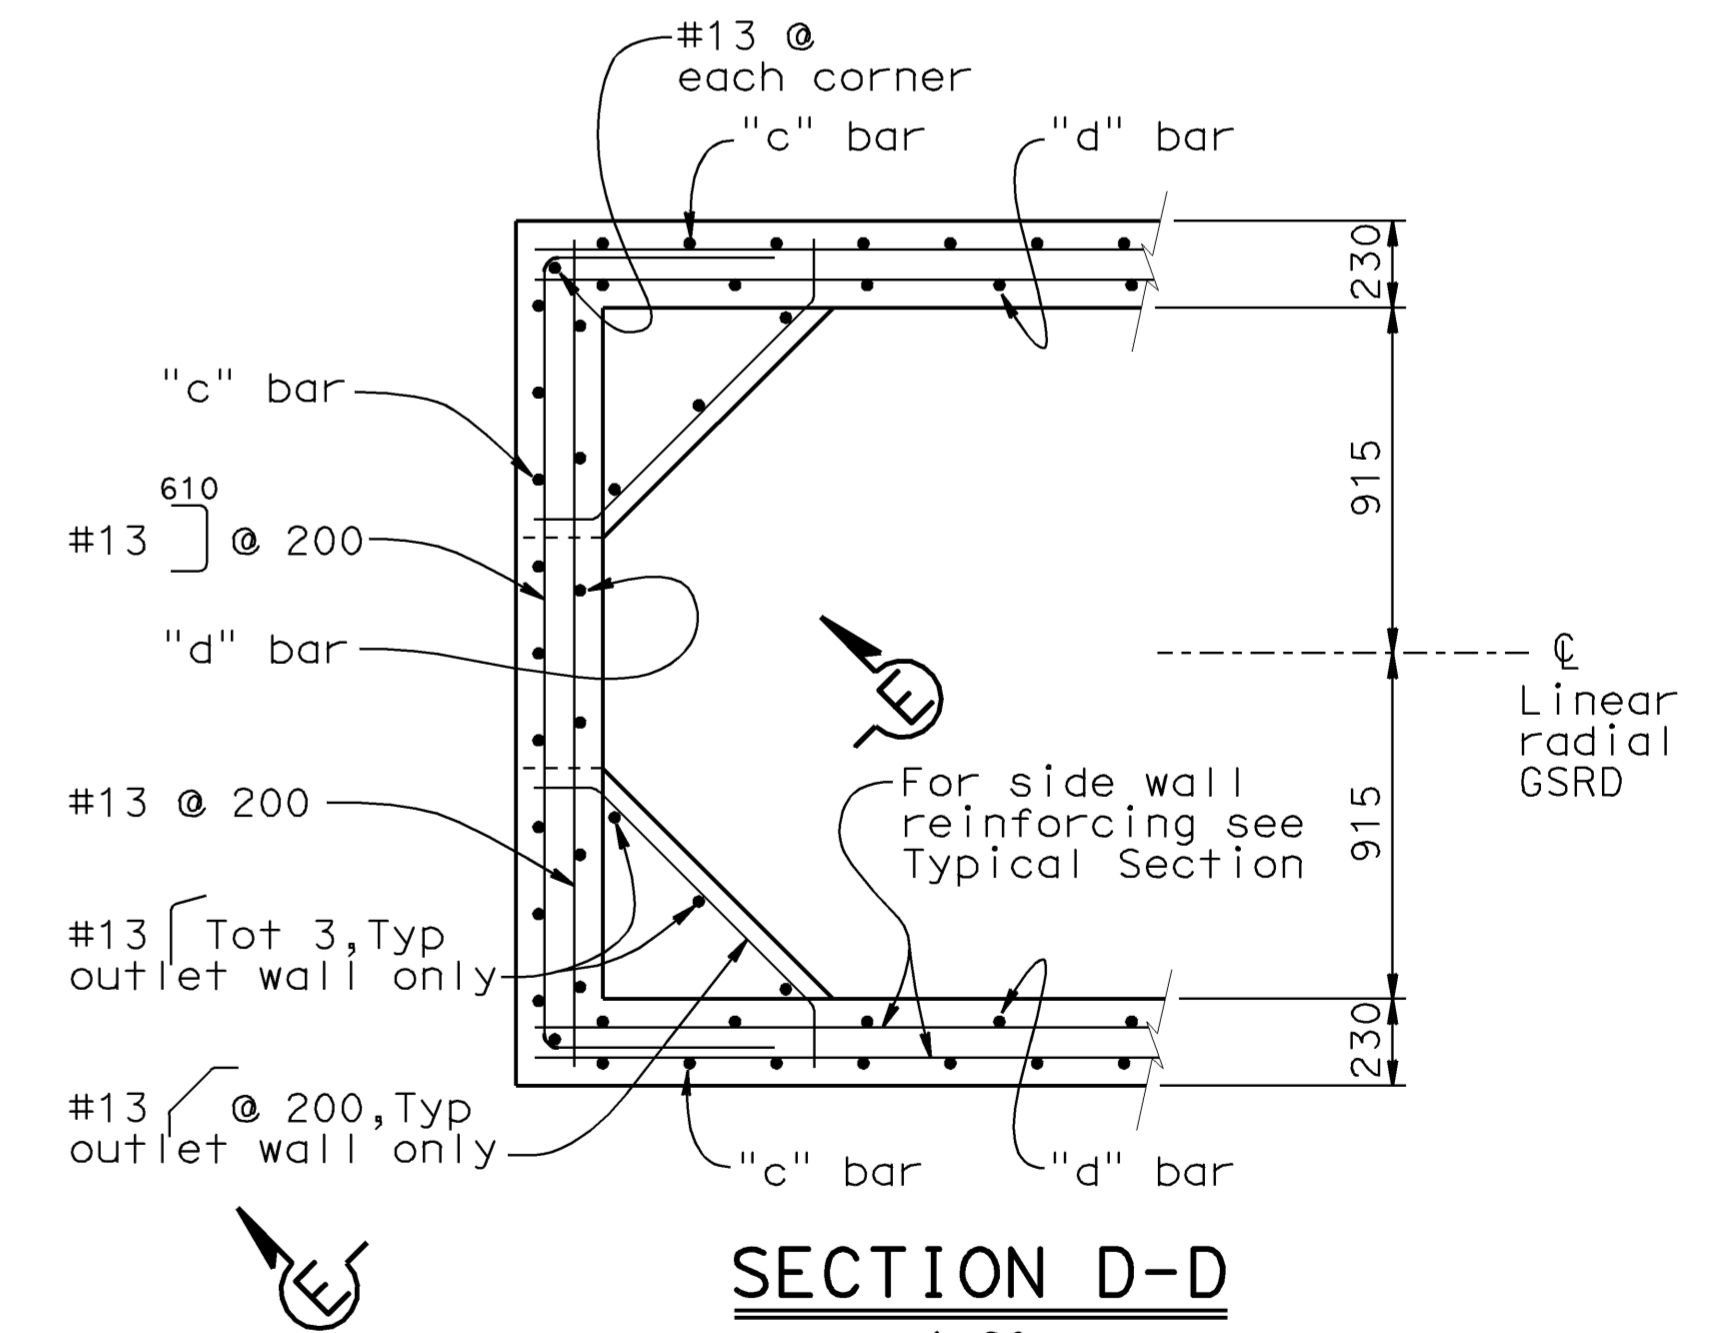

SECTION D-D
1:20

WATER POLLUTION CONTROL DETAILS

WD-14

ALL DIMENSIONS ARE IN MILLIMETERS UNLESS OTHERWISE SHOWN


RELEASE DATE	DESIGN BY	CHECKED
---	D. Dunrud	J&P Peterson
FILE NO.	DETAILS BY	CHECKED
---	J&P Peterson	J&P Peterson
	SUBMITTED BY	DRAWING DATE
	D. Forester	02/07

BRIDGE NO.	GROSS SOLIDS REMOVAL DEVICE
MILE POST	LINEAR RADIAL - DETAILS NO. 1

STATE OF CALIFORNIA
DEPARTMENT OF TRANSPORTATION

DIVISION OF ENGINEERING SERVICES

BRIDGE NO.	GROSS SOLIDS REMOVAL DEVICE
MILE POST	LINEAR RADIAL - DETAILS NO. 1
REVISION DATES (PRELIMINARY STAGE ONLY)	SHEET 3 OF 32

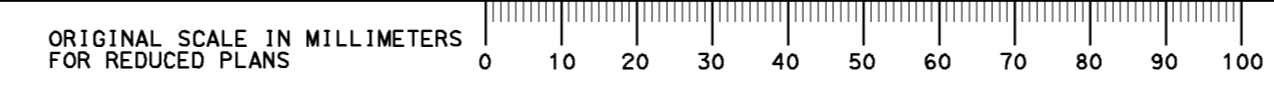

CU 07314
EA 121841

DISREGARD PRINTS BEARING EARLIER REVISION DATES

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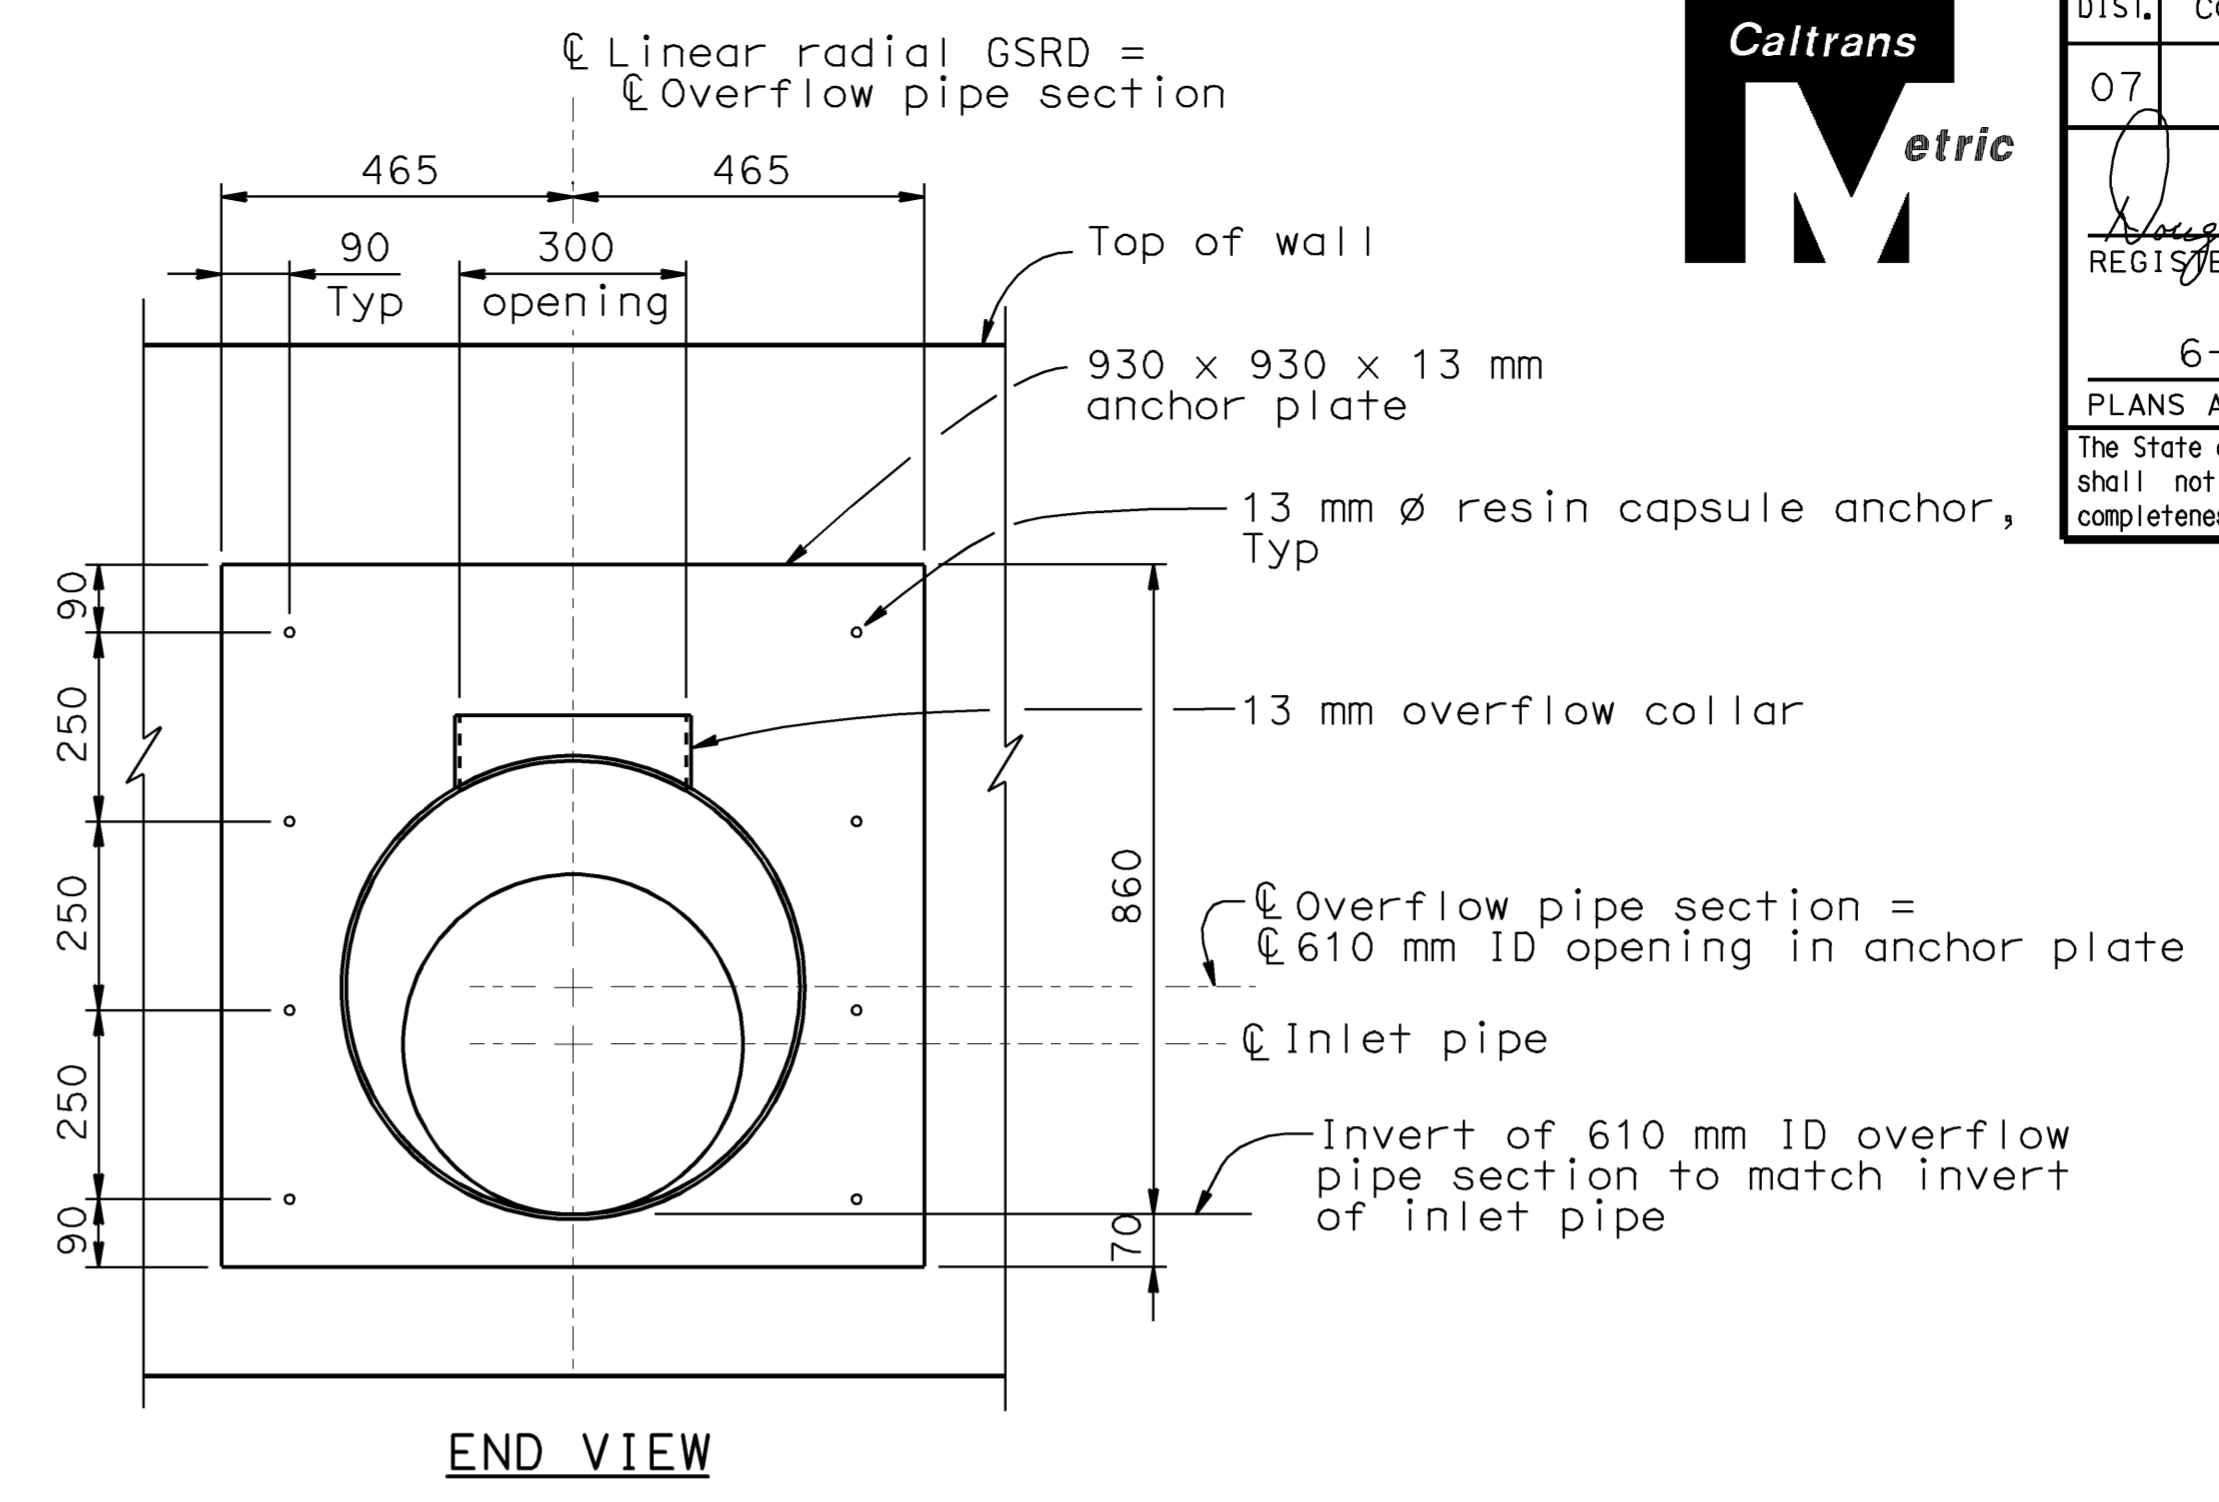
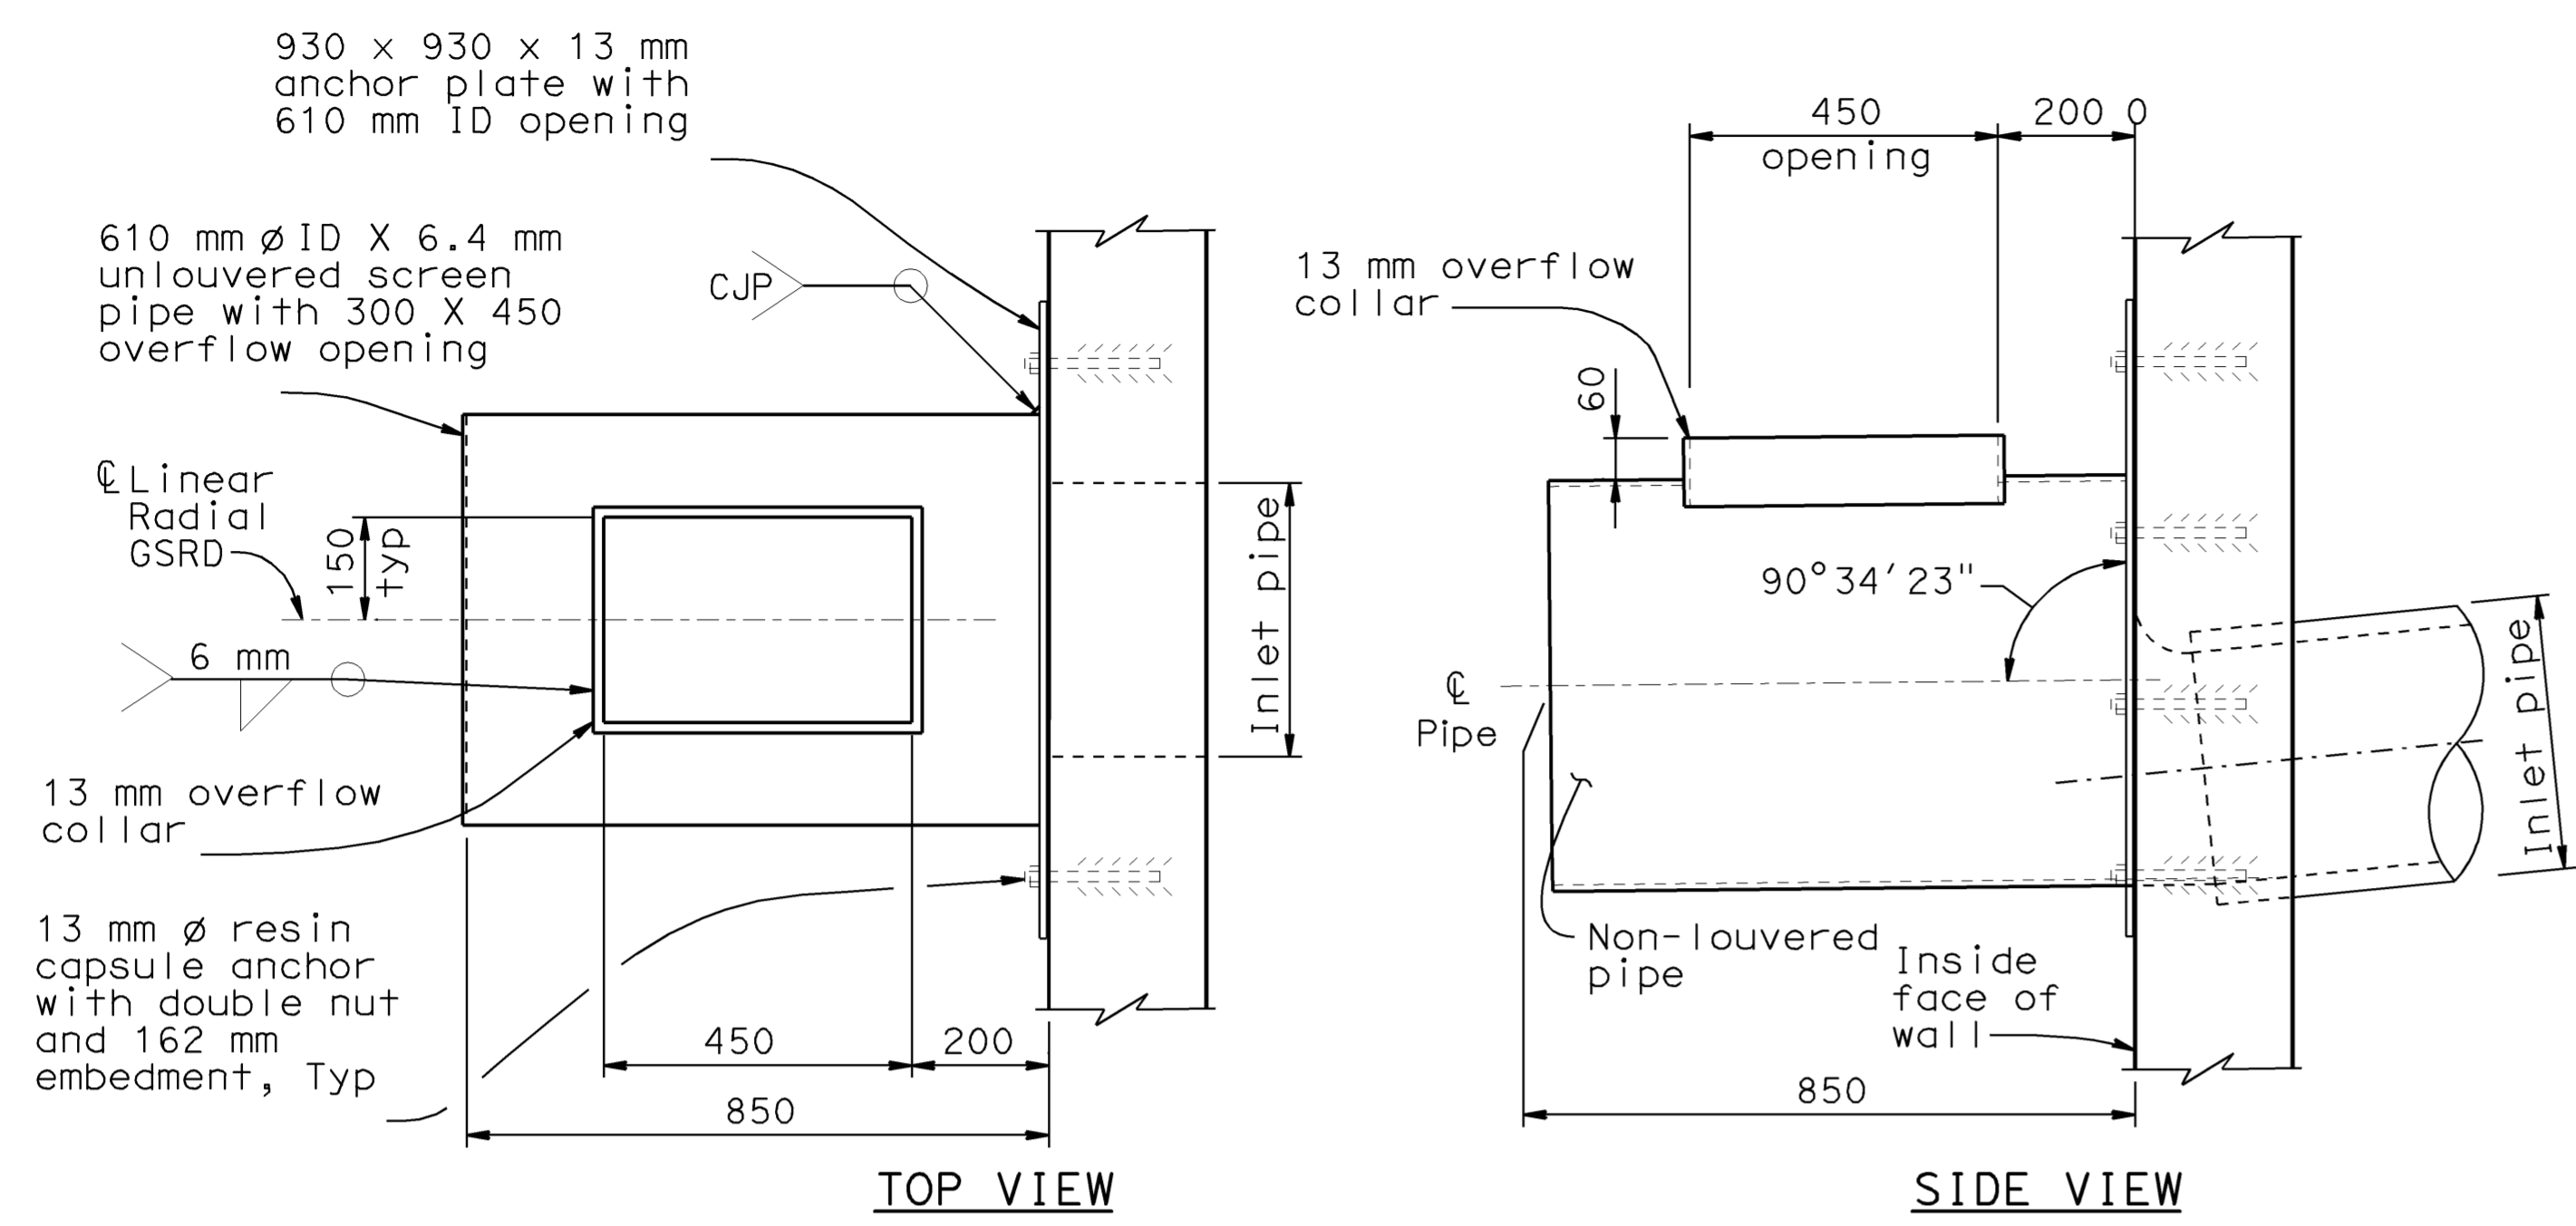
DATE PLOTTED => 12-JUN-2009 TIME PLOTTED => 08:16



DIST.	COUNTY	ROUTE	MILE POST TOTAL PROJECT	SHEET NO.	TOTAL SHEETS
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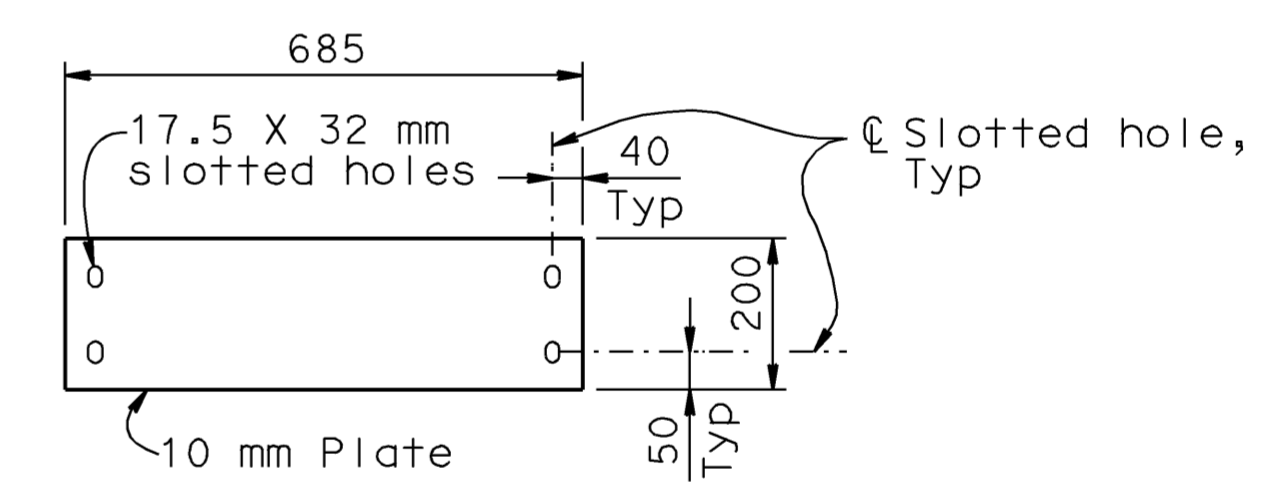
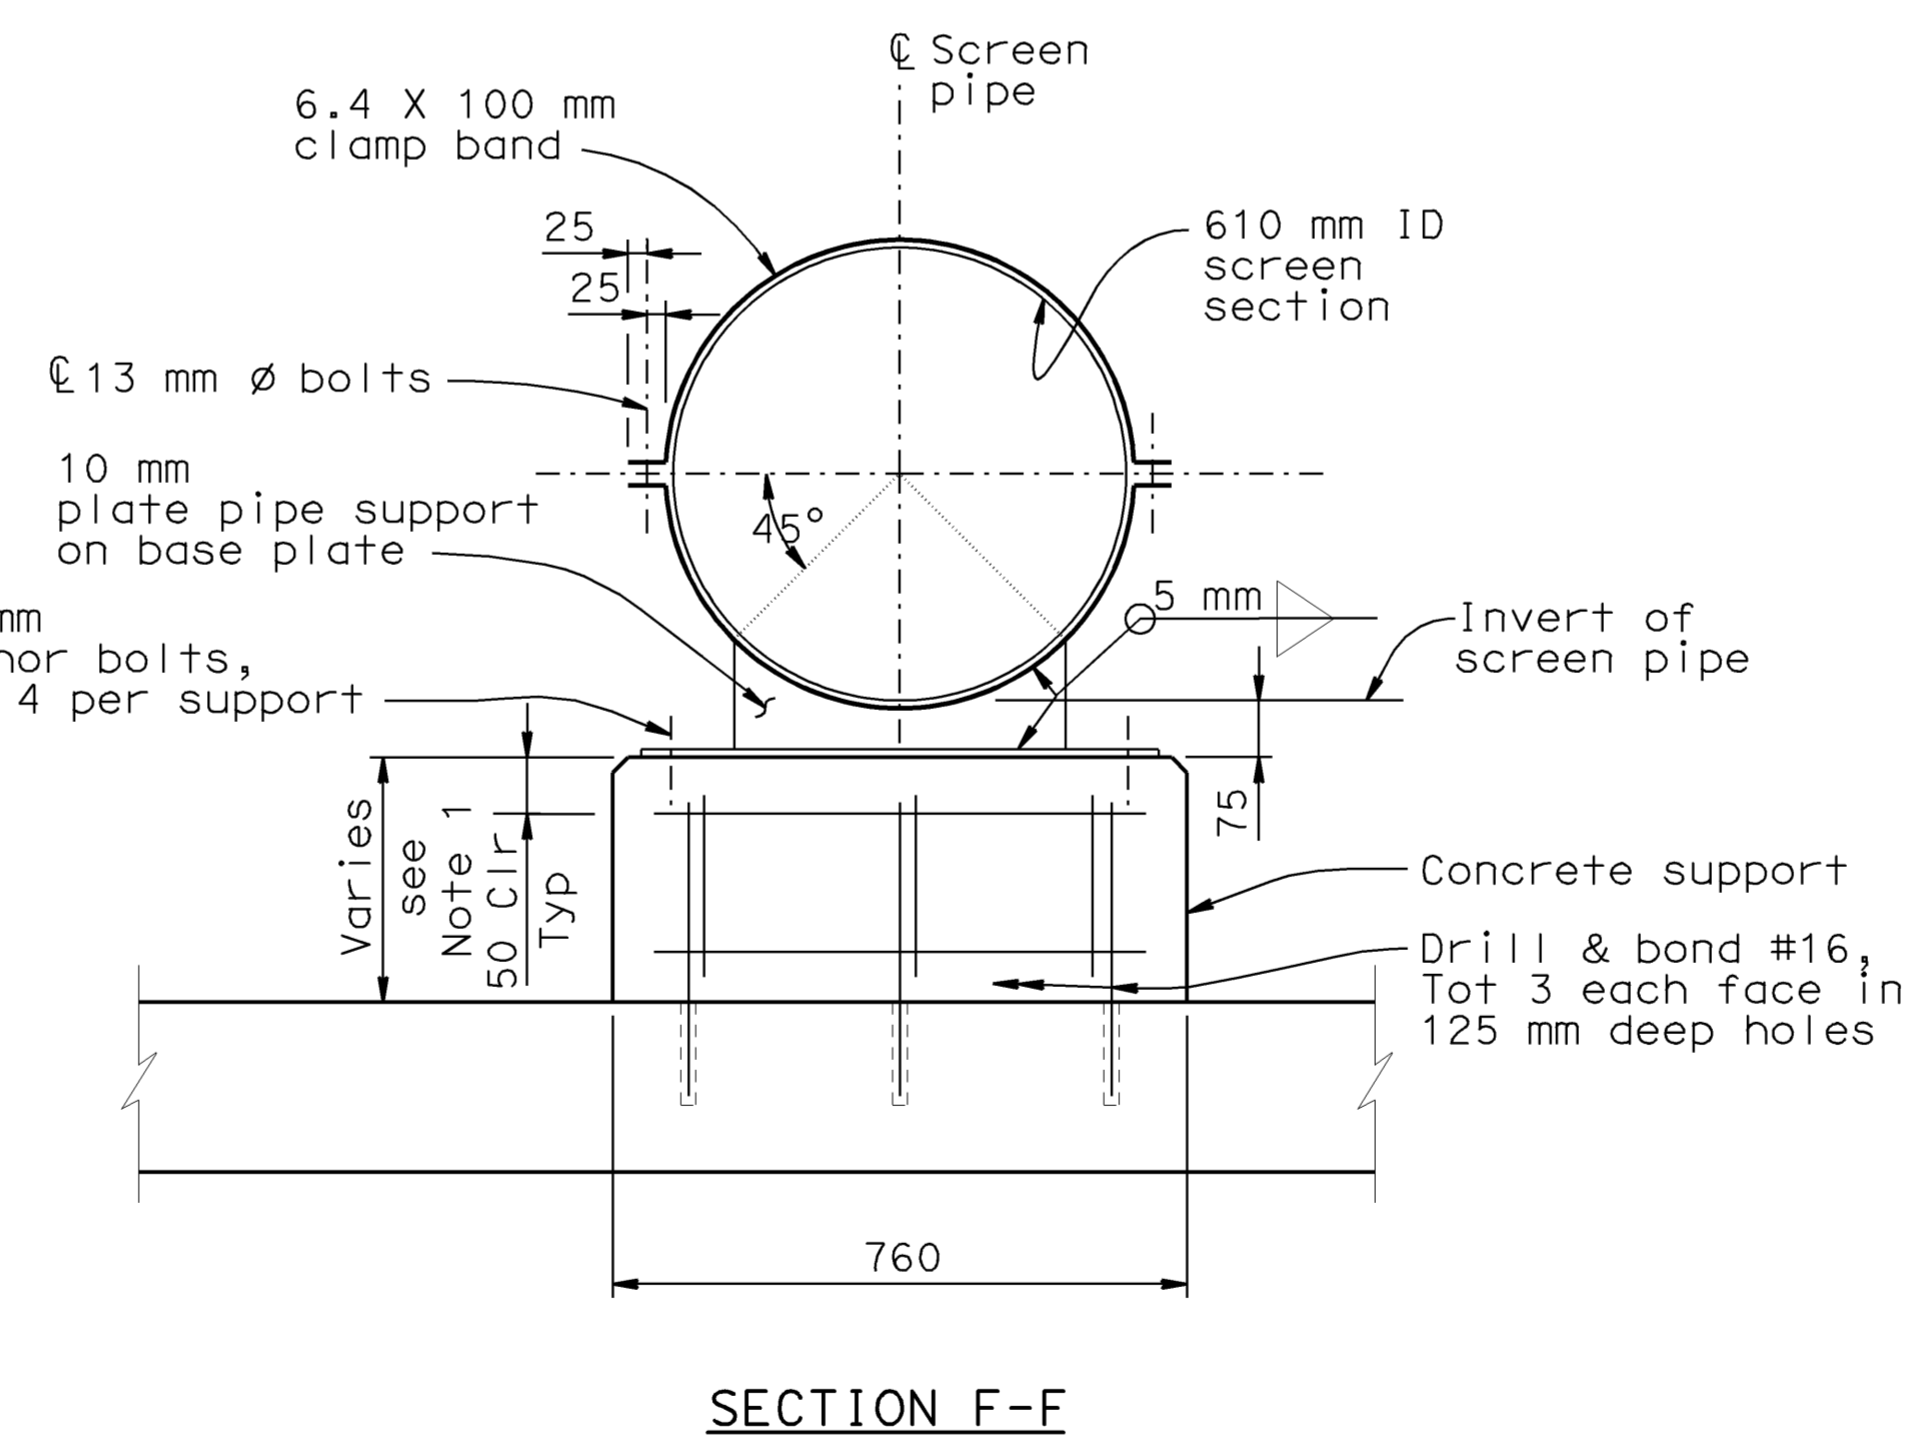
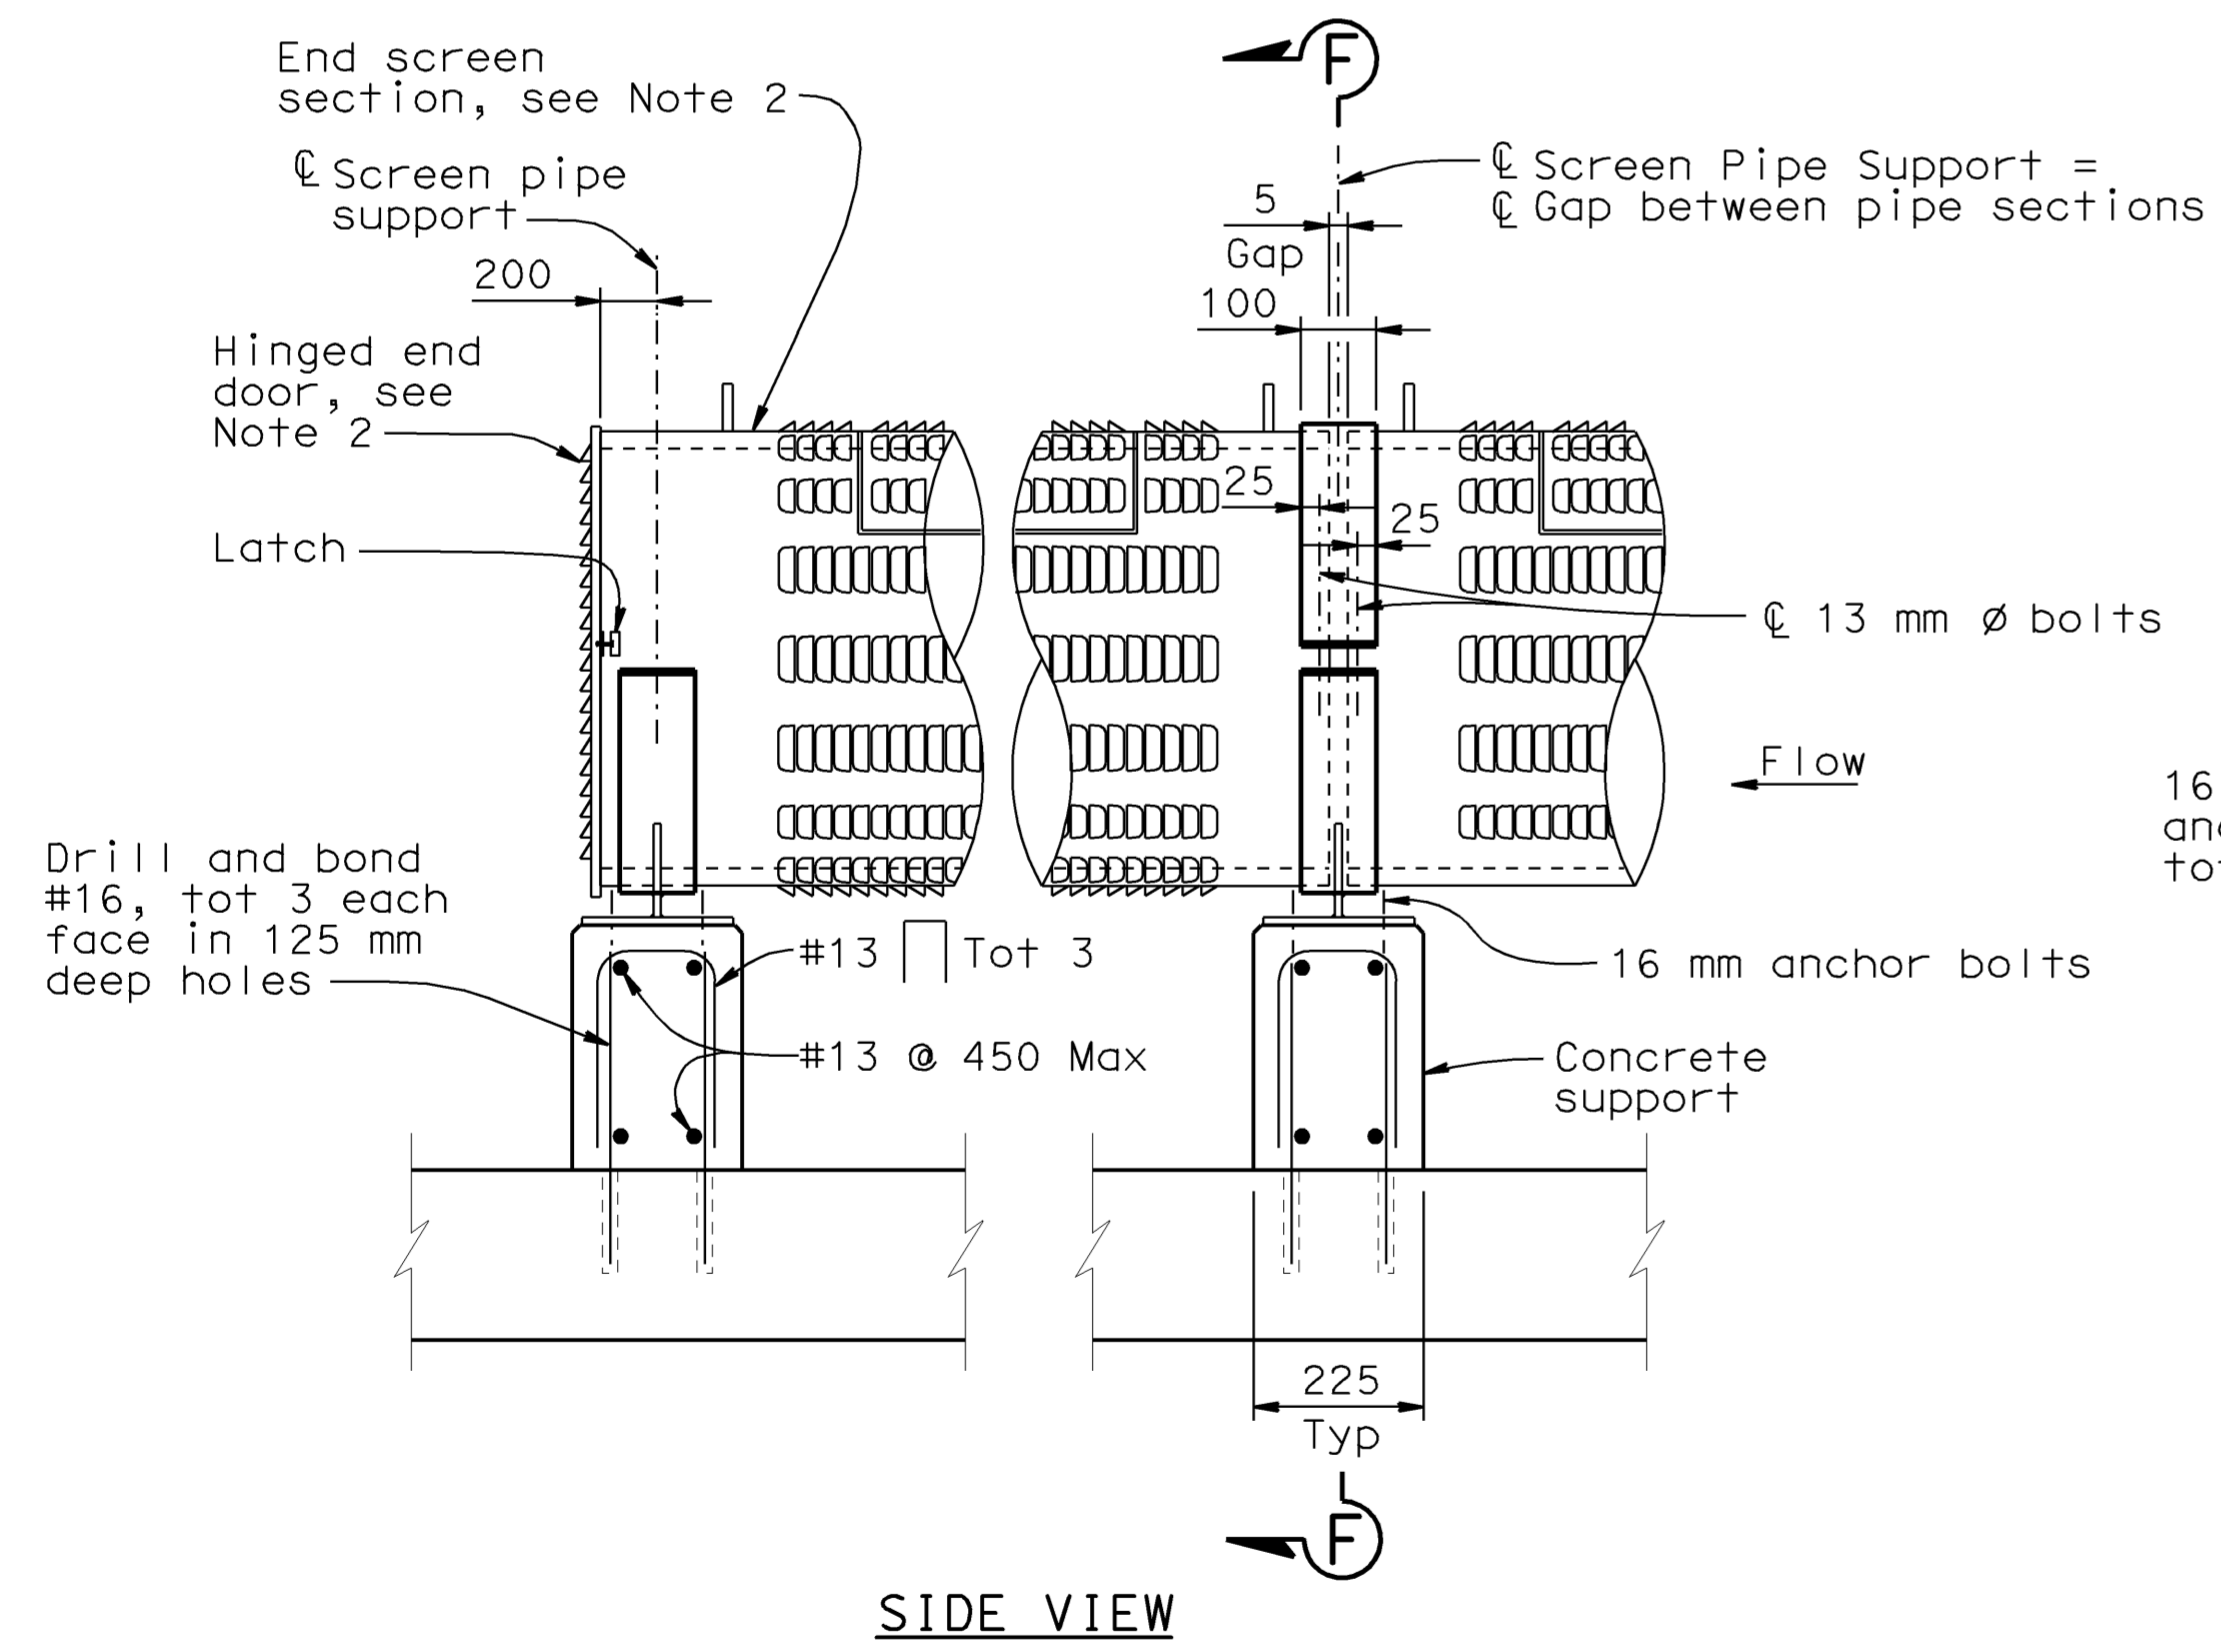
REGISTERED PROFESSIONAL ENGINEER
 DOUGLAS DUNRUD
 No. 47240
 Exp. 12/31/09
 CIVIL
 STATE OF CALIFORNIA

6-8-09
 PLANS APPROVAL DATE
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OVERFLOW PIPE SECTION DETAILS

1:10



BASE PLATE DETAIL

- NOTES:
1. If inlet invert height above floor is at the minimum 75 mm height, use anchor bolts to mount the pipe support base plate to the floor. Otherwise, construct concrete support as shown.
 2. For End Screen and Intermediate Screen pipe details, see "Linear Radial - Details No. 3" sheet.
 3. All metal components of screen pipe including connections to concrete shall be stainless steel.

SCREEN PIPE SUPPORT

1:10

WATER POLLUTION CONTROL DETAILS

WD-15


ALL DIMENSIONS ARE IN MILLIMETERS UNLESS OTHERWISE SHOWN

RELEASE DATE	DESIGN BY	BY	CHECKED
---	D. Dunrud	D. Dunrud	J&P Peterson
FILE NO.	DETAILS BY	BY	CHECKED
---	J&P Peterson	J&P Peterson	J&P Peterson
	SUBMITTED BY	BY	DRAWING DATE
	D. Forester	D. Forester	02/07

BRIDGE NO.	GROSS SOLIDS REMOVAL DEVICE
MILE POST	LINEAR RADIAL - DETAILS NO. 2

STATE OF CALIFORNIA	DIVISION OF ENGINEERING SERVICES
DEPARTMENT OF TRANSPORTATION	

CU 07314	DISREGARD PRINTS BEARING EARLIER REVISION DATES	REVISION DATES (PRELIMINARY STAGE ONLY)	SHEET 4	OF 32
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CU 07314
EA 121841
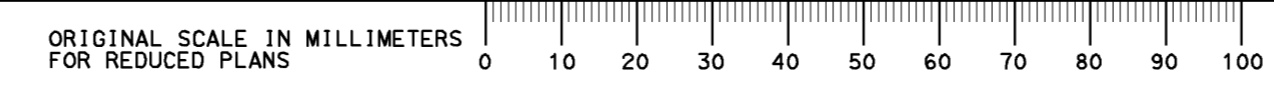
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DGN FILE => 7121841h015.dgn


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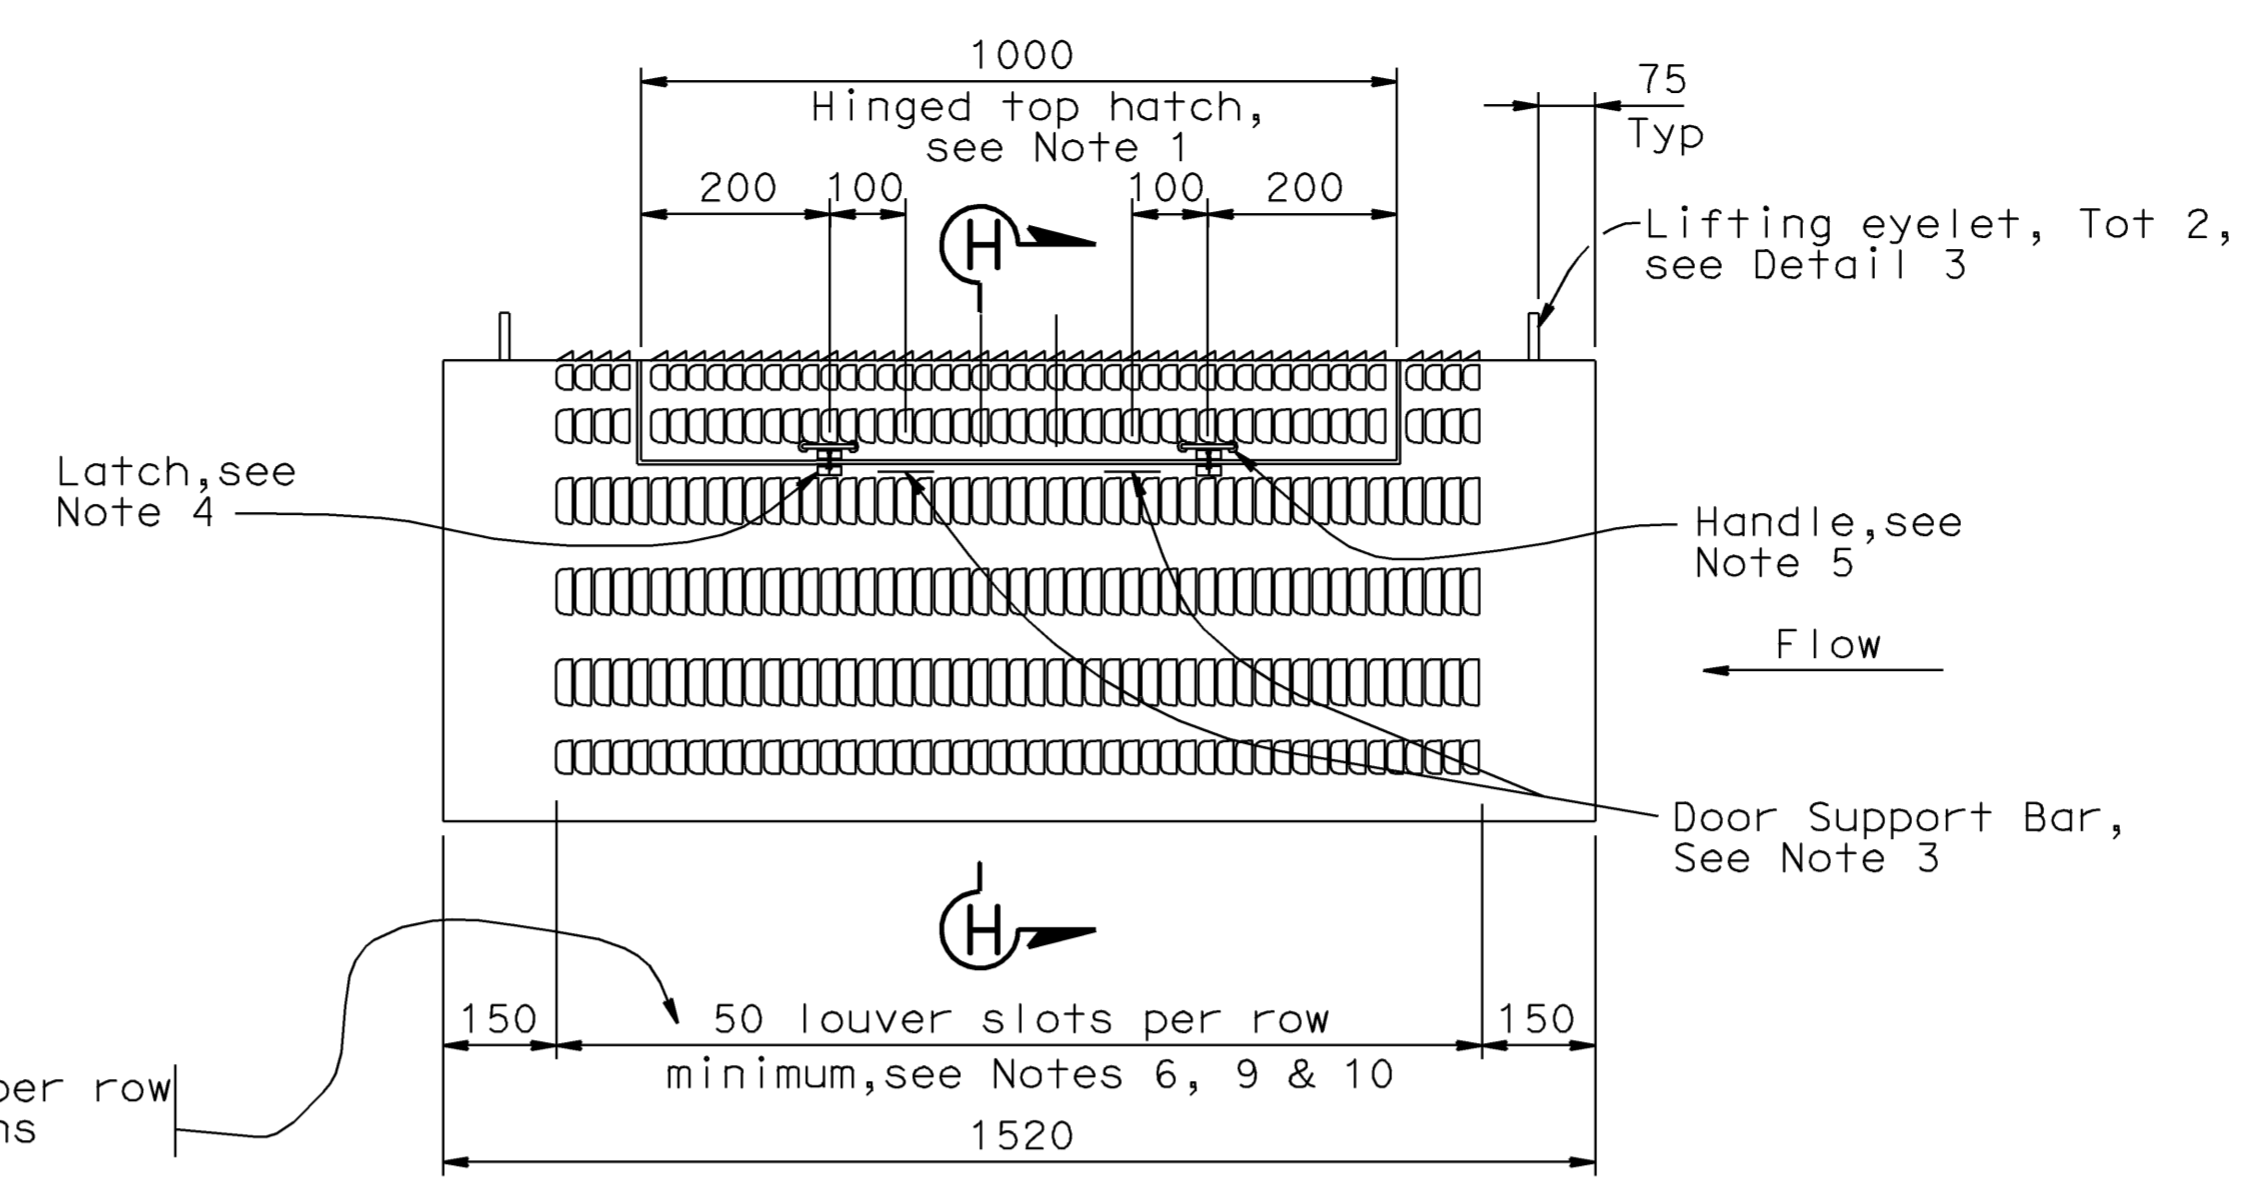
DIST.	COUNTY	ROUTE	MILE POST TOTAL PROJECT	SHEET NO.	TOTAL SHEETS
07	LA	5	42.8/47.3	91	1073

REGISTERED ENGINEER - CIVIL
 DOUGLAS DUNRUD
 No. 47240
 Exp. 12/31/09
 CIVIL
 STATE OF CALIFORNIA

PLANS APPROVAL DATE: 6-8-09
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END SCREEN DETAIL
1:10




INTERMEDIATE SCREEN DETAIL
1:10

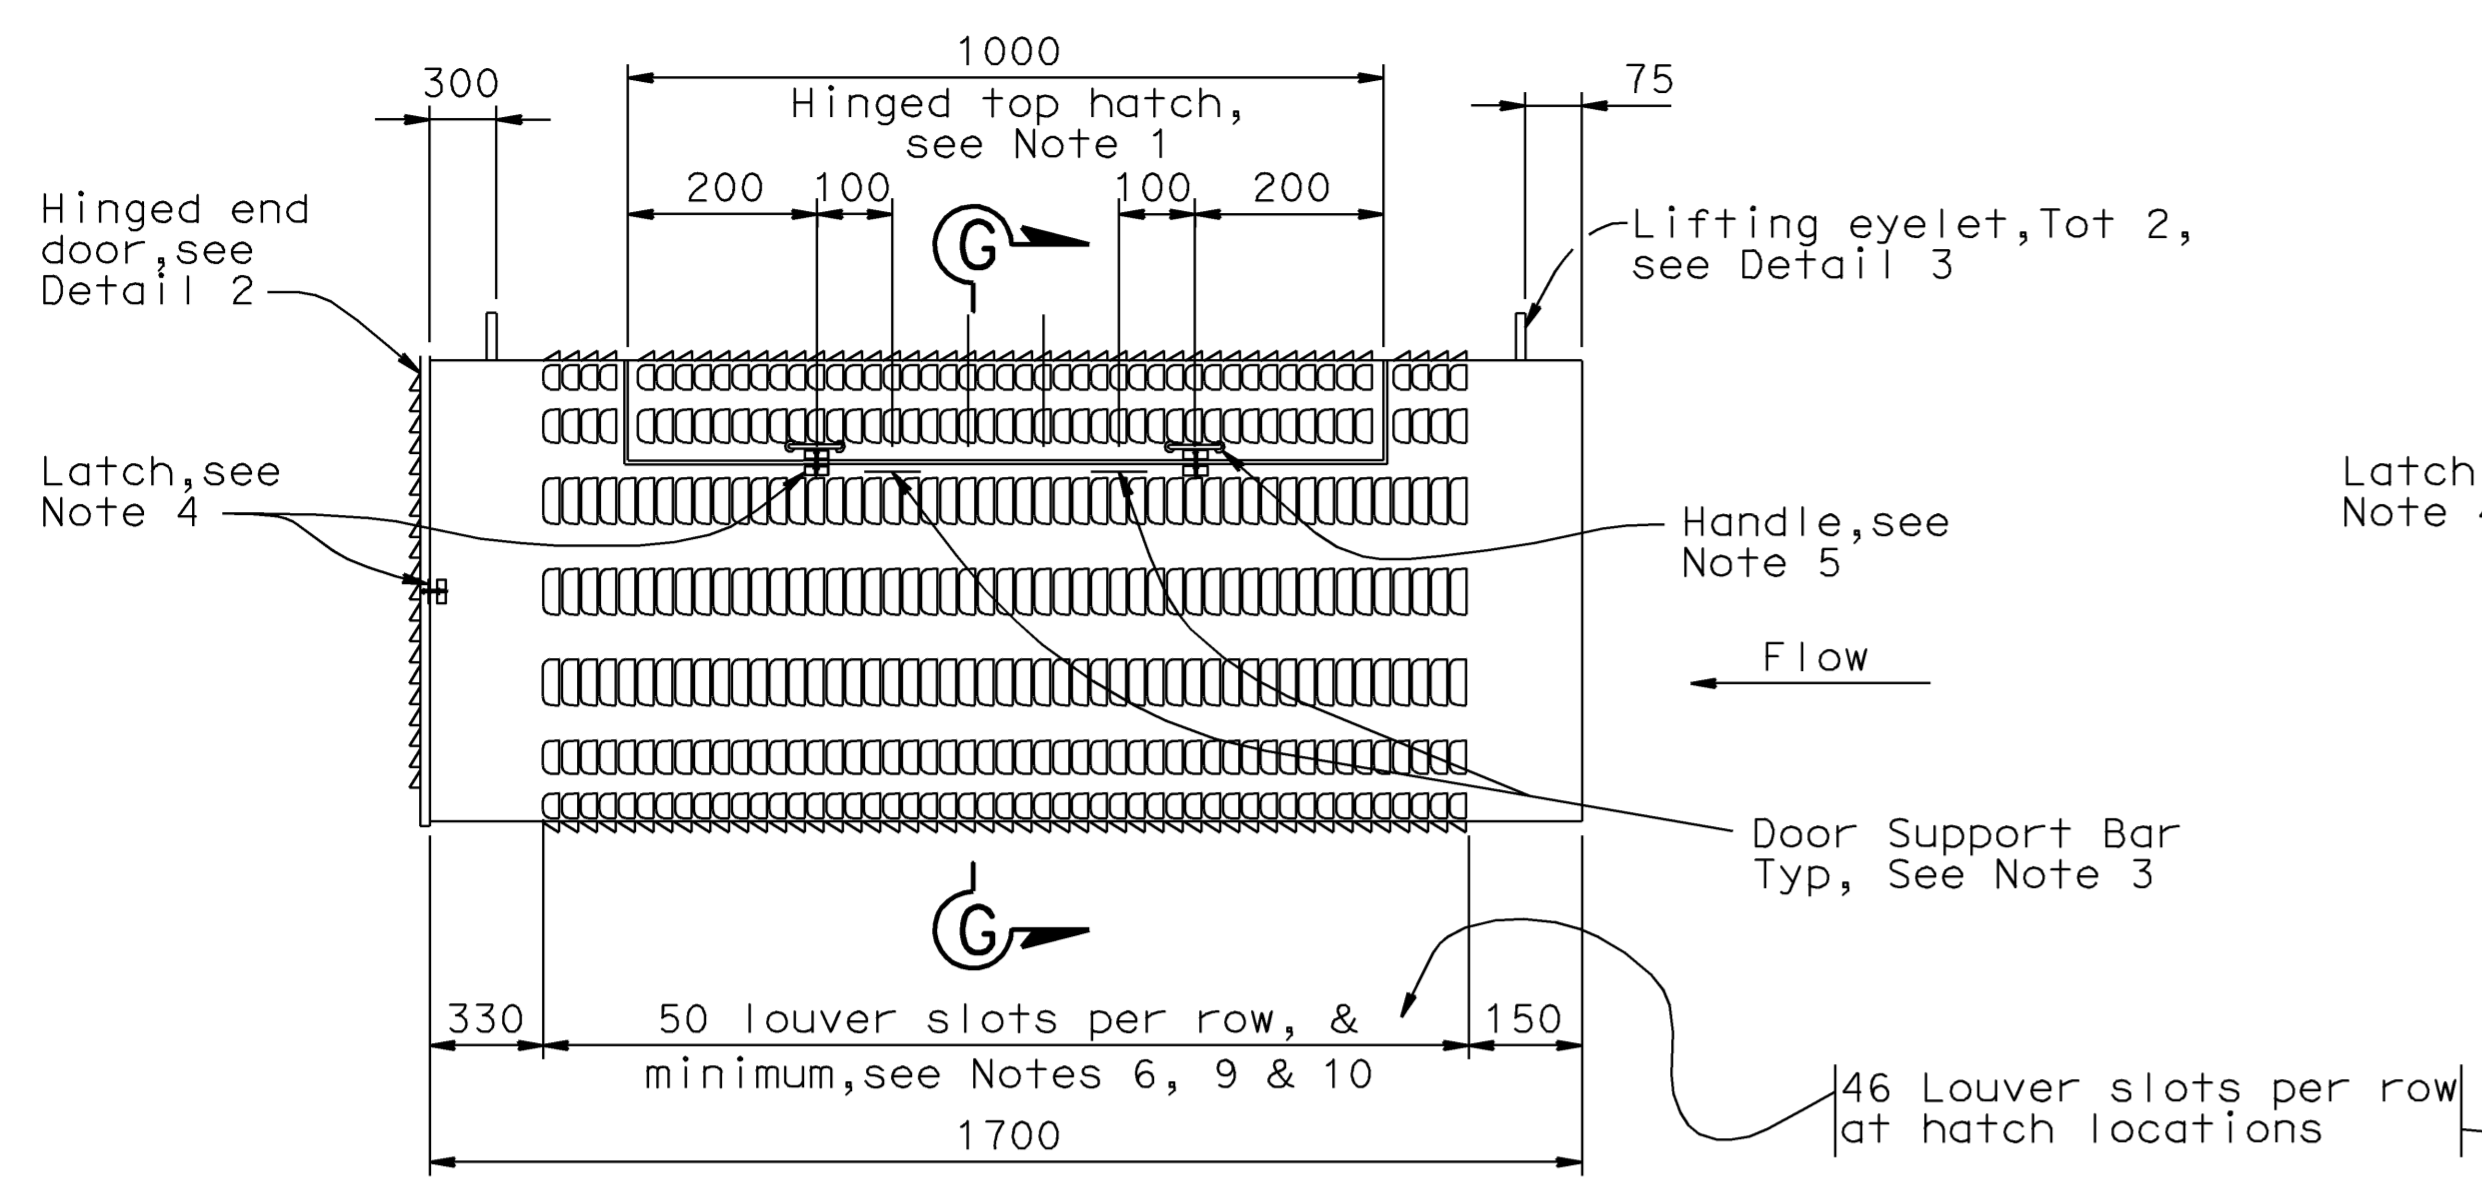NOTES:

- Provide 25 x 5 mm stainless steel bar at all cut edges to provide a seat and support for all doors when closed.
- Provide stainless steel 6.4 mm thick heavy duty hinges 101x101 mm thick with 15.8 mm Dia pin. Use fillet weld at cover and frame. Total two each door, evenly spaced.
- Attach 2-25 x 25 x 75 mm stainless steel bars (or fabricator equivalent design) to support doors when in an open position. Mechanical Stops can be welded on hinges.
- Provide latch. Latch shall have threaded U-bolt for adjustment. Latch to have 10 mm total adjustability and 30 mm drawing movement and be rated at 163 KG.
- Provide stainless steel handles at locations indicated.
- The aperture size of each louver slot shall be 5.1 mm wide X 63.5 mm long.
- End door to secured to end screen with 10mm Dia x 250 mm continuous bolt with lock nut through flat bars.
- All metal components of screen pipe shall be stainless steel.
- Louver slot apertures shall meet the following requirements:


Width (mm)	% of Total
4.8-5.3	90
4.6-5.3	95
4.3-5.3	100

Length (mm)	% of Total
57-70	90
50-75	100
- A Certificate of Compliance conforming to the provisions in Section 6-1.07, "Certificate of Compliance," shall be furnished to Engineer, prior to installing Linear Radial GSRD device, certifying that louver slot apertures being furnished conforms to above requirements

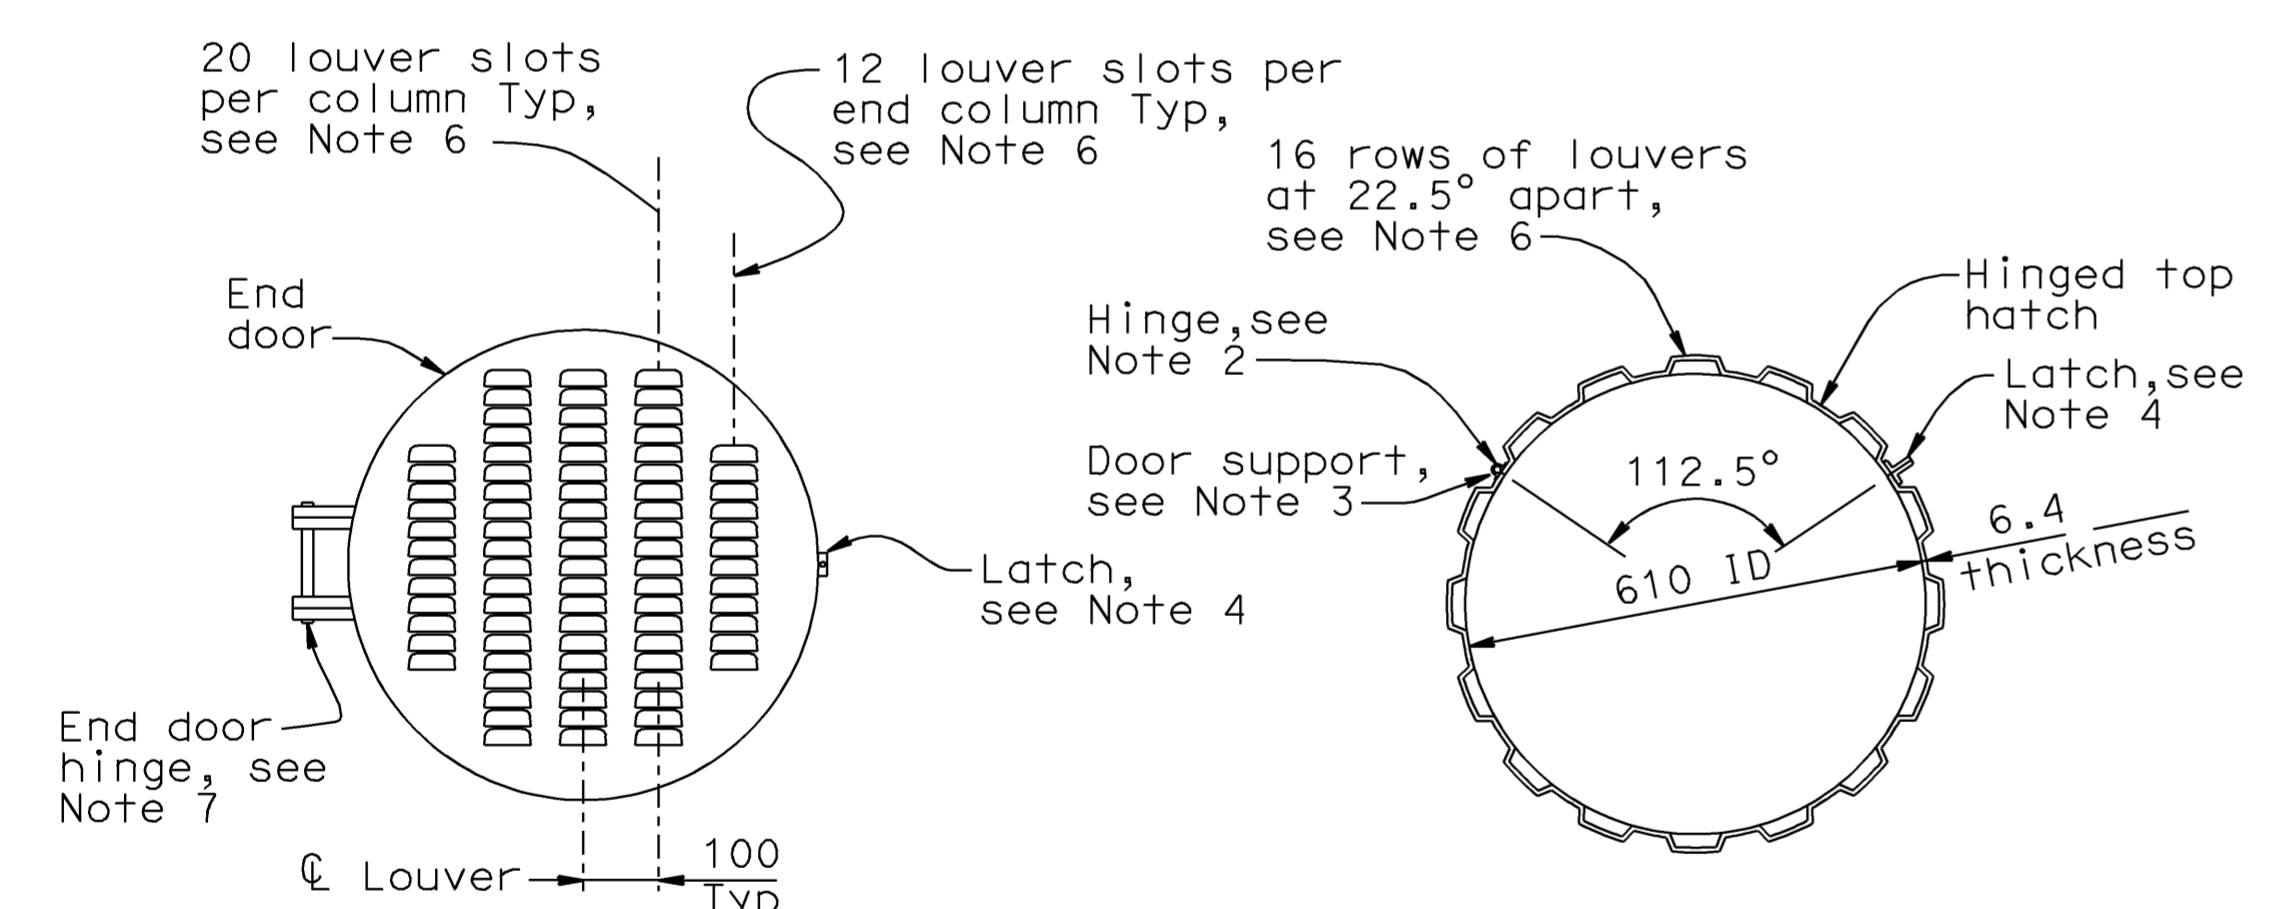


DETAIL 2
1:10

SECTION G-G
1:10

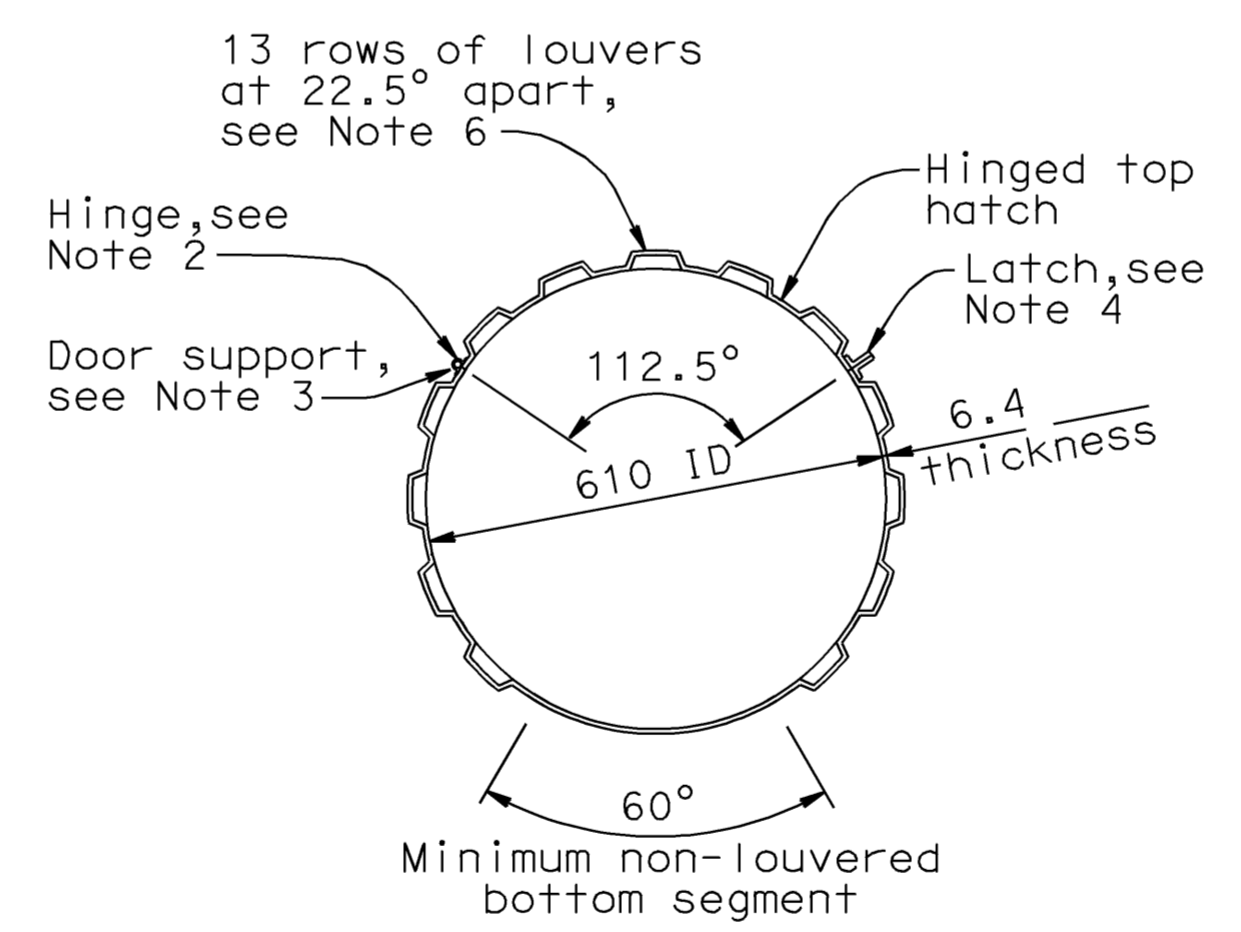

SECTION H-H
1:10

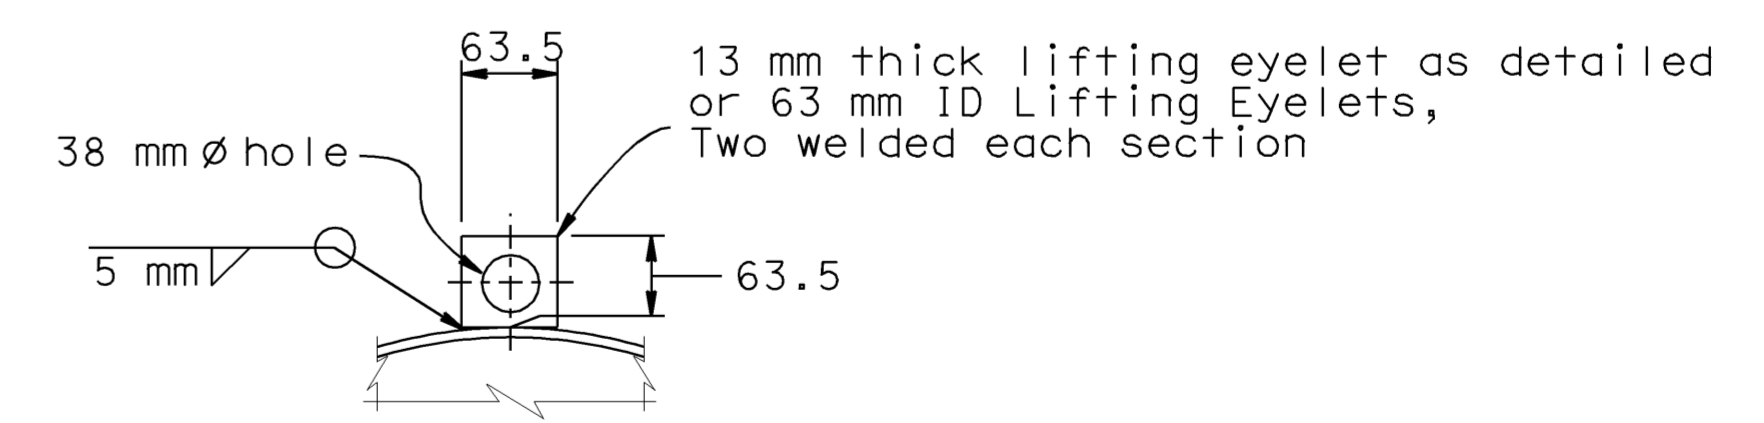

DETAIL 3
1:10

ALL DIMENSIONS ARE IN MILLIMETERS UNLESS OTHERWISE SHOWN

WATER POLLUTION CONTROL DETAILS
WD-16

RELEASE DATE ---	DESIGN BY <i>D. Dunrud</i>	CHECKED <i>J&P Peterson</i>	BRIDGE NO.	GROSS SOLIDS REMOVAL DEVICE
FILE NO. ---	DETAILS BY <i>J&P Peterson</i>	CHECKED <i>J&P Peterson</i>	MILE POST	
	SUBMITTED BY <i>D. Forester</i>	DRAWING DATE <i>02/07</i>		

STATE OF CALIFORNIA
DEPARTMENT OF TRANSPORTATION

DIVISION OF ENGINEERING SERVICES

CU 07314
EA 121841

DISREGARD PRINTS BEARING EARLIER REVISION DATES

REVISION DATES (PRELIMINARY STAGE ONLY)

SHEET	OF
5	32

DATE PLOTTED => 12-JUN-2009

ORIGINAL SCALE IN MILLIMETERS FOR REDUCED PLANS


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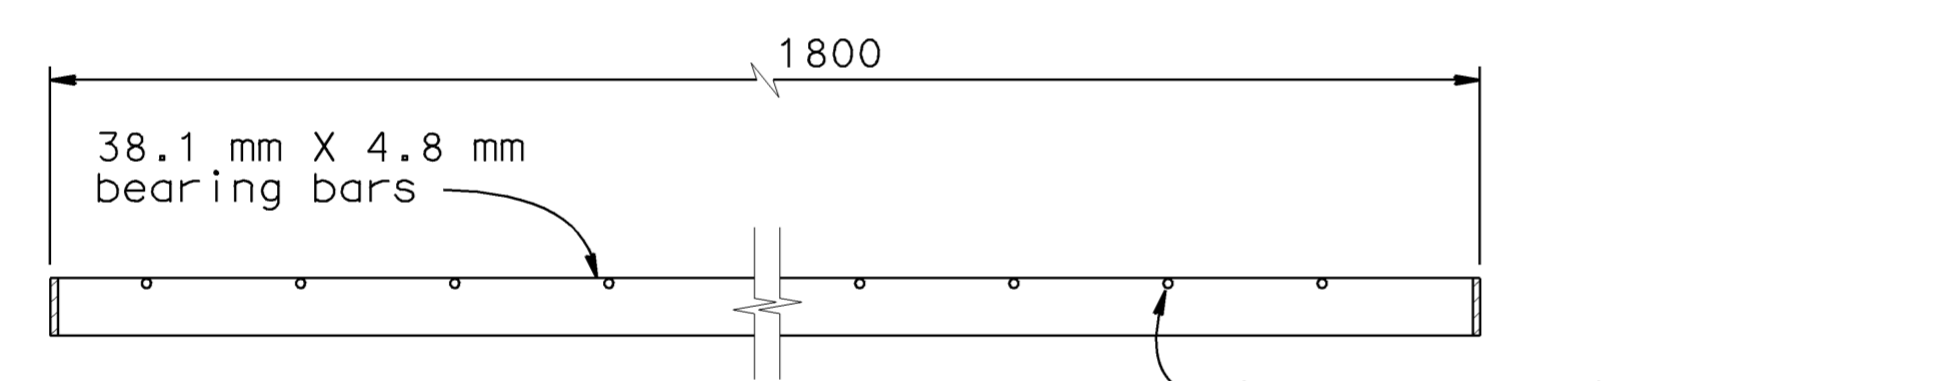
DIST.	COUNTY	ROUTE	MILE POST TOTAL PROJECT	SHEET NO.	TOTAL SHEETS
07	LA	5	42.8/47.3	92	1073

Douglas Dunrud
 REGISTERED ENGINEER - CIVIL
 6-8-09
 PLANS APPROVAL DATE
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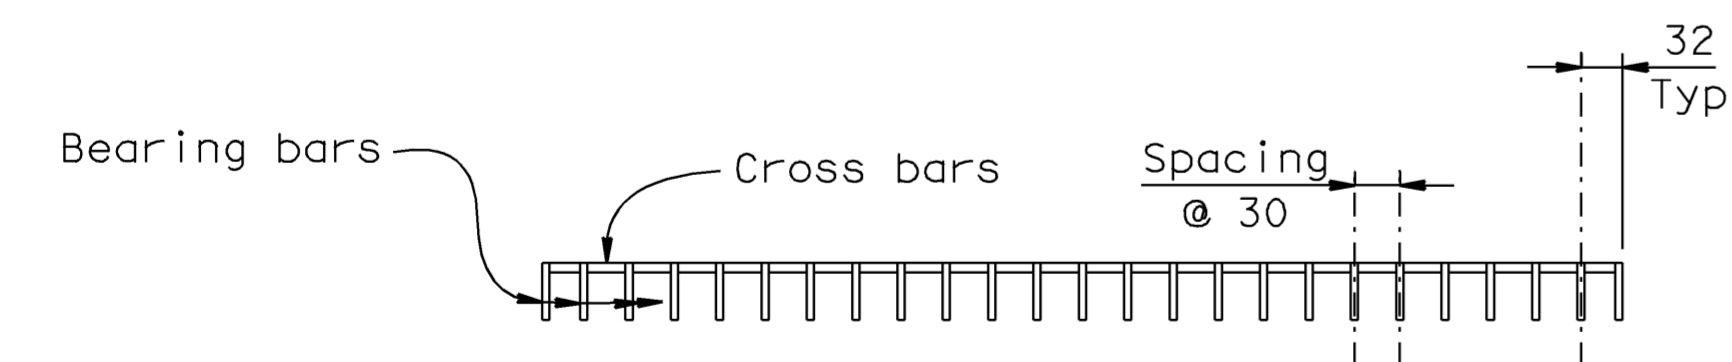
REGISTERED PROFESSIONAL ENGINEER
 DOUGLAS DUNRUD
 No. 47240
 Exp. 12/31/09
 CIVIL
 STATE OF CALIFORNIA



GRATE PANEL
1:5

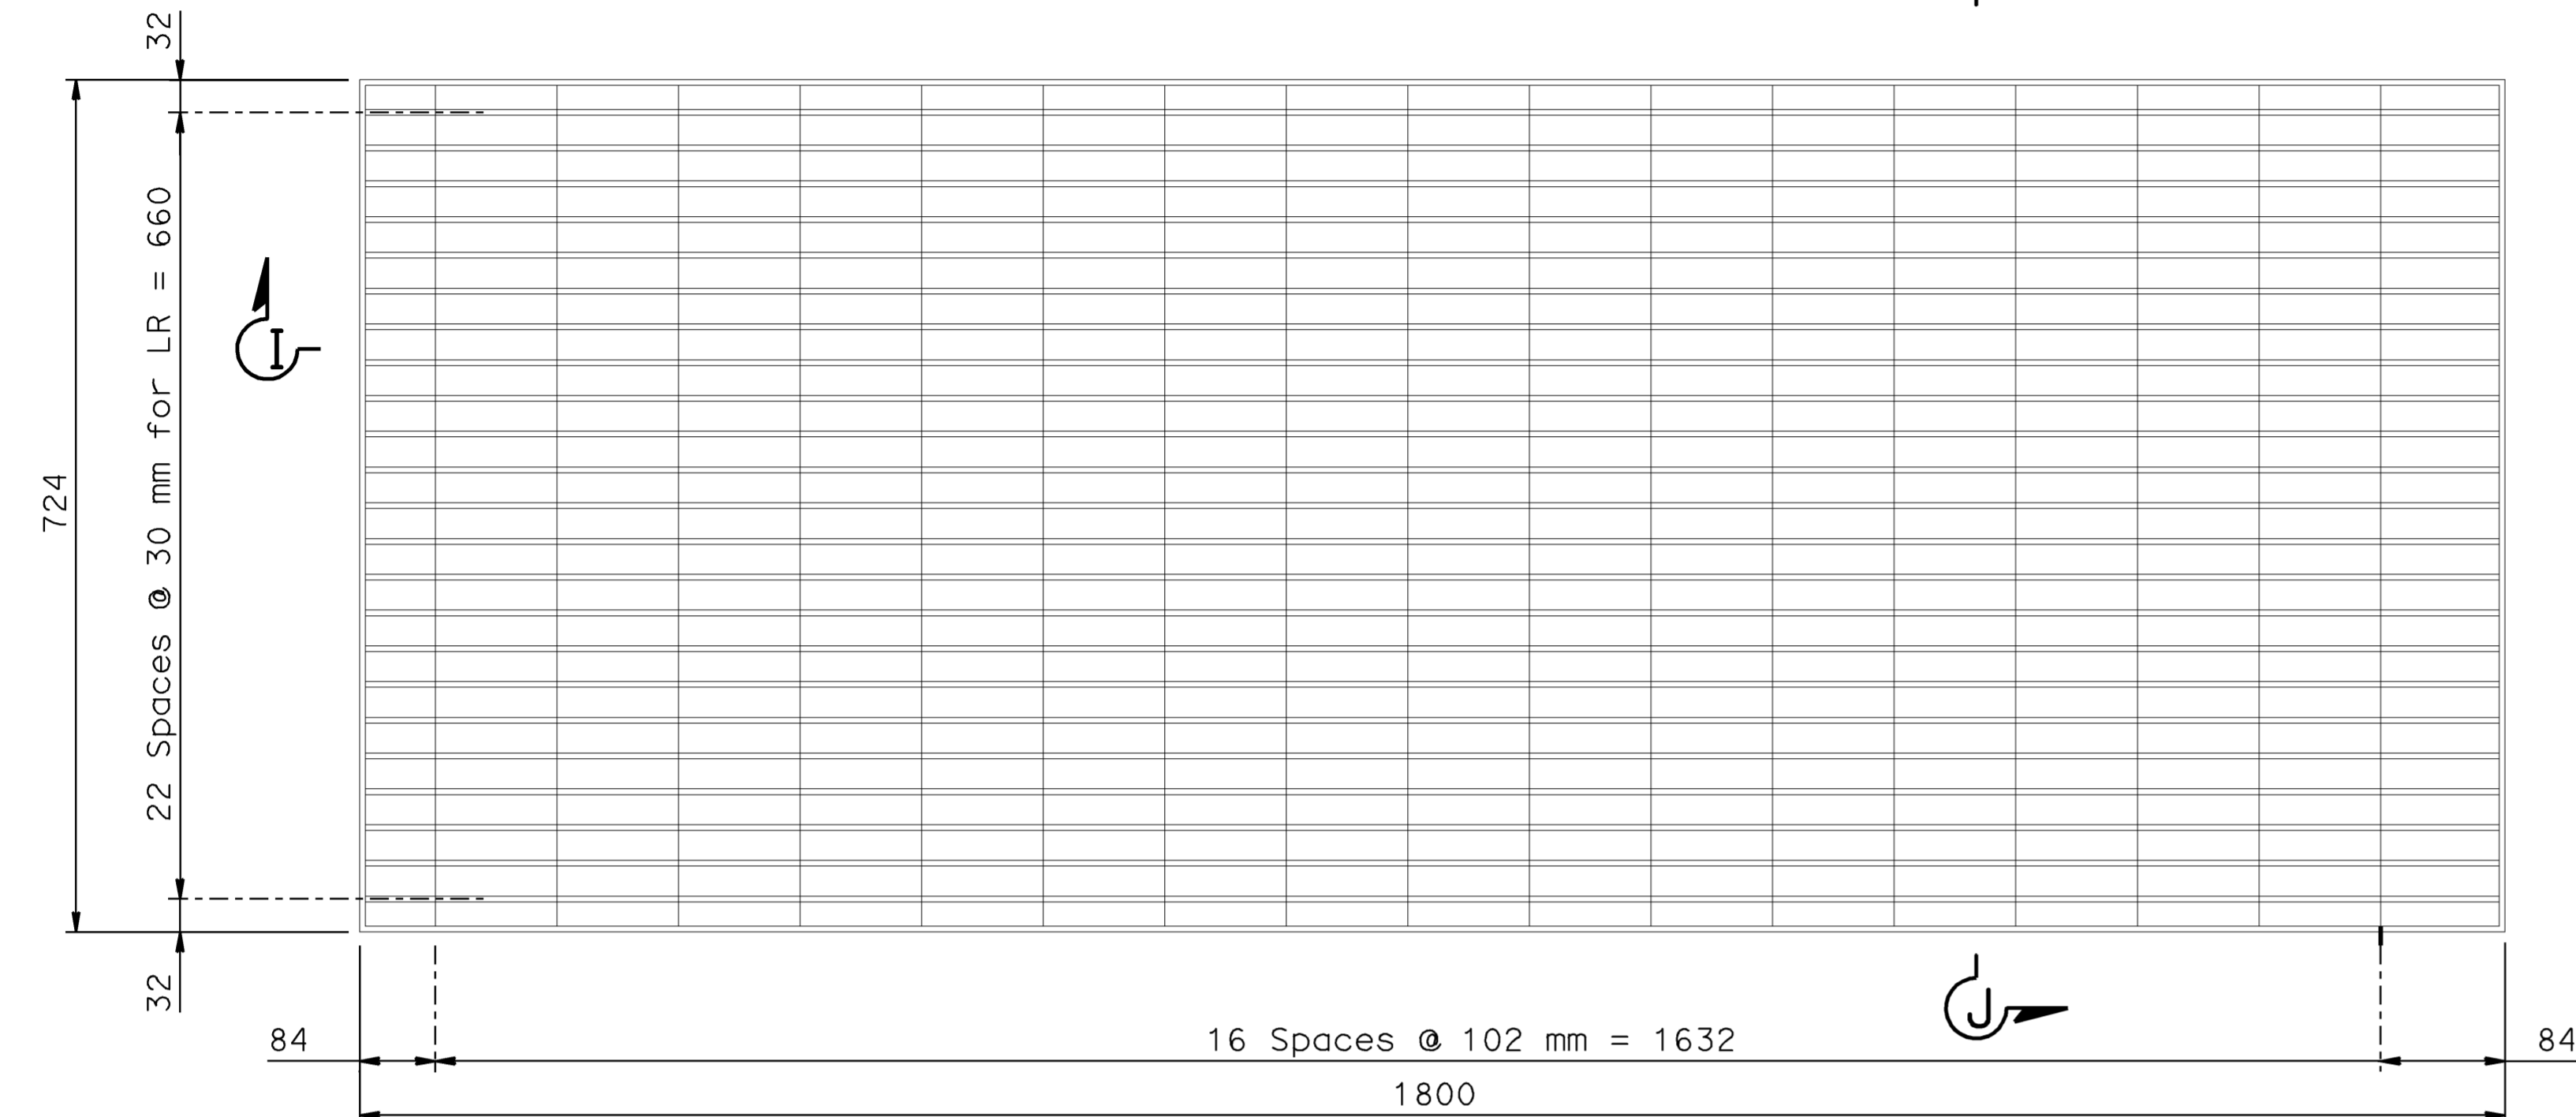


SECTION I-I
1:5



SECTION J-J
1:5

- NOTES:
1. For Linear Radial dimension "L" and total number of grate panels, see Quantity Summary Table on "Linear Radial - Quantities" sheet.
 2. For Linear Radial (HV) dimension "L" and total number of grate panels, see Quantity Summary Table (HV) on "Linear Radial (HV) - Quantities" sheet.
 3. Gap between grate panels shall be equal, 22 Min, 40 Max.
 4. All metal components of grating shall be galvanized.

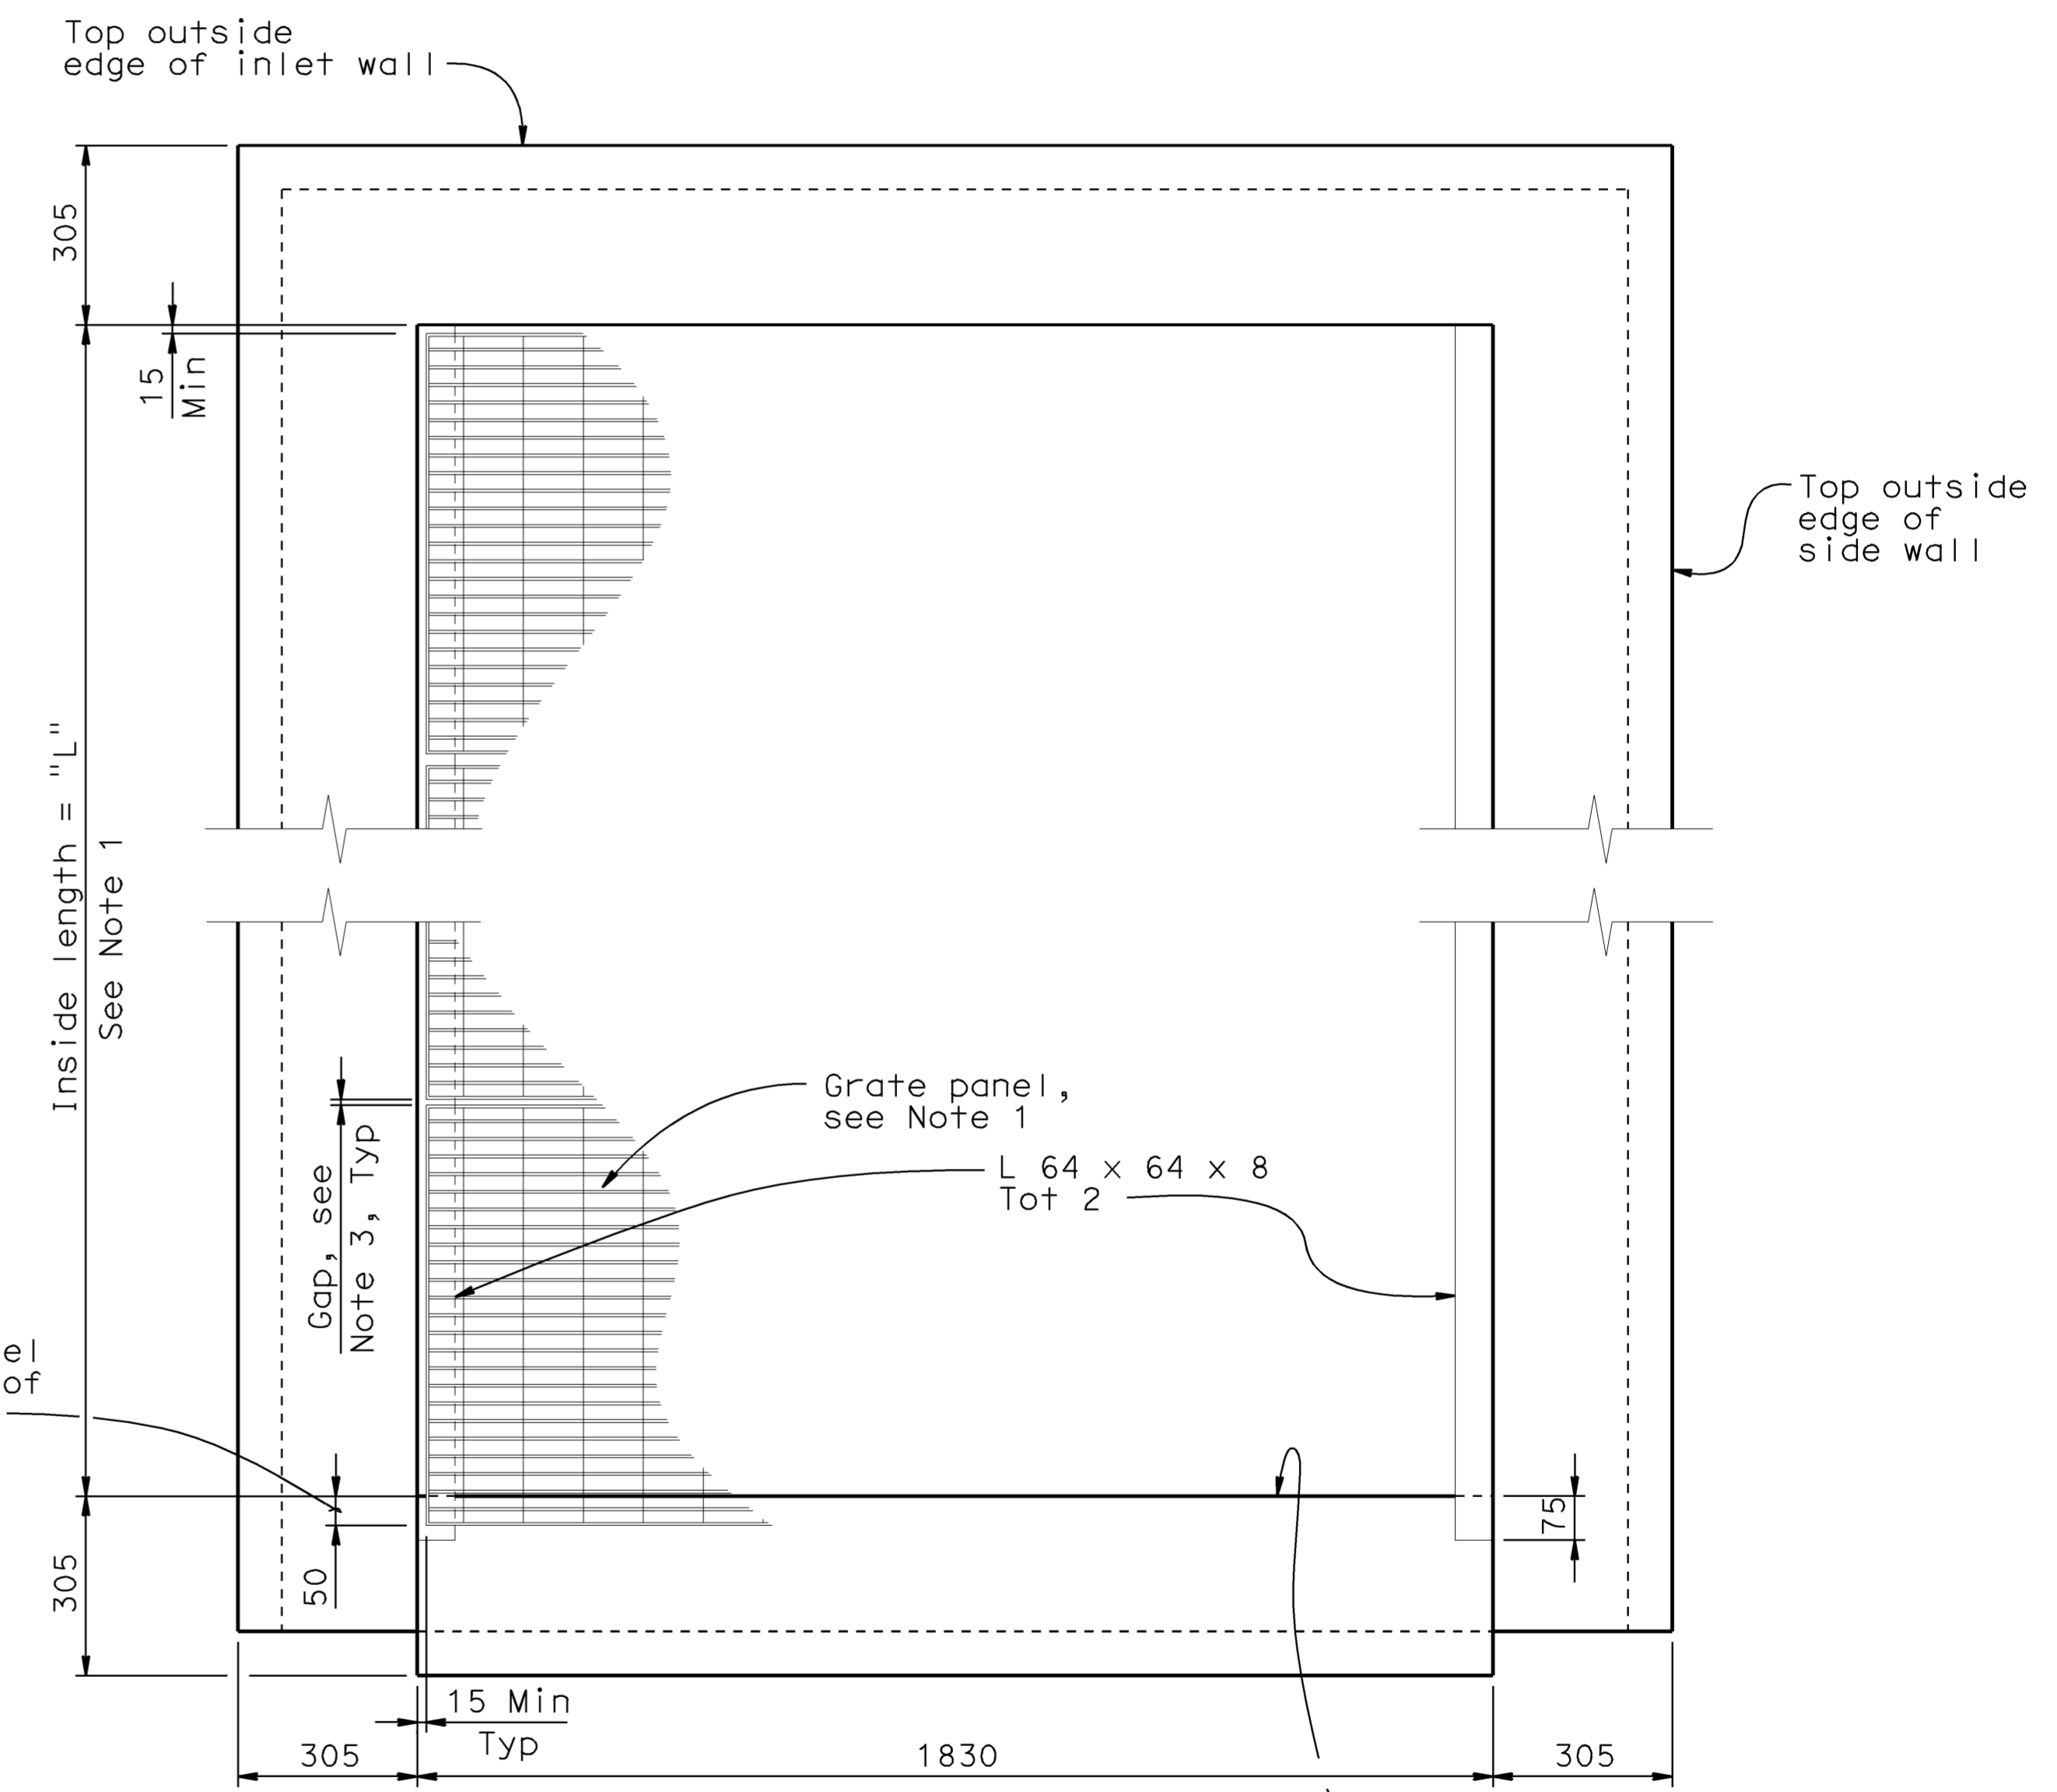

GRATE LAYOUT
(see Note 1)
1:10

WATER POLLUTION CONTROL DETAILS
WD-17


ALL DIMENSIONS ARE IN MILLIMETERS UNLESS OTHERWISE SHOWN

RELEASE DATE ---	DESIGN BY <i>D. Dunrud</i>	CHECKED <i>J&P Peterson</i>
FILE NO. ---	DETAILS BY <i>J&P Peterson</i>	CHECKED <i>J&P Peterson</i>
	SUBMITTED BY <i>D. Forester</i>	DRAWING DATE <i>02/07</i>

STATE OF CALIFORNIA
DEPARTMENT OF TRANSPORTATION

DIVISION OF ENGINEERING SERVICES	BRIDGE NO.
CU 07314 EA 121841	MILE POST

GROSS SOLIDS REMOVAL DEVICE	
LINEAR RADIAL - DETAILS NO.4	
REVISION DATES (PRELIMINARY STAGE ONLY)	SHEET 6 OF 32

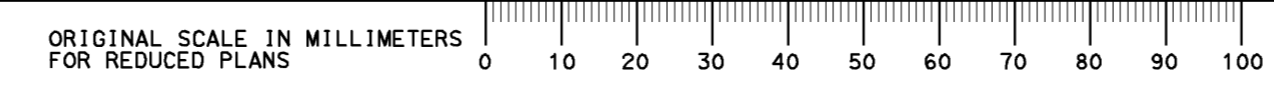

USERNAME => trmartin
DGN FILE => 7121841h017.dgn

DISREGARD PRINTS BEARING EARLIER REVISION DATES

DATE PLOTTED => 12-JUN-2009 TIME PLOTTED => 08:16



DIST.	COUNTY	ROUTE	MILE POST TOTAL PROJECT	SHEET NO.	TOTAL SHEETS
07	LA	5	42.8/47.3	93	1073

Douglas Dunrud
 REGISTERED ENGINEER - CIVIL
 6-8-09
 PLANS APPROVAL DATE

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QUANTITY SUMMARY TABLE FOR LINEAR RADIAL GSRD																
GSRD Configuration (Type - H)	Wall Height "H"	No. of Intermediate Pipe Screen Sections "N"	Length Inside of Walls "L"	Out-to-Out Concrete Dimensions			Invert Elevation Differential Between Inlet and Outlet		Shear Keys Required	No. of Grate Panels	Stainless Steel Screen (kg)	Concrete (m3)	Bar Reinf Steel (kg)	Misc Metal (kg)	Maximum Pipe Opening	
				Height	Length	Width	Minimum	Maximum							Inlet Wall	Outlet Wall
LR-1-1220	1220	0	3630	1620	4390	3490	111	257	-	5	314	10.1	795	447	785 *	710
LR-2-1220	1220	1	5155	1620	5915	3490	126	272	-	7	495	13.1	939	619		
LR-3-1220	1220	2	6680	1620	7440	3490	141	287	-	9	676	16.2	1097	789		
LR-4-1220	1220	3	8205	1620	8965	3490	157	303	-	11	857	19.3	1237	961		
LR-5-1220	1220	4	9730	1620	10490	3490	172	318	-	13	1038	22.4	1380	1131		
LR-6-1220	1220	5	11255	1620	12015	3490	187	333	-	15	1219	25.5	1533	1302		
LR-1-1830	1830	0	3630	2230	4390	3490	111	867	-	5	314	12.0	1081	455	1295 *	1295
LR-2-1830	1830	1	5155	2230	5915	3490	126	882	-	7	495	15.5	1266	627		
LR-3-1830	1830	2	6680	2230	7440	3490	141	897	Yes	9	676	20.3	1496	797		
LR-4-1830	1830	3	8205	2230	8965	3490	157	913	Yes	11	857	24.0	1704	969		
LR-5-1830	1830	4	9730	2230	10490	3490	172	928	Yes	13	1038	27.8	1902	1139		
LR-6-1830	1830	5	11255	2230	12015	3490	187	943	Yes	15	1219	31.6	2112	1310		
LR-1-2440	2440	0	3630	2840	4390	3490	111	1477	Yes	5	314	14.7	1713	463	1295 *	1295
LR-2-2440	2440	1	5155	2840	5915	3490	126	1492	Yes	7	495	18.9	2043	635		
LR-3-2440	2440	2	6680	2840	7440	3490	141	1507	Yes	9	676	23.1	2360	805		
LR-4-2440	2440	3	8205	2840	8965	3490	157	1523	Yes	11	857	27.3	2712	977		
LR-5-2440	2440	4	9730	2840	10490	3490	172	1538	Yes	13	1038	31.5	3055	1147		
LR-6-2440	2440	5	11255	2840	12015	3490	187	1553	Yes	15	1219	35.7	3399	1318		

NOTES:

- Bar reinforcing steel and concrete quantities assume minimum screen height for all configurations.
- Pipe opening size is equal to pipe outside diameter.
- Maximum inlet inside pipe diameter shall not exceed 610 mm which is the size of louvered screen. Minimum screen height is assumed for maximum inlet pipe opening.

* See Note 3

ALL DIMENSIONS ARE IN MILLIMETERS UNLESS OTHERWISE SHOWN

WATER POLLUTION CONTROL DETAILS

WD-18

RELEASE DATE --- FILE NO. ---	DESIGN BY <i>D. Dunrud</i> DETAILS BY <i>J&P Peterson</i> SUBMITTED BY <i>D. Forester</i>	CHECKED <i>J&P Peterson</i> CHECKED <i>J&P Peterson</i> DRAWING DATE <i>02/07</i>	STATE OF CALIFORNIA DEPARTMENT OF TRANSPORTATION	DIVISION OF ENGINEERING SERVICES	BRIDGE NO. --- MILE POST ---	GROSS SOLIDS REMOVAL DEVICE LINEAR RADIAL - QUANTITIES
ORIGINAL SCALE IN MILLIMETERS FOR REDUCED PLANS: 0 10 20 30 40 50 60 70 80 90 100			CU 07314 EA 121841		DISREGARD PRINTS BEARING EARLIER REVISION DATES	

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DGN FILE => 7121841h018.dgn


DATE PLOTTED => 12-JUN-2009 TIME PLOTTED => 08:19




DIST.	COUNTY	ROUTE	MILE POST TOTAL PROJECT	SHEET NO.	TOTAL SHEETS
07	LA	5	42.8/47.3	94	1073

REGISTERED ENGINEER - CIVIL
 DOUGLAS DUNRUD
 No. 47240
 Exp. 12/31/09
 CIVIL
 STATE OF CALIFORNIA


6-8-09
 PLANS APPROVAL DATE
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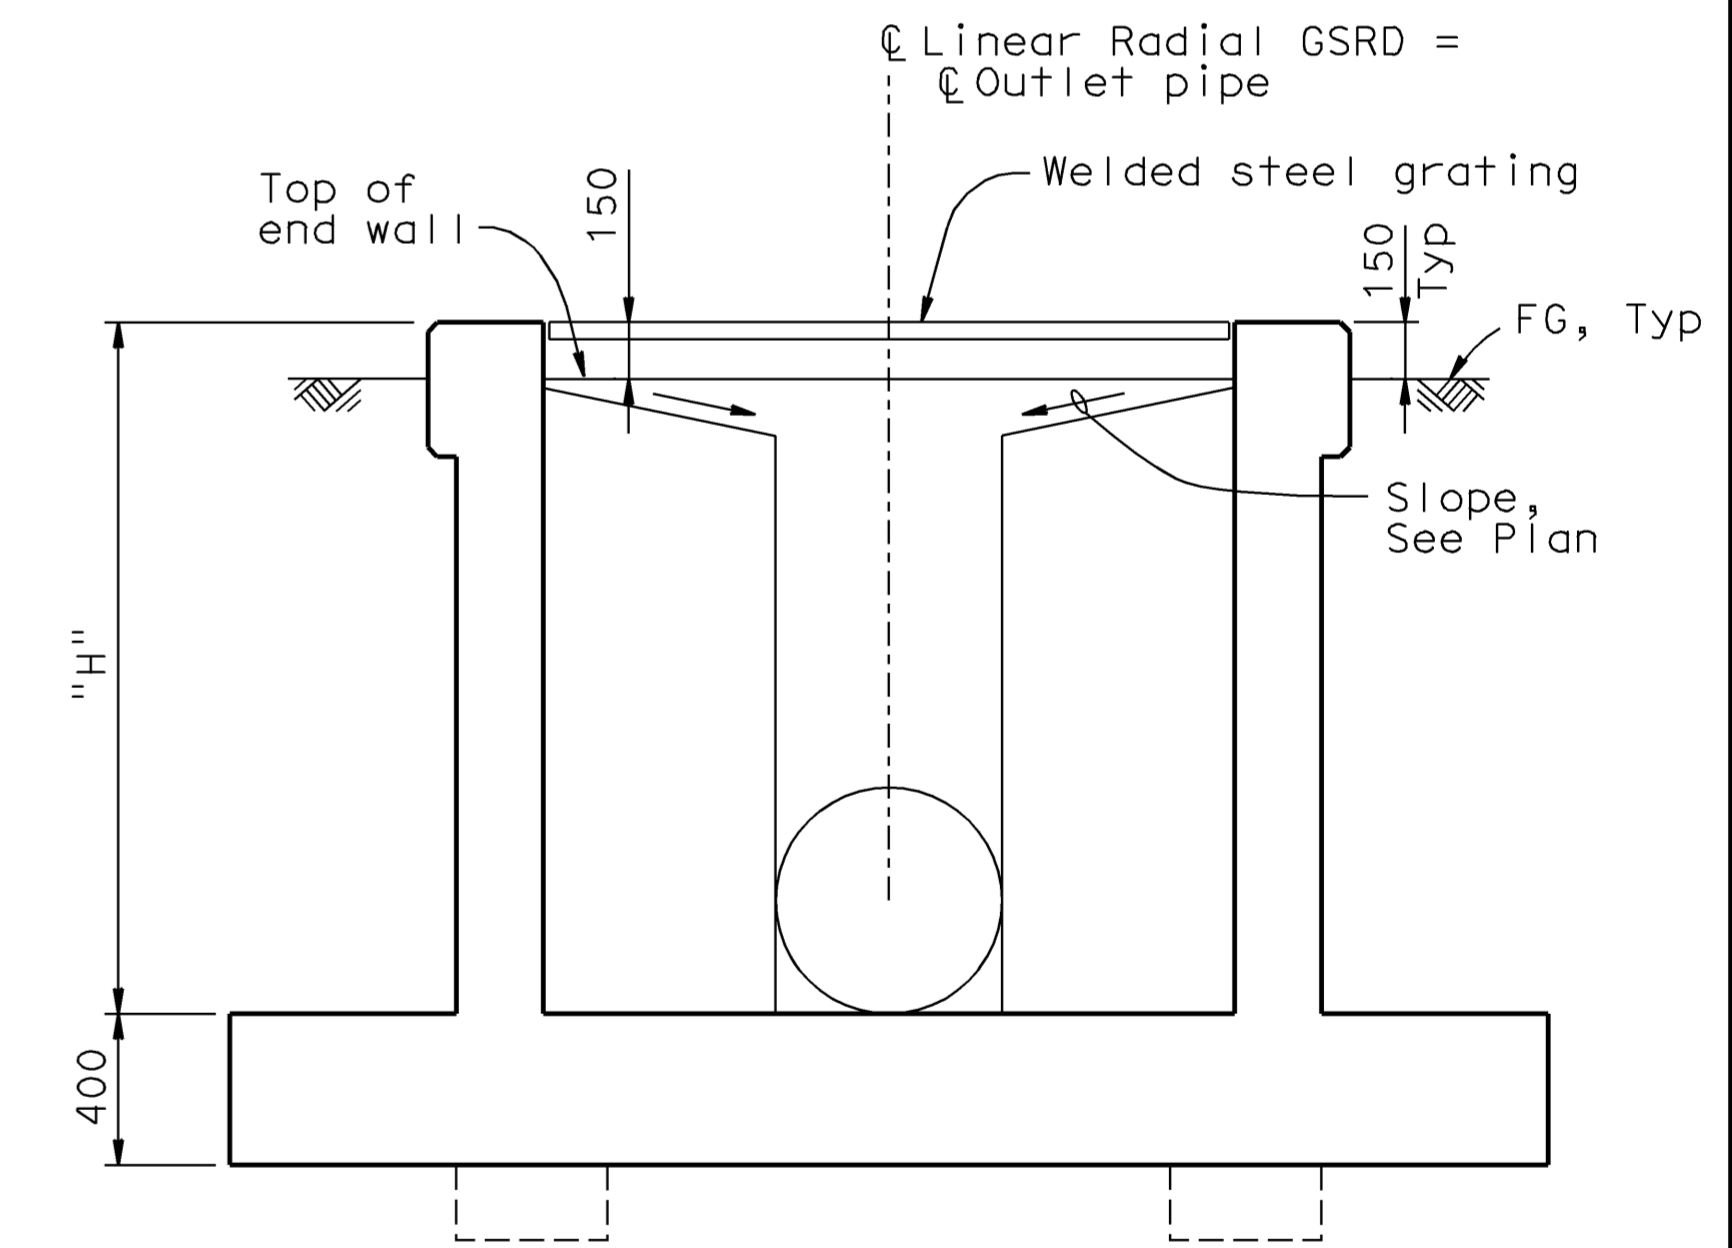
LONGITUDINAL SECTION - MAXIMUM SCREEN HEIGHT

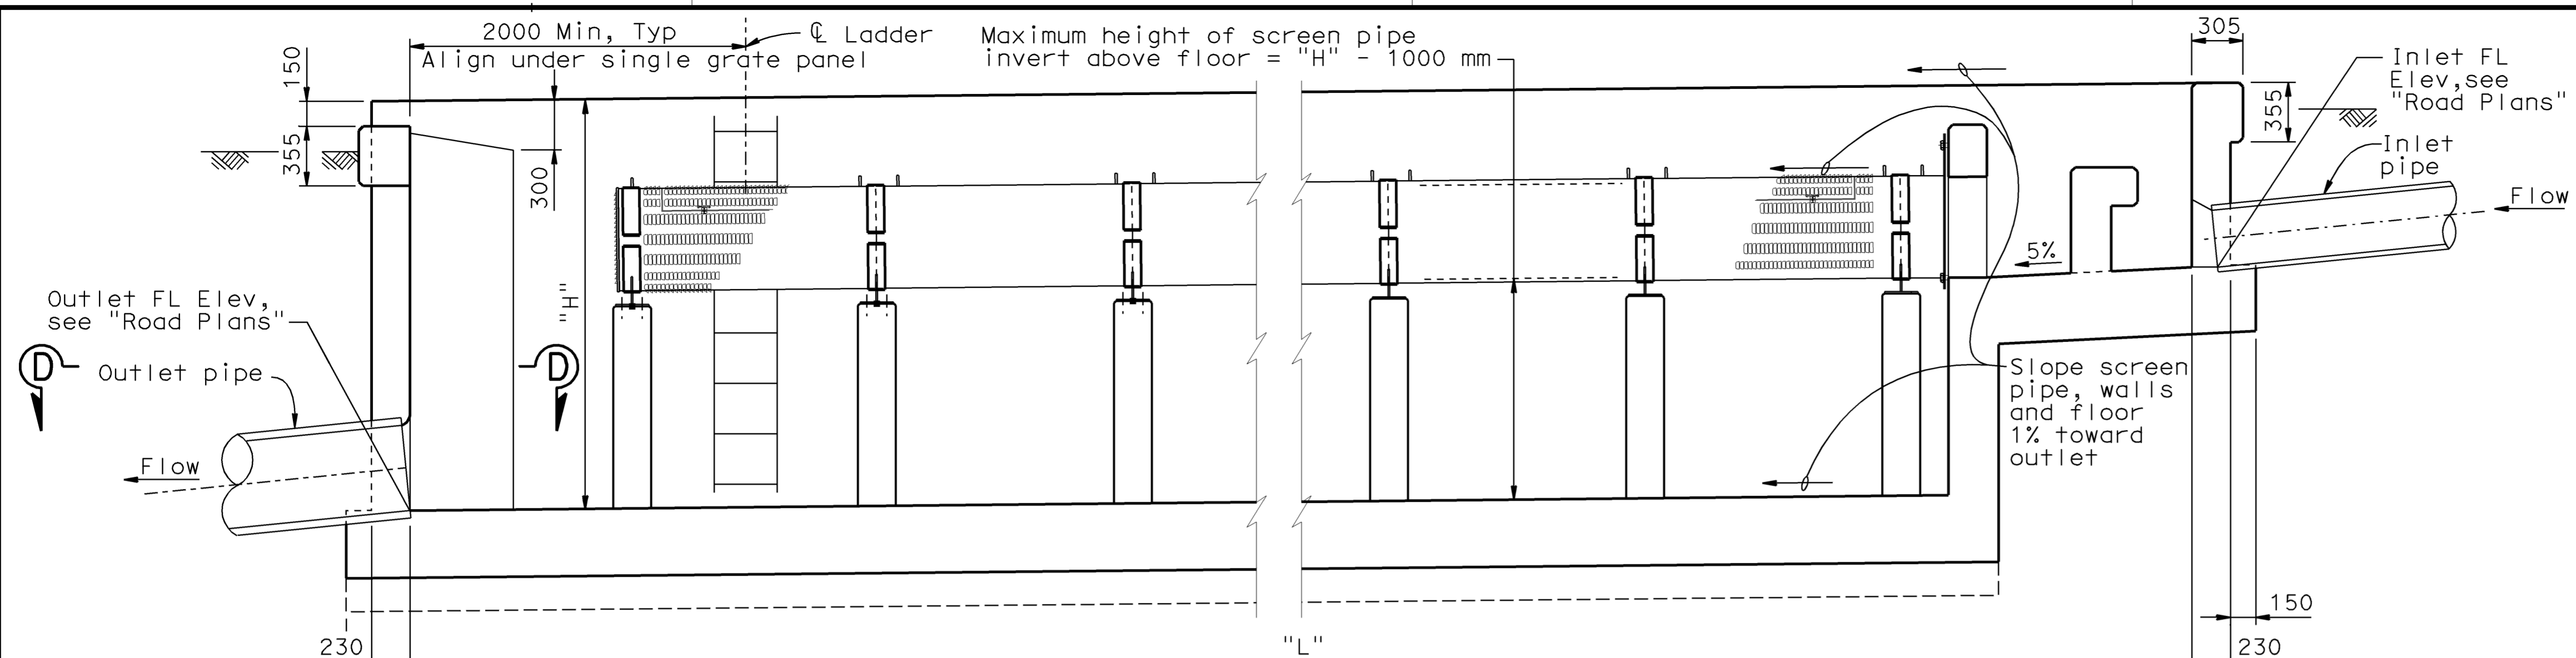

LONGITUDINAL SECTION - MINIMUM SCREEN HEIGHT

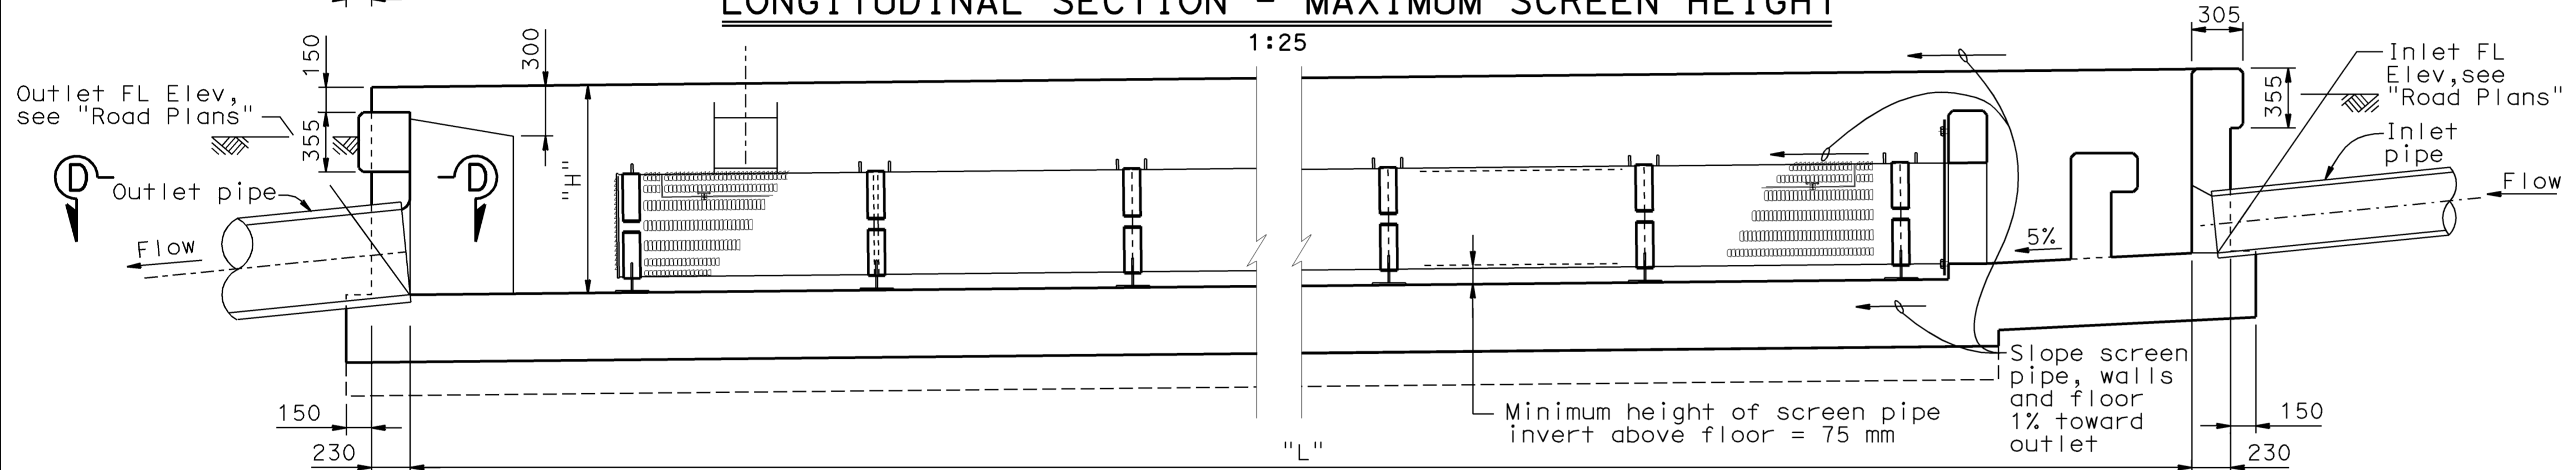

PLAN
1:25

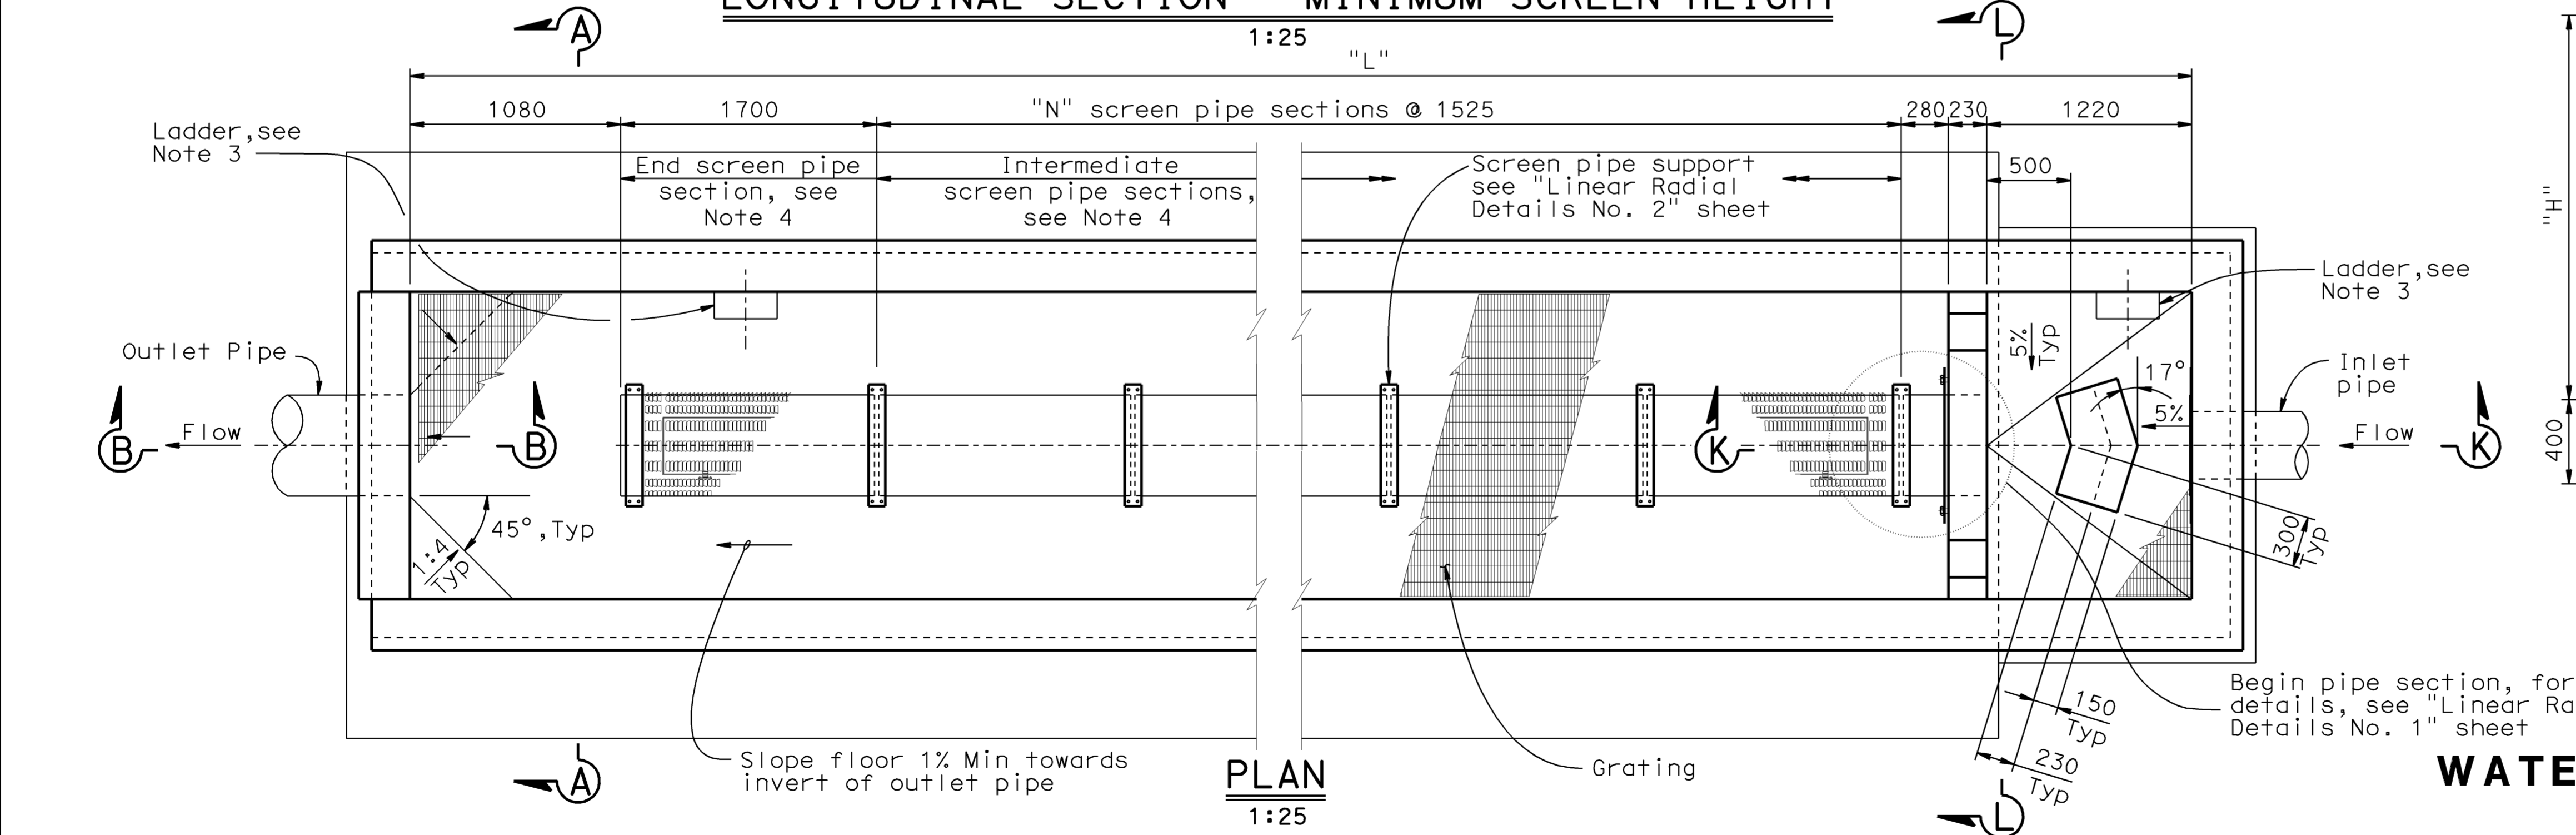

SECTION A-A
1:20

- NOTES:
1. For Typical Section, see "Linear Radial - Details No. 1" sheet.
 2. For Section B-B and D-D, see "Linear Radial - Details No. 1" sheet.
 3. For ladder details see "Miscellaneous Details No. 1" sheet.
 4. For end screen and intermediate screen pipe details, see "Linear Radial - Details No. 3" sheet.
 5. For "N", "H" and other design data, see "Linear Radial (HV) - Quantities" sheet.
 6. For Section K-K and L-L, see "Linear Radial (HV) - Details No. 1" sheet.
 7. For Grating details, see "Linear Radial Details No. 4" sheet.
 8. For inlet and outlet pipe details not shown, see "Road Plans".

WATER POLLUTION CONTROL DETAILS
HIGH VELOCITY
WD-19

RELEASE DATE	DESIGN BY	BY	CHECKED	BY
---	D. Dunrud	D. Dunrud	J&P Peterson	J&P Peterson
FILE NO.	DETAILS BY	BY	CHECKED	BY
---	J&P Peterson	J&P Peterson	J&P Peterson	J&P Peterson
	SUBMITTED BY	BY	DRAWING DATE	
	D. Forester	D. Forester	02/07	

STATE OF CALIFORNIA
DEPARTMENT OF TRANSPORTATION

DIVISION OF ENGINEERING SERVICES

BRIDGE NO. _____

MILE POST _____

GROSS SOLIDS REMOVAL DEVICE
LINEAR RADIAL (HV) - LAYOUT

ORIGINAL SCALE IN MILLIMETERS FOR REDUCED PLANS

CU 07314
EA 121841

DISREGARD PRINTS BEARING EARLIER REVISION DATES

REVISION DATES (PRELIMINARY STAGE ONLY)

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SHEET 8 OF 32

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DGN FILE => 7121841h019.dgn


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DIST.	COUNTY	ROUTE	MILE POST TOTAL PROJECT	SHEET NO.	TOTAL SHEETS
07	LA	5	42.8/47.3	95	1073

REGISTERED ENGINEER - CIVIL
 DOUGLAS DUNRUD
 No. 47240
 Exp. 12/31/09
 CIVIL
 STATE OF CALIFORNIA


6-8-09
 PLANS APPROVAL DATE
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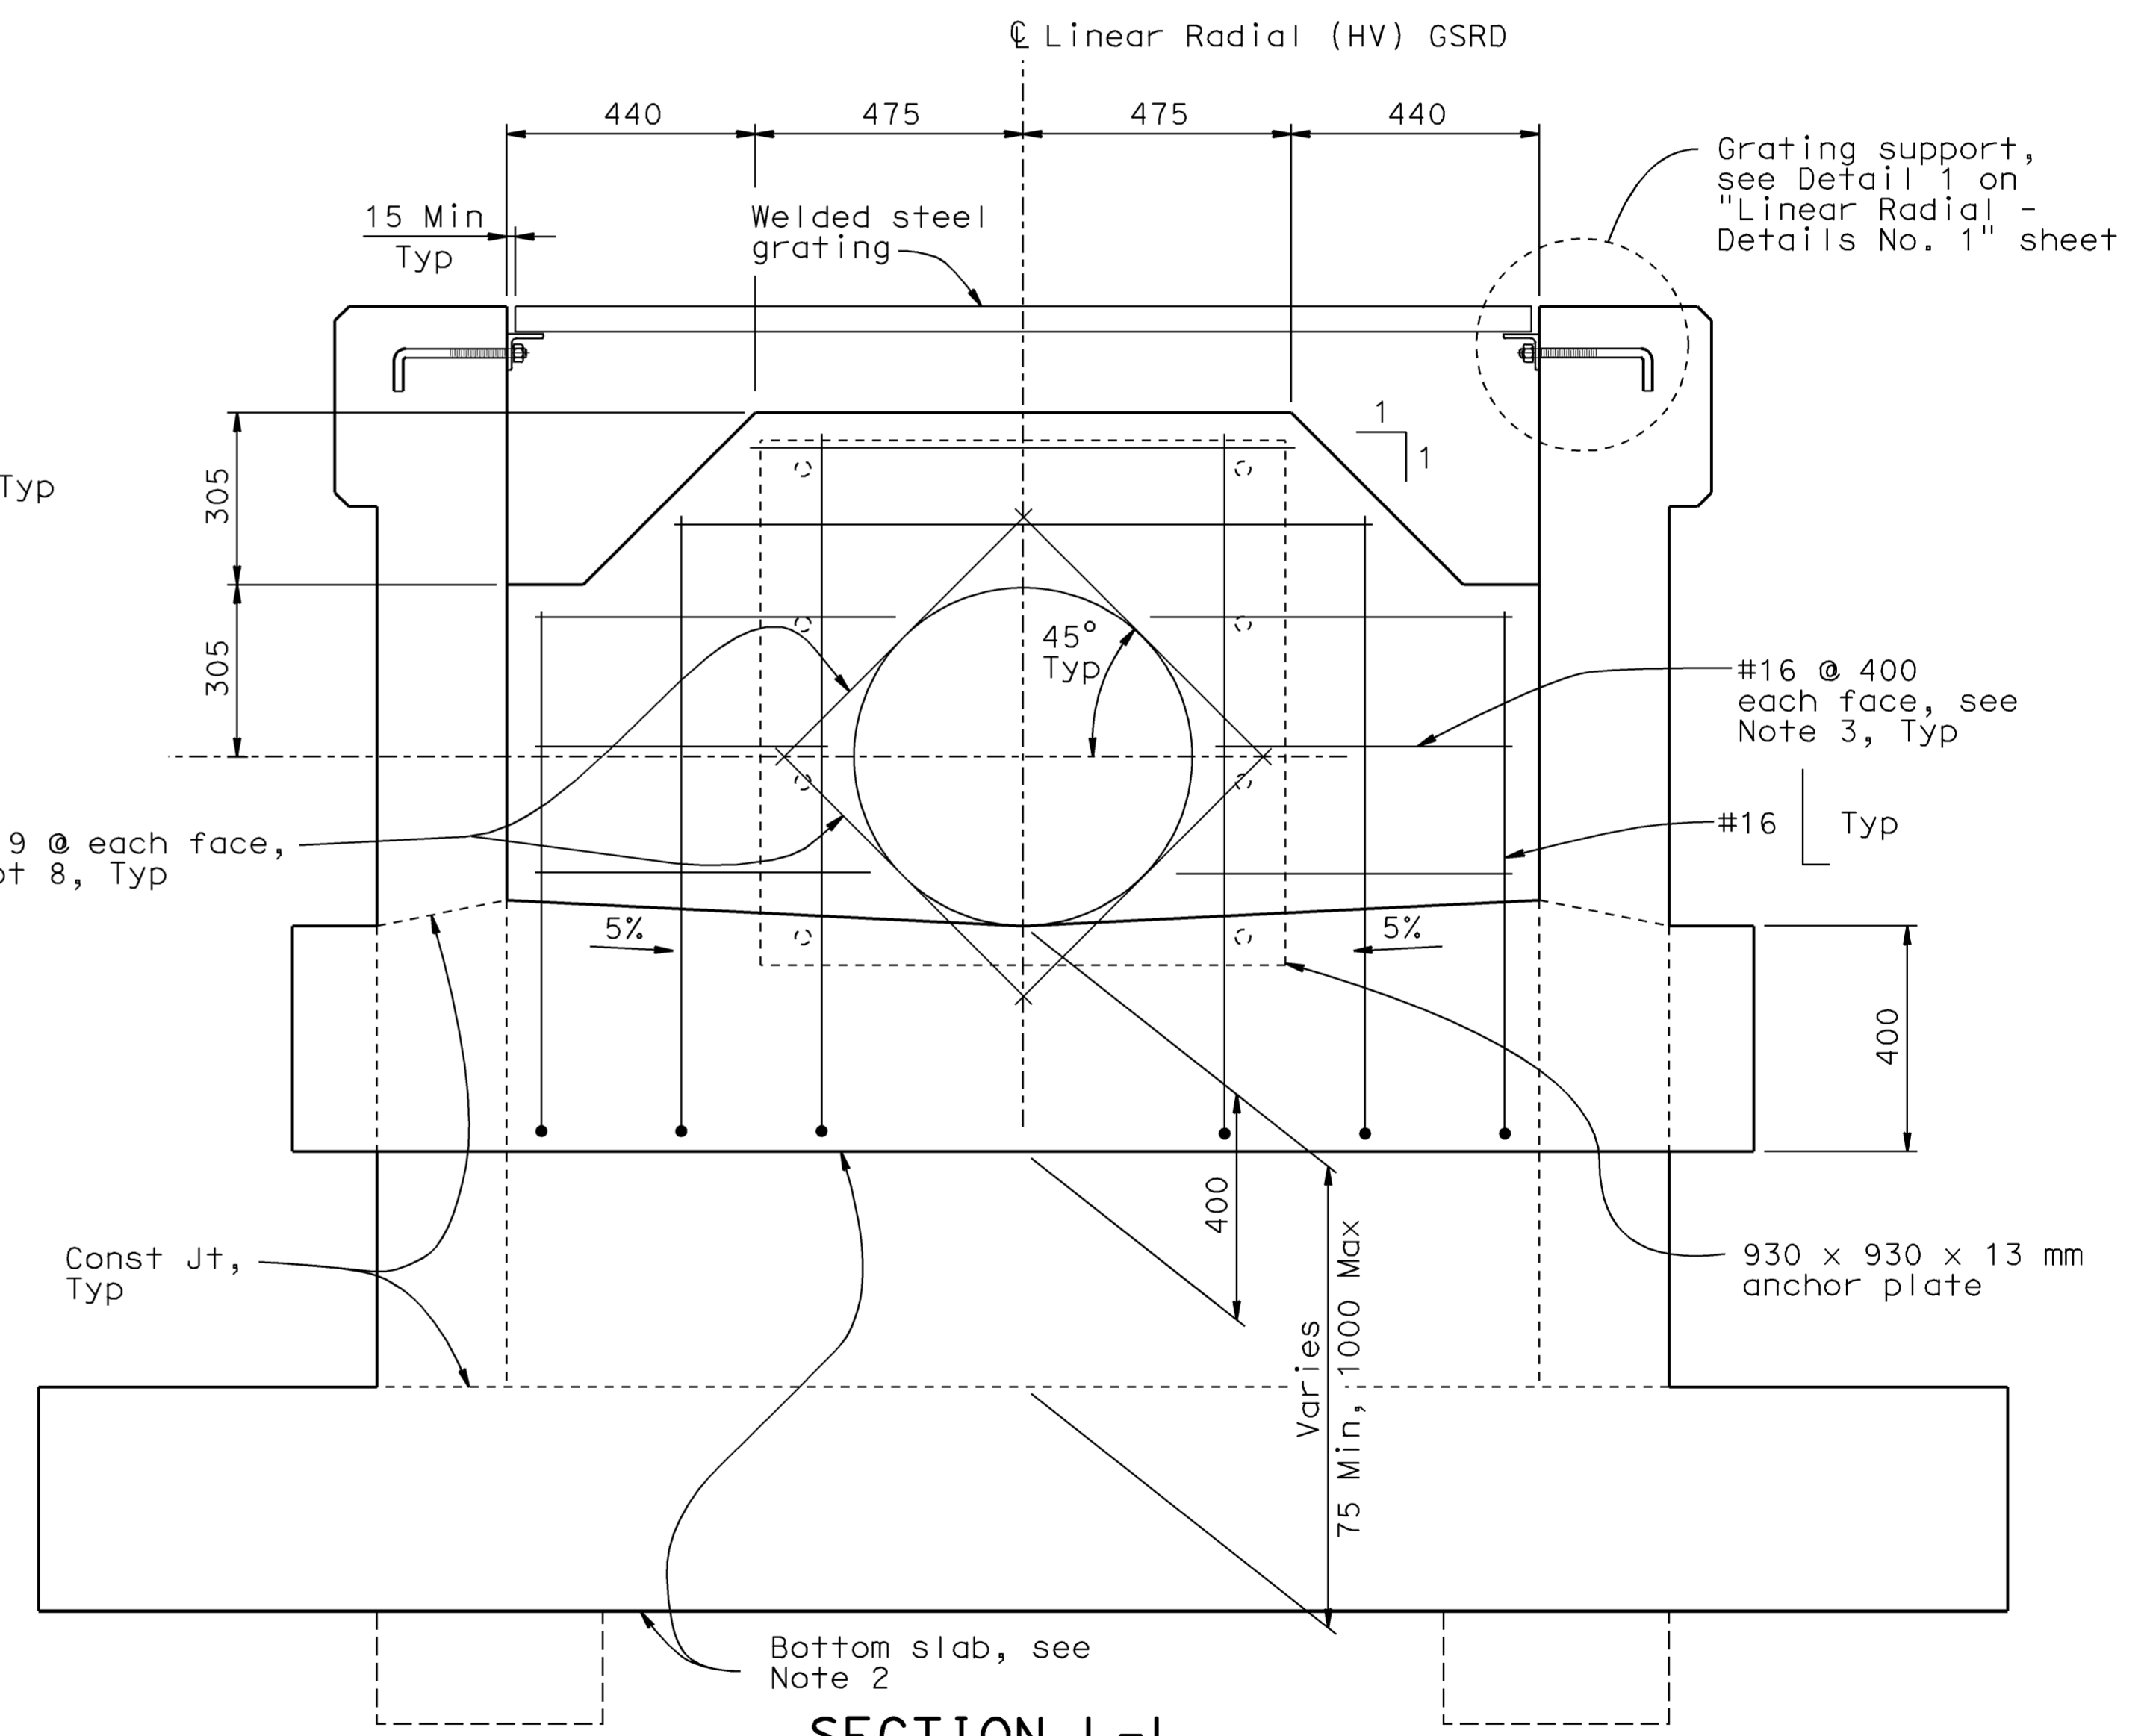
- NOTES:
- For location of sections K-K and L-L, see "Linear Radial (HV) - Layout" sheet.
 - For bottom slab details and grating support not shown, see Typical Section on "Linear Radial Details No. 1" sheet.
 - All metal components of screen pipe including connections to concrete shall be stainless steel.
 - All metal components of grating including connections to wall shall be galvanized.

ANCHOR PLATE DETAILS

1:10

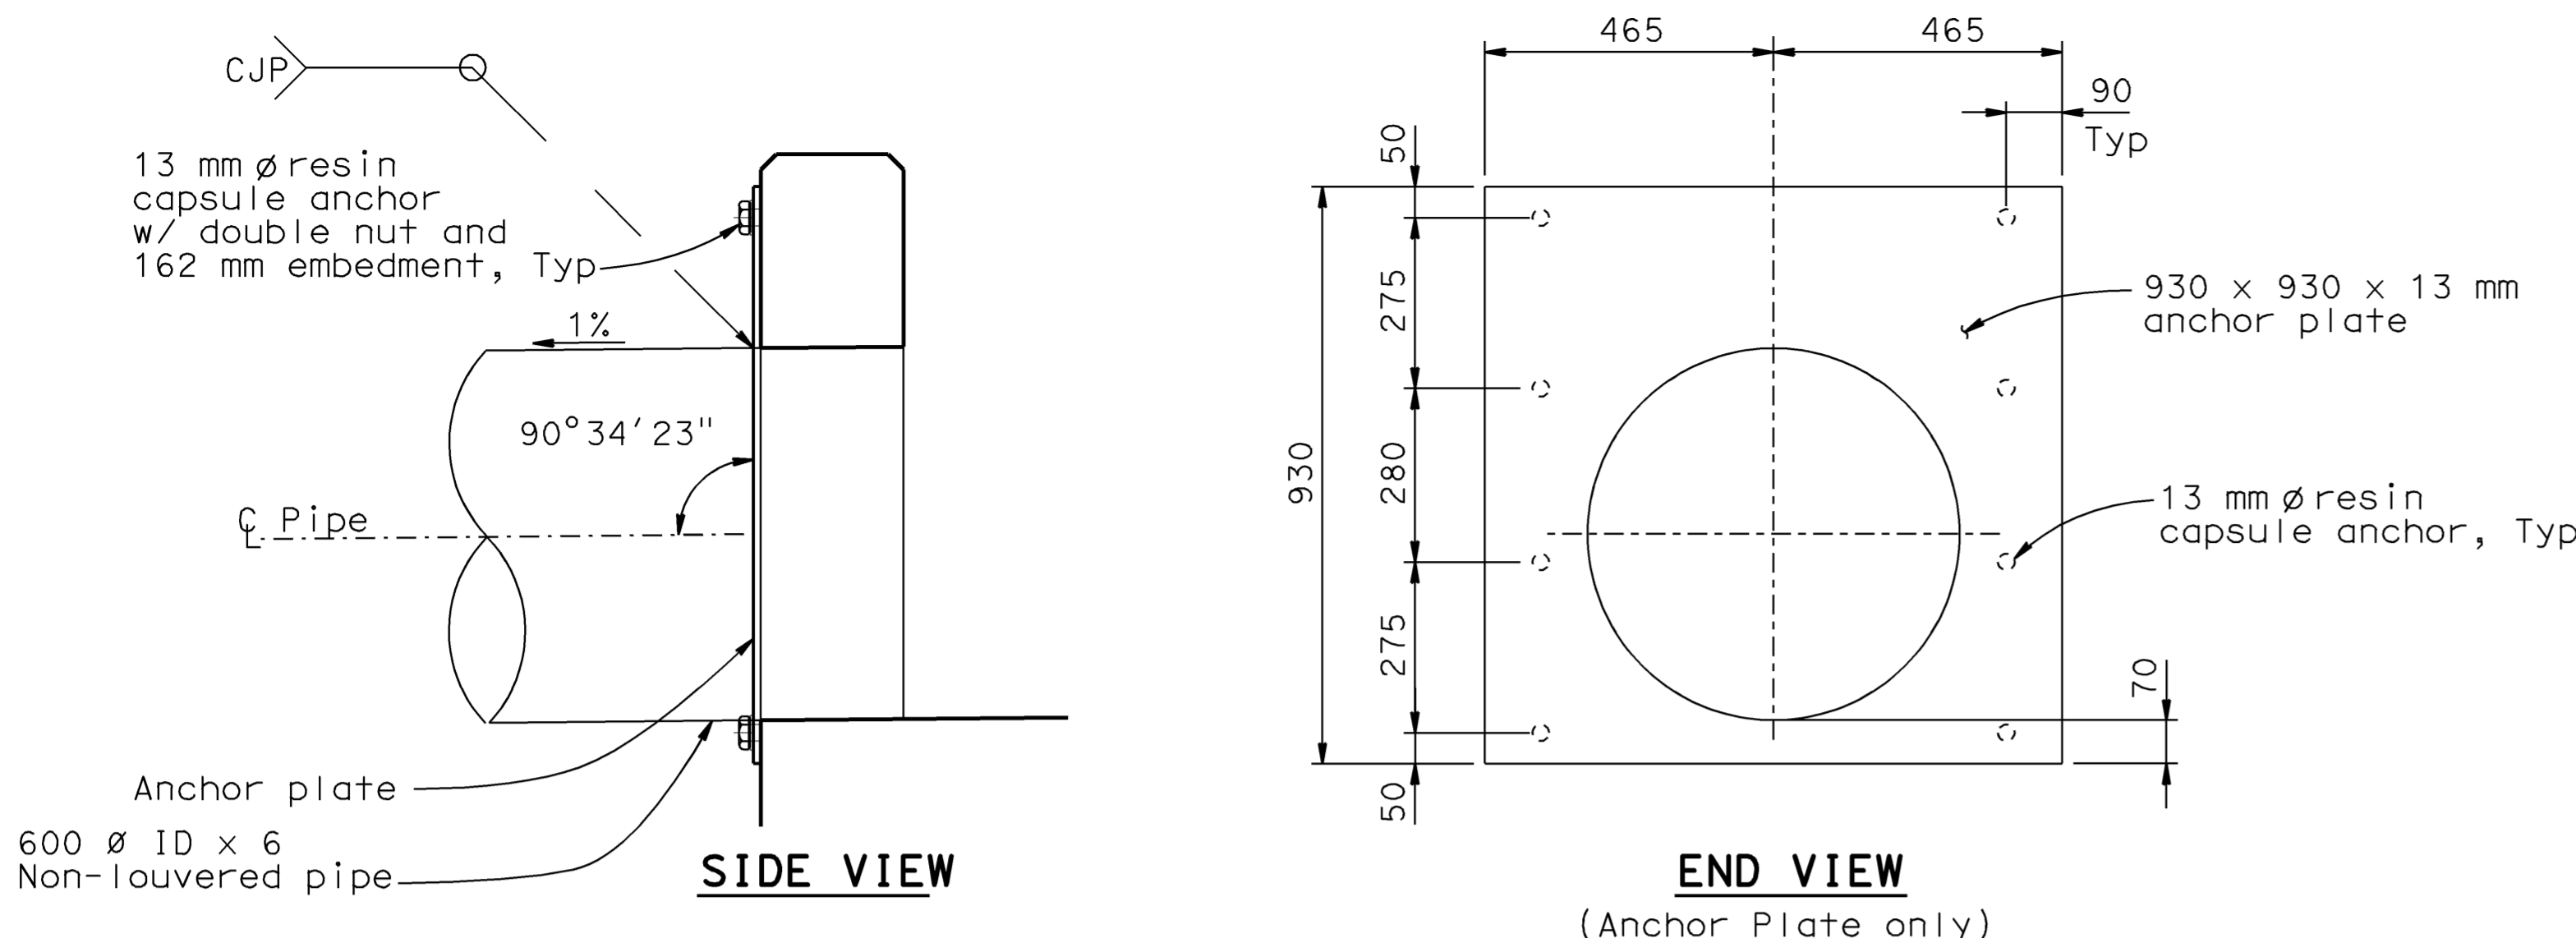

SECTION K-K
1:10

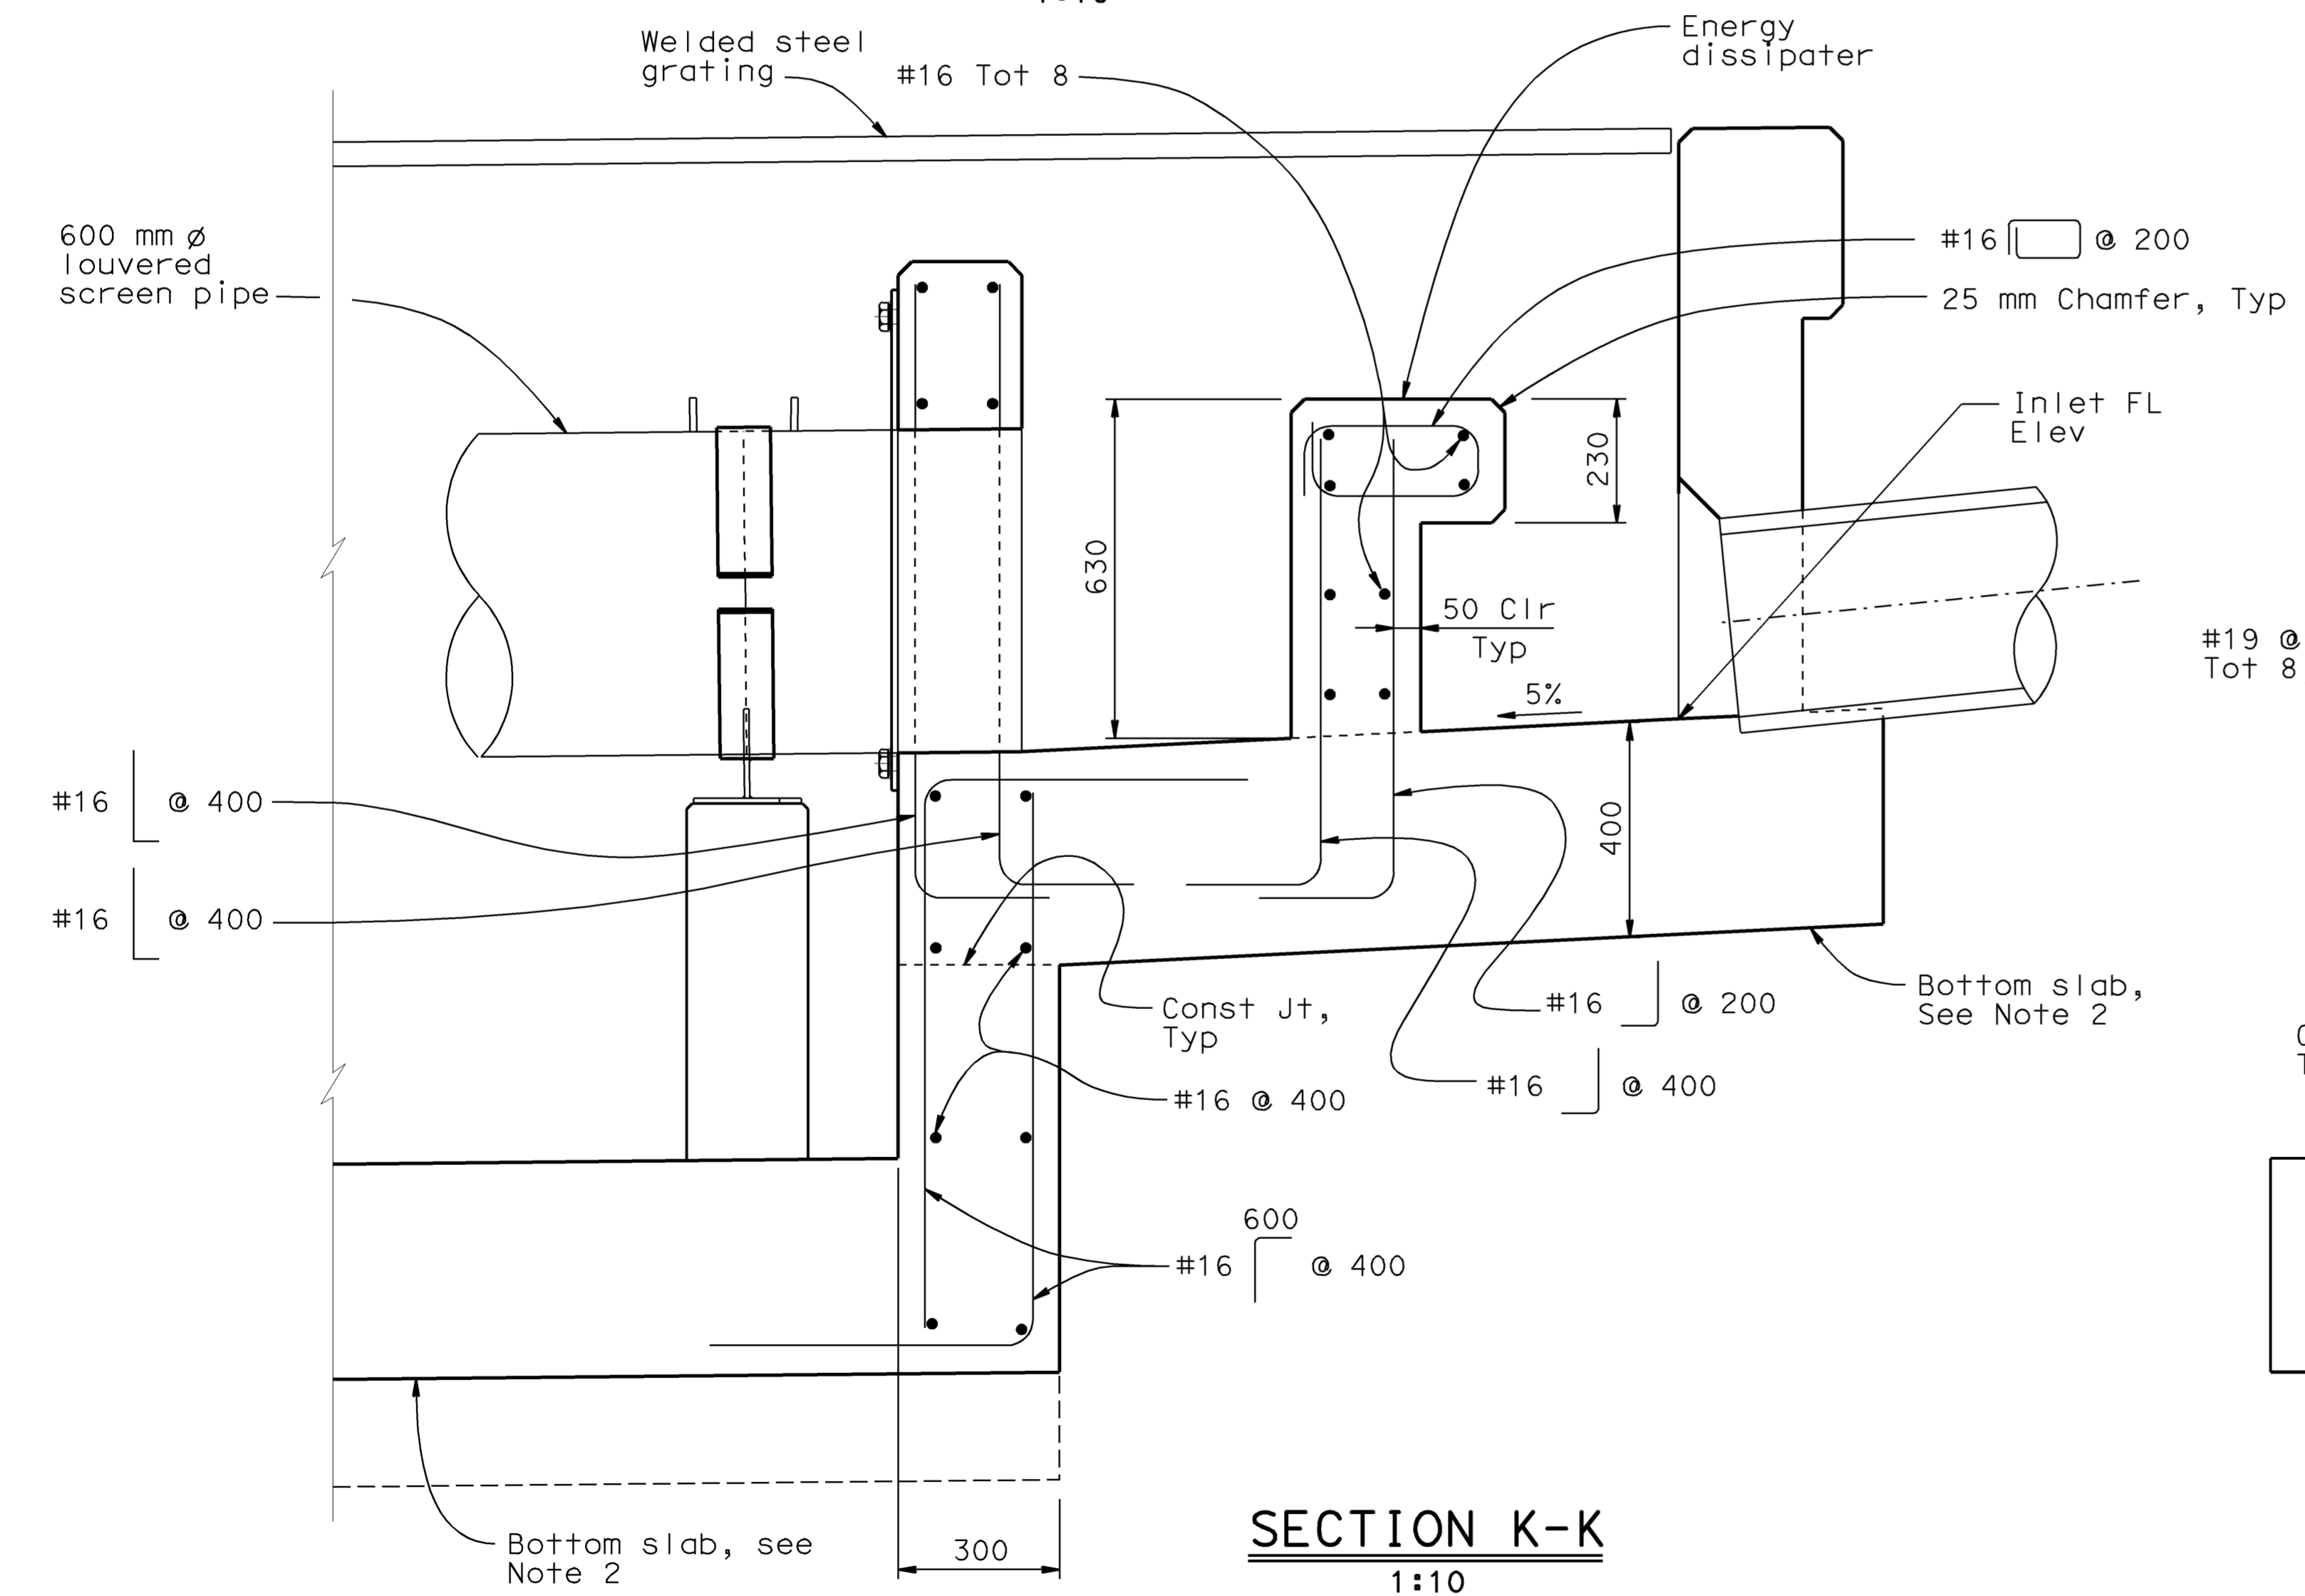

SECTION L-L
1:10

ALL DIMENSIONS ARE IN MILLIMETERS UNLESS OTHERWISE SHOWN

WATER POLLUTION CONTROL DETAILS
HIGH VELOCITY
WD-20

RELEASE DATE	DESIGN BY	BY	CHECKED
---	D. Dunrud	D. Dunrud	J&P Peterson
FILE NO.	DETAILS BY	BY	CHECKED
---	J&P Peterson	J&P Peterson	J&P Peterson
	SUBMITTED BY	BY	DRAWING DATE
	D. Forester	D. Forester	02/07

BRIDGE NO.	GROSS SOLIDS REMOVAL DEVICE
MILE POST	LINEAR RADIAL (HV) - DETAILS NO. 1

STATE OF CALIFORNIA
DEPARTMENT OF TRANSPORTATION

DIVISION OF ENGINEERING SERVICES

CU 07314	DISREGARD PRINTS BEARING EARLIER REVISION DATES	REVISION DATES (PRELIMINARY STAGE ONLY)	SHEET 9 OF 32
EA 121841			

ORIGINAL SCALE IN MILLIMETERS FOR REDUCED PLANS

USERNAME => trmartin
DGN FILE => 7121841n020.dgn

DATE PLOTTED => 12-JUN-2009 TIME PLOTTED => 08:16



DIST.	COUNTY	ROUTE	MILE POST TOTAL PROJECT	SHEET NO.	TOTAL SHEETS
07	LA	5	42.8/47.3	96	1073

Douglas L. Dunrud
 REGISTERED ENGINEER - CIVIL
 No. 47240
 Exp. 12/31/09
 CIVIL
 STATE OF CALIFORNIA

6-8-09
PLANS APPROVAL DATE

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QUANTITY SUMMARY TABLE FOR LINEAR RADIAL (HV) GSRD																
GSRD Configuration (Type - H)	Wall Height "H"	No. of Intermediate Pipe Screen Sections "N"	Length Inside of Walls "L"	Out-to-Out Concrete Dimensions			Invert Elevation Differential Between Inlet and Outlet		Shear Key Req'd.	No. of Grate Panels	Stainless Steel Screen (kg)	Concrete (m3)	Bar Reinf Steel (kg)	Misc Metal (kg)	Maximum Pipe Opening	
				Height	Length	Width	Minimum	Maximum							Inlet Wall	Outlet Wall
LR(HV)-1-1220	1220	0	4510	1620	5270	3490	111	257	-	6	284	11.8	1089	552	685	710
LR(HV)-2-1220	1220	1	6035	1620	6795	3490	126	272	-	8	465	14.9	1245	729		
LR(HV)-3-1220	1220	2	7560	1620	8320	3490	141	287	-	10	646	17.9	1361	905		
LR(HV)-4-1220	1220	3	9085	1620	9845	3490	157	303	-	12	828	21.0	1520	1083		
LR(HV)-5-1220	1220	4	10610	1620	11370	3490	172	318	-	14	1009	24.1	1676	1260		
LR(HV)-6-1220	1220	5	12135	1620	12895	3490	187	333	-	16	1190	27.2	1818	1436		
LR(HV)-1-1830	1830	0	4510	2230	5270	3490	111	867	-	6	284	13.9	1416	560	1270	1270
LR(HV)-2-1830	1830	1	6035	2230	6795	3490	126	882	-	8	465	17.4	1613	737		
LR(HV)-3-1830	1830	2	7560	2230	8320	3490	141	897	Yes	10	646	22.3	1813	913		
LR(HV)-4-1830	1830	3	9085	2230	9845	3490	157	913	Yes	12	828	26.0	2021	1091		
LR(HV)-5-1830	1830	4	10610	2230	11370	3490	172	928	Yes	14	1009	29.8	2226	1268		
LR(HV)-6-1830	1830	5	12135	2230	12895	3490	187	943	Yes	16	1190	33.6	2407	1444		
LR(HV)-1-2440	2440	0	4510	2840	5270	3490	111	1477	Yes	6	284	16.9	2094	568	1270	1270
LR(HV)-2-2440	2440	1	6035	2840	6795	3490	126	1492	Yes	8	465	21.1	2425	745		
LR(HV)-3-2440	2440	2	7560	2840	8320	3490	141	1507	Yes	10	646	25.3	2786	921		
LR(HV)-4-2440	2440	3	9085	2840	9845	3490	157	1523	Yes	12	828	29.4	3120	1099		
LR(HV)-5-2440	2440	4	10610	2840	11370	3490	172	1538	Yes	14	1009	33.6	3477	1276		
LR(HV)-6-2440	2440	5	12135	2840	12895	3490	187	1553	Yes	16	1190	37.8	3819	1452		

- NOTES:
1. Bar reinforcing steel and concrete quantities assume minimum screen height for all configurations.
 2. Pipe opening size is equal to pipe outside diameter.
 3. Minimum screen height is assumed for maximum inlet pipe opening.

ALL DIMENSIONS ARE IN MILLIMETERS UNLESS OTHERWISE SHOWN

WATER POLLUTION CONTROL DETAILS
HIGH VELOCITY
WD-21

RELEASE DATE ---	DESIGN BY <i>D. Dunrud</i>	CHECKED <i>J&P Peterson</i>		STATE OF CALIFORNIA DEPARTMENT OF TRANSPORTATION	DIVISION OF ENGINEERING SERVICES	BRIDGE NO.	GROSS SOLIDS REMOVAL DEVICE LINEAR RADIAL (HV) - QUANTITIES	SHEET NO.	10	TOTAL SHEETS	32
FILE NO. ---	DETAILS BY <i>J&P Peterson</i>	CHECKED <i>J&P Peterson</i>				MILE POST		REVISION DATES (PRELIMINARY STAGE ONLY)			
	SUBMITTED BY <i>D. Forester</i>	DRAWING DATE <i>02/07</i>				CU 07314 EA 121841		DISREGARD PRINTS BEARING EARLIER REVISION DATES			

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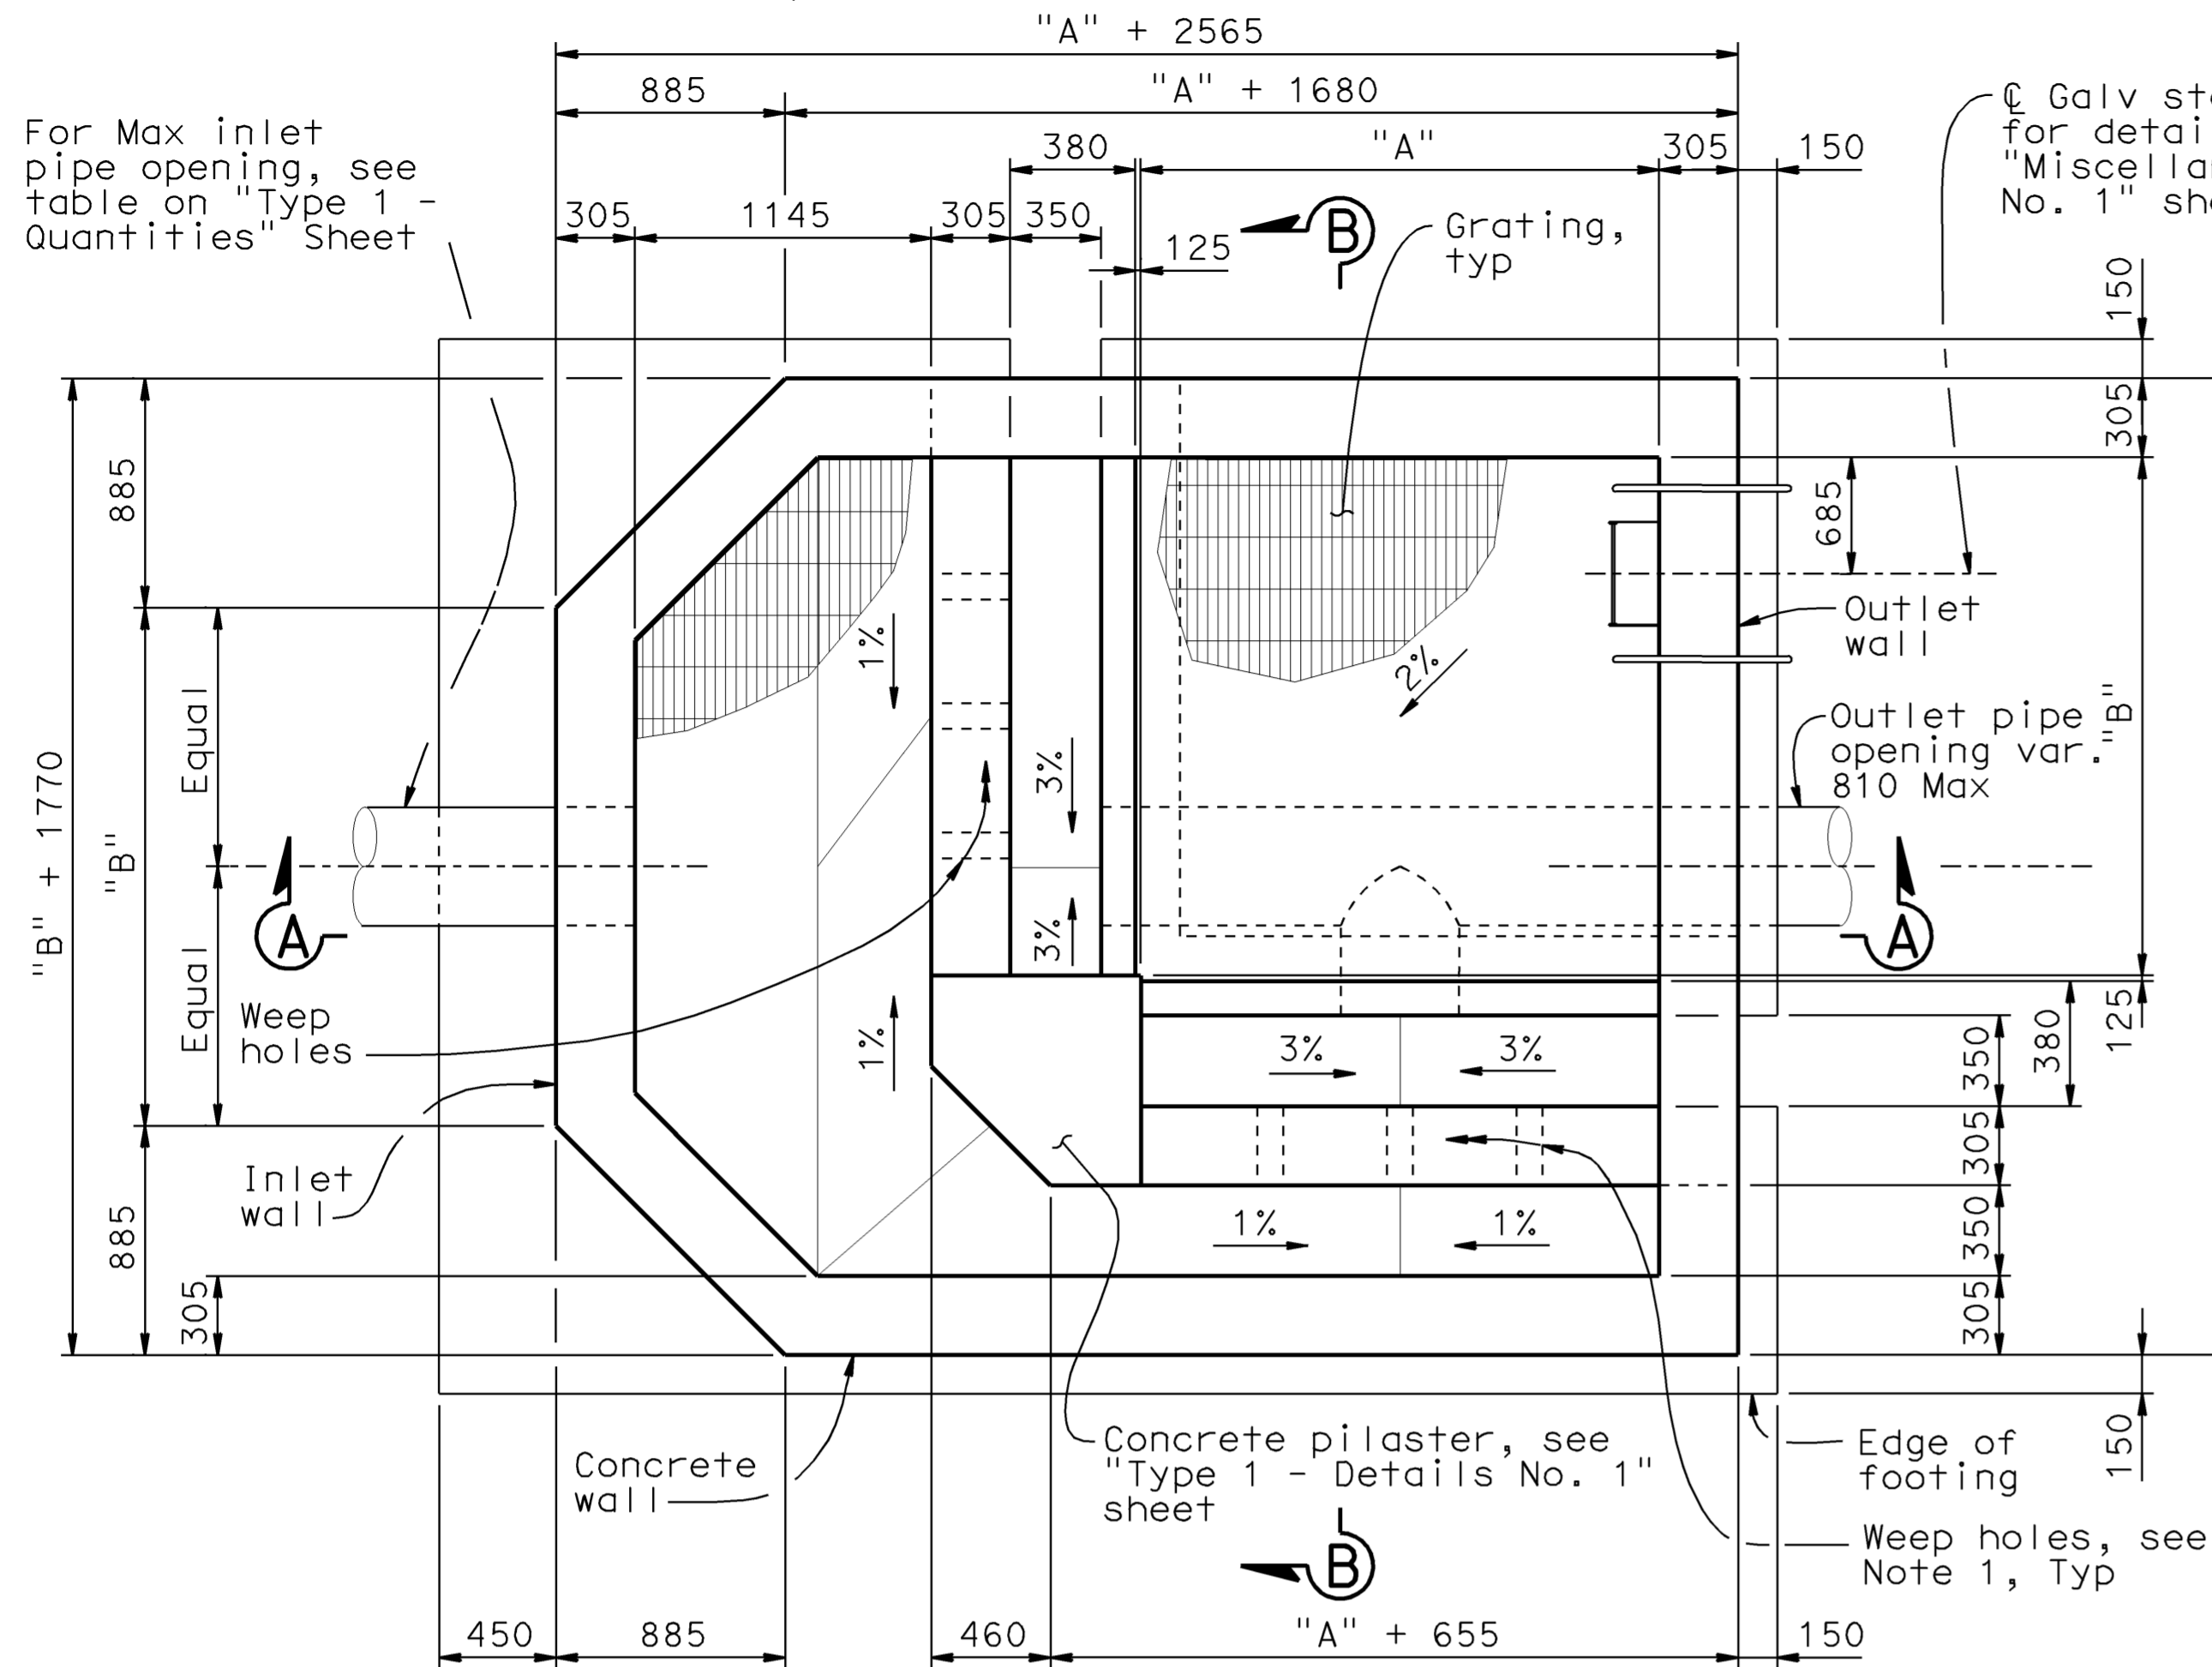
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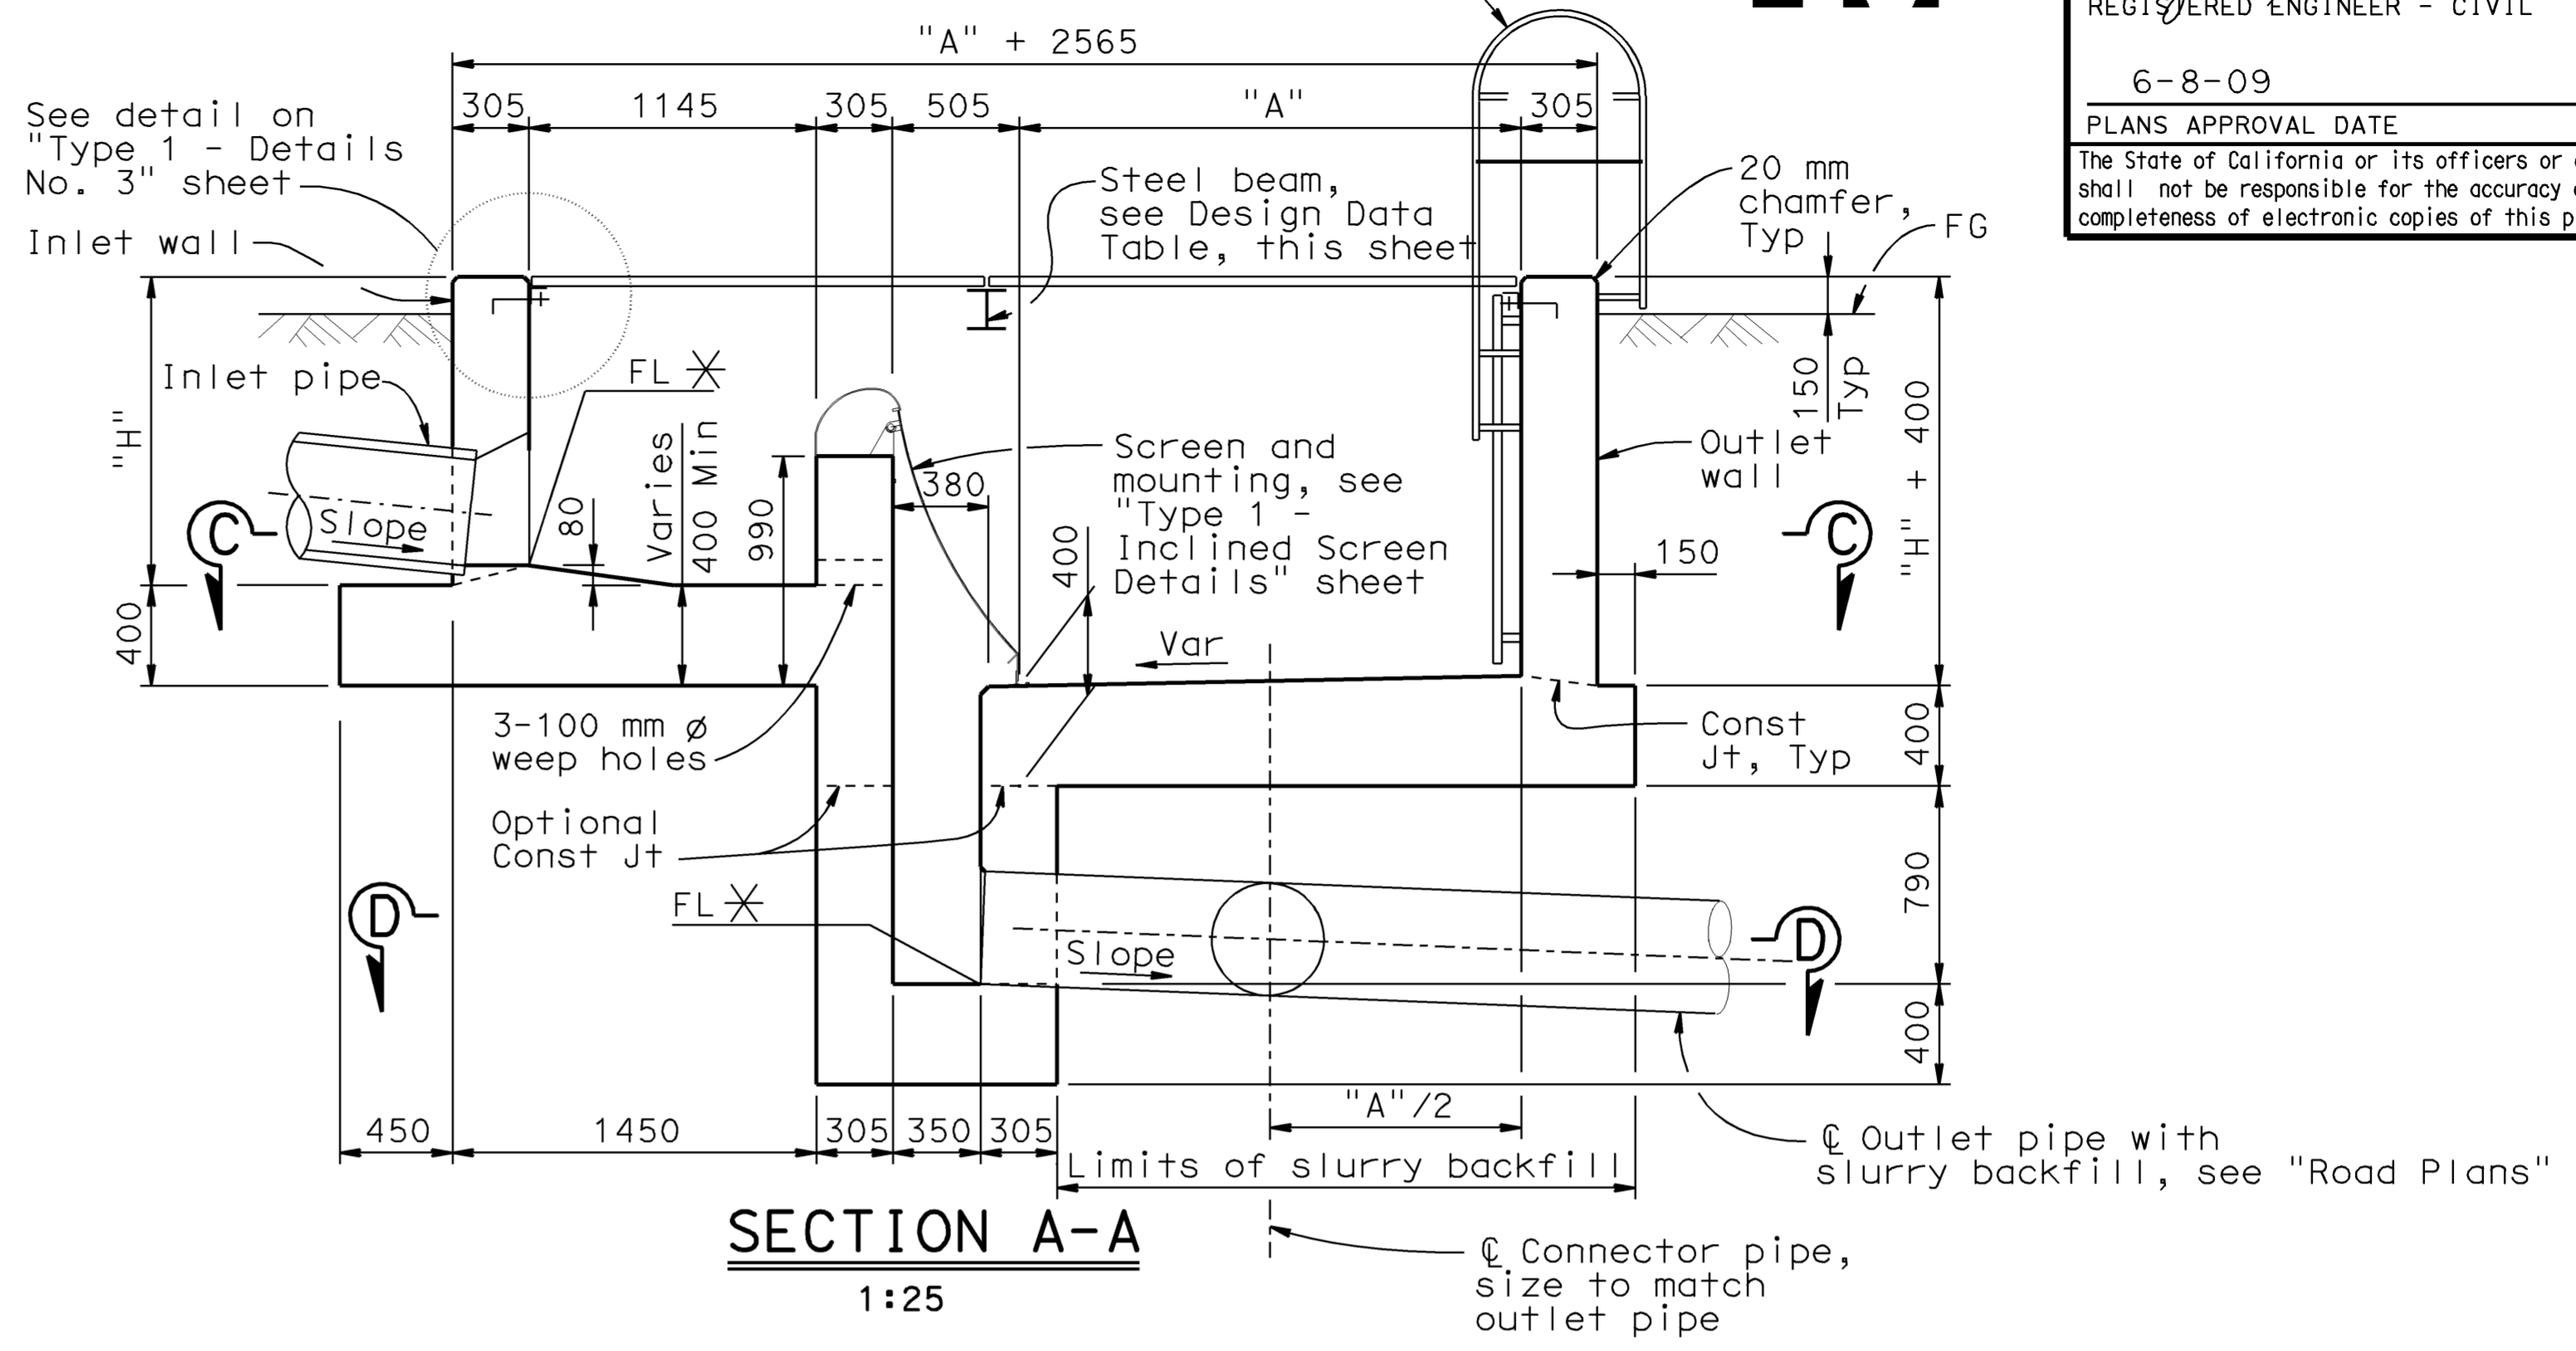
DIST.	COUNTY	ROUTE	MILE POST TOTAL PROJECT	SHEET NO.	TOTAL SHEETS
07	LA	5	42.8/47.3	97	1073

Douglas Dunrud
 REGISTERED ENGINEER - CIVIL
 No. 47240
 Exp. 12/31/09
 CIVIL
 STATE OF CALIFORNIA


6-8-09
 PLANS APPROVAL DATE
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PLAN - TYPE 1L
1:25



SECTION A-A
1:25



SECTION B-B
1:25

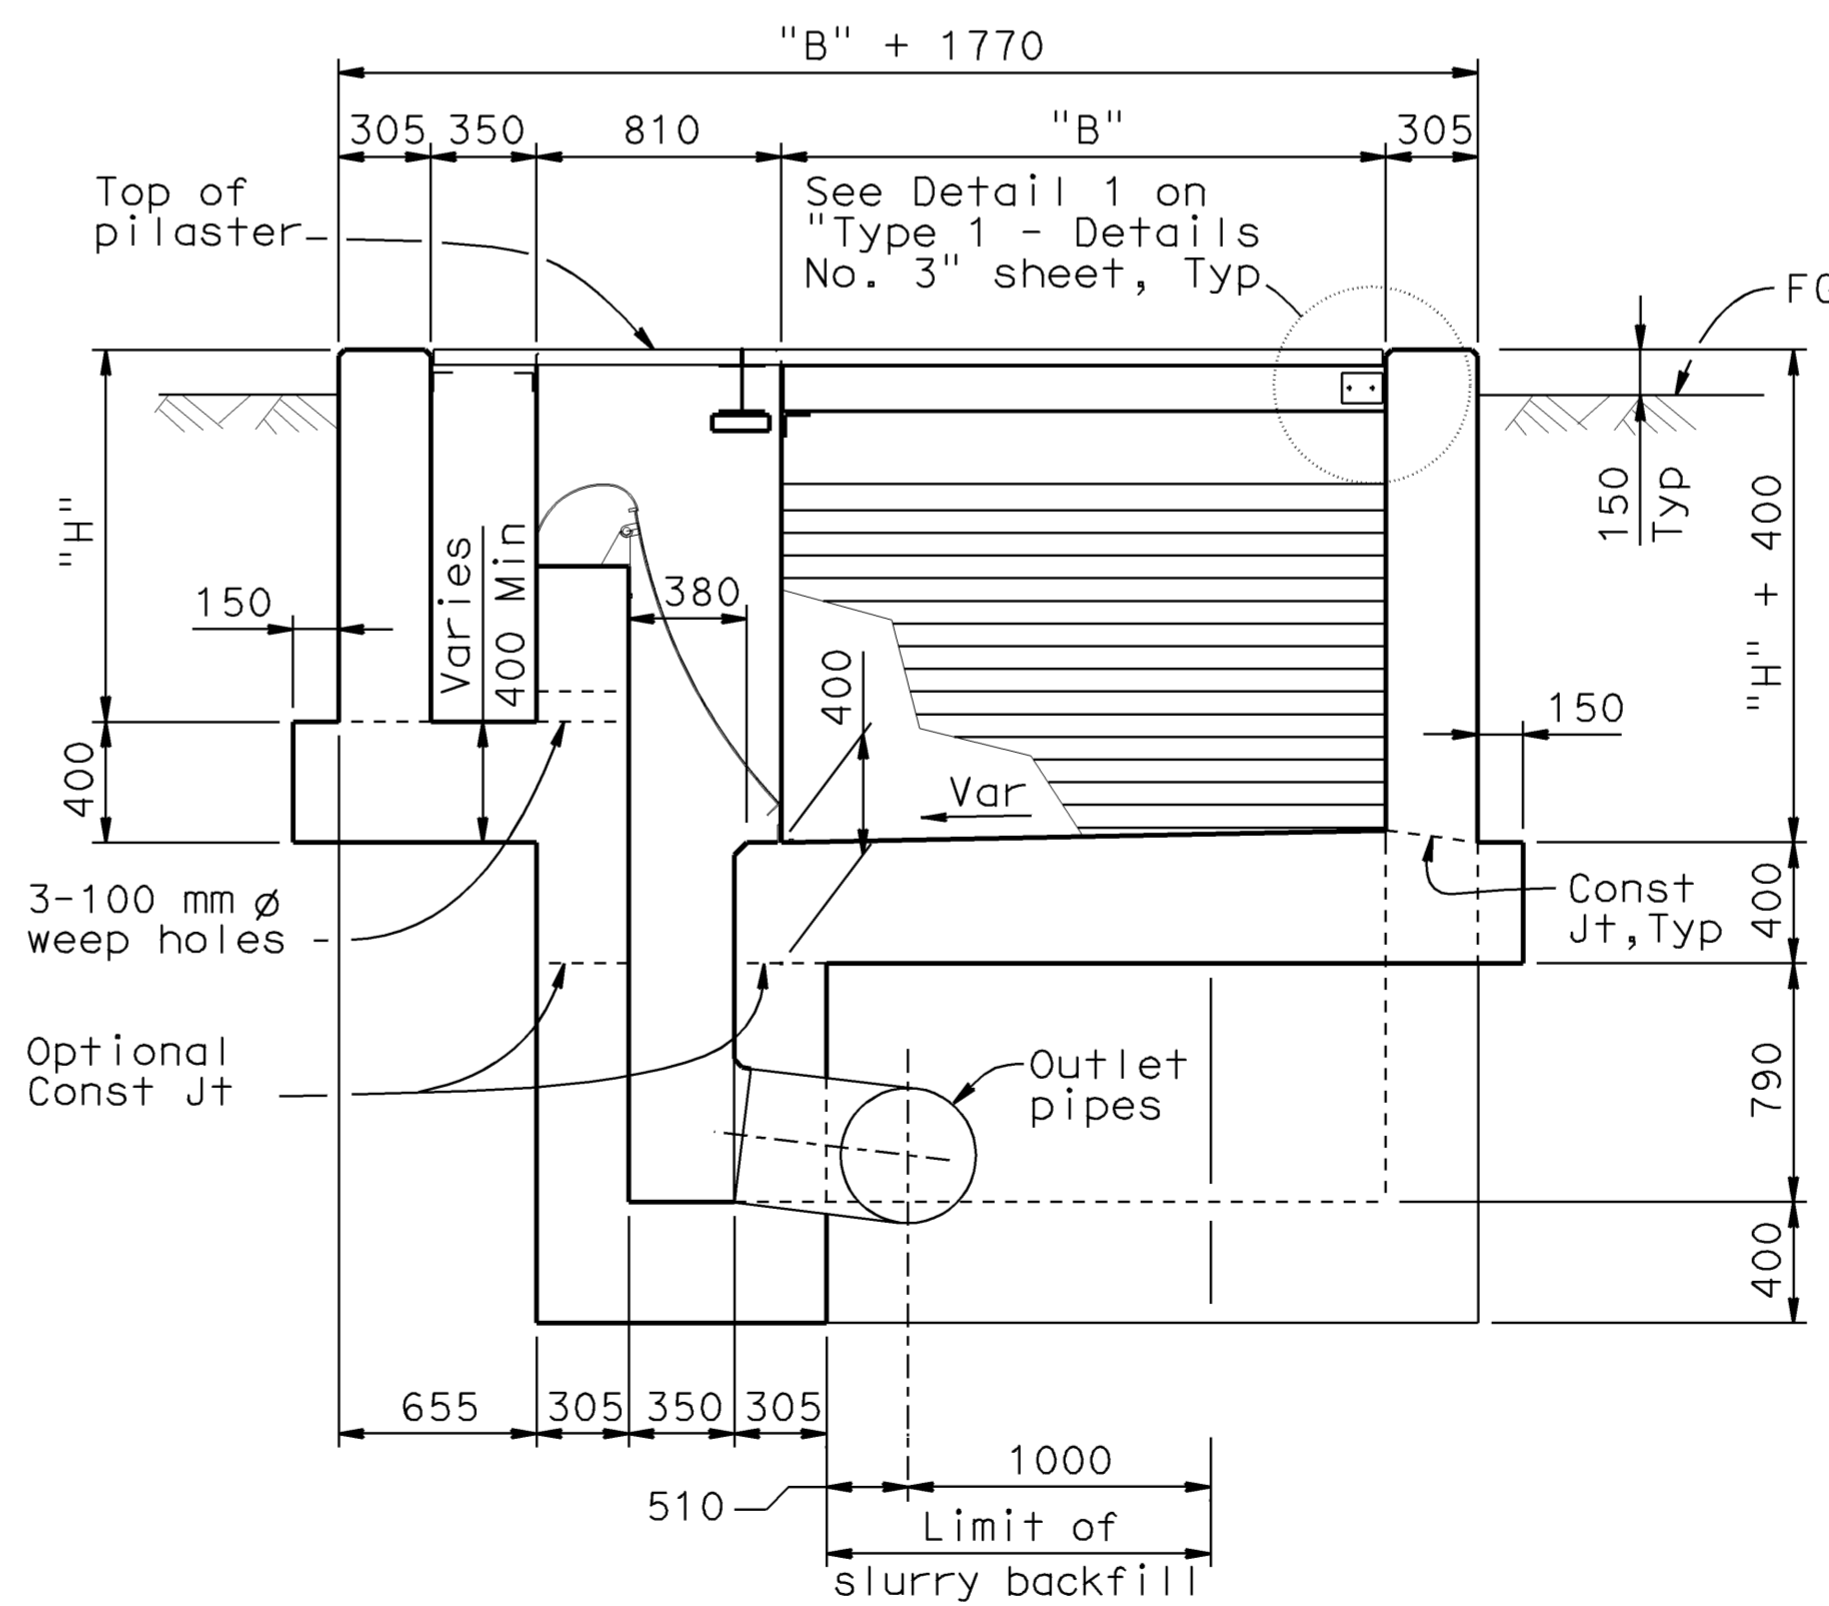- NOTES:
1. For weep hole details, see "Type 1 - Details No. 2" sheet.
 2. For Views C-C & D-D see "Type 1 - Details No. 2" sheet.
 3. For reinforcing details not shown see "Type 1 - Details No. 1" sheet.
 4. ✕ - FL elevations, see "Road Plans".
 5. For inlet and outlet pipe details not shown, see "Road Plans".

DESIGN DATA TABLE - TYPE 1 GSRD											
Screen Length (mm)	"A"	2000			3000			4000			
	"B"	2000			3000			4000			
	Total	4000			6000			8000			
Concrete Wall	Inlet Wall Height "H" (mm)	4000	3400	2800	4000	3400	2800	4000	3400	2800	
	"a" bars	#22 @ 150	#19 @ 150	#16 @ 150	#22 @ 150	#19 @ 150	#16 @ 150	#22 @ 150	#19 @ 150	#16 @ 150	
	"b" bars	#22 @ 300	#19 @ 300	#16 @ 300	#22 @ 300	#19 @ 300	#16 @ 300	#22 @ 300	#19 @ 300	#16 @ 300	
	"c" bars	#25 @ 150	#22 @ 150	#19 @ 150	#25 @ 150	#22 @ 150	#19 @ 150	#25 @ 150	#22 @ 150	#19 @ 150	
Footing	"d" bars	#25 @ 300	#22 @ 300	#19 @ 300	#25 @ 300	#22 @ 300	#19 @ 300	#25 @ 300	#22 @ 300	#19 @ 300	
	"e" bars	#16 @ 200	#19 @ 300	#16 @ 300	#16 @ 200	#19 @ 300	#16 @ 300	#16 @ 200	#19 @ 300	#16 @ 300	
	"f" bars	#19 @ 150	#16 @ 150	#16 @ 150	#19 @ 150	#16 @ 150	#16 @ 150	#19 @ 150	#16 @ 150	#16 @ 150	
	"g" bars	#19 @ 200	#19 @ 300	#19 @ 300	#19 @ 200	#19 @ 300	#19 @ 300	#19 @ 200	#19 @ 300	#19 @ 300	
Grating	Supporting Beam	W Section	W150x22.5			W150x22.5			W150x29.8		
		C Section	NA			NA			C230x19.9		

TYPE 1L - LEVEL SIDE WALL CONFIGURATION

WATER POLLUTION CONTROL DETAILS
WD-22

ALL DIMENSIONS ARE IN MILLIMETERS UNLESS OTHERWISE SHOWN

RELEASE DATE	DESIGN BY	BY	CHECKED	BY
---	D. Dunrud	D. Dunrud	J&P Peterson	J&P Peterson
FILE NO.	DETAILS BY	BY	CHECKED	BY
---	J&P Peterson	J&P Peterson	J&P Peterson	J&P Peterson
	SUBMITTED BY	BY	DRAWING DATE	
	D. Forester	D. Forester	02/07	

STATE OF CALIFORNIA
DEPARTMENT OF TRANSPORTATION


DIVISION OF ENGINEERING SERVICES

BRIDGE NO. _____

MILE POST _____

GROSS SOLIDS REMOVAL DEVICE

TYPE 1 - LAYOUT NO. 1

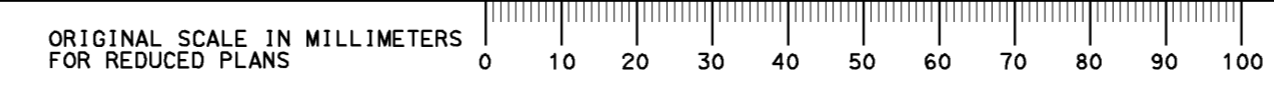

CU 07314
EA 121841

REVISION DATES (PRELIMINARY STAGE ONLY)	SHEET	OF
	11	32

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DGN FILE => 7121841h022.dgn

DATE PLOTTED => 12-JUN-2009 08:15




B11-47



DIST.	COUNTY	ROUTE	MILE POST TOTAL PROJECT	SHEET NO.	TOTAL SHEETS
07	LA	5	42.8/47.3	98	1073

REGISTERED ENGINEER - CIVIL
 6-8-09
 PLANS APPROVAL DATE
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REGISTERED PROFESSIONAL ENGINEER
 DOUGLAS DUNRUD
 No. 47240
 Exp. 12/31/09
 CIVIL
 STATE OF CALIFORNIA

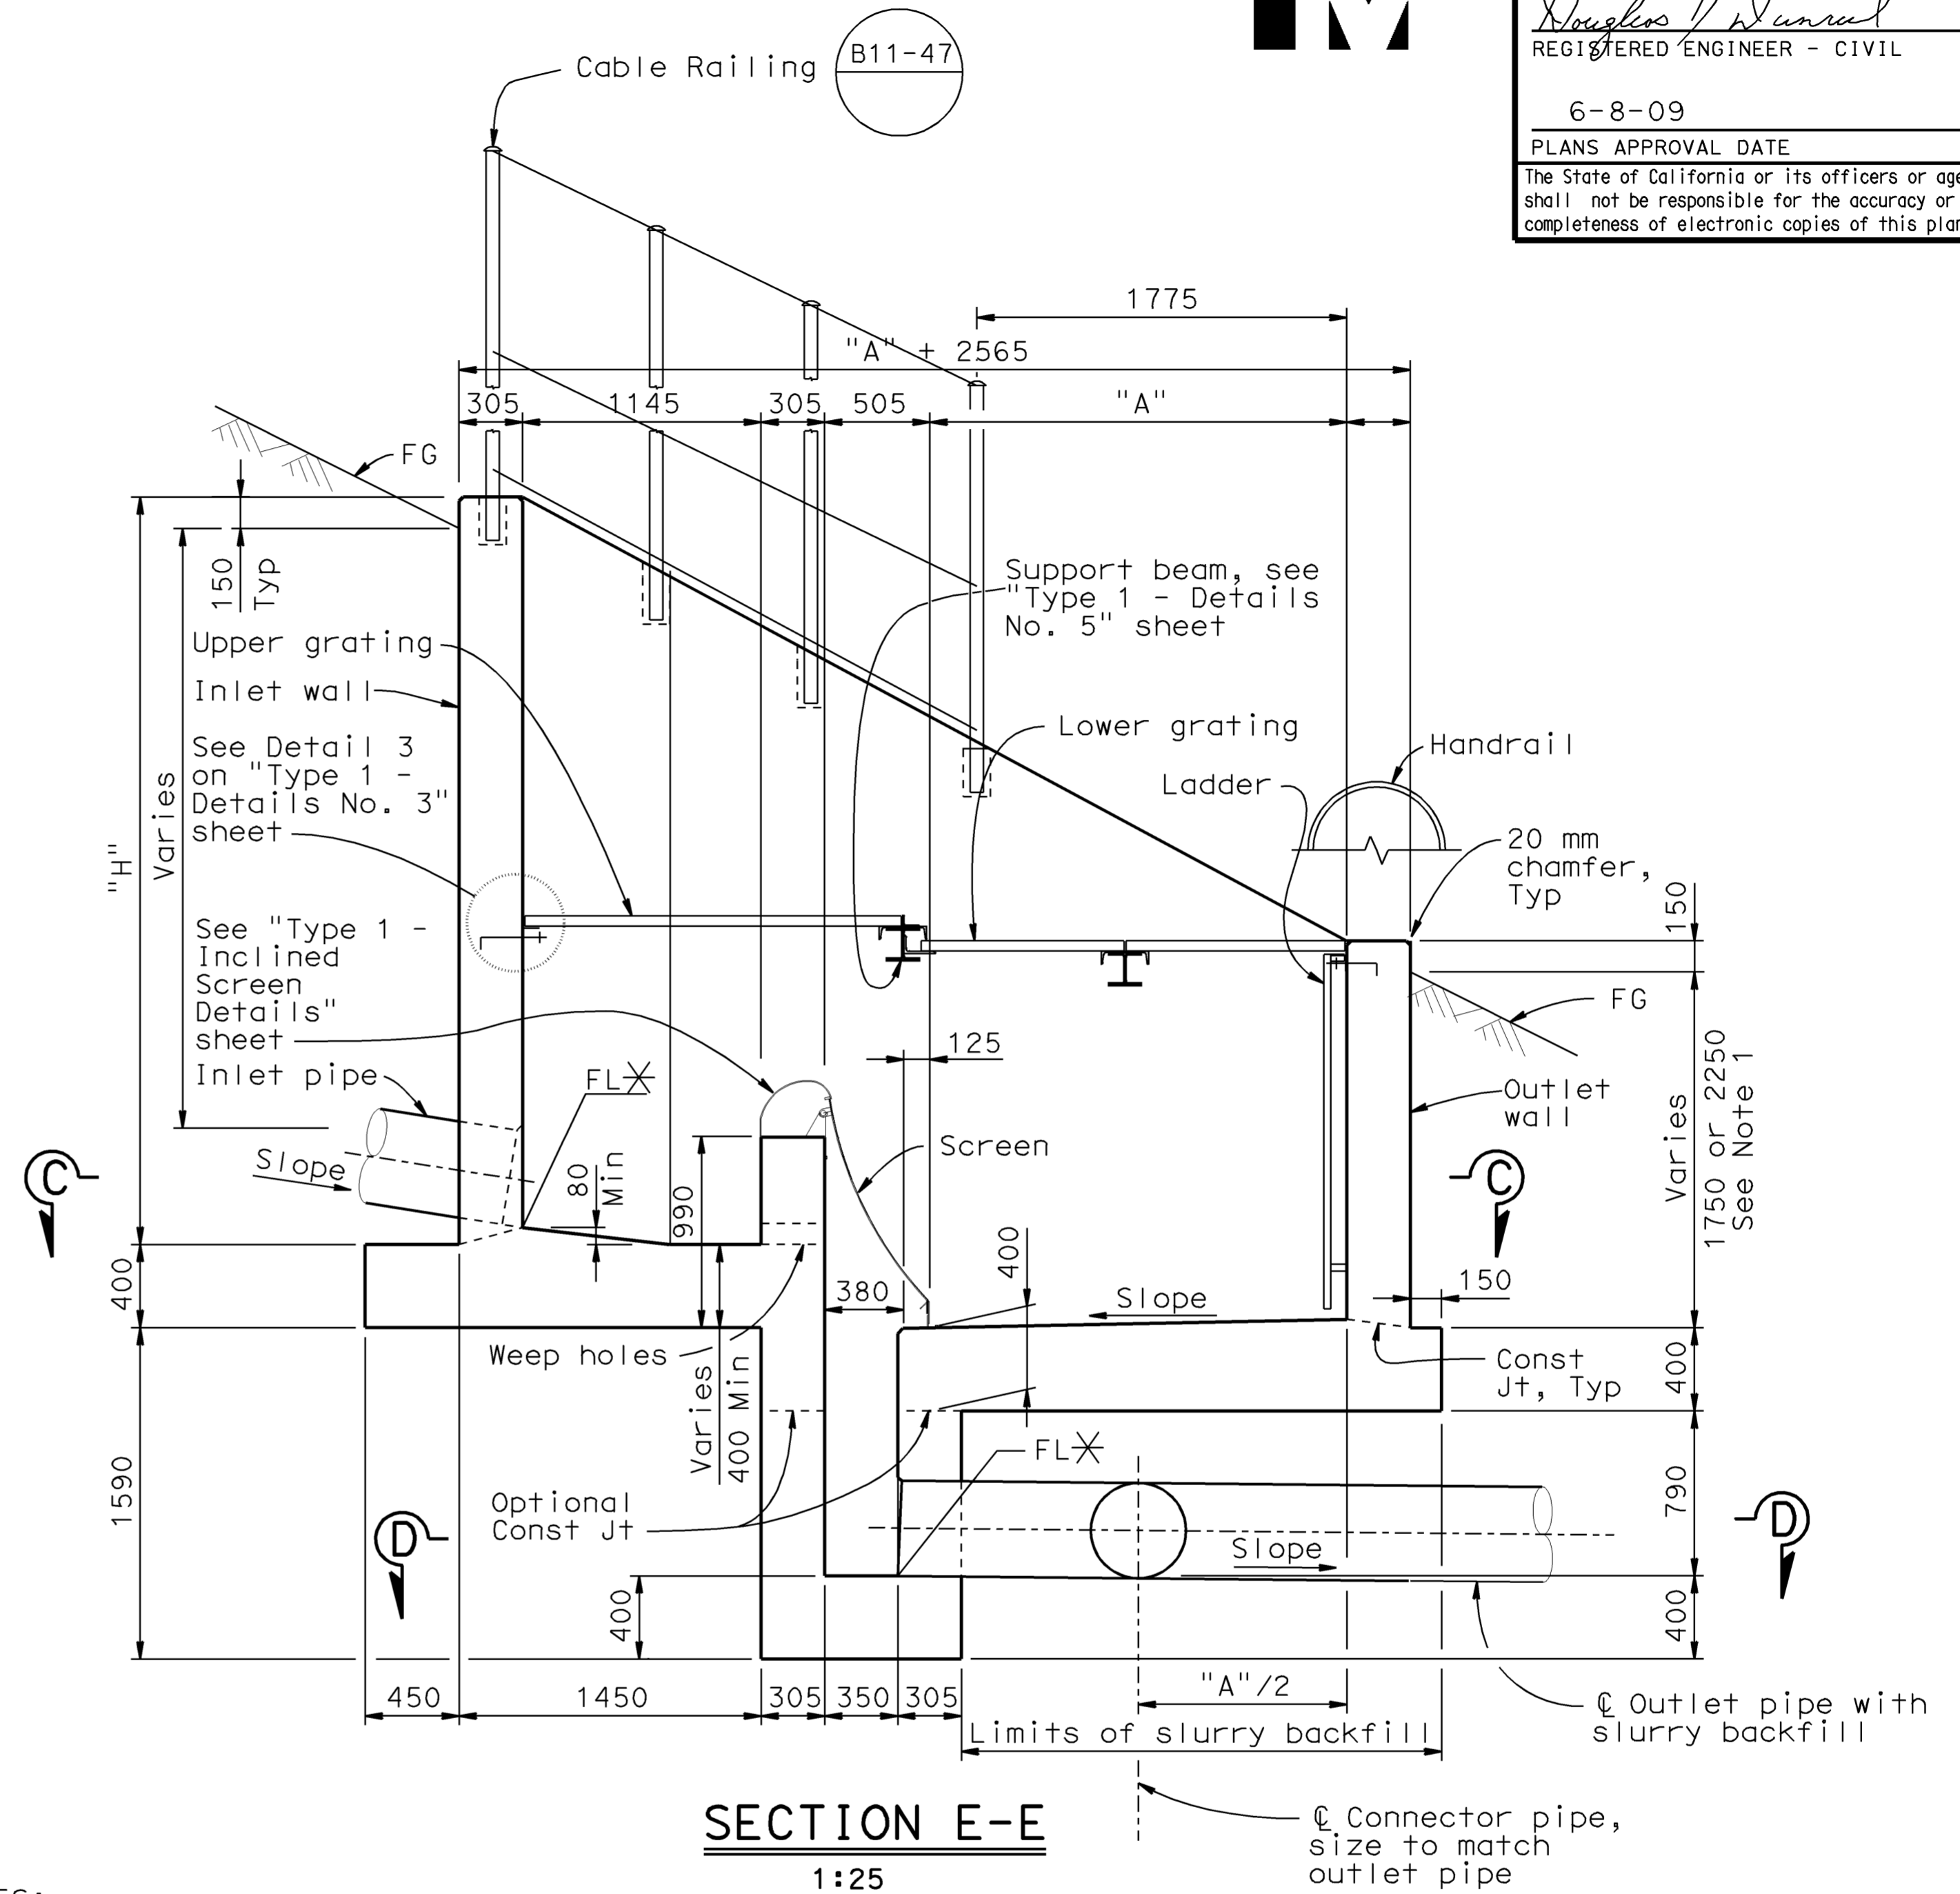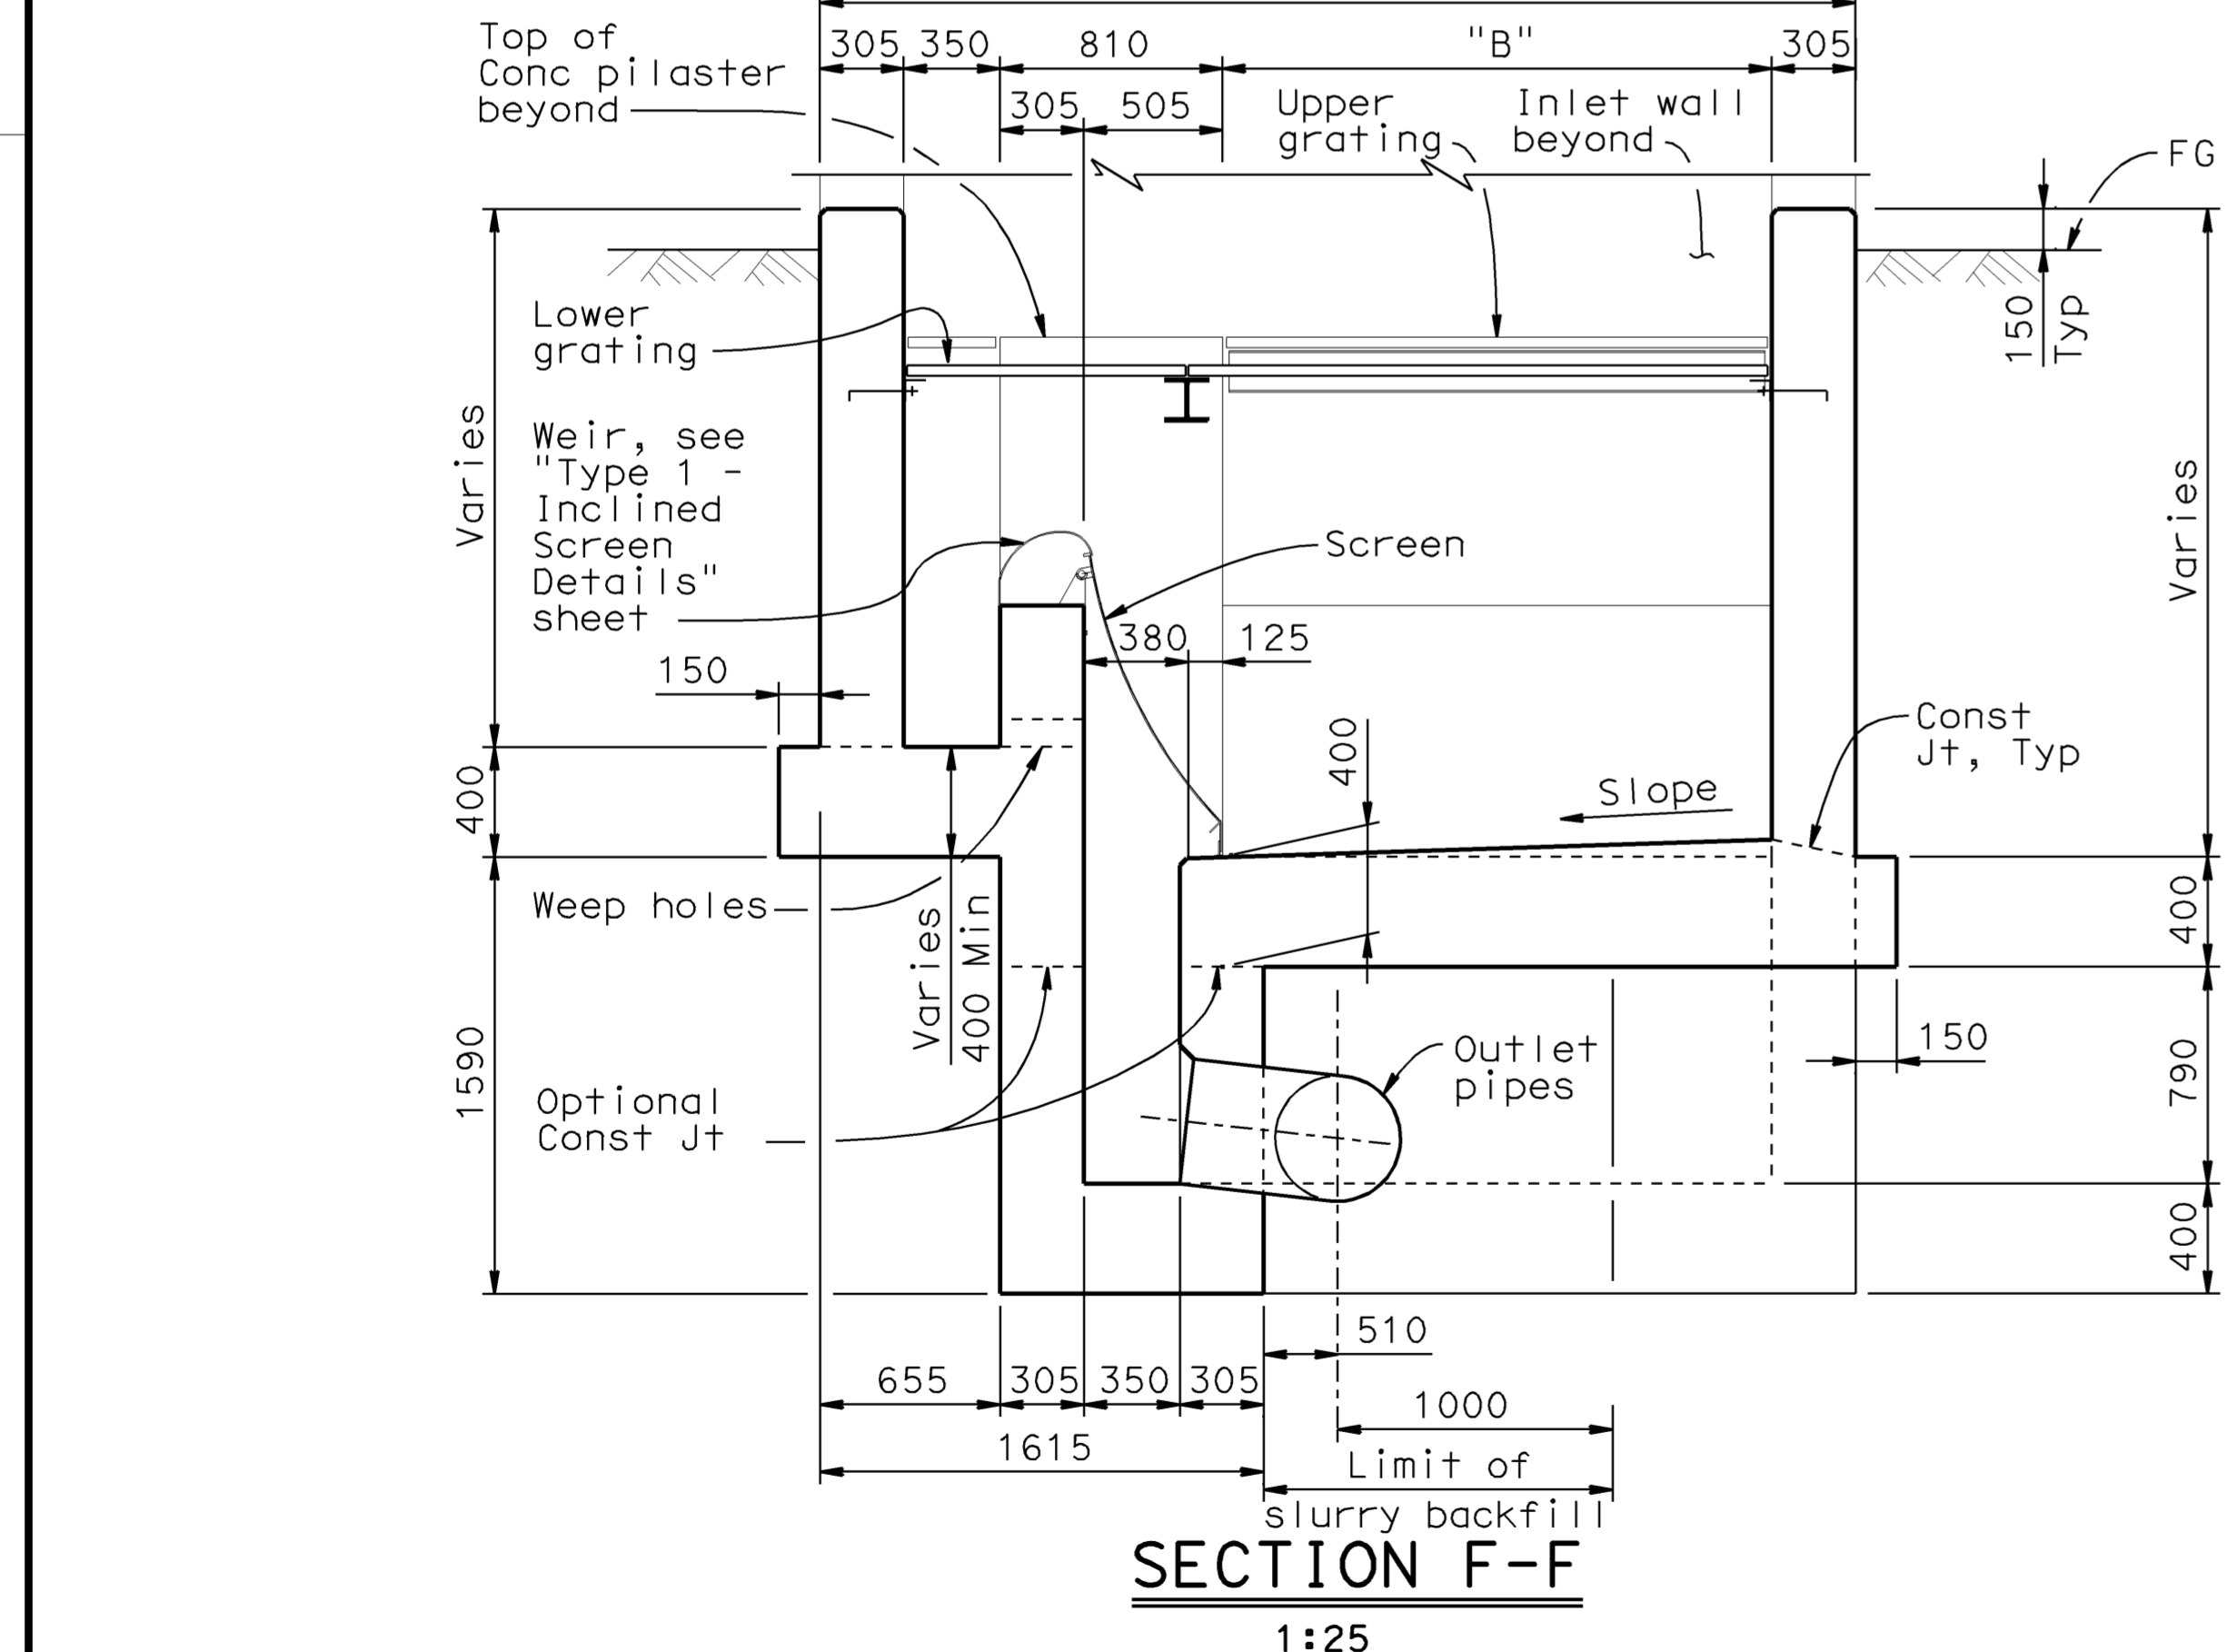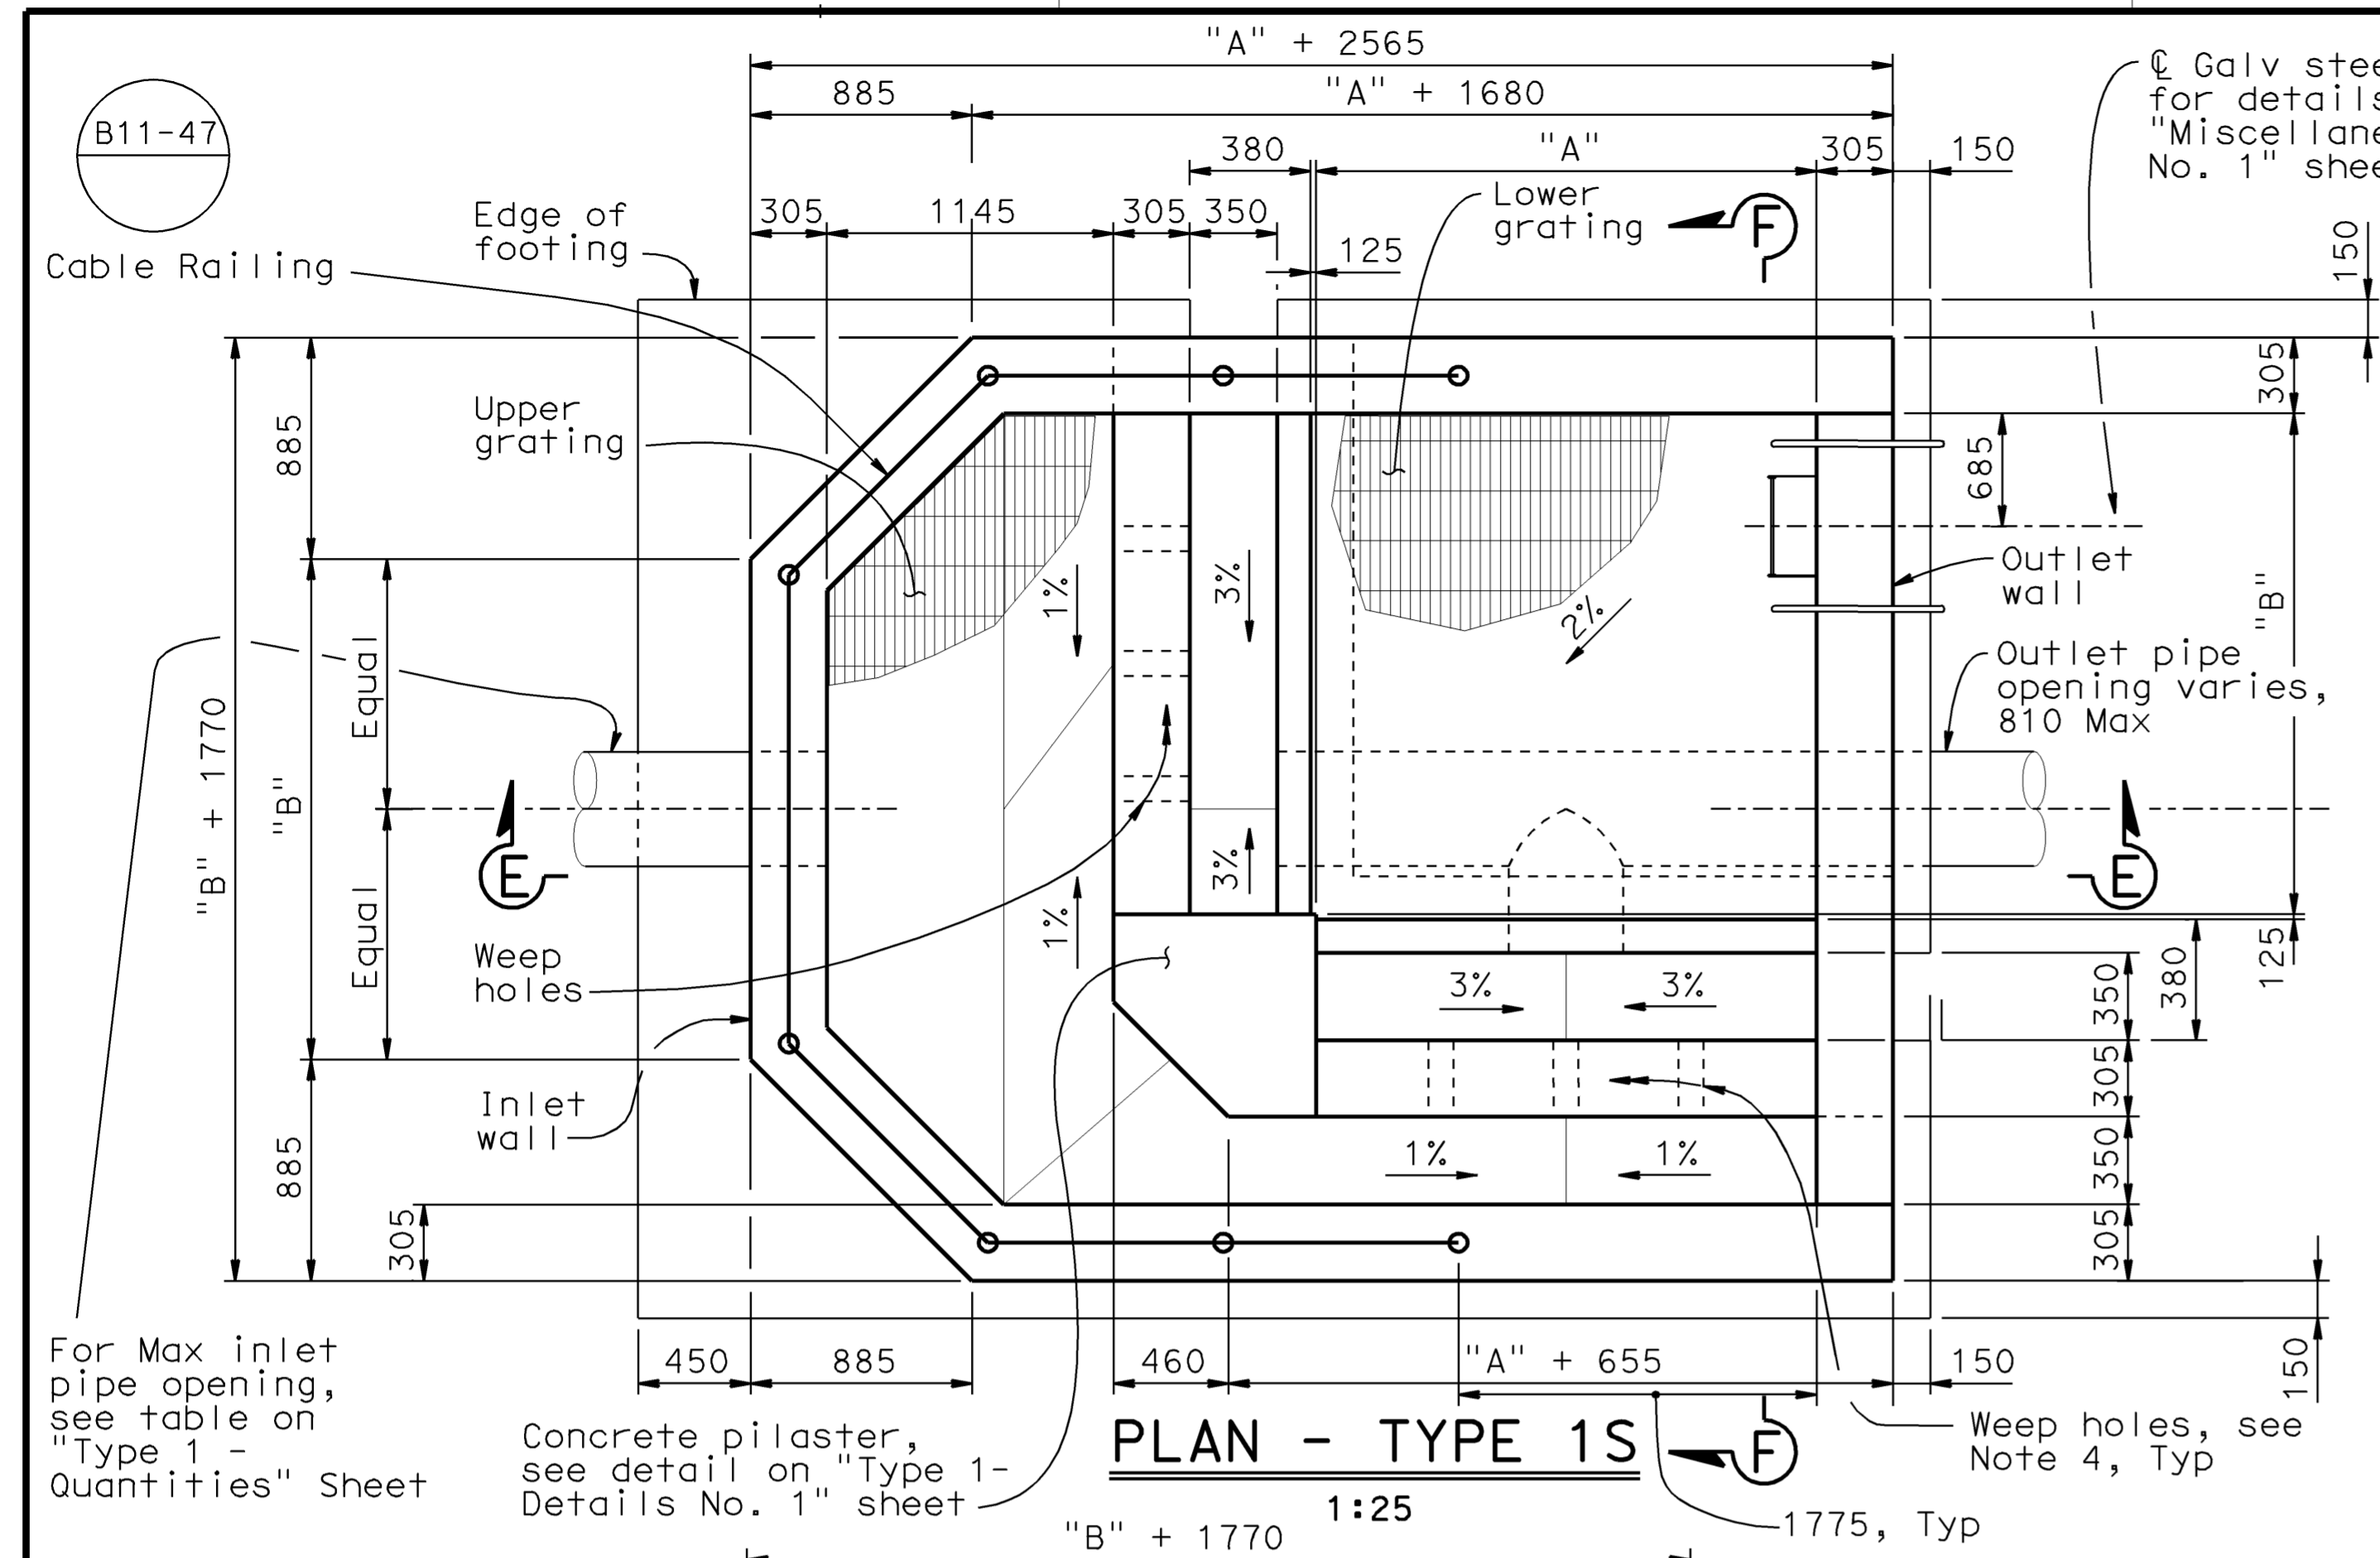

- NOTES:
1. The Engineer to determine outlet wall height according to configuration of existing grade. See Road Plans for details.
 2. See "Type 1- Details No. 2" sheet for Views C-C & D-D.
 3. For reinforcing details see "Type 1 - Details No. 1" sheet.
 4. For weep hole details, see "Type 1 - Details No. 2" sheet.
 5. * - FL elevation, see Road Plans.
 6. For quantities and additional GSRD data, see "Type 1 - Quantities" sheet.
 7. For inlet and outlet pipe details not shown, see "Road Plans".

WATER POLLUTION CONTROL DETAILS
WD-23

RELEASE DATE	DESIGN BY	CHECKED
---	D. Dunrud	J&P Peterson
FILE NO.	DETAILS BY	CHECKED
---	J&P Peterson	J&P Peterson
	SUBMITTED BY	DRAWING DATE
	D. Forester	02/07

STATE OF CALIFORNIA
 DEPARTMENT OF TRANSPORTATION

DIVISION OF ENGINEERING SERVICES

BRIDGE NO.	GROSS SOLIDS REMOVAL DEVICE
MILE POST	
TYPE 1 - LAYOUT NO. 2	

ORIGINAL SCALE IN MILLIMETERS FOR REDUCED PLANS

CU 07314
 EA 121841

DISREGARD PRINTS BEARING EARLIER REVISION DATES	REVISION DATES (PRELIMINARY STAGE ONLY)	SHEET 12 OF 32
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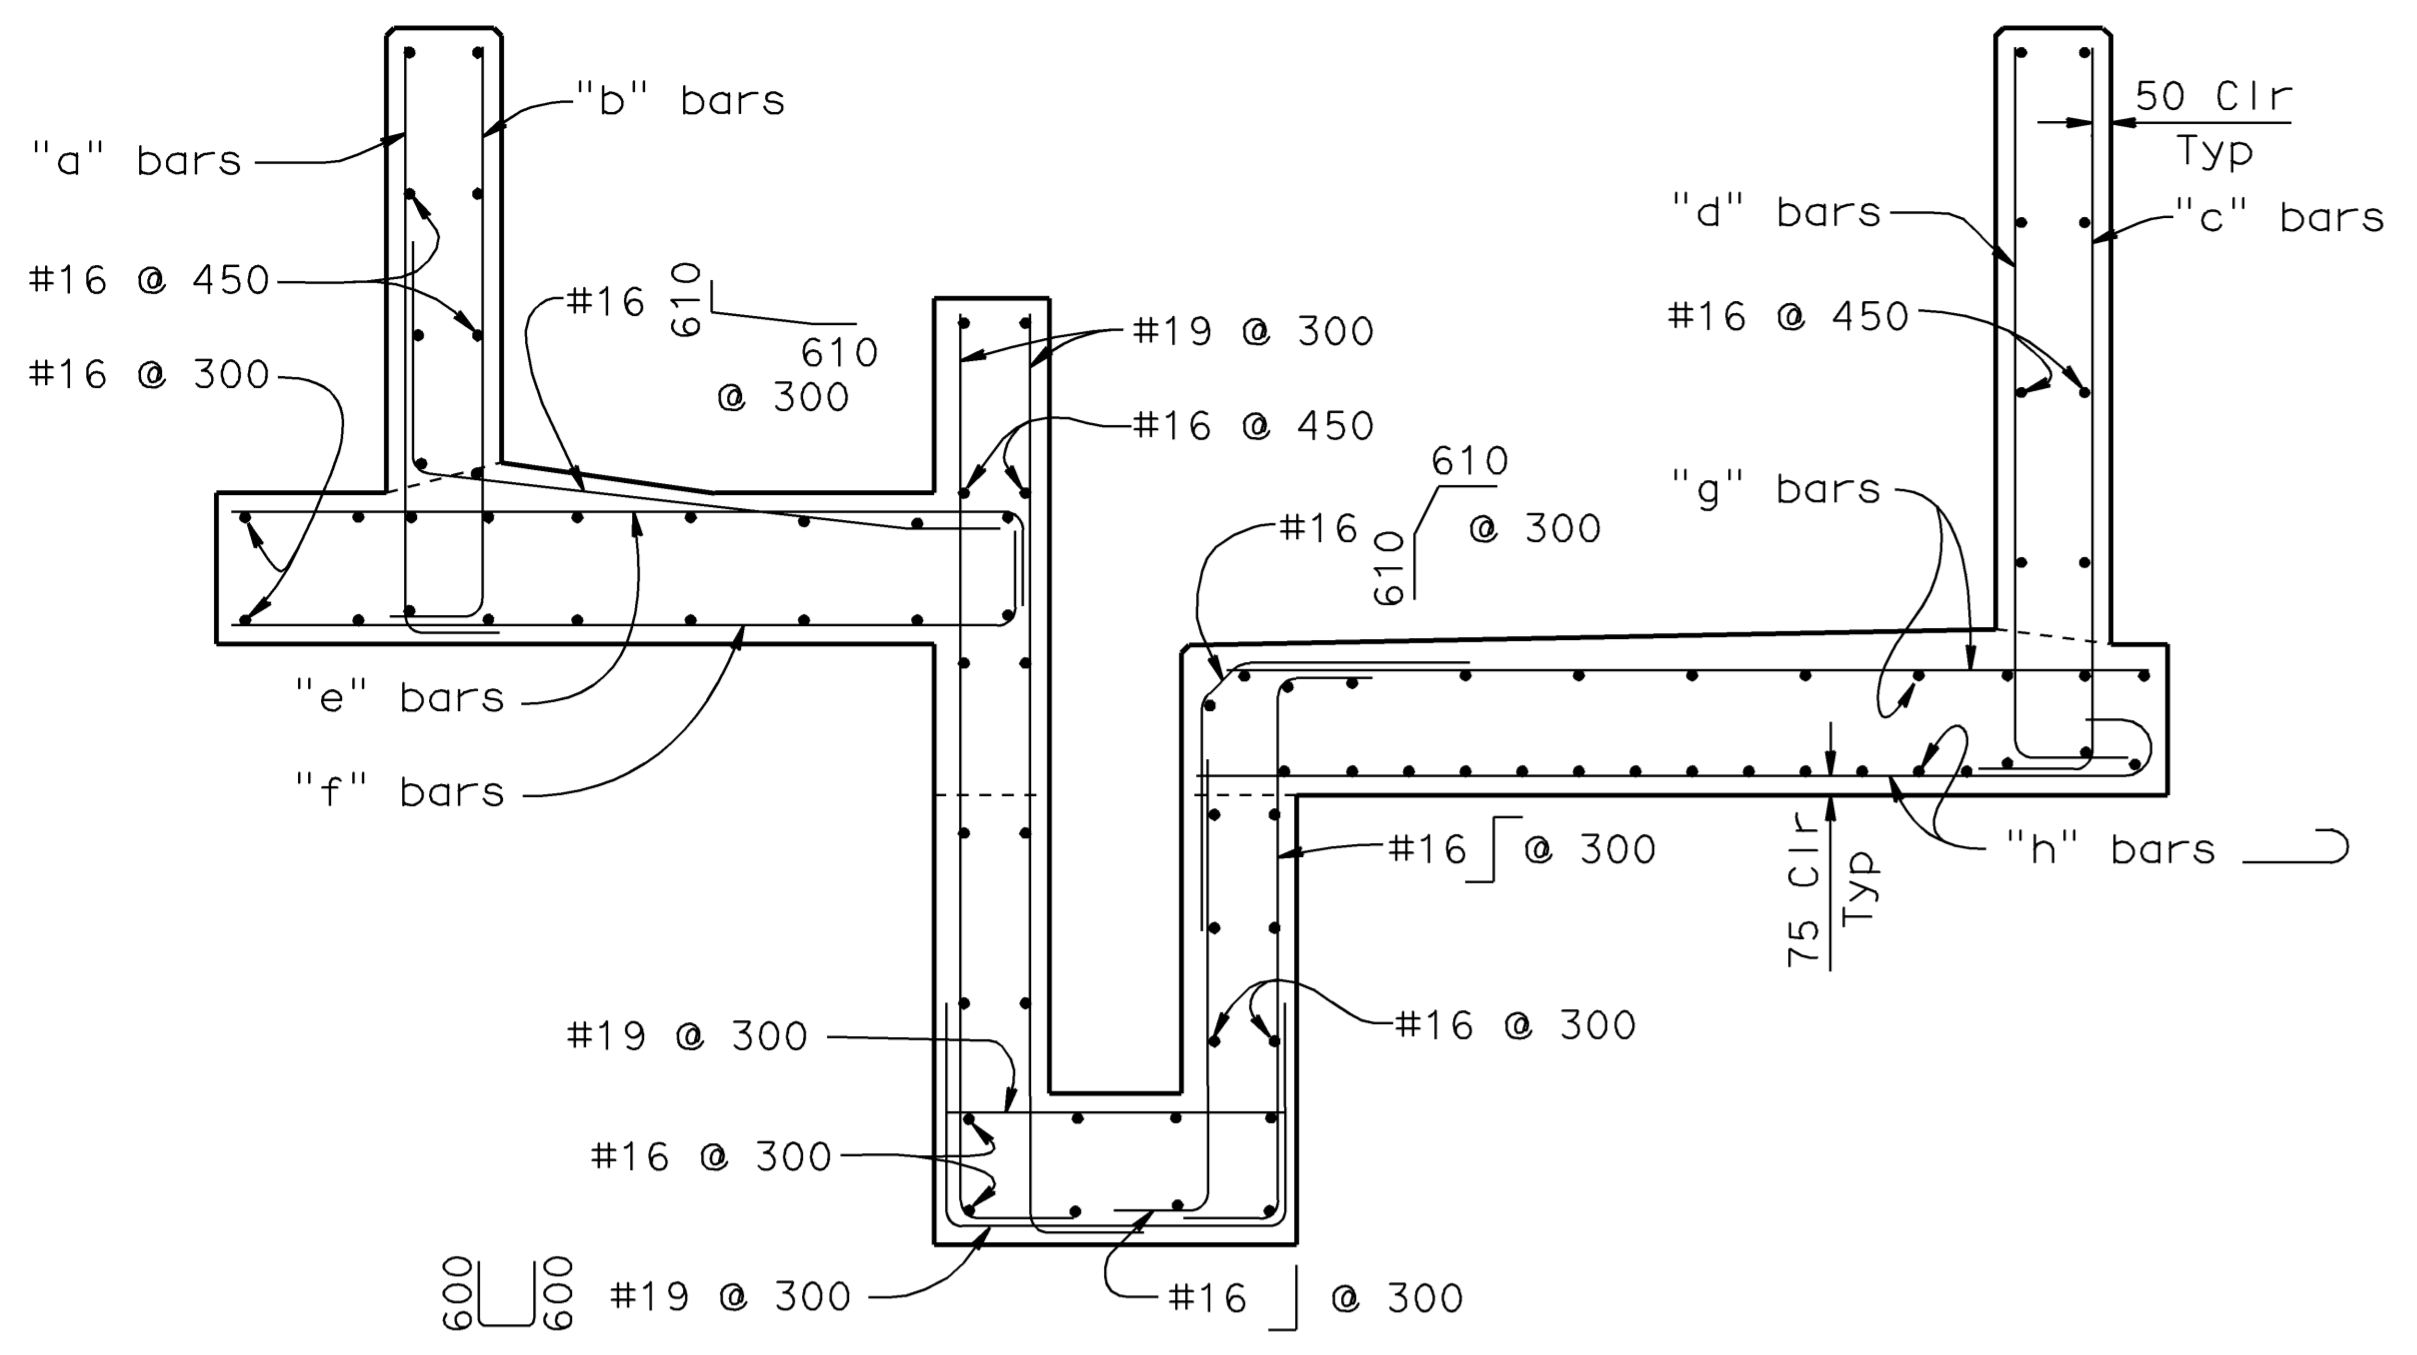
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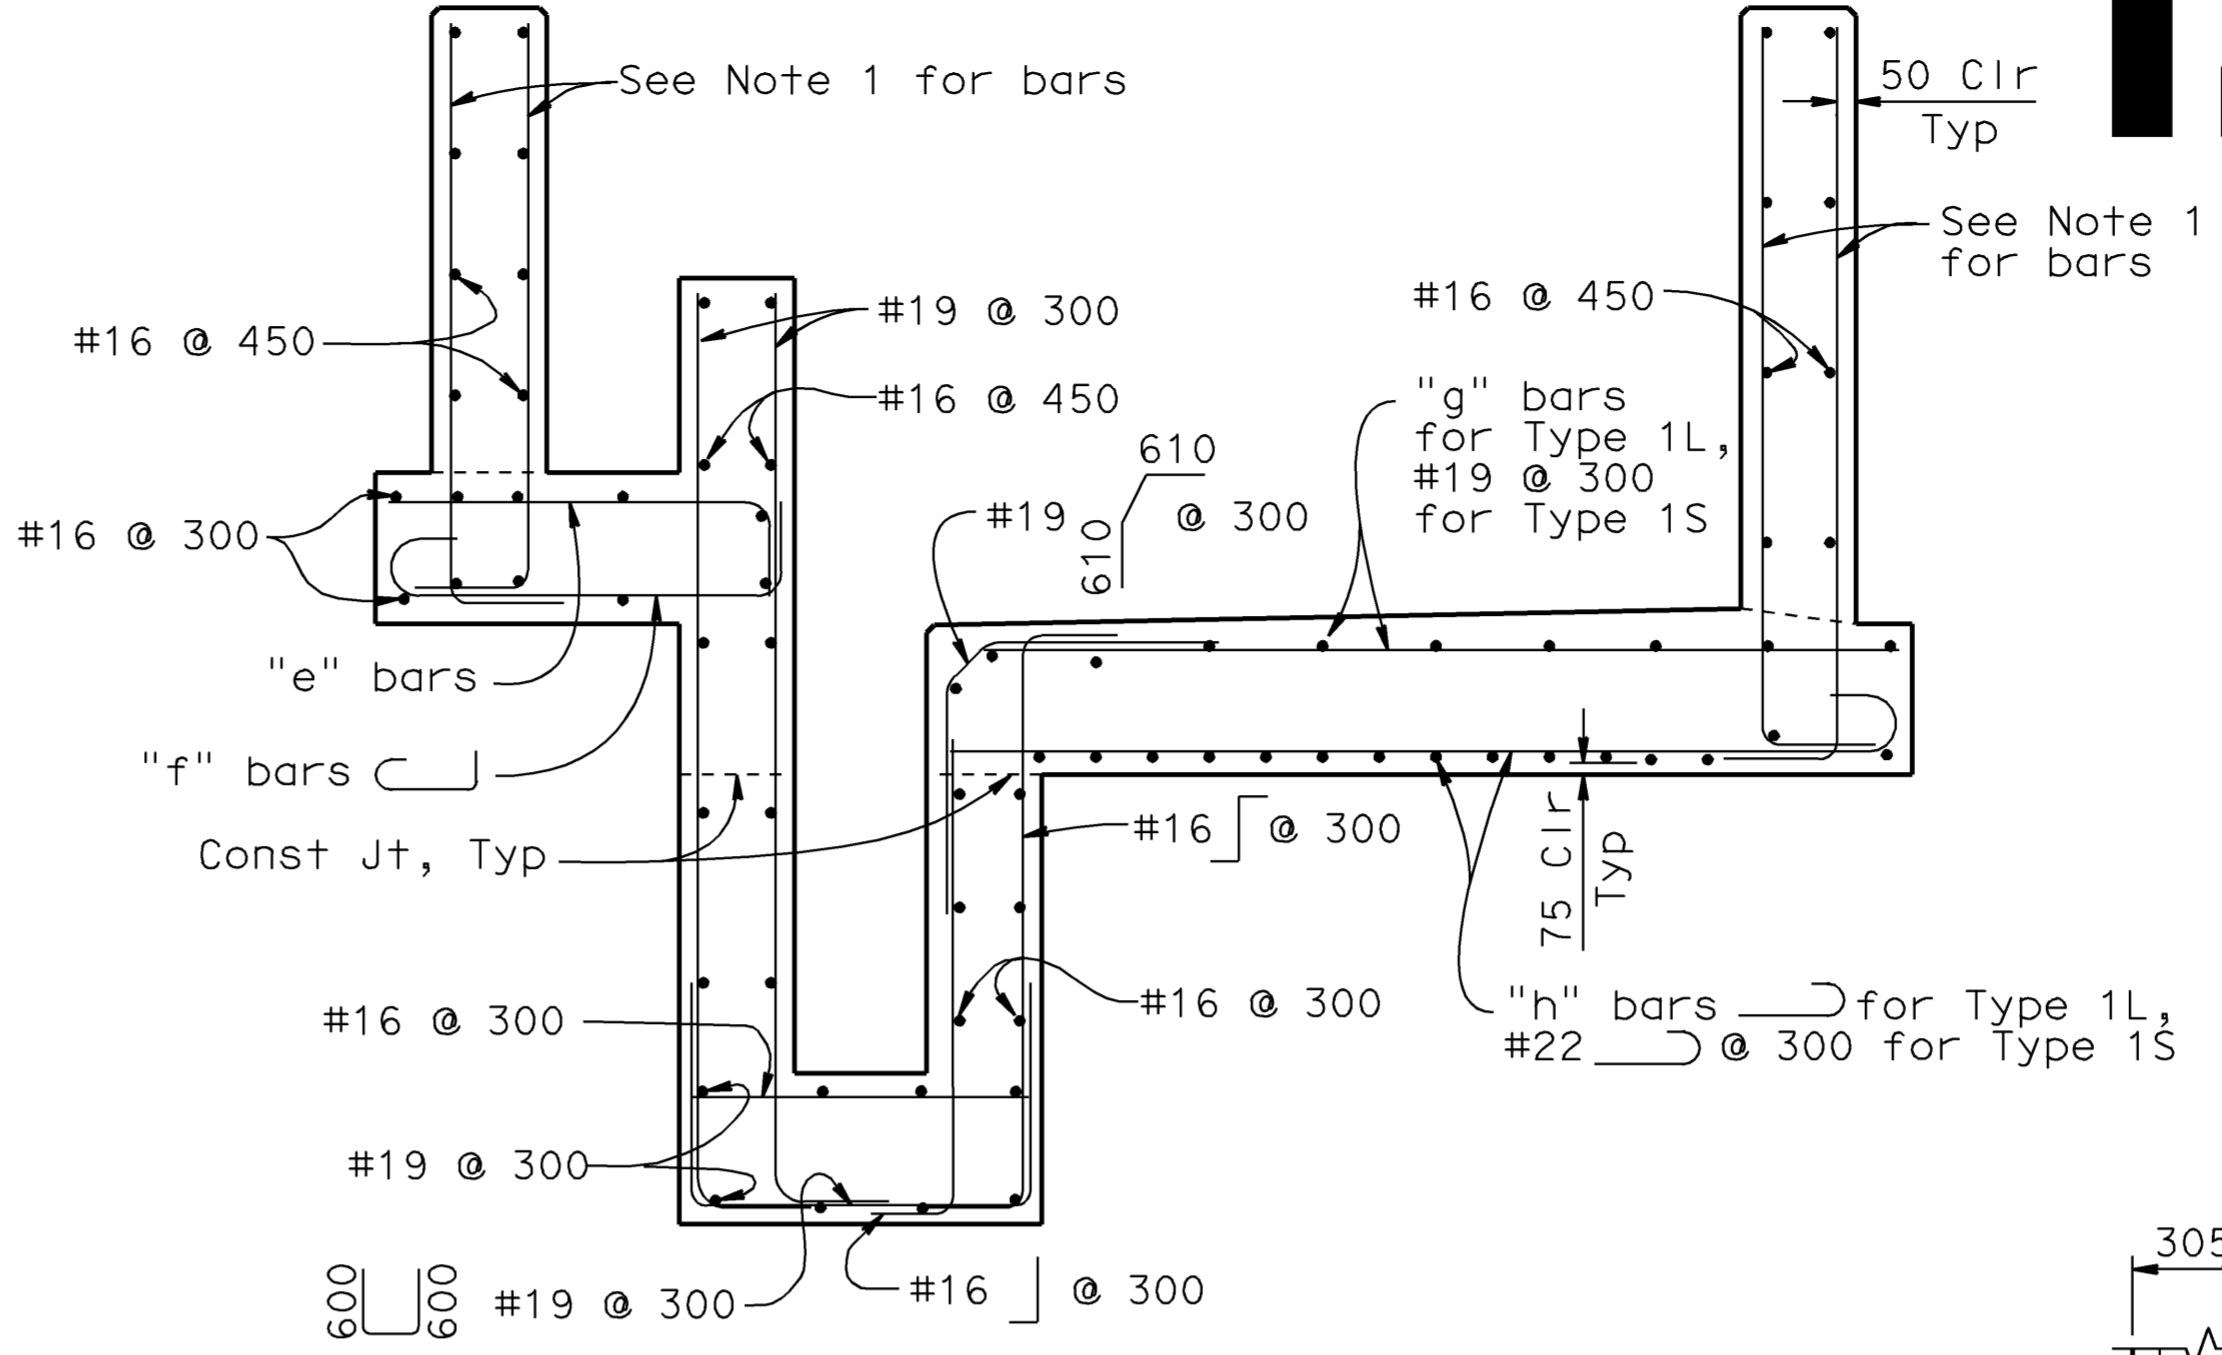
DIST.	COUNTY	ROUTE	MILE POST TOTAL PROJECT	SHEET NO.	TOTAL SHEETS
07	LA	5	42.8/47.3	99	1073

REGISTERED ENGINEER - CIVIL
 DOUGLAS DUNRUD
 No. 47240
 Exp. 12/31/09
 CIVIL
 STATE OF CALIFORNIA

6-8-09
 PLANS APPROVAL DATE
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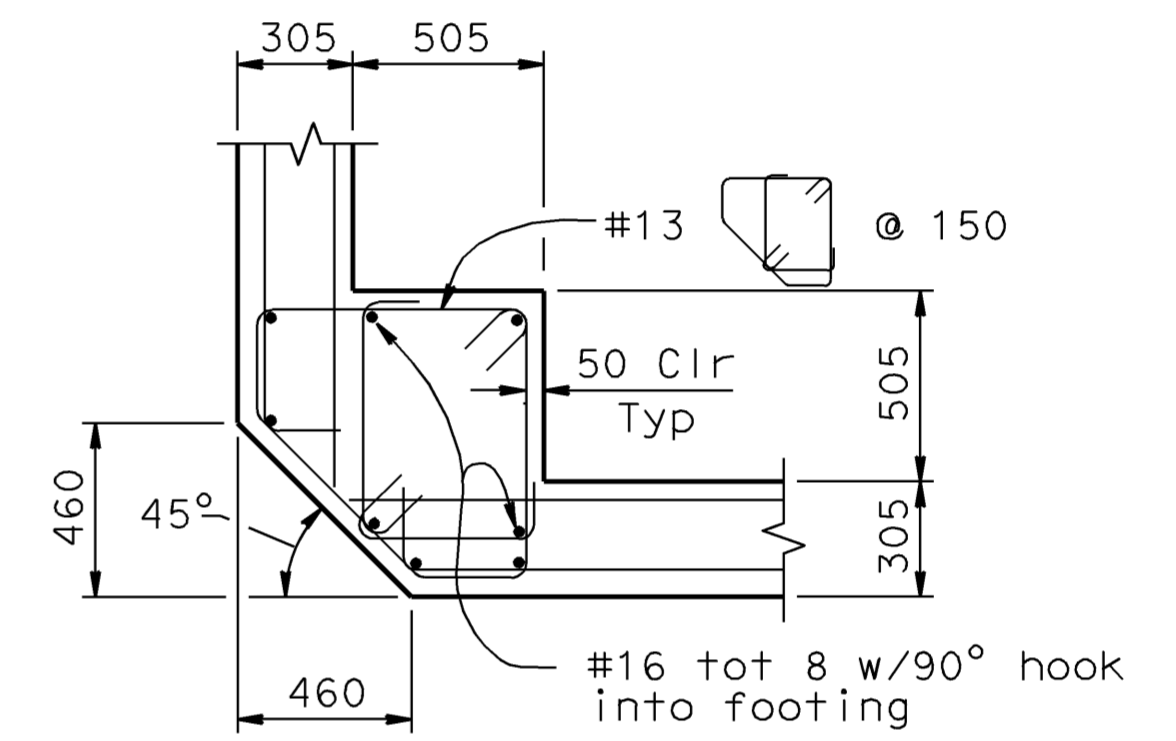


SECTION A-A - REINF DETAIL
1:20




SECTION B-B - REINF DETAIL
Section B-B of Type 1L shown, Section F-F of Type 1S similar
1:20


NOTE:
Use #16 @ 300 when wall height is 2500 or below. Use "a" and "b" bars shown in the table when wall height exceeds 2500. "a" bars indicate exterior bars, "b" bars indicate interior bars.



PILASTER DETAIL
1:20

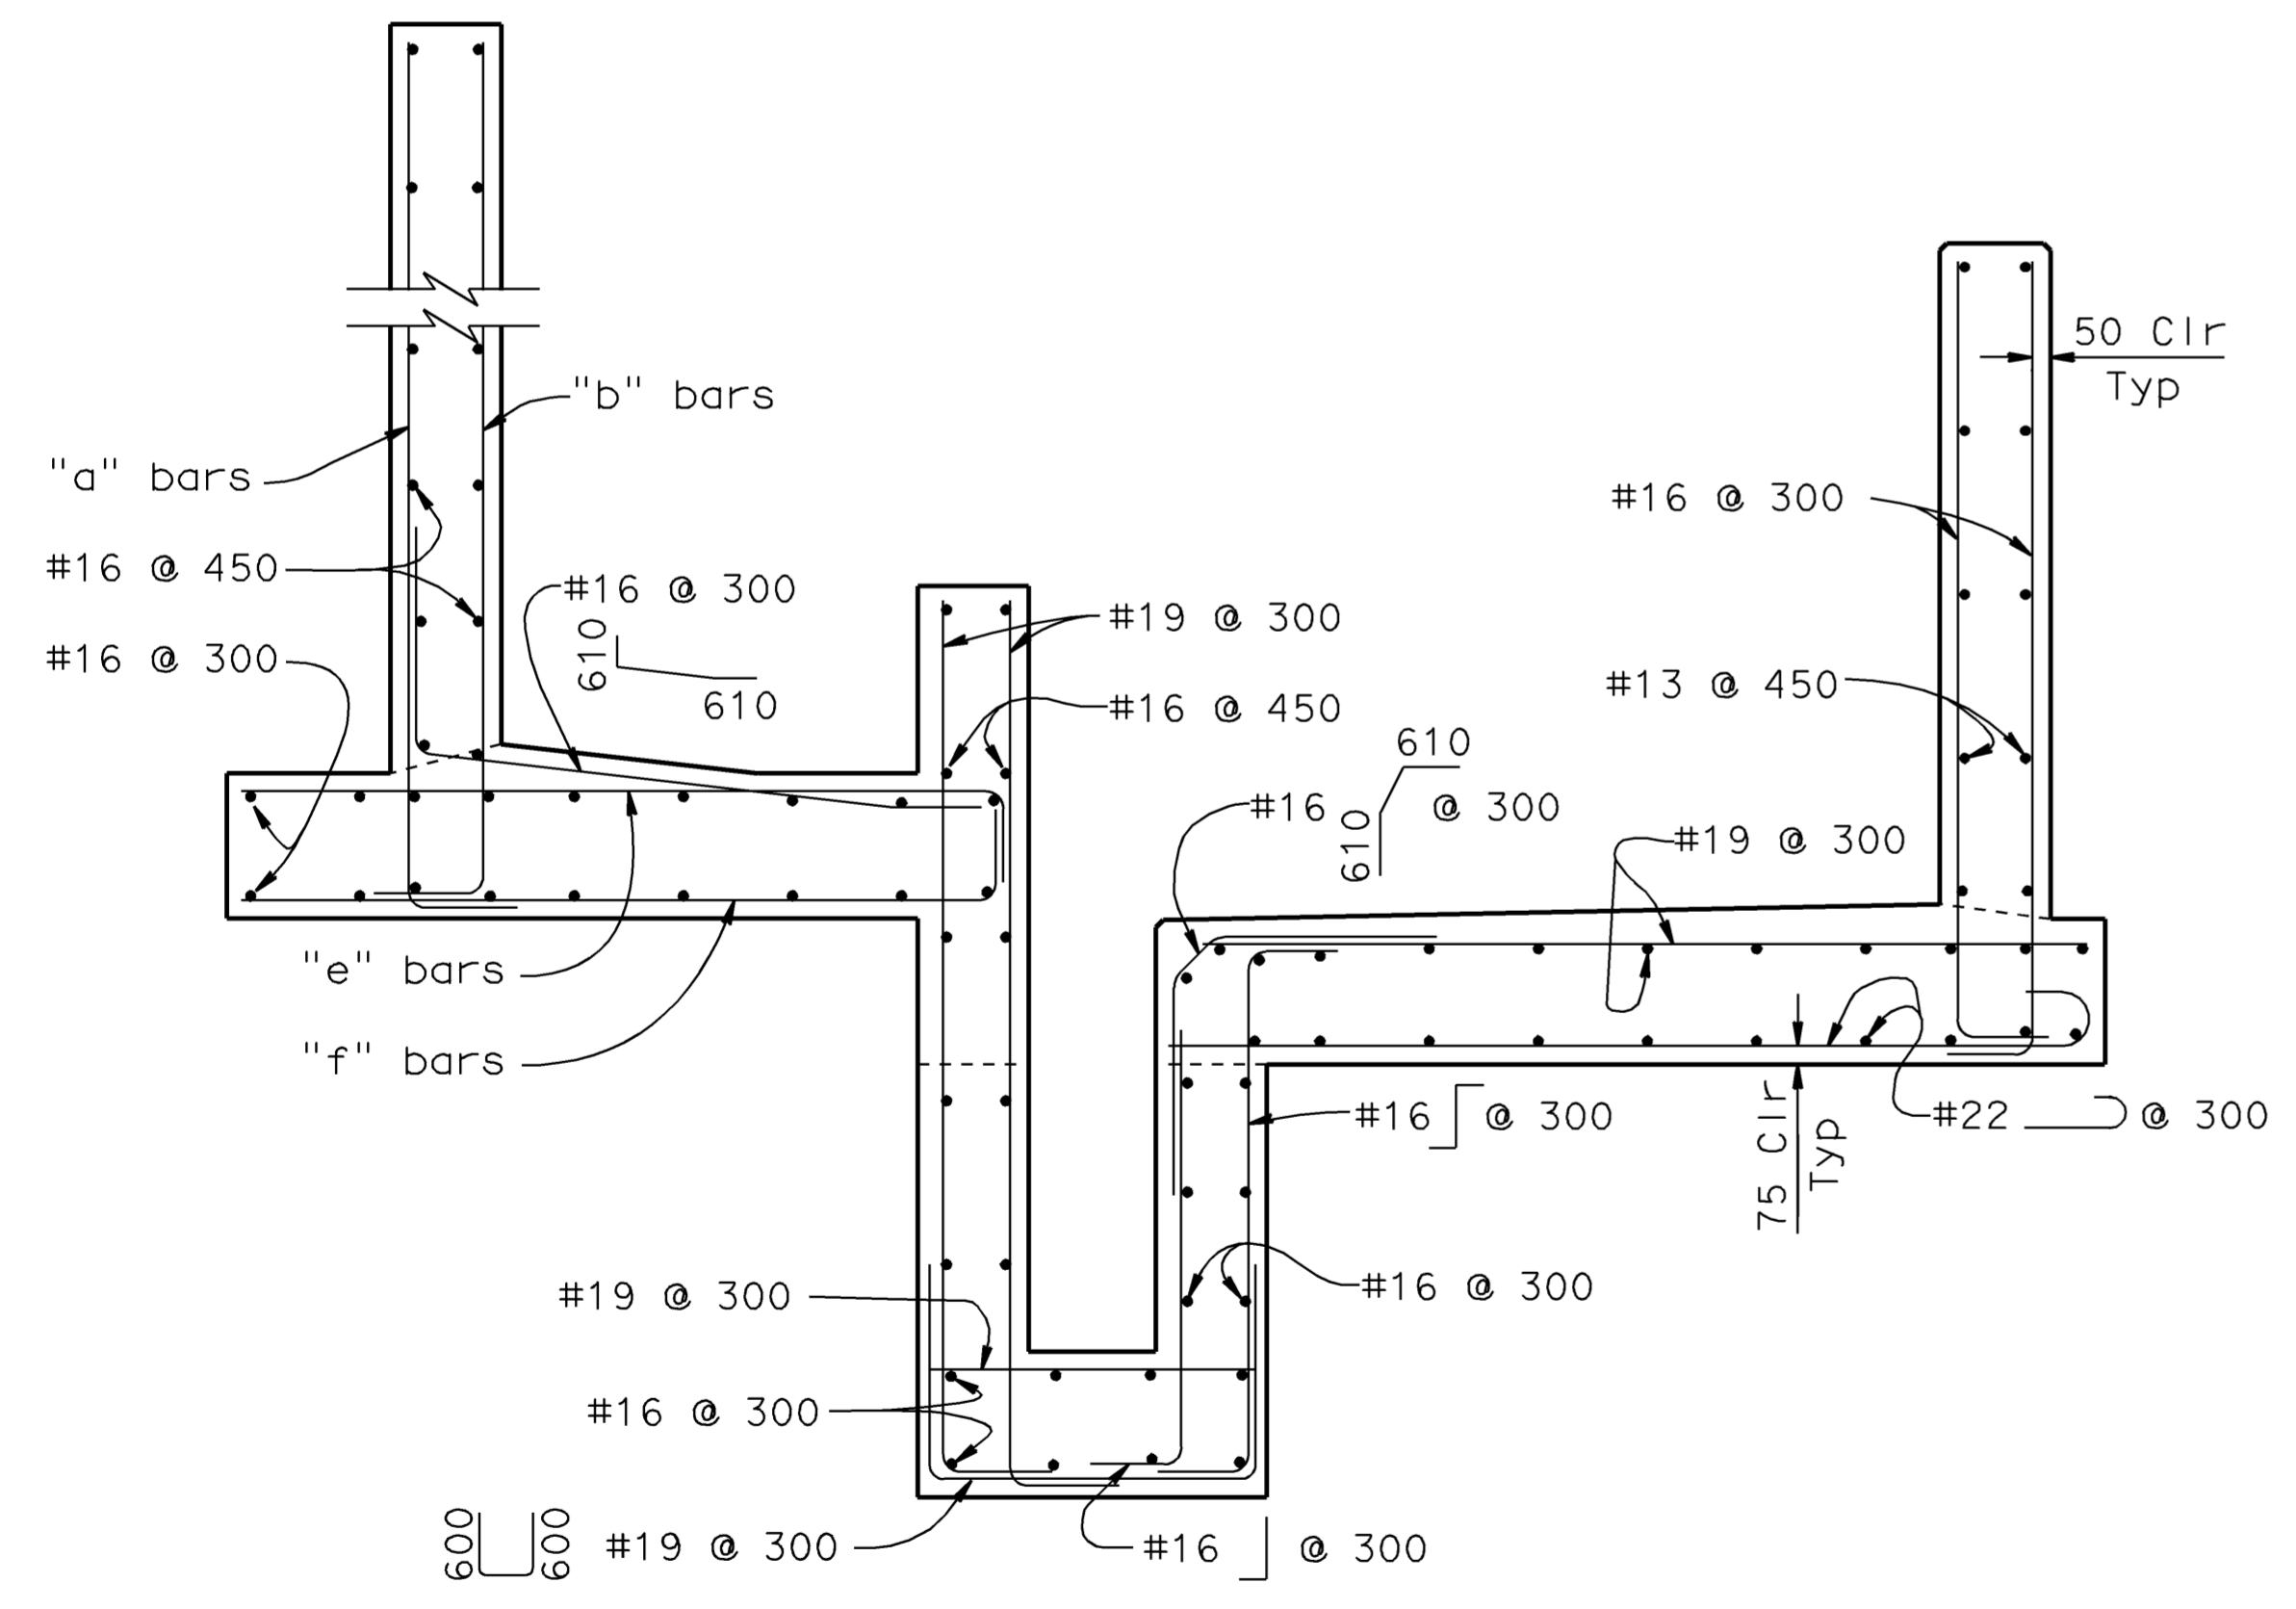

SECTION E-E - REINF DETAIL
1:20

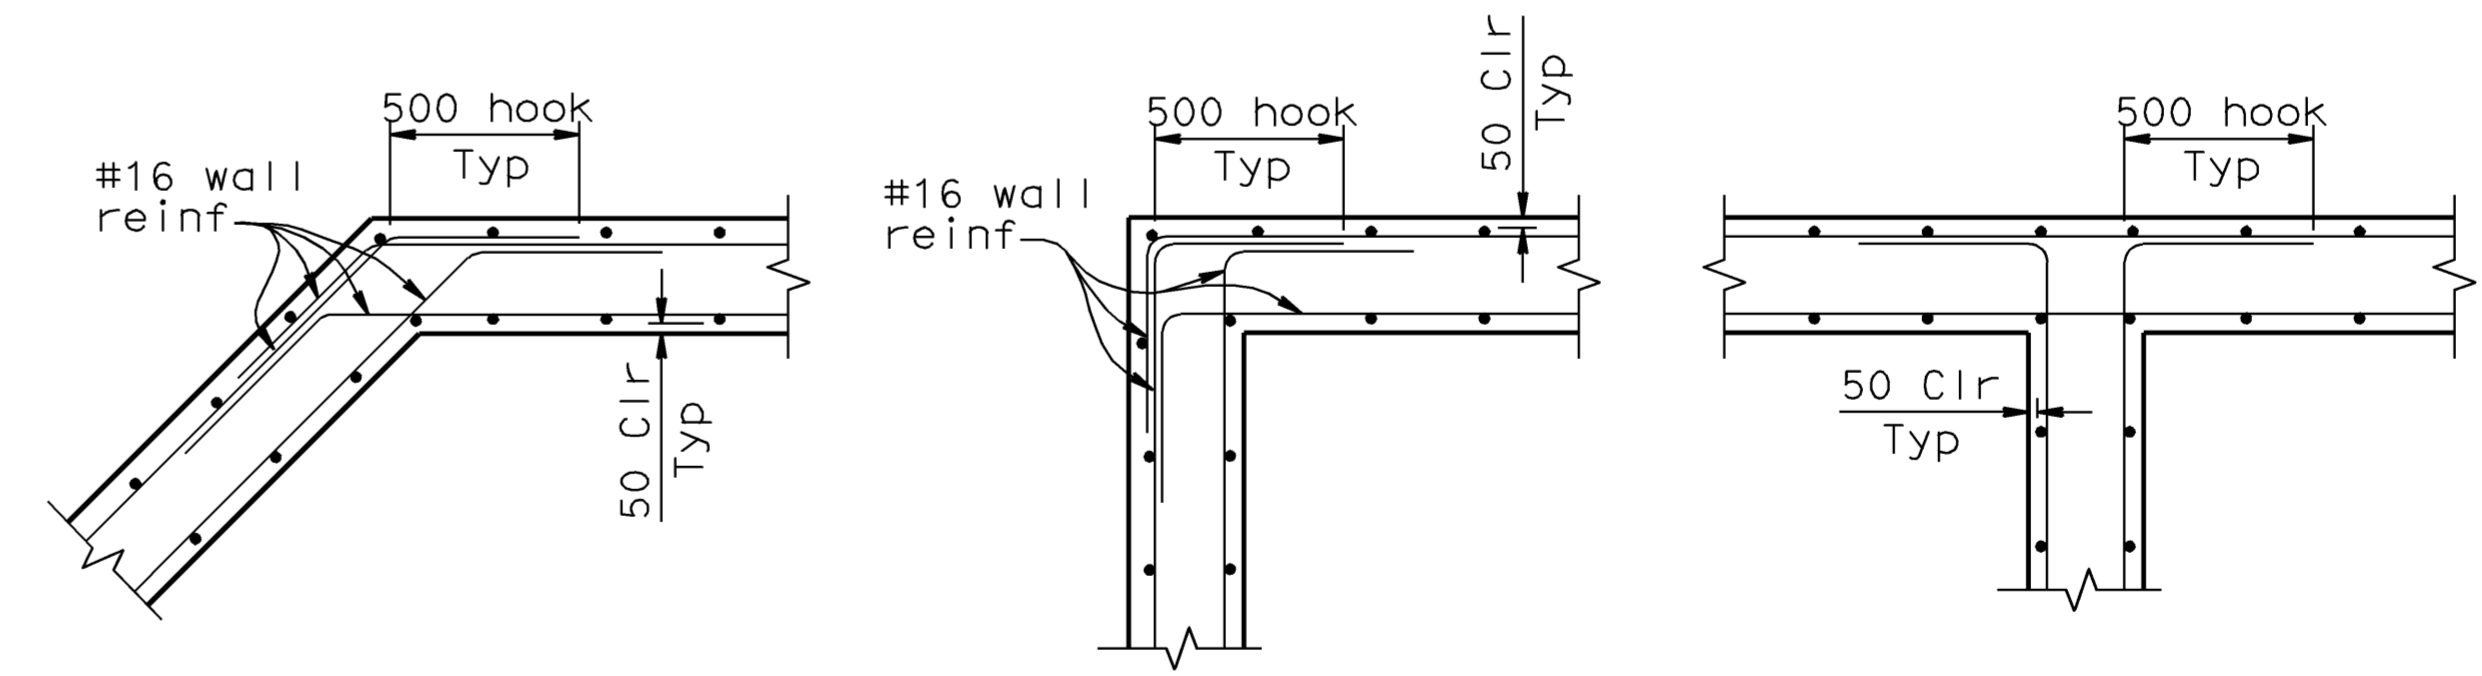

PLAN - REINFORCING DETAILS AT WALL CORNERS AND TRANSITIONS
1:20

WATER POLLUTION CONTROL DETAILS
ALL DIMENSIONS ARE IN MILLIMETERS UNLESS OTHERWISE SHOWN
WD-24

RELEASE DATE ---	DESIGN BY <i>D. Dunrud</i>	CHECKED <i>J&P Peterson</i>
FILE NO. ---	DETAILS BY <i>J&P Peterson</i>	CHECKED <i>J&P Peterson</i>
	SUBMITTED BY <i>D. Forester</i>	DRAWING DATE <i>02/07</i>

BRIDGE NO.	GROSS SOLIDS REMOVAL DEVICE
MILE POST	TYPE 1 - DETAILS NO. 1

STATE OF CALIFORNIA
DEPARTMENT OF TRANSPORTATION

DIVISION OF ENGINEERING SERVICES

CU 07314
EA 121841

REVISION DATES (PRELIMINARY STAGE ONLY)	SHEET 13 OF 32
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ORIGINAL SCALE IN MILLIMETERS FOR REDUCED PLANS

DISREGARD PRINTS BEARING EARLIER REVISION DATES

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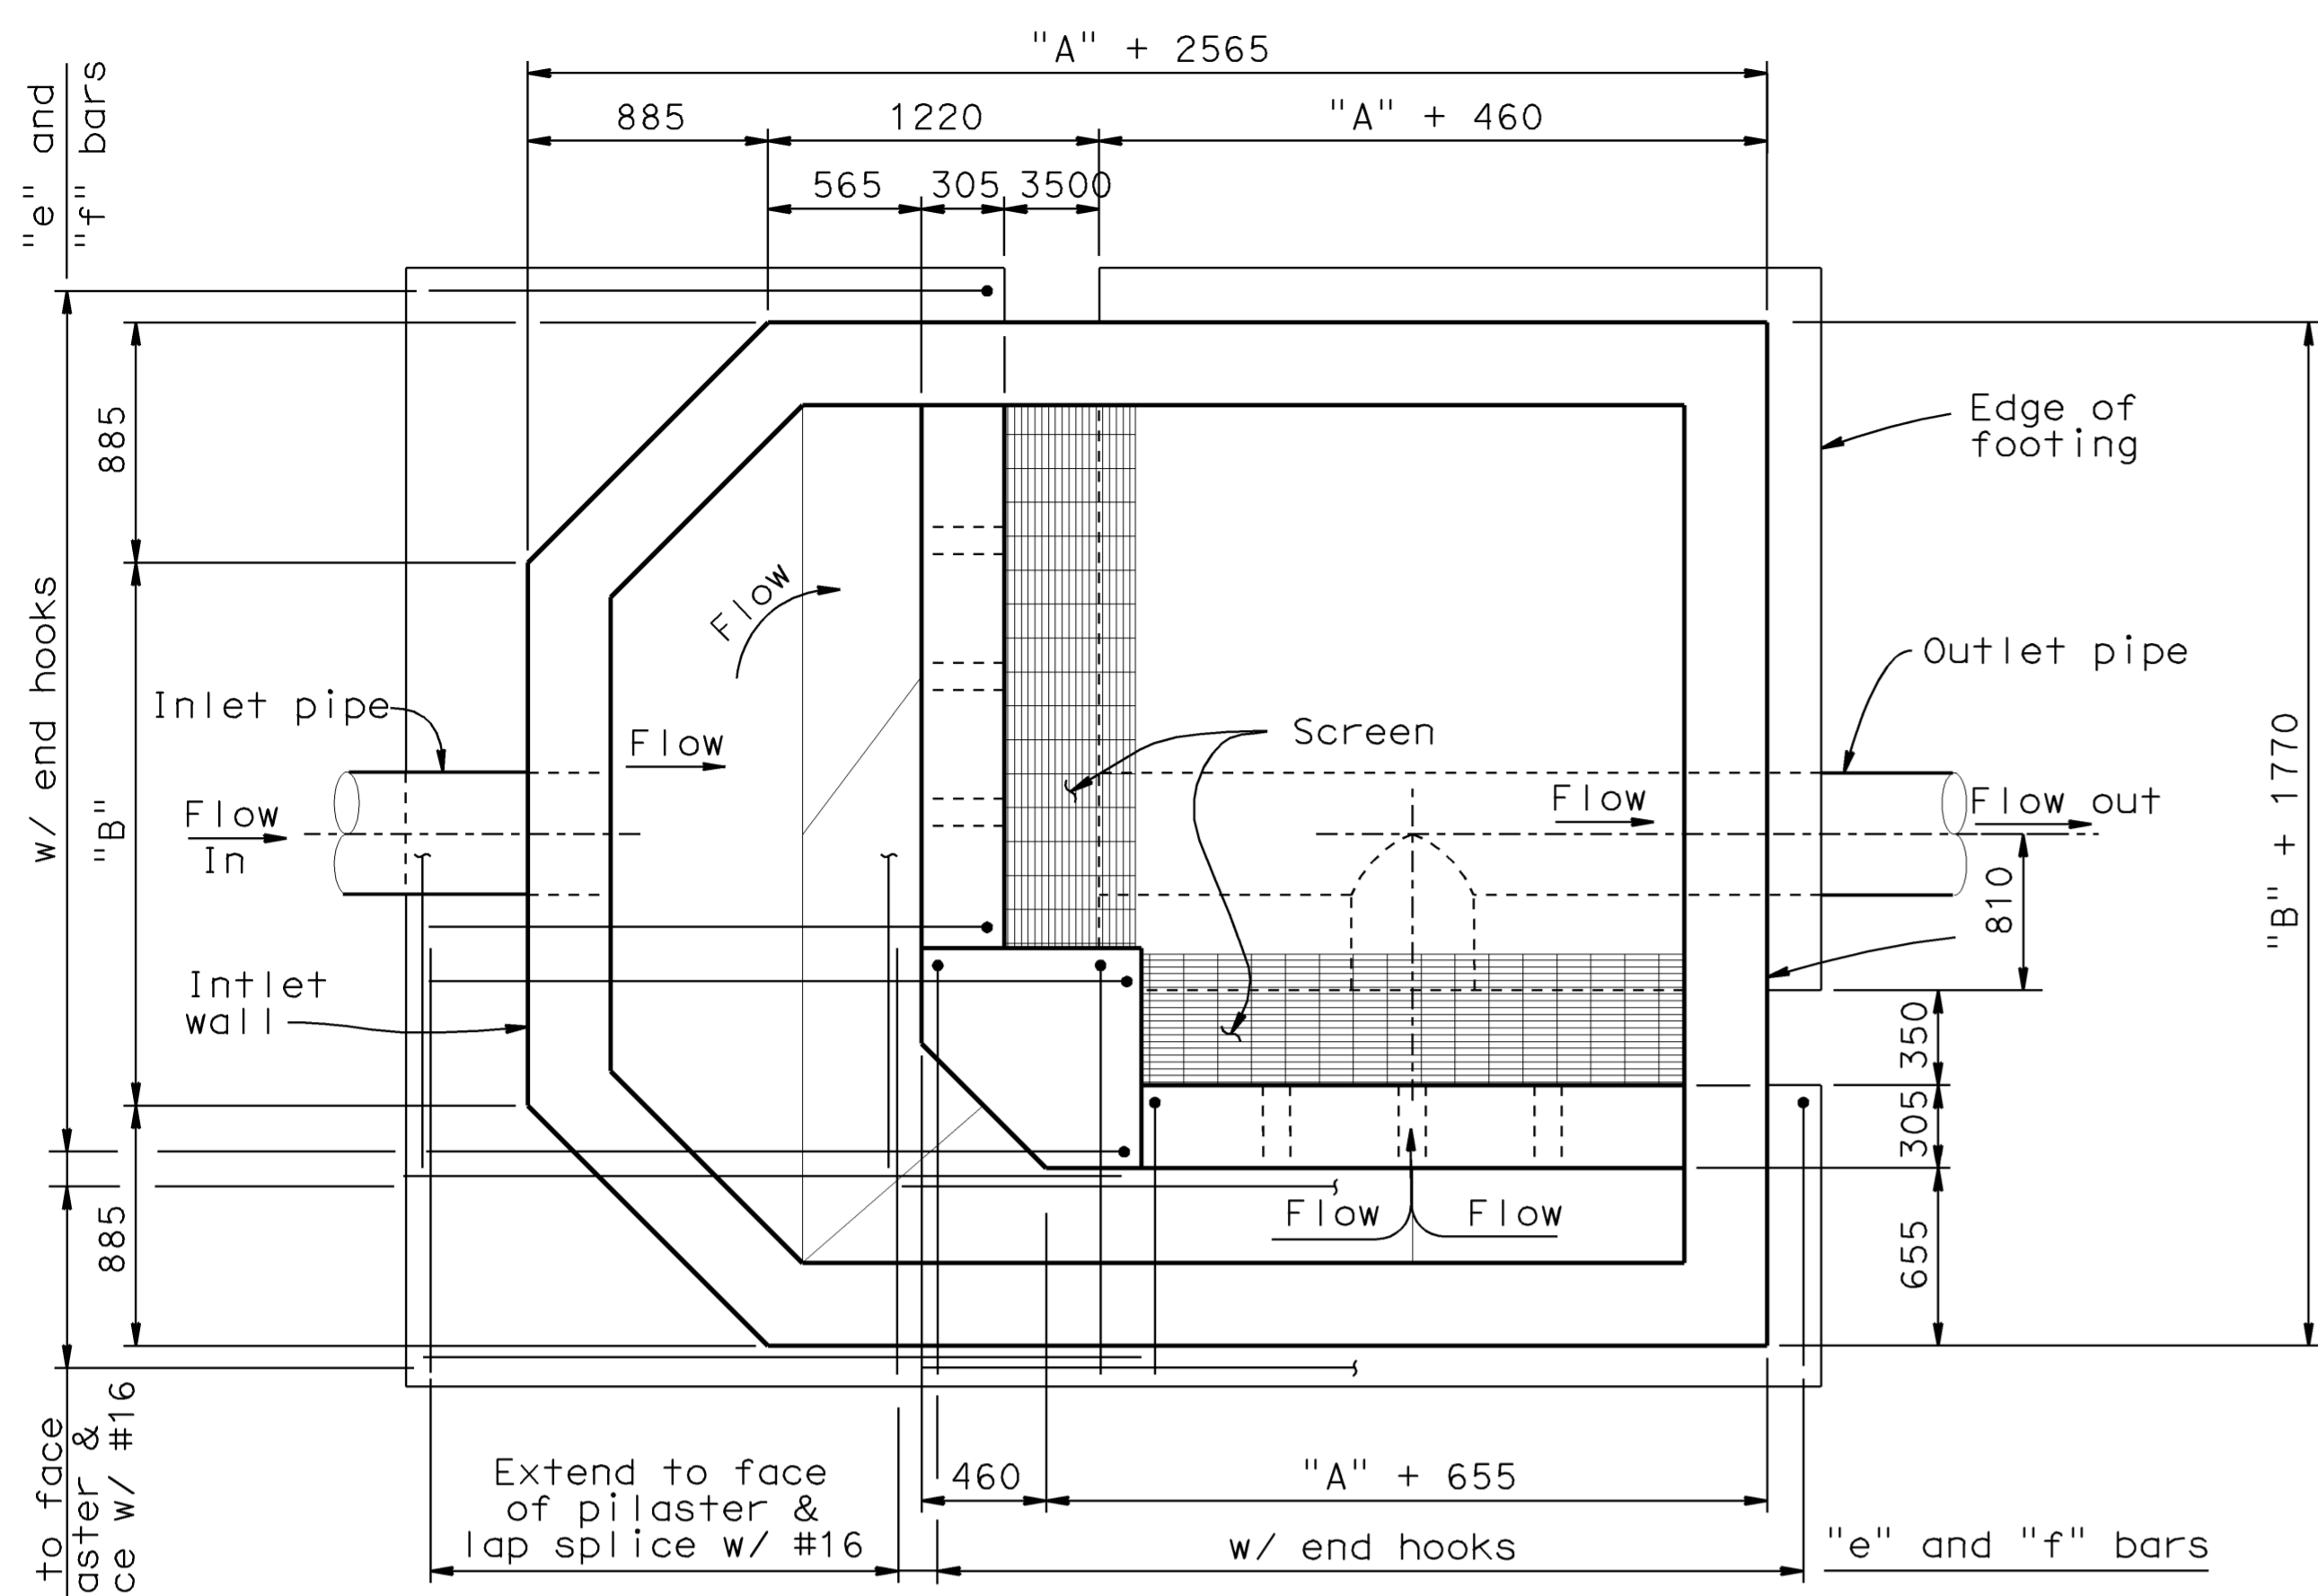
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DIST.	COUNTY	ROUTE	MILE POST TOTAL PROJECT	SHEET NO.	TOTAL SHEETS
07	LA	5	42.8/47.3	100	1073


REGISTERED ENGINEER - CIVIL
 DOUGLAS DUNRUD
 No. 47240
 Exp. 12/31/09
 CIVIL
 STATE OF CALIFORNIA

6-8-09
 PLANS APPROVAL DATE
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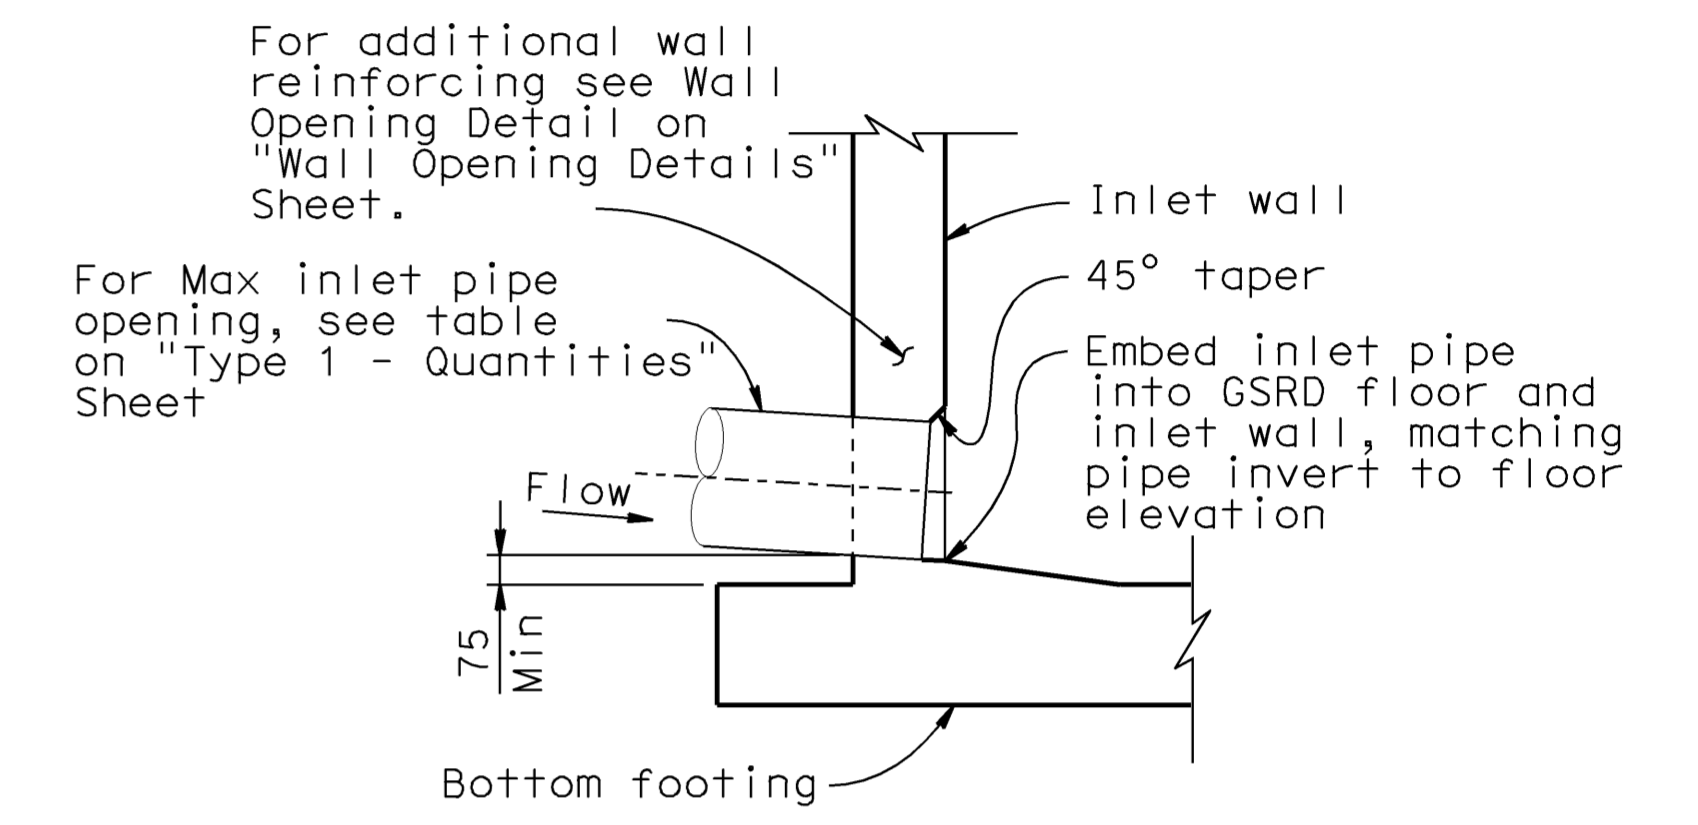
VIEW C-C

Type 1L shown, Type 1S similar
1:25




VIEW D-D

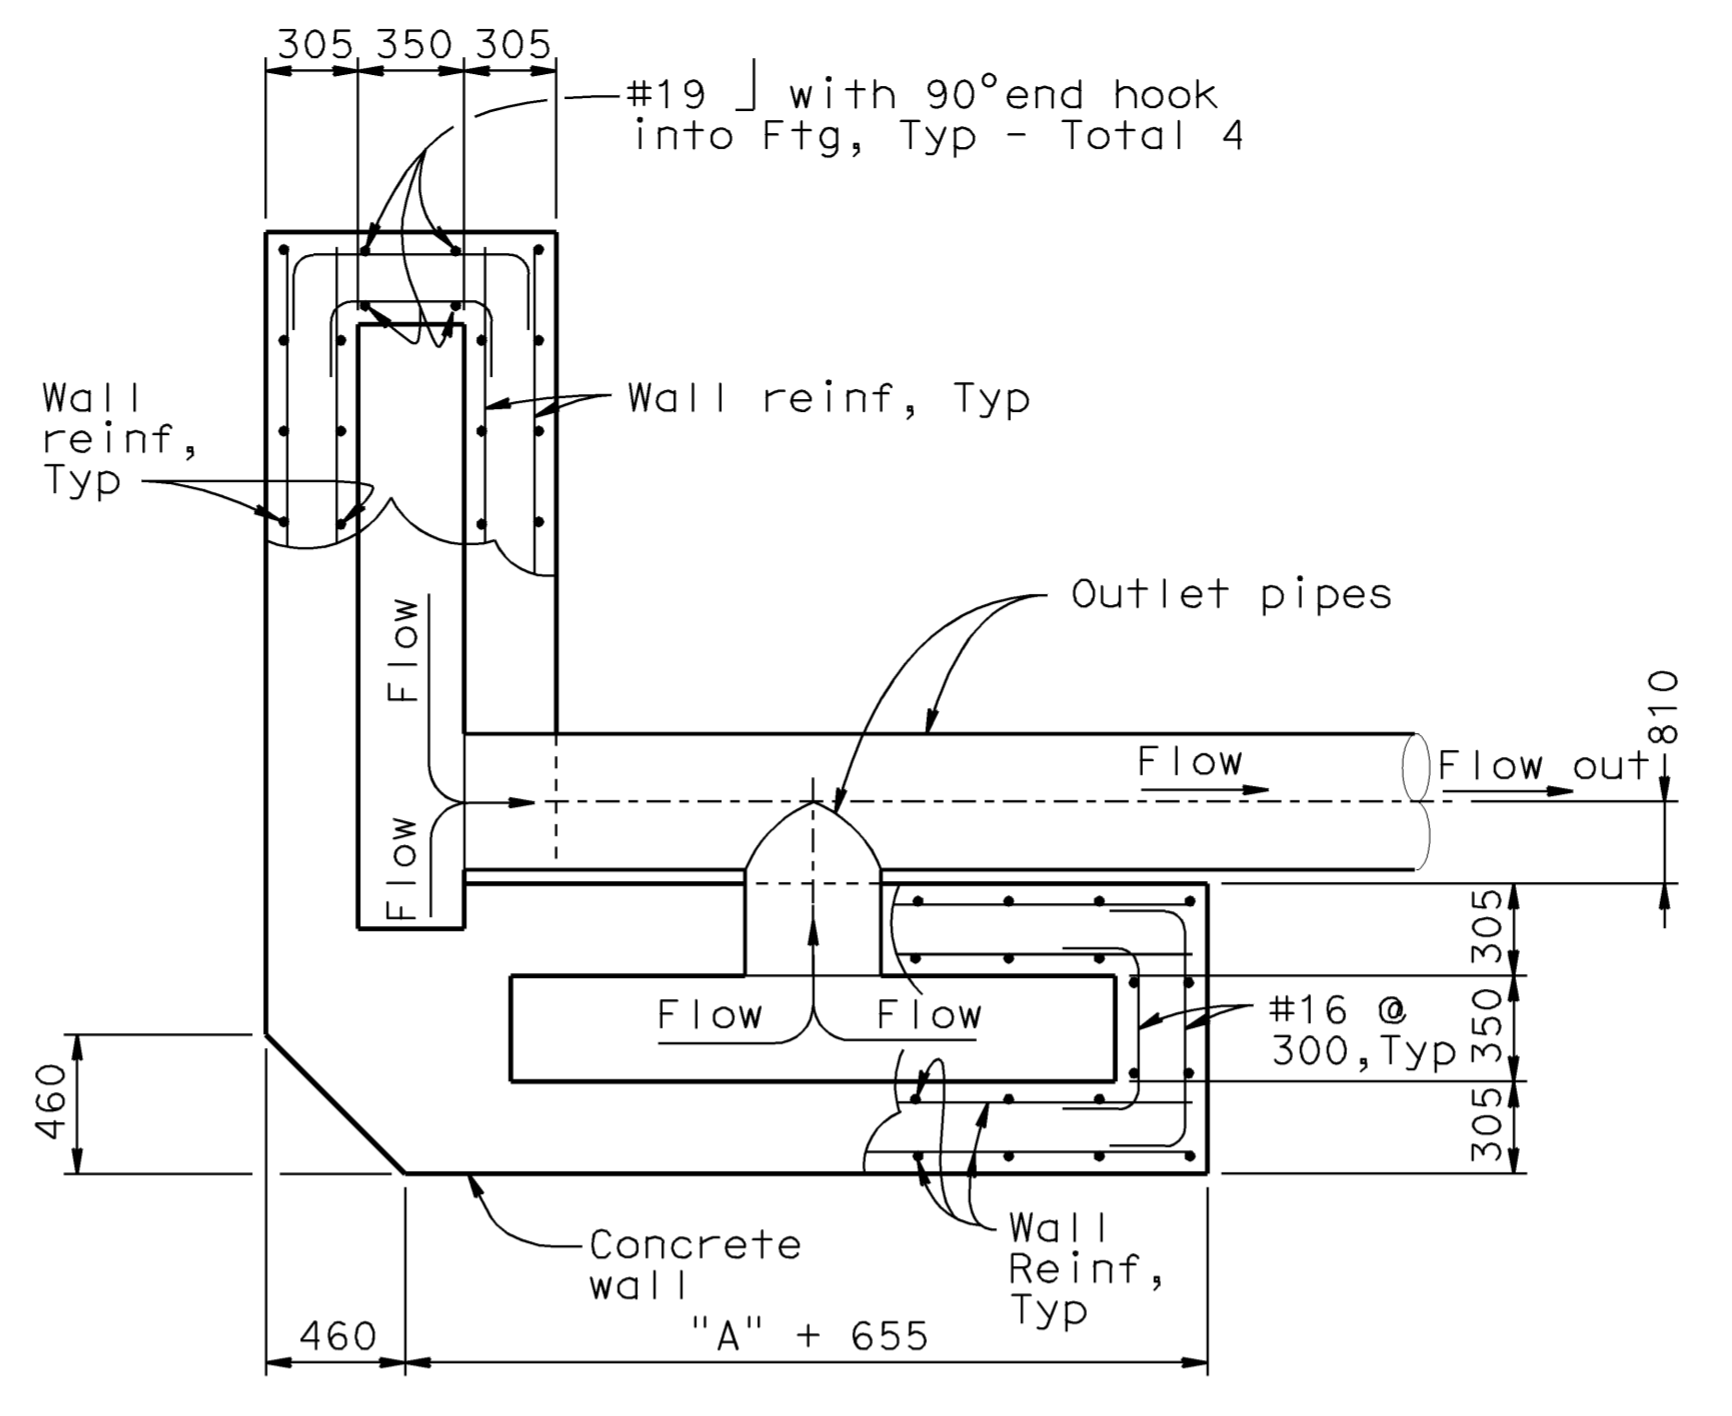1:25




INLET DETAIL

PIPE ENTRANCE AT WALL - TYPE 1
1:25

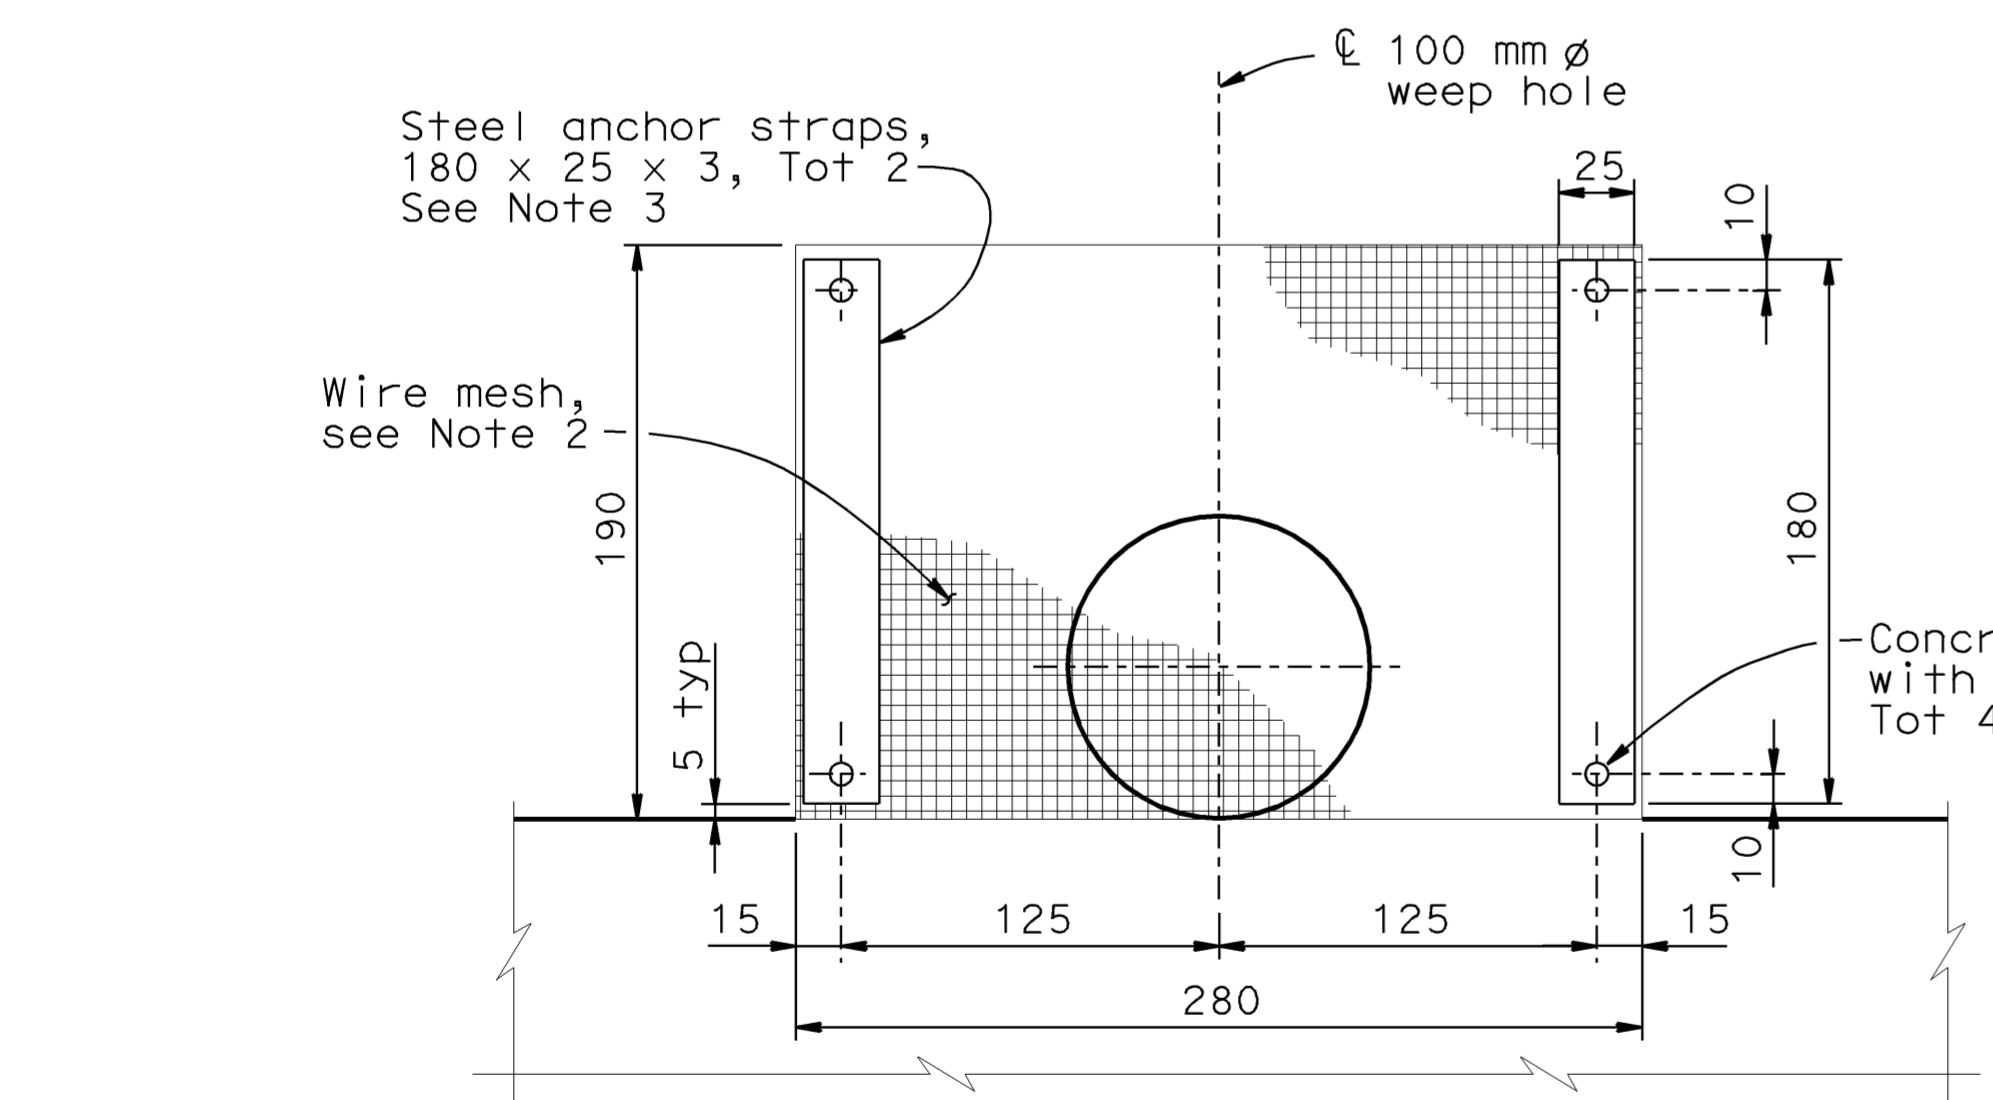


WIRE MESH DETAIL

1:2.5

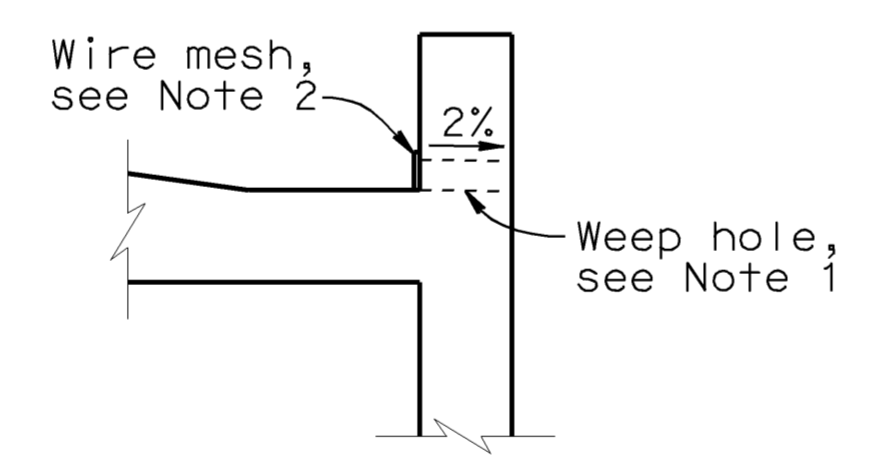


SECTION S-S

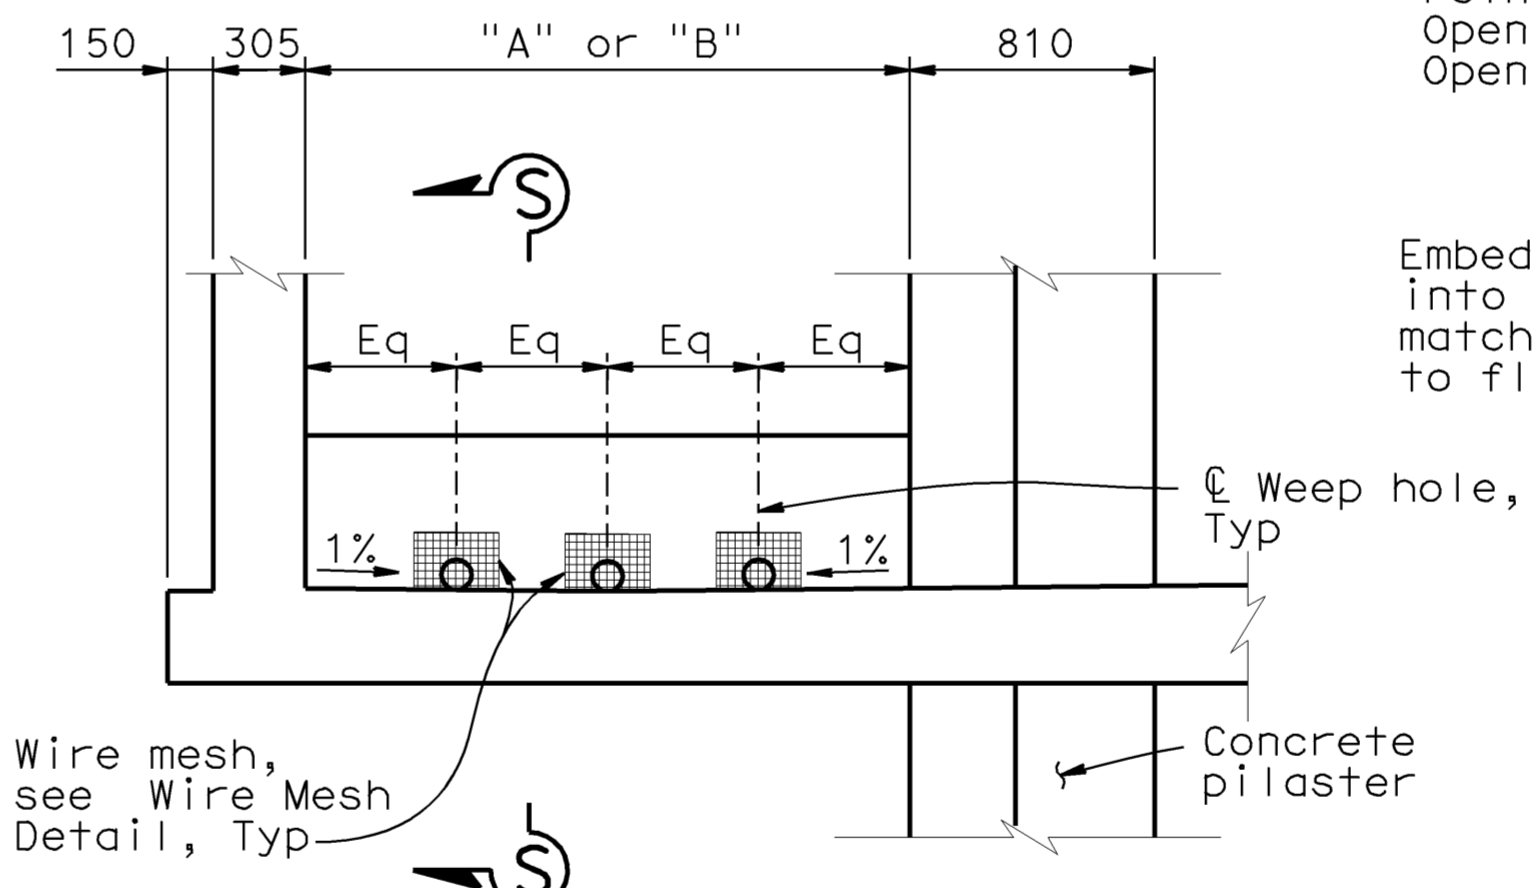

ELEVATION

WEEP HOLE DETAIL

1:25
("B" direction shown, "A" direction similar but opposite hand)

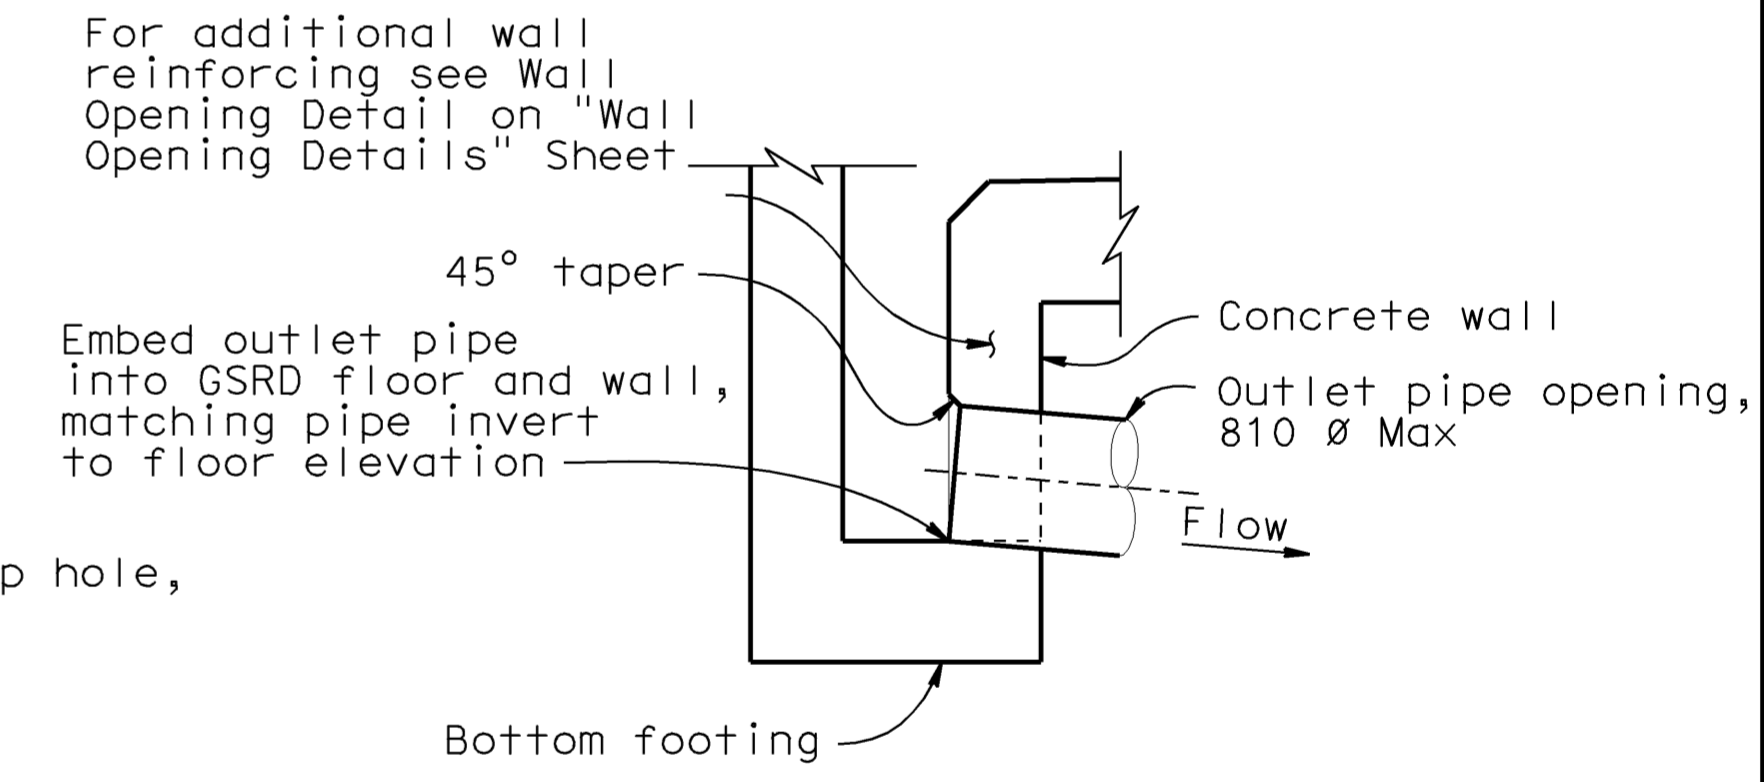

OUTLET DETAIL

PIPE EXIT AT WALL - TYPE 1
1:25

NOTES:

- 100 mm ø drains at spacing shown.
- 280 x 190 mm aluminum or galvanized steel wire 6 mm mesh hardware cloth (minimum wire ø 0.64 mm). Anchor firmly to concrete as shown.
- Concrete nails to be 3 mm ø, 75 mm long with washers. Anchor straps, concrete nails and washers to be galvanized.
- For Section locations, see "Type 1 - Layout No. 1" sheet.

WATER POLLUTION CONTROL DETAILS


ALL DIMENSIONS ARE IN MILLIMETERS UNLESS OTHERWISE SHOWN

WD-25

RELEASE DATE	DESIGN BY	D. Dunrud	CHECKED	J&P Peterson
FILE NO.	DETAILS BY	J&P Peterson	CHECKED	J&P Peterson
	SUBMITTED BY	D. Forester	DRAWING DATE	02/07

STATE OF CALIFORNIA
 DEPARTMENT OF TRANSPORTATION
 DIVISION OF ENGINEERING SERVICES

BRIDGE NO.	GROSS SOLIDS REMOVAL DEVICE
MILE POST	TYPE 1 - DETAILS NO. 2

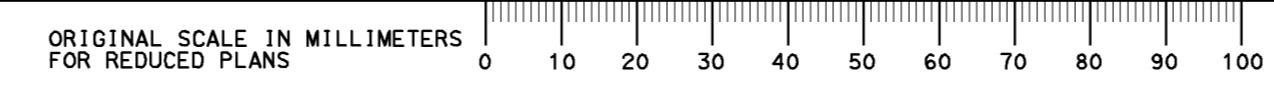

CU 07314
EA 121841

DISREGARD PRINTS BEARING EARLIER REVISION DATES	REVISION DATES (PRELIMINARY STAGE ONLY)	SHEET 14 OF 32
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USERNAME => frmguyue
DGN FILE => 7121841h025.dgn

DATE PLOTTED => 12-JUN-2009 TIME PLOTTED => 08:15